TITLE

TYPICAL SECTIONS

POND DETAILS

MEDIAN ISLAND DETAIL

RETAINING WALL DETAIL

PATH PLAN AND PROFILE STORM SEWER PLANS

STORM SEWER SCHEDULE EROSION CONTROL PLANS

PAVEMENT MARKING PLAN

PATH CROSS SECTIONS

POND CROSS SECTIONS

LIGHTING AND ELECTRICAL PLAN

CITY OF MADISON

CITY ENGINEERING DIVISION DEPARTMENT OF PUBLIC WORKS PLAN OF PROPOSED IMPROVEMENT

CAPITAL CITY PATH SEGMENT 1 (E BUCKEYE RD - DONDEE RD)

> CITY PROJECT NO. 10154 CONTRACT NO. 7801


CONVENTIONAL SIGNS FIELD VERIFY ALL UTILITY LOCATIONS STORM SEWER SANITARY SEWER WATEROVERHEAD ELECTRIC

NOTES:

POWER POLE

SIDEWALK RAMPS AND CURB THRU SIDEWALK RAMPS SHALL HAVE A MAXIMUM SLOPE OF 1" PER 12". SIDEWALK AND CURB RAMPS SHALL BE CONSTRUCTED WITH A SIDE SLOPE OF 2.00%. SIDEWALK SHALL HAVE A MINIMUM LONGITUDINAL SLOPE OF 0.50% AND A MAXIMUM LONGITUDINAL SLOPE OF 5.00%

SEE SHEET D-I FOR EARTHWORK SUMMARY

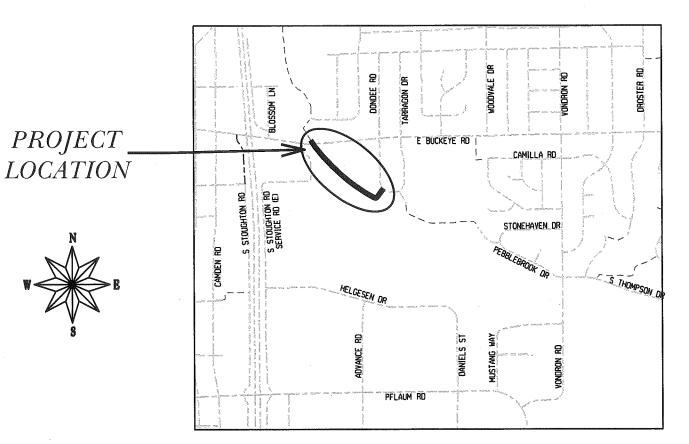

PUBLIC IMPROVEMENT PROJECT APPROVED FEBRUARY 7, 2017


BY THE COMMON COUNCIL OF MADISON, WISCONSIN

PUBLIC IMPROVEMENT DESIGN APPROVED BY:

PATH AND STREET GRADES DESIGNED BY:




GEOMETRY DESIGNED BY: PAVEMENT MARKING ON E-39453 **MADISON**

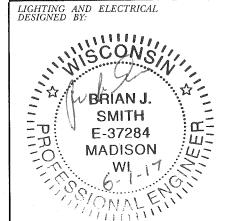

STORM SEWER DESIGNED BY:



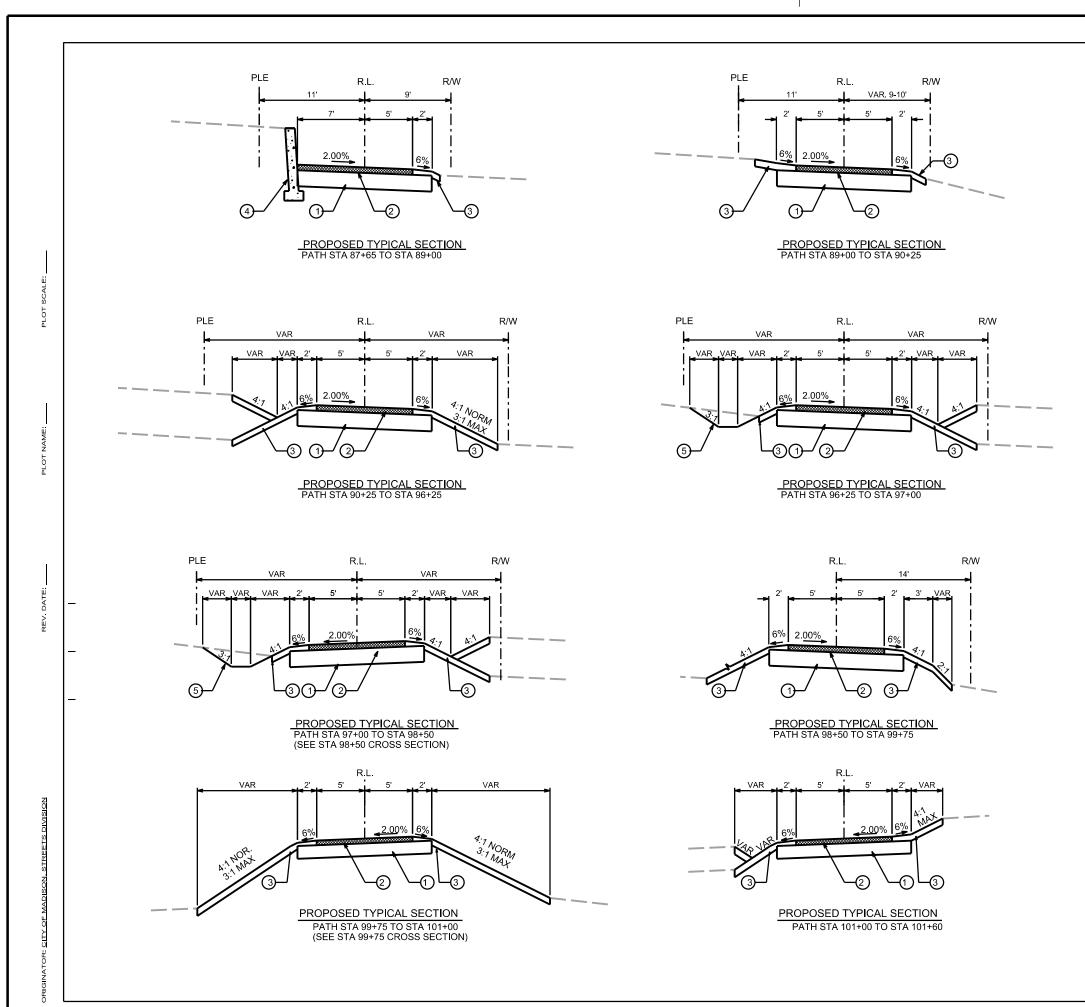

CAPITAL CITY PATH SEGMENT 1 PROJECT NO. 10154 SHEET NO. D-1

TYPICAL SECTIONS

CAPITAL CITY PATH

CITY OF MADISON

LEGEND

- (1) 8" CRUSHED AGGREGATE BASE COURSE, GRAD. NO. 2
- 2 3" HMA PAVEMENT TYPE 4 LT 58-28 S (SEE NOTE 1)
- (3) 4" TOPSOIL, SEED AND MATTING CL 1 TY URBAN A
- 4 MODULAR BLOCK RETAINING WALL (SEE DETAILS)

5 SWALE WITH SEED AND MATTING CL 1 TY URBAN B (SEE NOTE 2)

NOTES


1. CONSTRUCT HMA PAVEMENTS AS FOLLOWS:

TYPE	LAYER	THICK	NOM. AGG SIZE		
4 LT 8-28 S	SINGLE	3.0"	12.5 MM		

2. EXCAVATE TO SURFACE ELEVATION AS SHOWN ON PLANS FOR SWALE. DO NOT EXCAVATE FOR PLACEMENT OF TOPSOIL IN SWALE. SEED AND MAT NATIVE SOIL

EARTHWORK SUMMARY

UNCLASSIFIED EXCAVATION ESTIMATED UNDERCUT (EBS) EXCAVATION CUT FILL (UNADJUSTED) WASTE 534 CY (PLAN QUANTITY) 186 CY 720 CY (PROPOSAL QUANTITY)

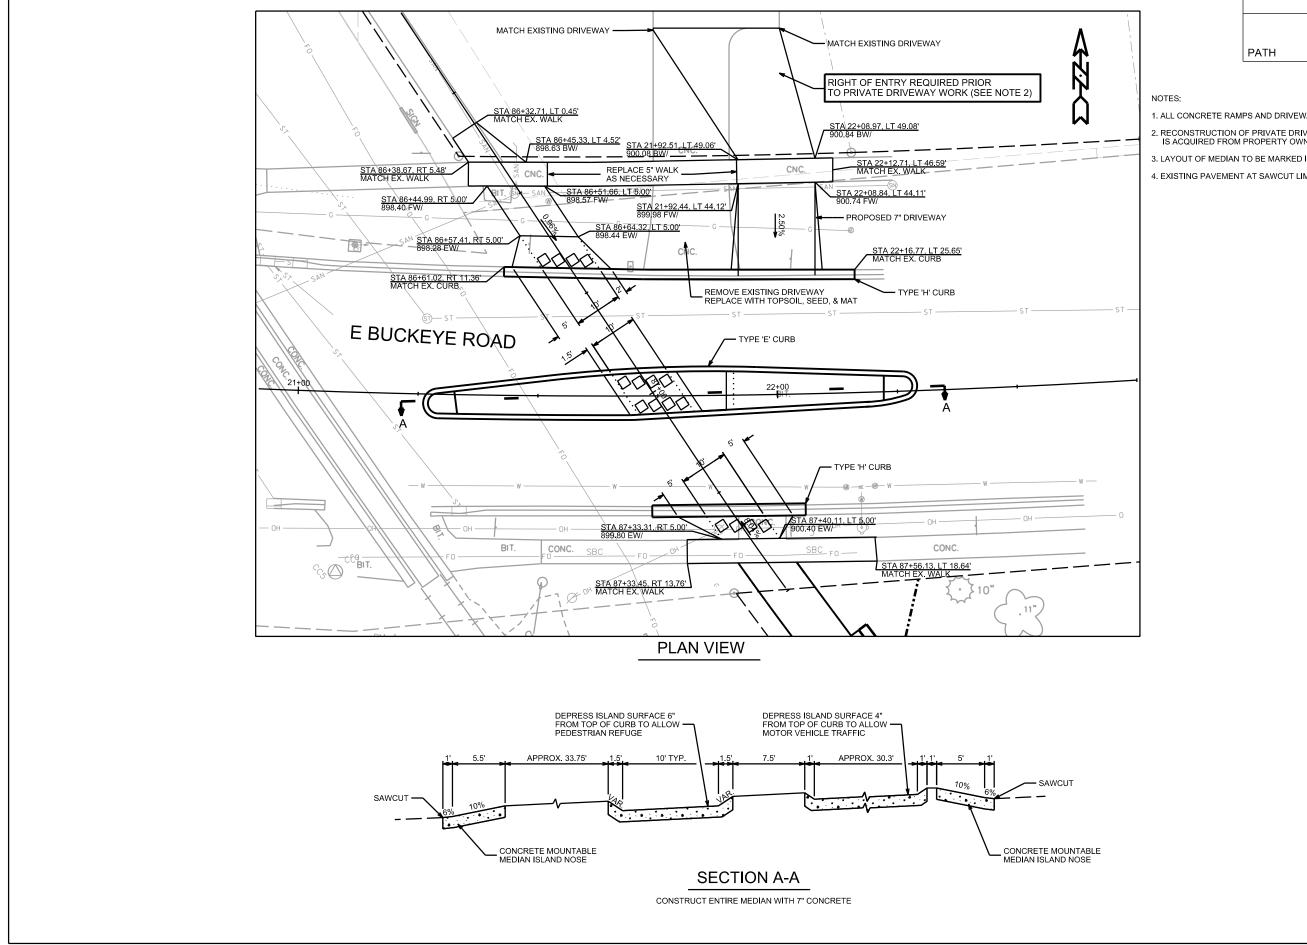

CAPITAL CITY PATH SEGMENT 1 PROJECT NO. 10154


BUCKEYE CROSSING DETAIL

SHEET NO.

D-2

CITY OF MADISON

- 1. ALL CONCRETE RAMPS AND DRIVEWAYS TO BE CONSTRUCTED WITH 7" CONCRETE
- 2. RECONSTRUCTION OF PRIVATE DRIVEWAY SHALL NOT OCCUR UNTIL RIGHT OF ENTRY IS ACQUIRED FROM PROPERTY OWNER
- 3. LAYOUT OF MEDIAN TO BE MARKED IN FIELD BY CITY TRAFFIC ENGINEERING
- 4. EXISTING PAVEMENT AT SAWCUT LIMITS TO BE USED AS FORM FOR CURB

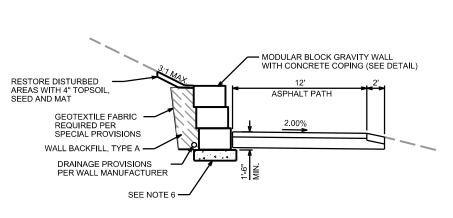


SECTION THRU RETAINING WALL

OUTSIDE FACE OF COPING -½" CHAMFER, TYP.

COPING EXPANSION JOINT

DO NOT RUN BAR STEEL THRU JOINT SEAL ALL EXPOSED HORIZ. & VERT. SURFACES OF FILLER WITH NON-STAINING GRAY NON-BITUMINOUS JOINT SEALER. (1" DEEP AND HOLD 1/8" BELOW SURFACE OF CONC.) MEMBRANE WATERPROOFING TO EXTEND FROM TOP OF COPING TO BOTTOM OF COPING

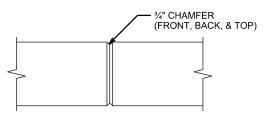

COPING CONTRACTION JOINT DO NOT RUN BAR STEEL THRU JOINT **CAPITAL CITY PATH SEGMENT 1** PROJECT NO. 10154

MODULAR BLOCK GRAVITY WALL DETAIL

PATH

CITY OF MADISON

SHEET NO.


D-3

RETAINING WALL GEOMETRY TABLE


	OFFSET TO	FINISHED	TOP OF
STATION	R/LWALL	GRADE	WALL
	K/L WALL	ELEV.	ELEV.
87+65.00	7.00' LT	901.49	902.73
87+75.00	7.00' LT	901.99	903.93
88+00.00	7.00' LT	903.03	906.10
88+25.00	7.00' LT	903.44	906.10
88+30.00	7.00' LT	903.45	906.10
88+50.00	7.00' LT	903.26	905.33
88+75.00	7.00' LT	902.44	903.93
89+00.00	7.00' LT	901.23	902.29

NOTES:

- 1. FINISHED GRADE ELEVATION IS GIVEN AT THE FRONT FACE OF THE WALL ASSUMING FRONT FACE IS 7'-0" FROM PATH C.L.
- 2. OFFSET AND TOP OF WALL ELEVATION GIVEN AT ASSUMED LOCATION AT FRONT FACE OF WALL ASSUMING NO BATTER. ACTUAL OFFSET LOCATION AND TOP OF WALL ELEVATION MAY DIFFER SLIGHTLY DEPENDING ON WALL
- 3. CONTRACTOR SHALL PROVIDE COMPLETE DESIGN, PLANS, DETAILS, SPECIFICATIONS AND SHOP DRAWINGS FOR RETAINING WALL IN ACCORDANCE WITH THE SPECIAL PROVISIONS.
- 4. RETAINING WALL IS TO BE DESIGNED USING THE GRADES PROVIDED ON THIS DETAIL. STEP LOCATIONS AND ELEVATIONS OF LEVELING PAD MAY BE ADJUSTED TO MEET SPECIFIC WALL DESIGN AND MODULAR BLOCK DIMENSIONS.
- 5. WALL PLANS AND DETAILS ON THESE DRAWINGS ARE INTENDED TO INDICATE THE LOCATION, HEIGHT AND DETAILS COMMON TO ANY GRAVITY WALL SYSTEM SELECTED. CONTRACTOR SHALL VERIFY THAT THE WALL SYSTEM SELECTED WILL CONFORM TO THE REQUIRED ALIGNMENT AND DETAILS.
- 6. CONCRETE LEVELING PAD REQUIRED. MIN 6" THICK, SEE SPECIAL PROVISIONS.
- 7. MODULAR BLOCKS SHALL HAVE A "CUT LIMESTONE" APPEARANCE WITH TAN COLORATION.
- 8. BEVEL EXPOSED EDGES OF CONCRETE 0.75"

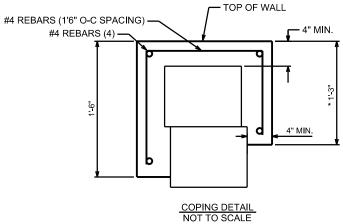


* THIS DIMENSION MAY CHANGE DEPENDING ON HEIGHT OF BLOCKS. THIS DIMENSION TO BE CONSTANT FOR ENTIRE LENGTH OF WALL, MAXIMUM ALLOWABLE HEIGHT OF BLOCKS TO BE 9 INCHES

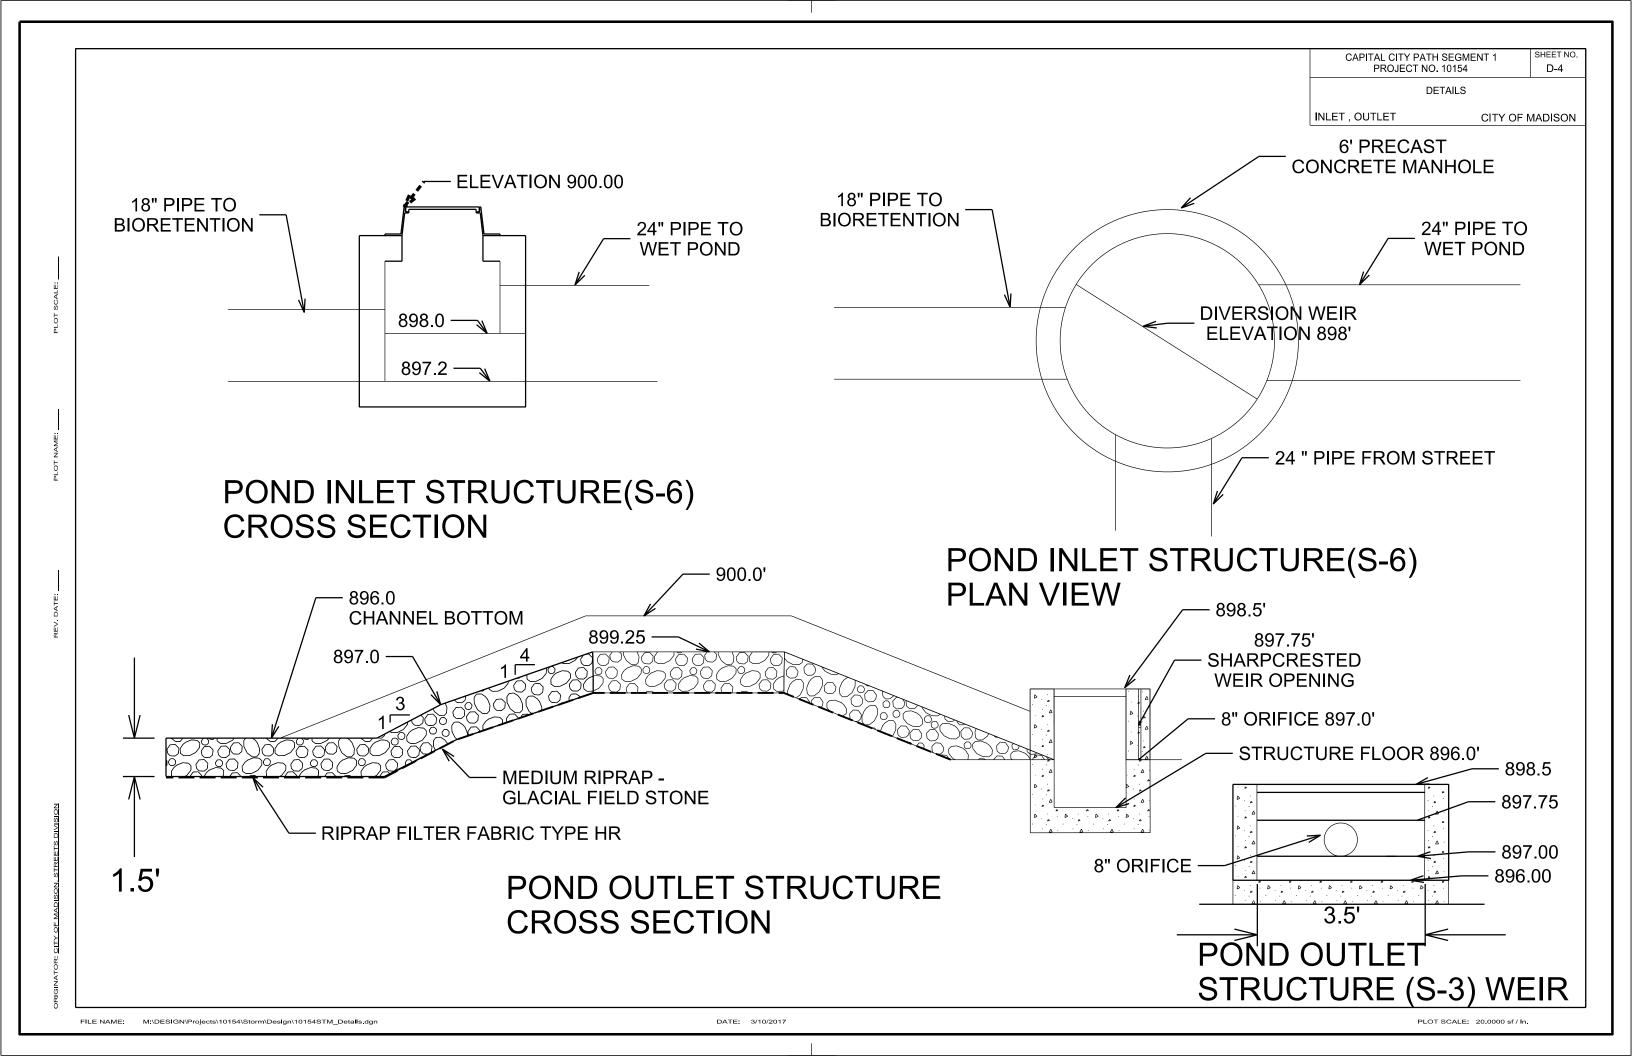


CAPITAL CITY PATH SEGMENT 1 SHEET NO. D-5

DETAILS


WEEPER, BIORETENTION CITY OF MADISON

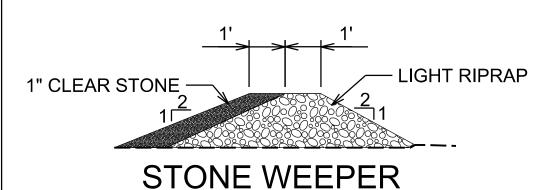


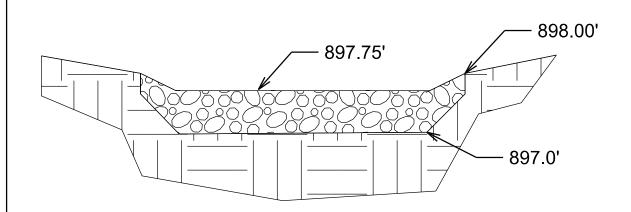



STONE WEEPER


FRONT VIEW

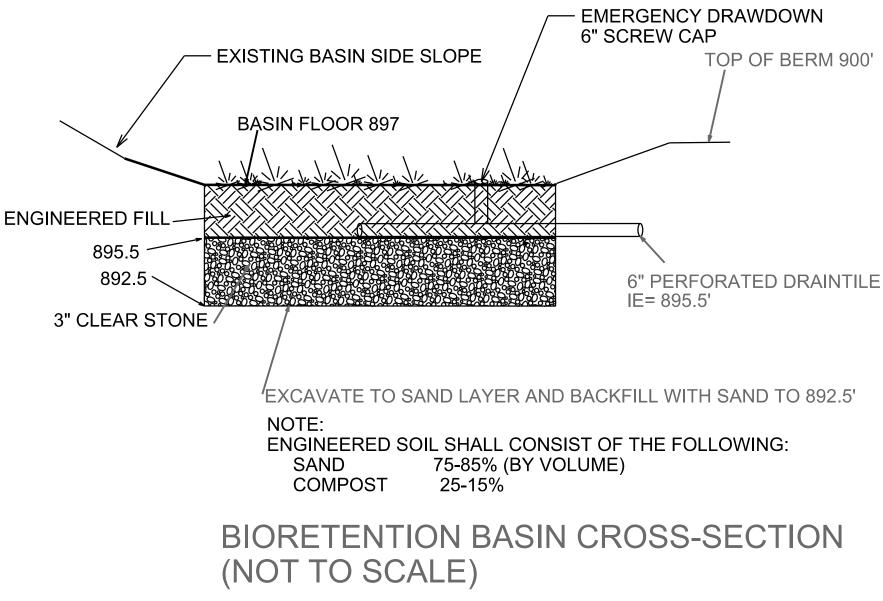


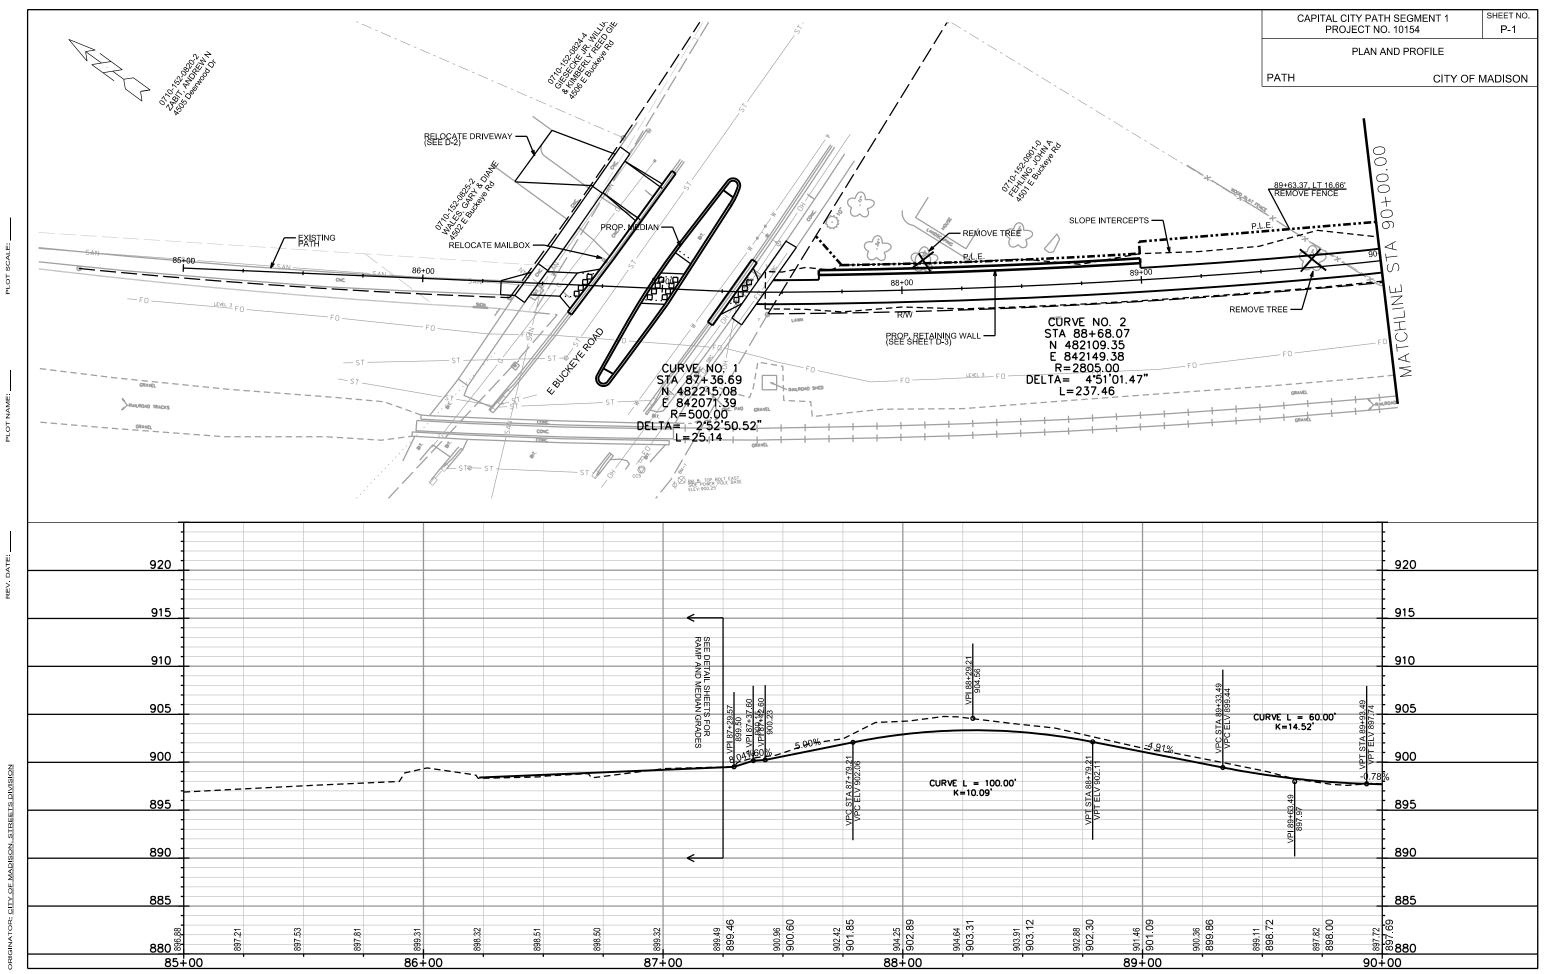


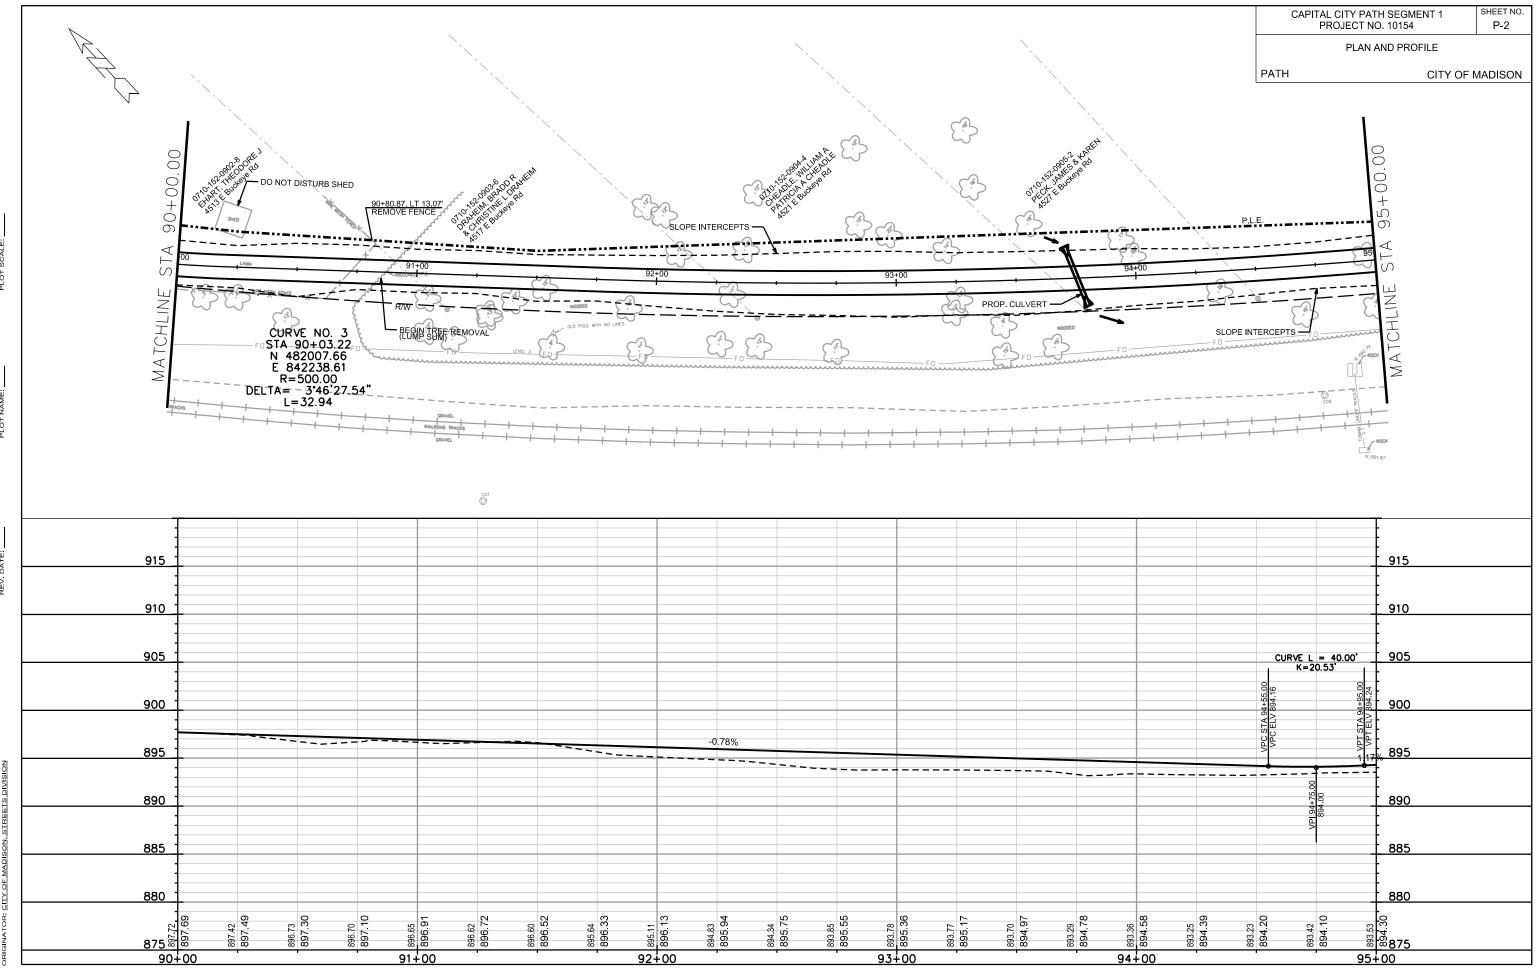


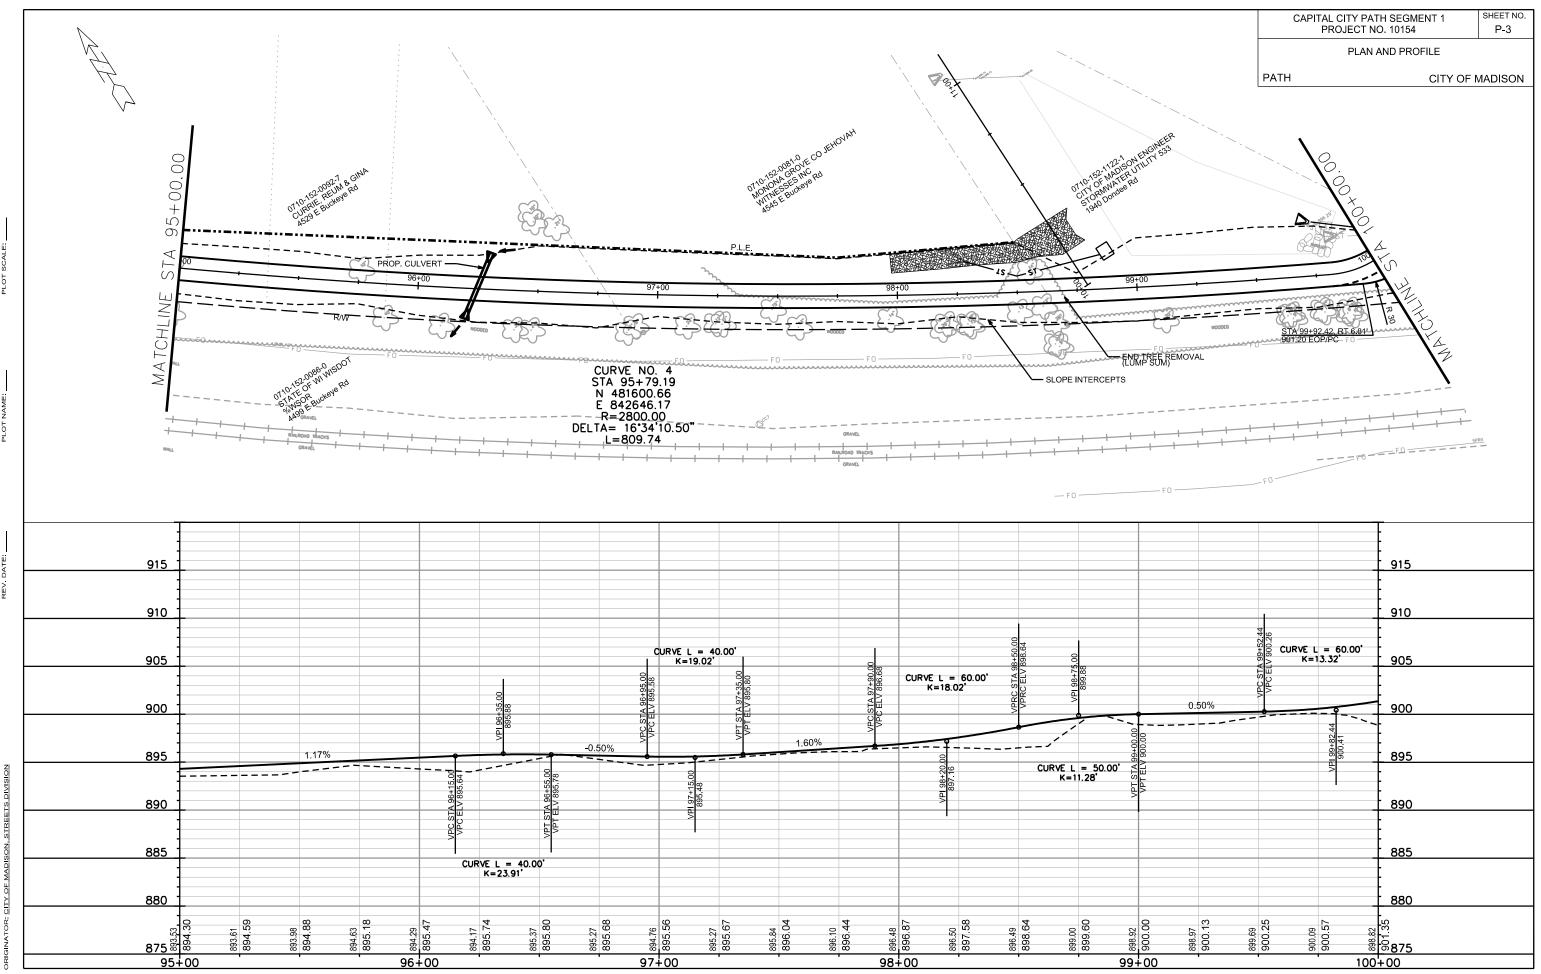


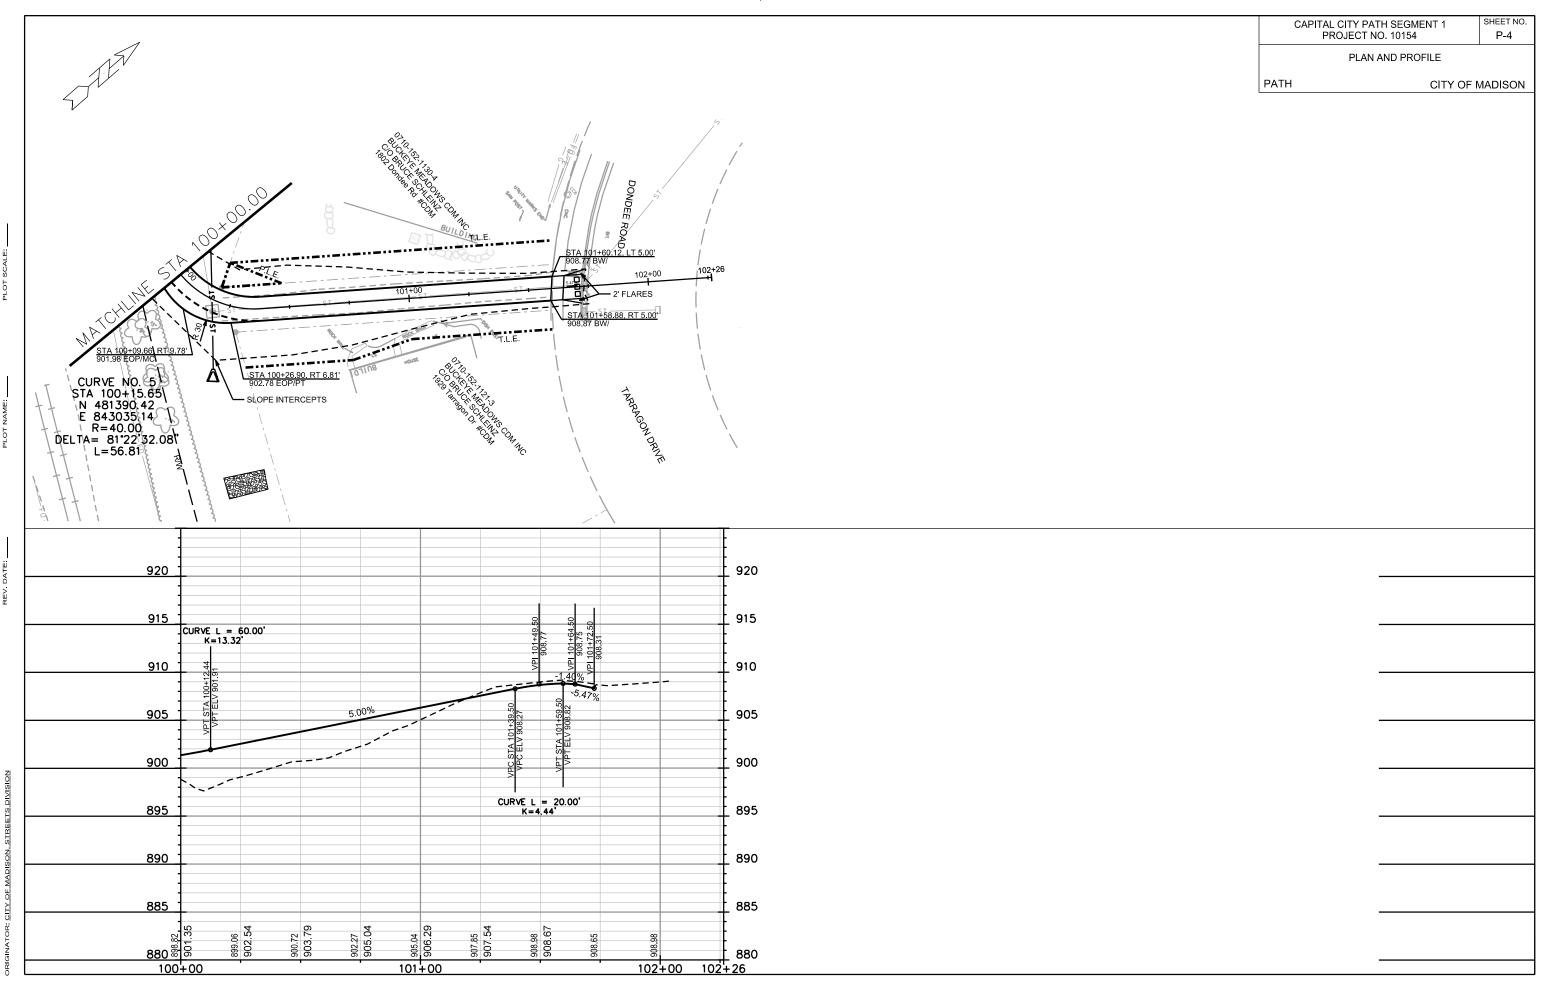


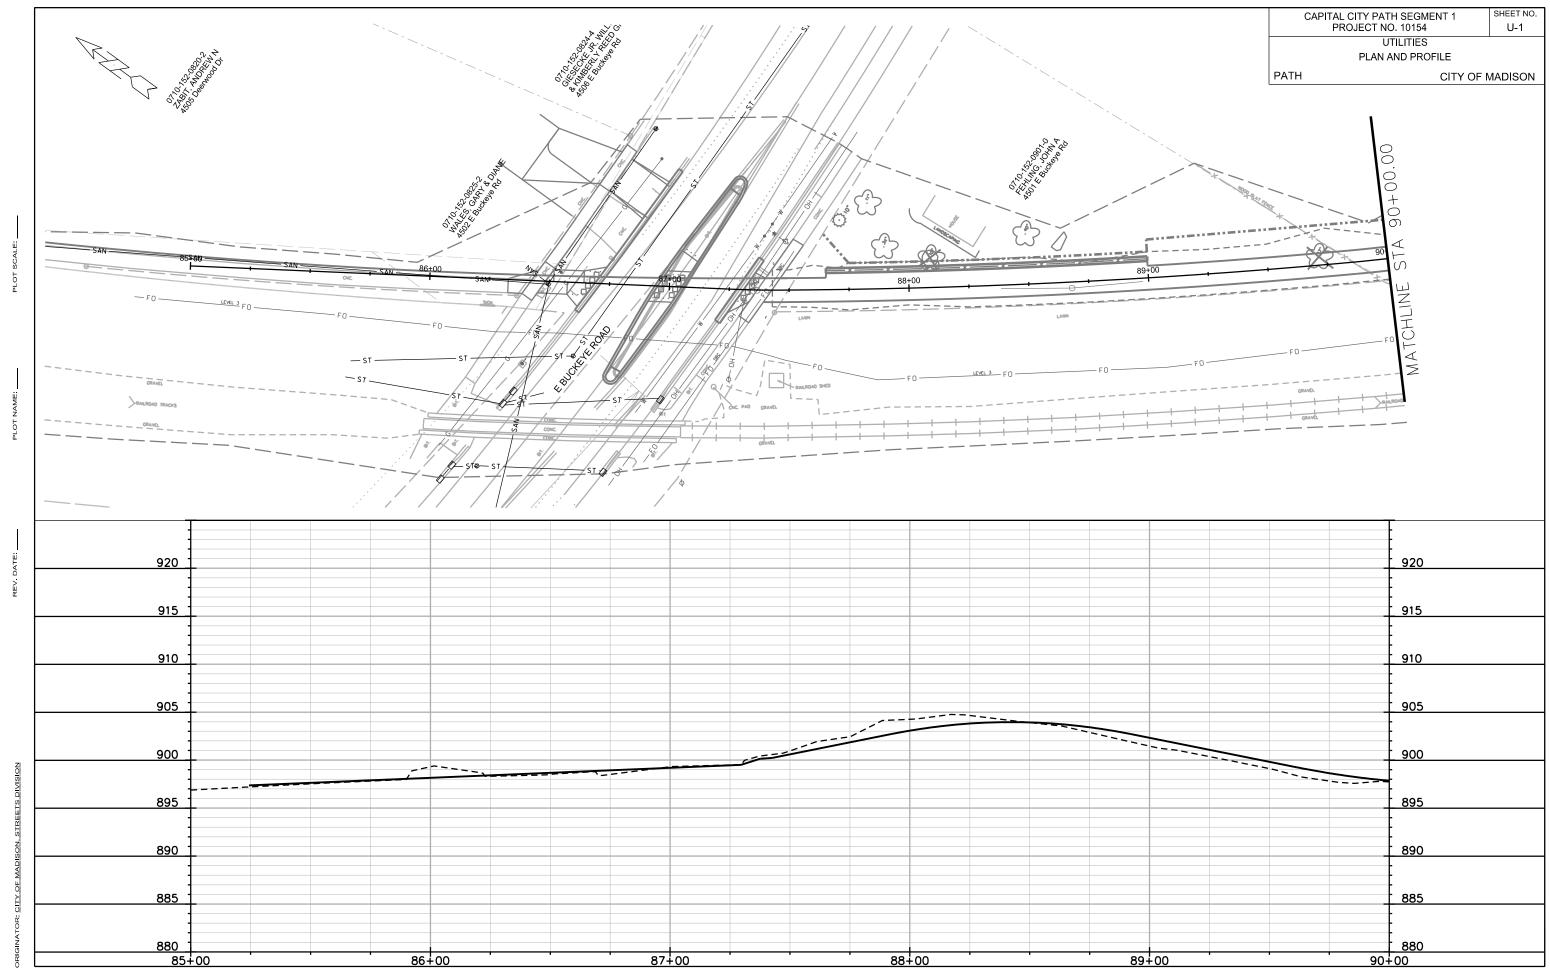

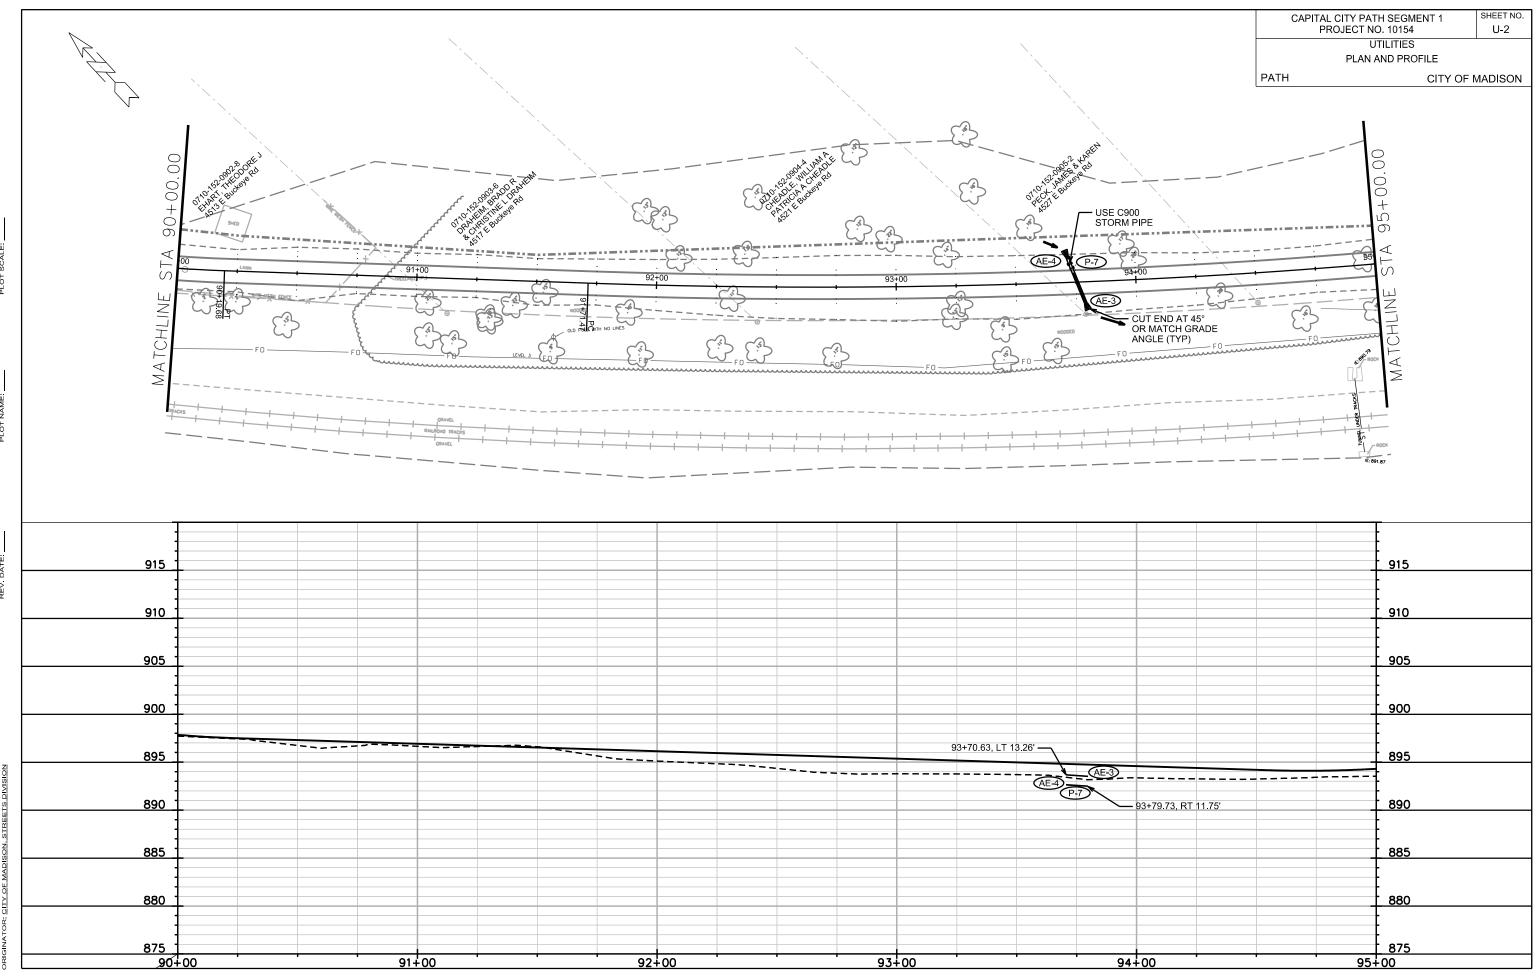

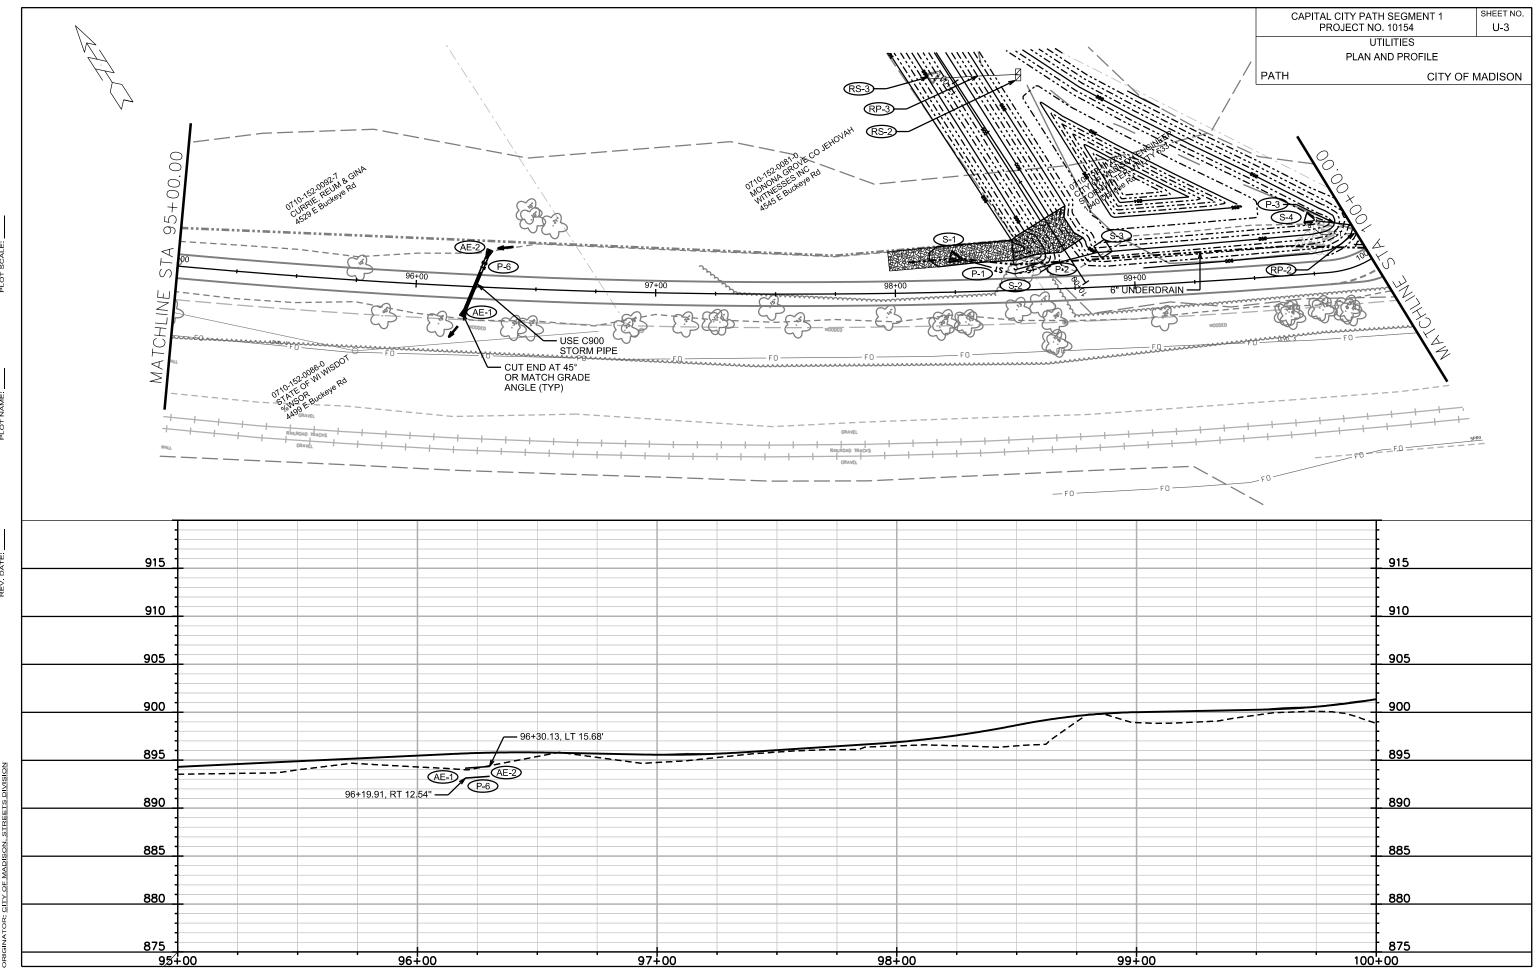

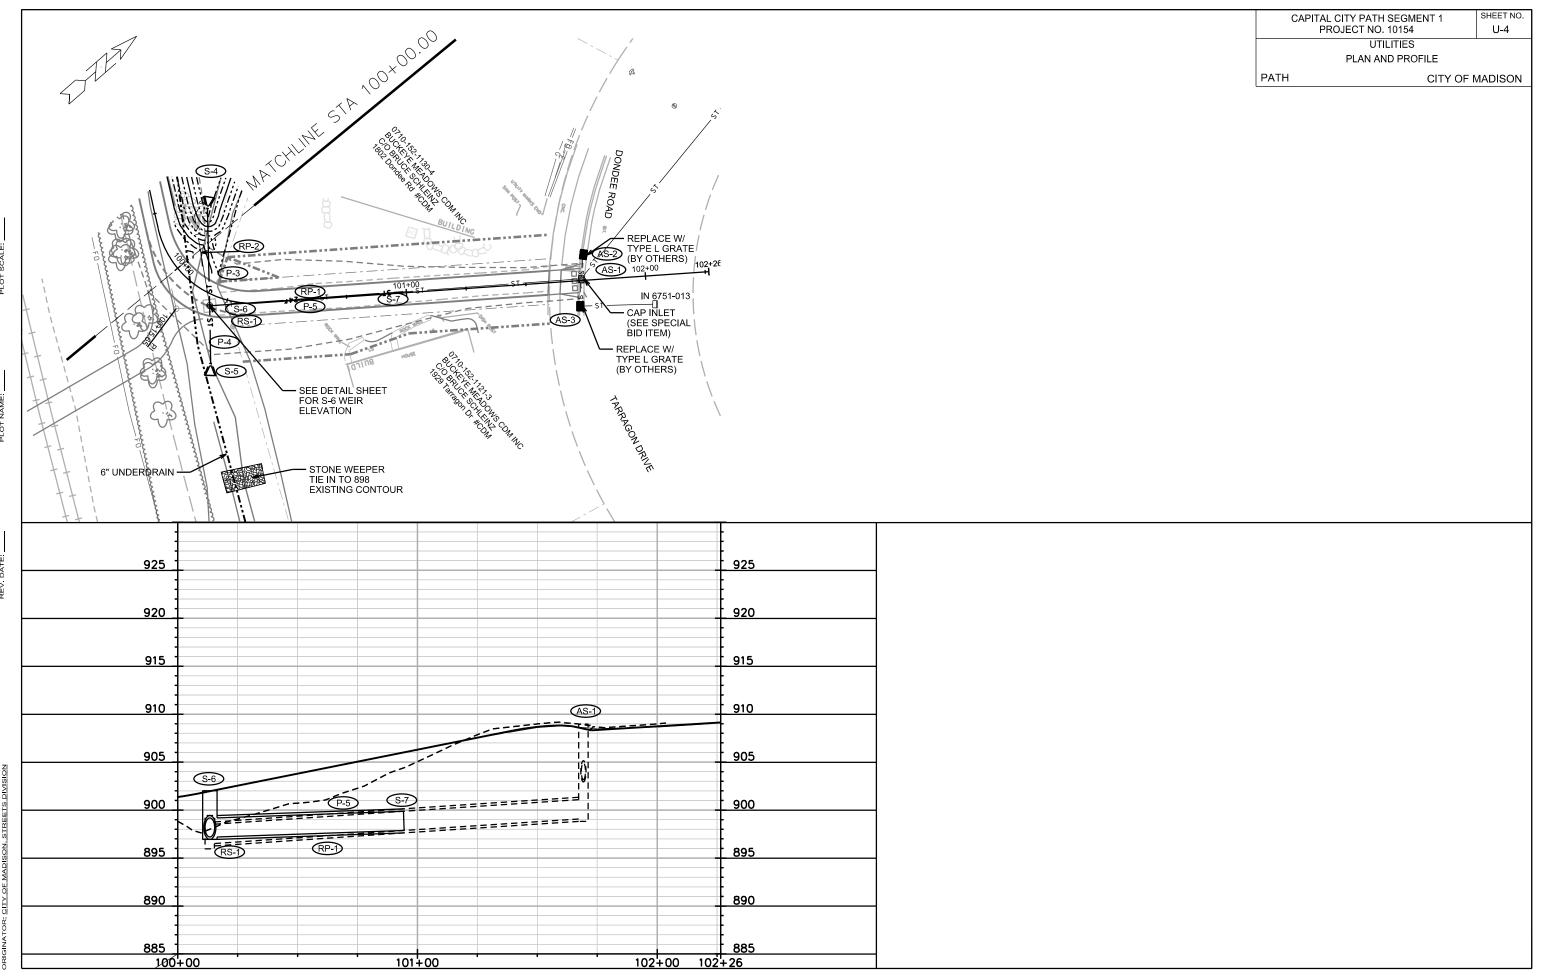

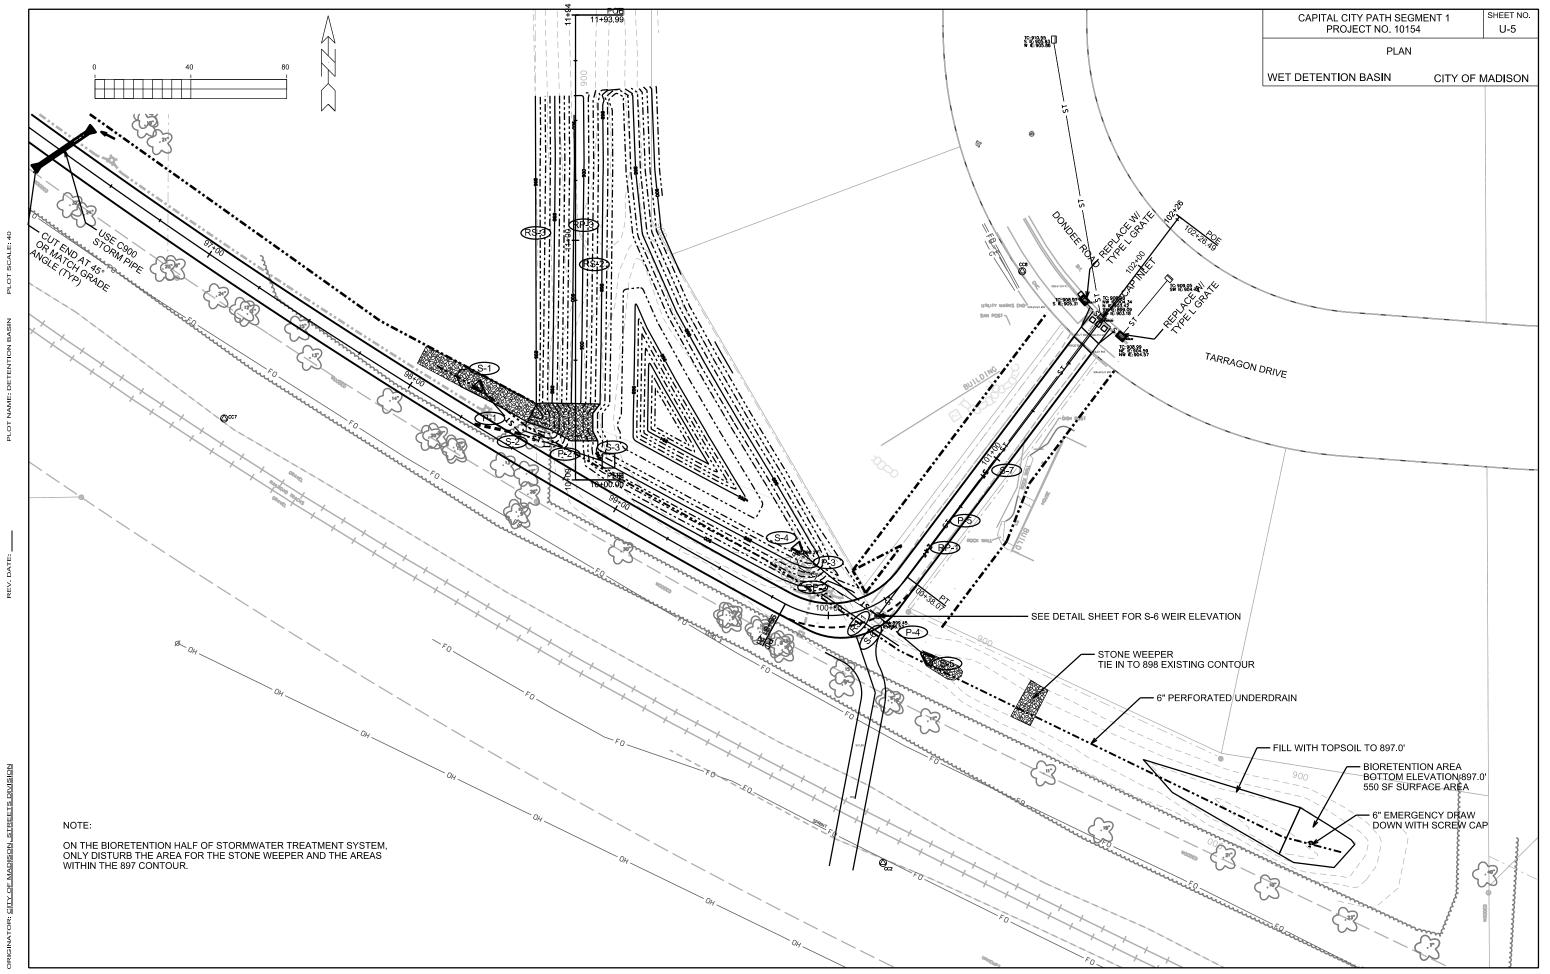

STORM SEWER SCHEDULE

CAPITAL CITY PATH SEGMENT 1	SHEET NO.
PROJECT NO. 10154	U-6
STORM SEWER SCHEDULE	

CITY OF MADISON

PROPO	SED STOR	RM STRUC	TURES				
STRUC.	STATION	LOCATION	=	TOP OF	E.I.	DEPTH	NOTES
NO.		(OFFSET)		CASTING			
SEG 1							
S-1	98+27.90	LT-13.60	30" APRON END		895.00	-	INSTALL GATE
S-2	98+50.00	LT-6.84	140° BEND		895.39	-	(4)
S-3	98+87.40	LT-15.82	OUTLET STRUCTURE	899.80	896.00	3.80	FP; SEE DETAIL DRAWING
S-4	99+77.60	LT-21.91	24" APRON END		896.00	-	INSTALL GATE
S-5	100+25.00	RT-27.37	24" APRON END		897.00	-	INSTALL GATE
S-6	100+19.19	RT-4.66	FLOW DIVERSION STRUC	902.28	897.20	5.08	SEE DETAIL DRAWING
S-7	100+98+76	CL	COLLAR		897.89	-	
AE-1	96+19.91	RT-12.54	FIELD CUT APRON END		893.14	-	(1)
AE-2	96+30.13	LT-15.68	FIELD CUT APRON END		893.32	-	(1)
AE-3	93+79.73	RT-11.75	FIELD CUT APRON END		892.50	-	(2)
AE-4	93+70.63	LT-13.26	FIELD CUT APRON END		892.65	-	(2)

PROP(OSED STOR	M PIPES							
PIPE	FROM	ТО	DISCH.	INLET	PLAN (PAY)	PIPE	SLOPE	PIPE	TYPE NOTES
NO.	(DNSTM)	(UPSTM)	E.I.	E.I.	LGTH (FT)	LGTH (FT)	(%)	SIZE	
SEG 1									
P-1	S-1	S-2	895.00	895.39	28.0	23.0	1.70%	30"	RCP
P-2	S-2	S-3	895.39	896.00	38.5	35.9	1.70%	30"	RCP
P-3	S-4	S-6	896.00	897.20	45.5	38.0	3.16%	24"	RCP
P-4	S-5	S-6	897.00	897.20	24.0	21.5	0.93%	18"	RCP
P-5	S-6	S-7	897.20	897.89	81.0	80.0	0.86%	24"	RCP
P-6	AE-2	AE-1	893.14	893.32	30.0	30.0	0.60%	12"	TYPE II - C900
P-7	AE-4	AE-3	892.50	892.65	26.6	26.6	0.56%	12"	TYPE II - C900

STORM STRUCTURE REMOVAL

ADJUST NO.	STATION	LOCATION (OFFSET)	TYPE	NOTES
SEG 1 RS-1	100+19.14	RT-4.59	EX 4x4 SAS	
RS-2 RS-3	98+54.14 98+18.43	LT-89.97 LT-89.16	APRON END OUTLET STRUCTURE	

STORM PIPE REMOVAL

REMOVE NO.	REMOVE FROM	REMOVE TO	LENGTH (FT)	PIPE SIZE	PIPE TYPE	PAID (Y/N)	NOTES
RP-1	S-7	S-6	81.0	24"	RCP	N	
RP-2	S-6	END	35.5	24"X38"	HERCP	N	REMOVE EX APRON END
RP-3	RS-3	RS-2	41.0	27"	RCP	Υ	(3)

STORM STRUCTURE ADJUSTMENTS

HERS)
HERS)

NOTE: PLAN LENGTH (PAY LENGTH) IS FROM CENTER OF STRUCTURE TO CENTER OF STRUCTURE. PIPE LENGTH IS ACTUAL LENGTH OF PIPE FROM STRUCTURE WALL TO STRUCTURE WALL. SLOPE CALCULATED USING PIPE LENGTH.

STANDARD NOTES:

- ABBREVIATIONS: AE = APRON ENDWALL; RCP = REINFORCED CONCRETE PIPE; HERCP = HORIZONTAL ELLIPTICAL REINFORCED CONCRETE PIPE; DNA = DOES NOT APPLY; SAS = SEWER ACCESS STRUCTURE; LP = LOW POINT INLET STRUCTURE; FP = FIELD POURED STRUCTURE; TR = TOP OF CONCRETE ROOF; NCM = NO CROWN MATCH FOR PIPES; UD = UNDERDRAIN

- APPROXIMATE DISCHARGE E.I. GIVEN, ADJUST E.I. AND PIPE SLOPE IN THE FIELD.
- TOP OF CASTING GRADE GIVEN IS THE TOP OF CURB FOR INLET STRUCTURES AND THE FLOWLINE OF THE CLOSED CASTING FOR SAS'S.
- TOP OF CONCRETE ROOF (TR) IS 1.25' BELOW TOP OF CASTING UNLESS OTHERWISE NOTED.
- ALL REINFORCED CONCRETE PIPES TO BE CLASS III UNLESS OTHERWISE NOTED.
- SURVEYOR TO CONFIRM THAT ALL INLET STATION / OFFSETS LINE UP WITH PROPOSED CURB AND GUTTER.
- ALL STRUCTURES CALLED OUT AS FIELD POURED SHALL BE FIELD POURED. ALL OTHER STRUCTURES (NOT INDICATED AS FIELD POURED) SHALL BE SUBMITTED TO CITY ENGINEERING FOR APPROVAL IF PRECAST STRUCTURES ARE PREFERRED. CONTACT DANIEL OLIVARES OF CITY ENGINEERING AT (608) 261-9285 FOR PRECAST APPROVALS, FAX SHOP DRAWINGS TO (608)264-9275, OR EMAIL SHOP DRAWINGS TO DAOLIVARES@CITYOFMADISON.COM.


SPECIFIC NOTES


(1) CUT END OF P-1 TO 45° OR MATCH GRADE


(2) CUT END OF P-2 TO 45° OR MATCH GRADE


(3) VERIFY IN FIELD - MAY INCLUDE 23'-27" RCP AND 18'-12" PVC


(4) PAID AS COLLAR

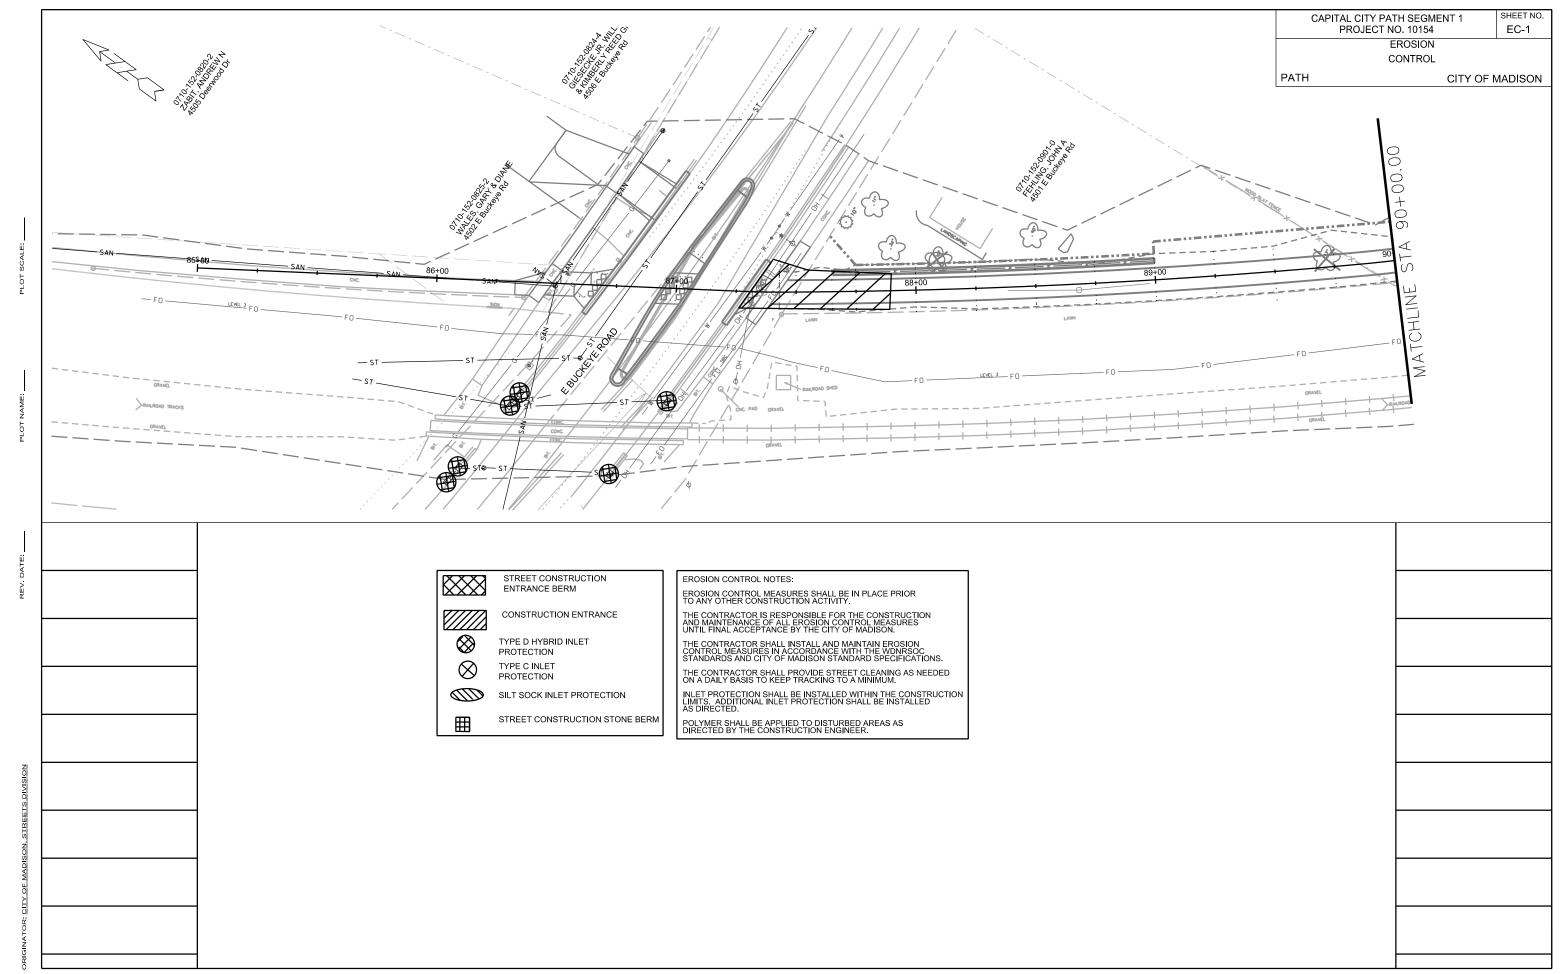

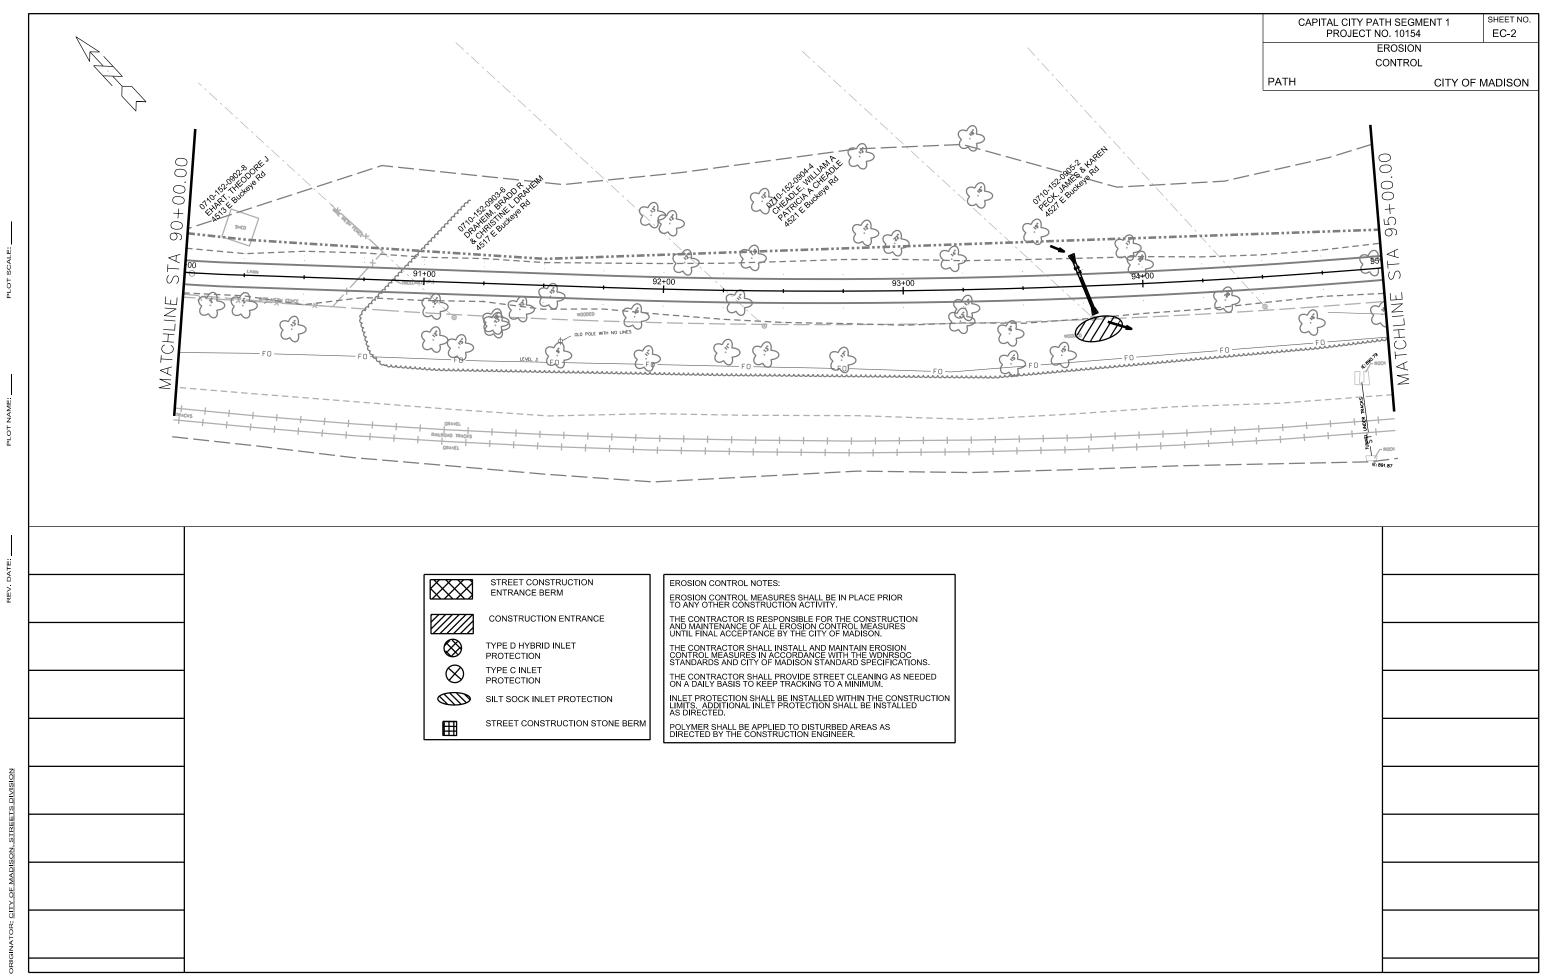

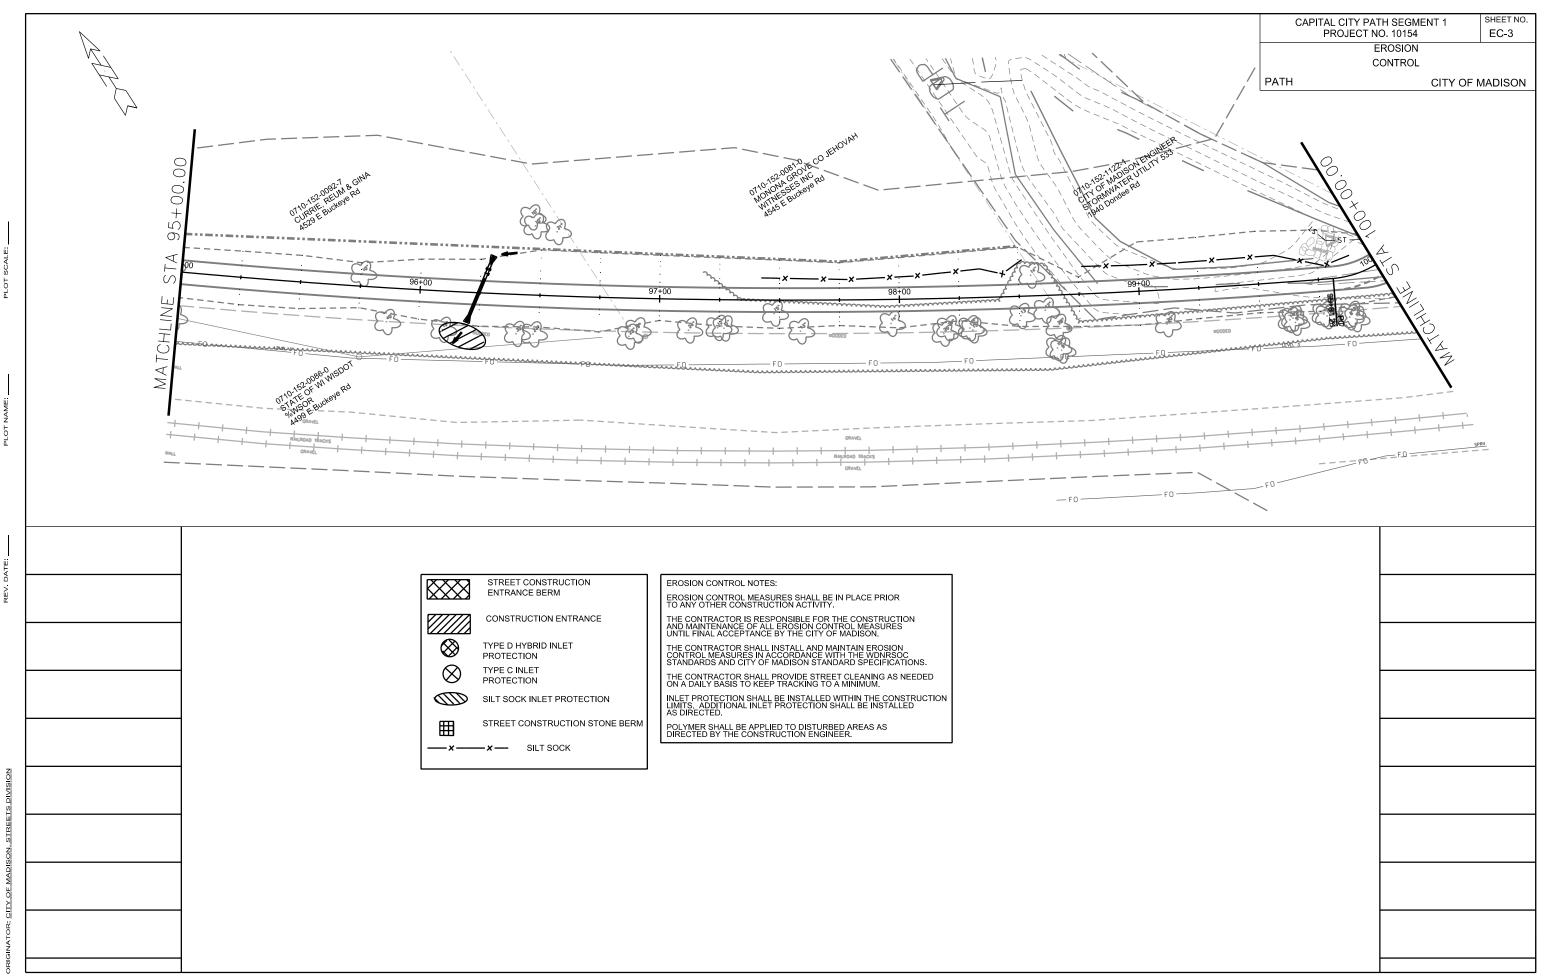


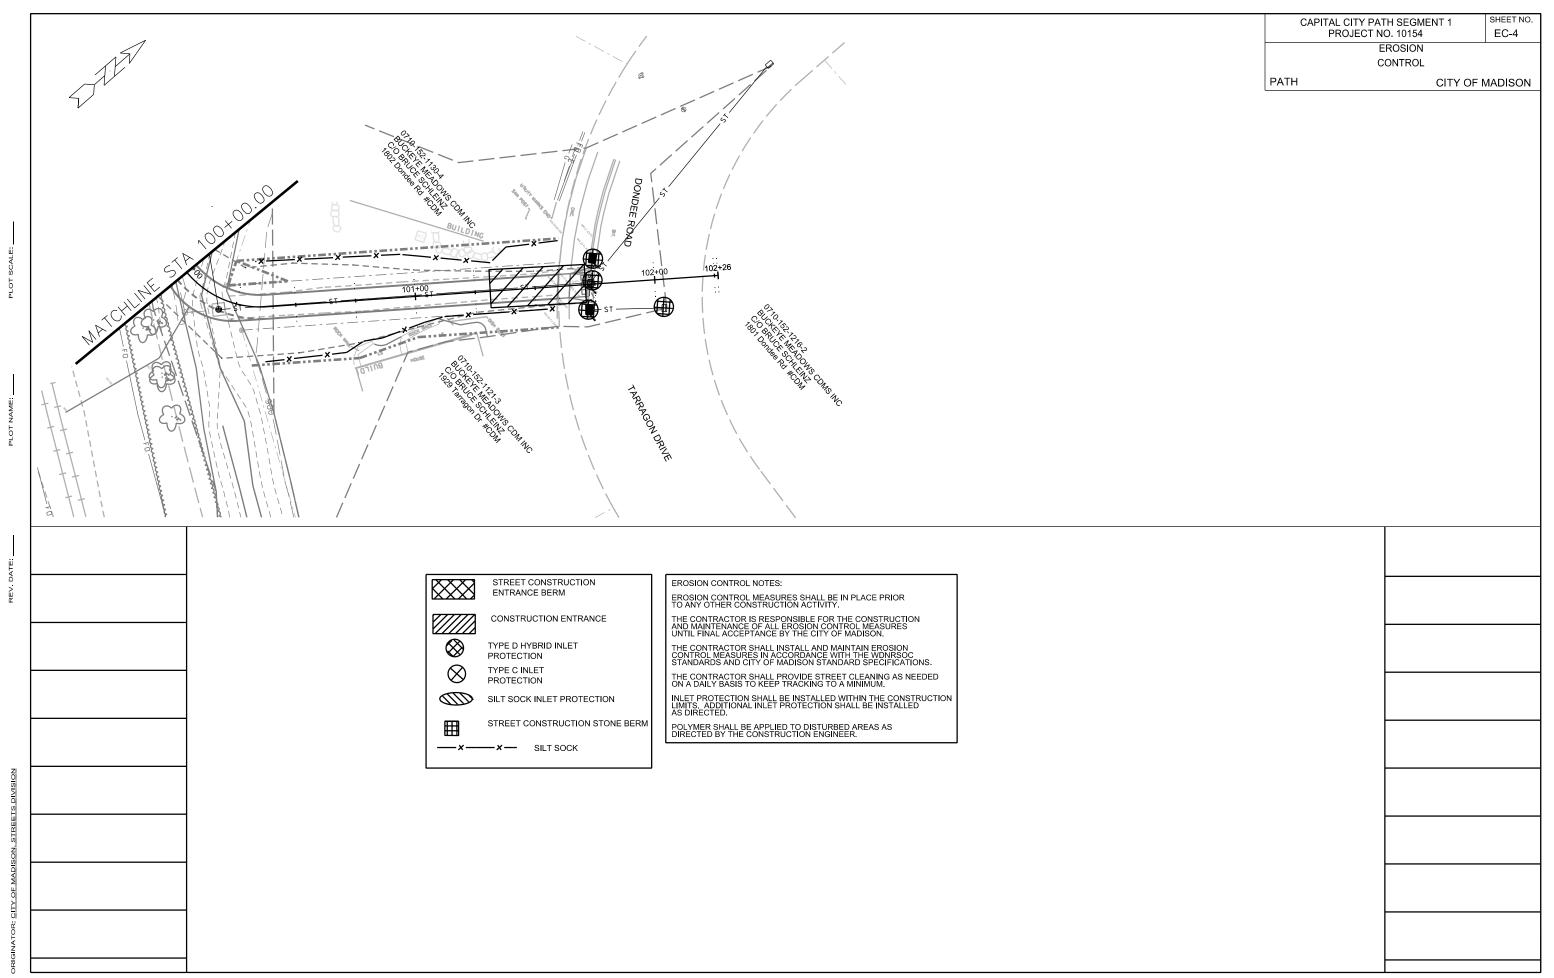

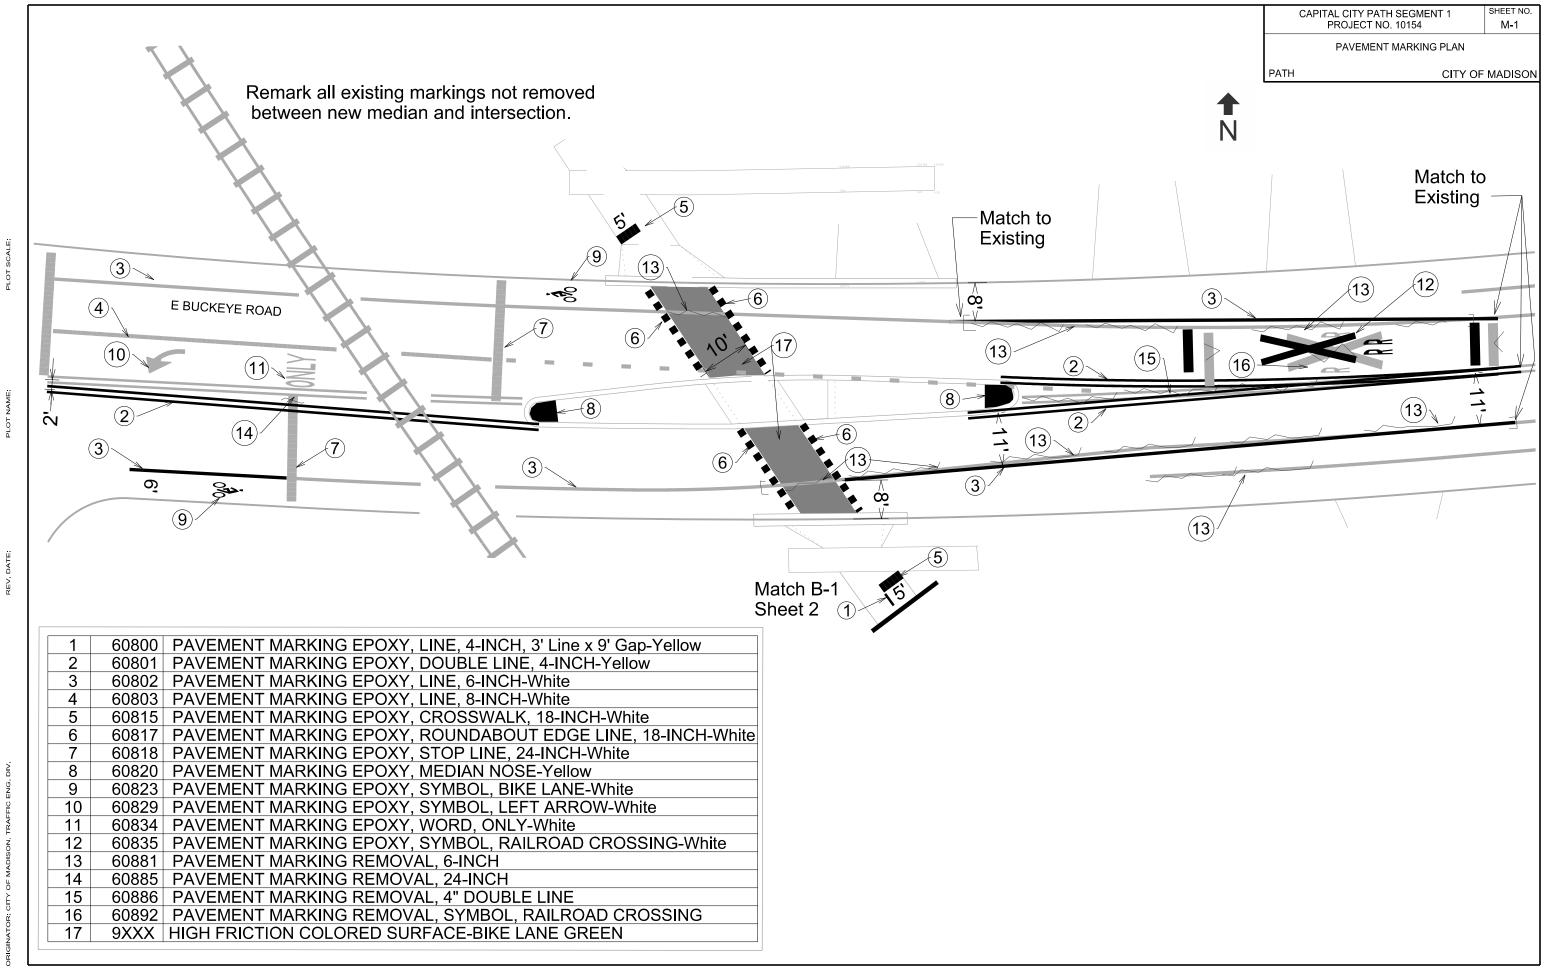


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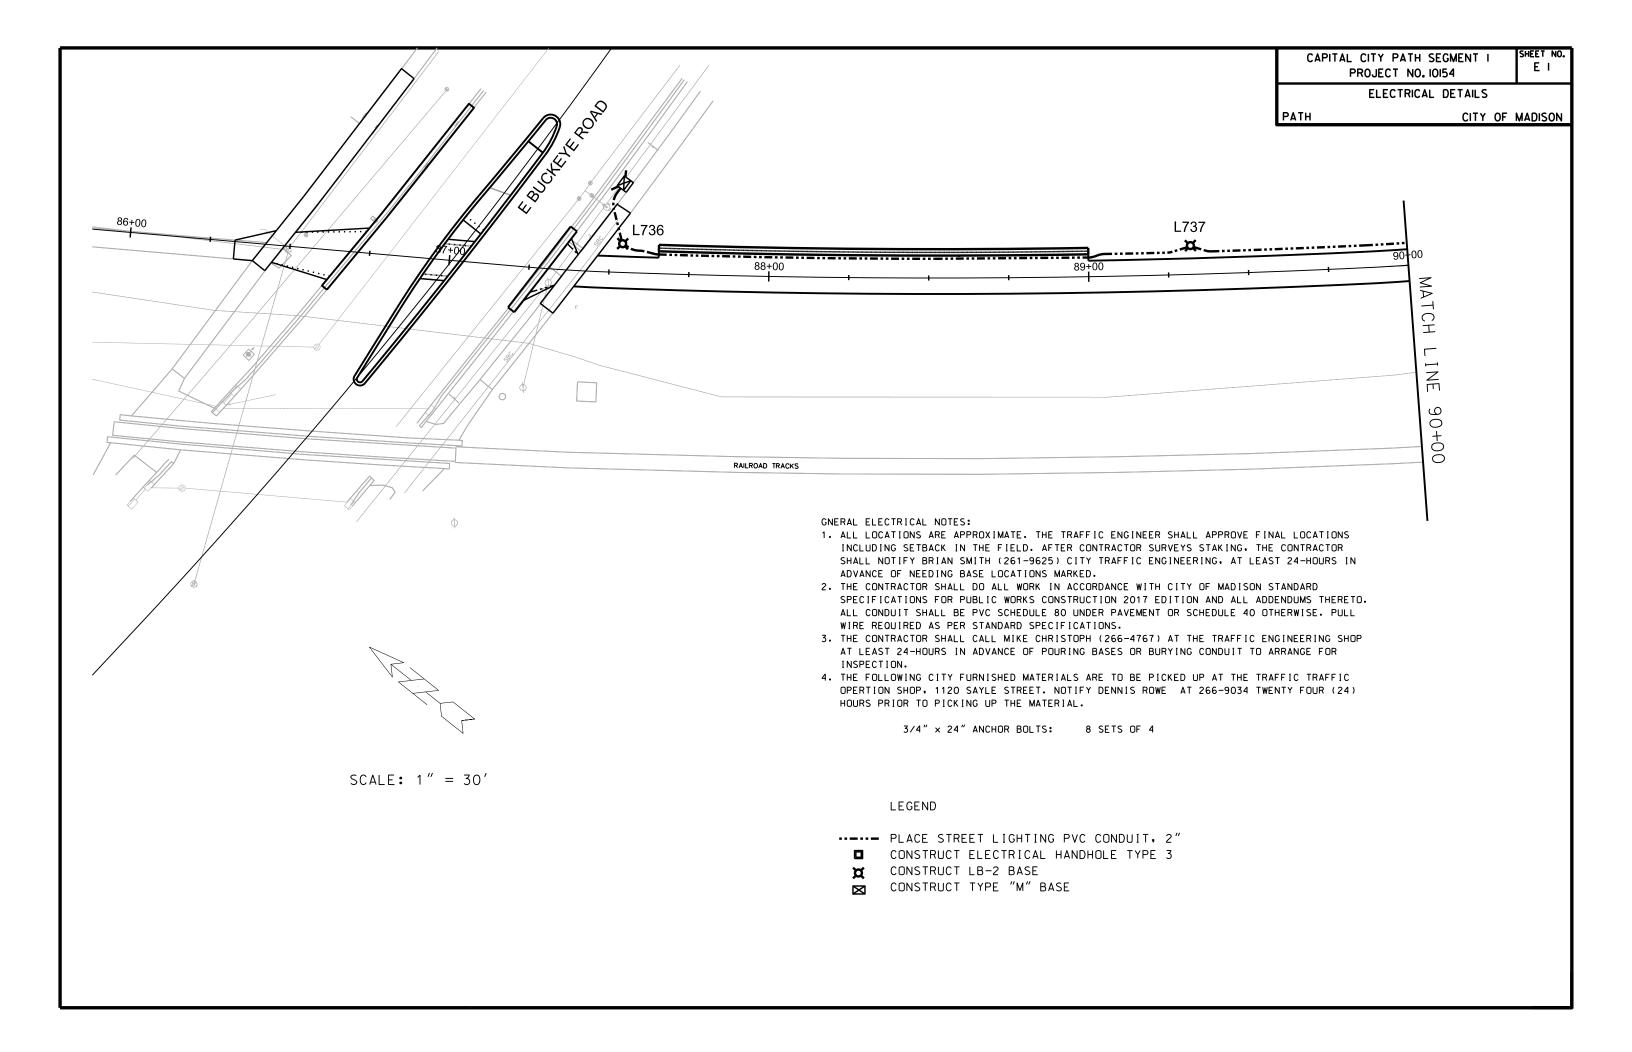
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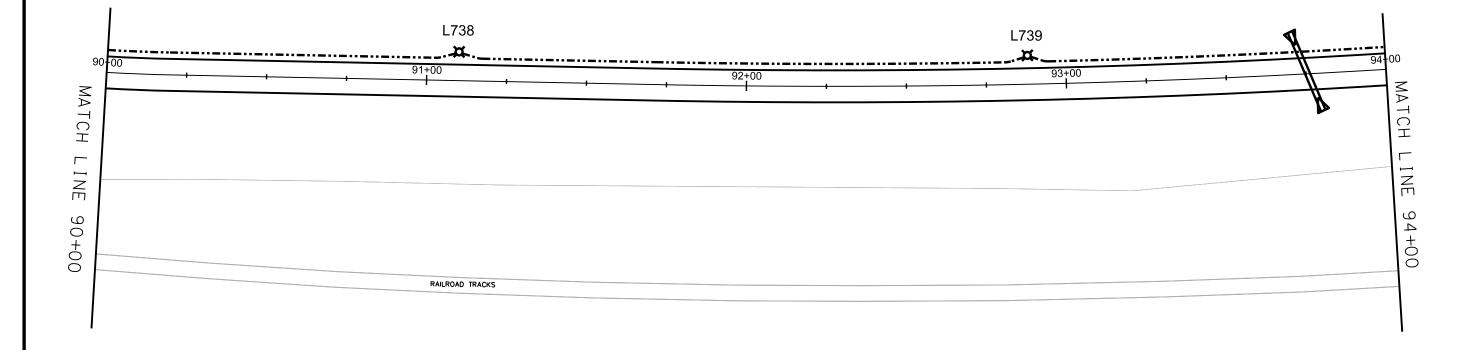
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CAPITAL CITY PATH SEGMENT I PROJECT NO. 10154


ELECTRICAL DETAILS

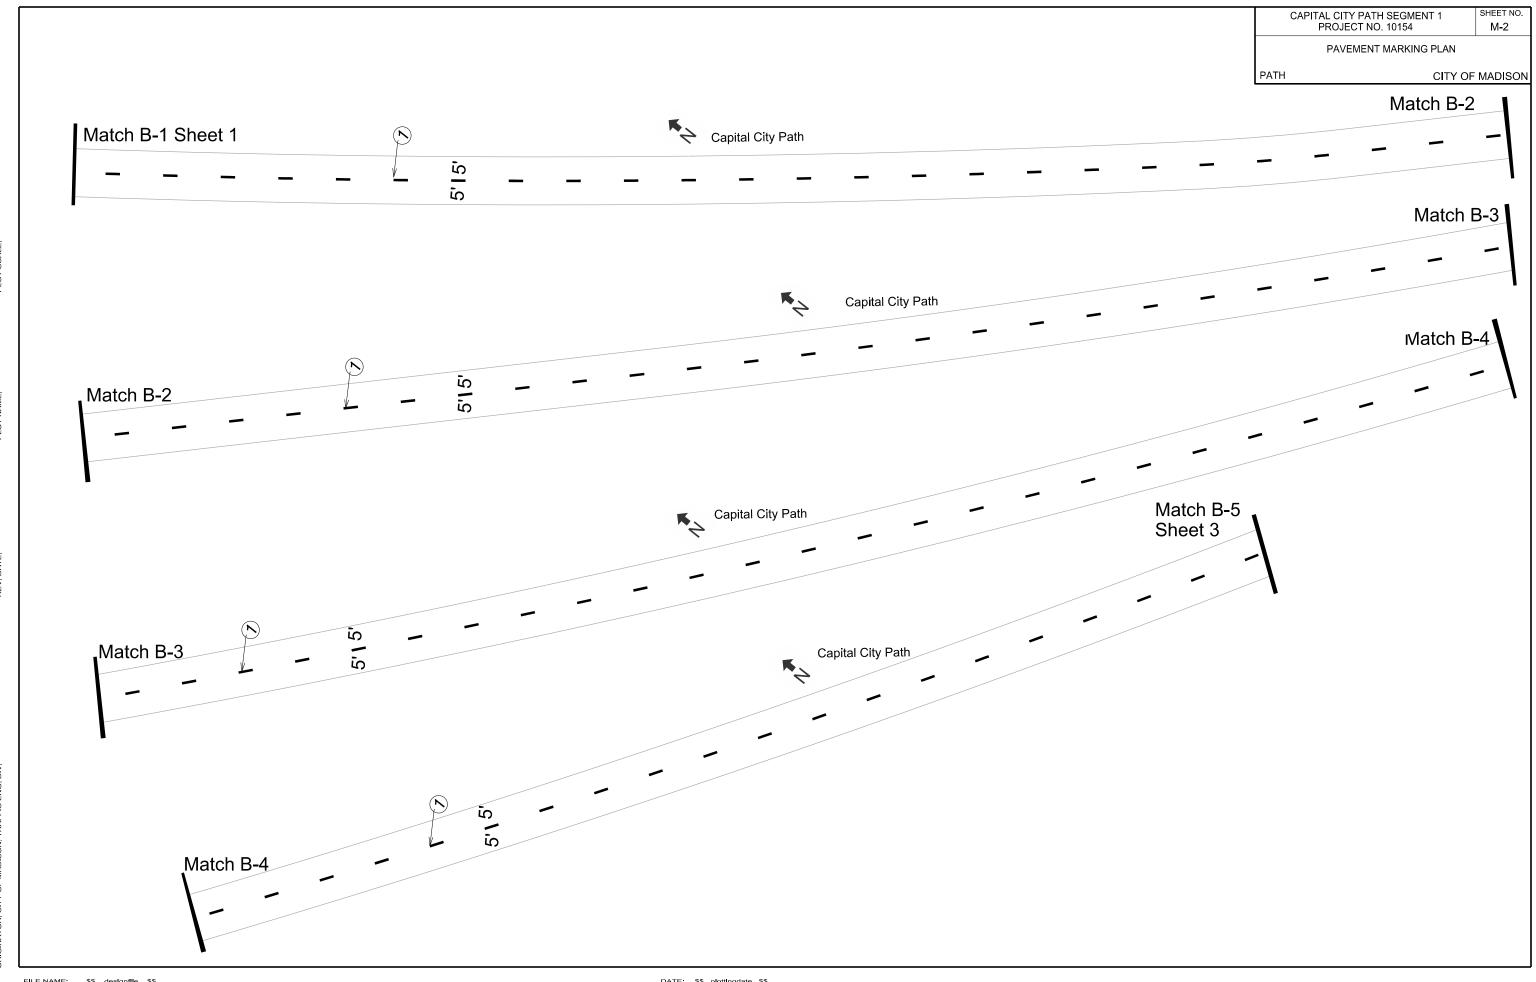PATH CITY OF MADISON



SCALE: 1'' = 30'

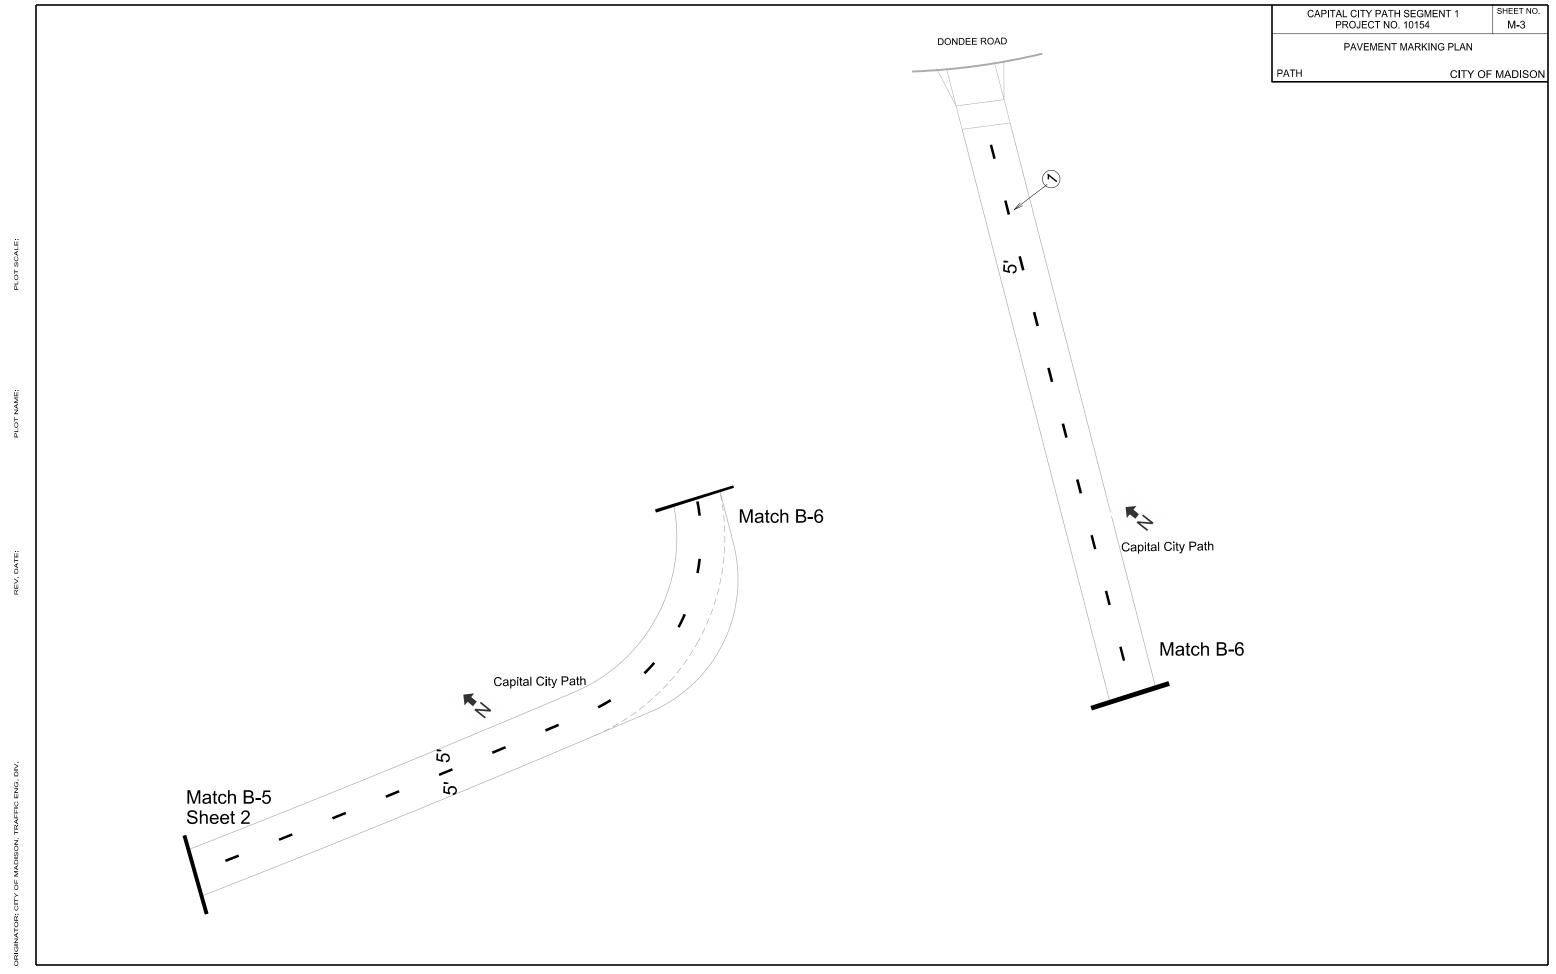		CITY PATH				E 3
		ELECTRIC	AL DI	ETAILS		
РА	TH			CITY	OF	MADISON

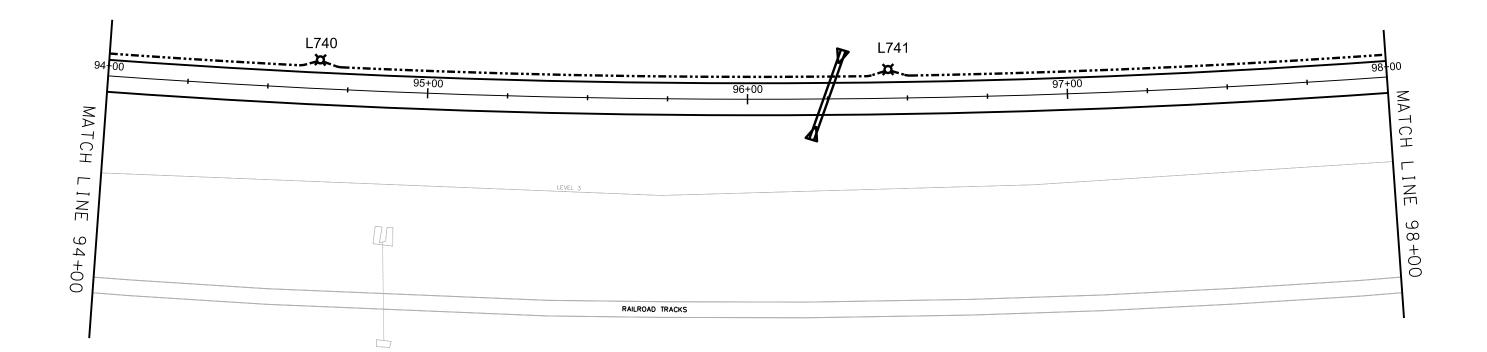

SCALE: 1" = 30'

