PROJECT:



GRAND ARBOR RESERVE

BIRCHWOOD POINT, LOT-1 10203 MINERAL POINT ROAD MADISON, WISCONSIN

OWNER:

GRAND ARBOR RESERVE, LLC

6417 ODANA RD MADISON, WISCONSIN 53719 CONTACT: DAN SCHMIDT

PHONE: 608-285-8680 FAX: 608-255-3387 email: dans@rentfmi.com

ARCHITECT:

ULIAN KISSIOV

476 PRESIDENTIAL LANE MADISON, WISCONSIN 53711

PHONE: 608-320-3151


email: ukissiov@charter.net

CIVIL ENGINEER:

D'ONOFRIO KOTTKE & ASSOC., INC.

7530 WESTWARD WAY MADISON, WISCONSIN 53717

CONTACT: DAN DAY PHONE: 608-833-7530 email: dday@donofrio.cc

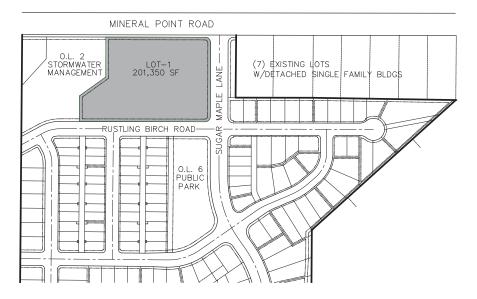

LOCATION MAP

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UNIT MIX:

UNIT TYPE	# UNITS	% OF TOTAL
STUDIO .	15	15%
ONE BEDROOM	39	39%
ONE BEDROOM+DEN	14	14%
TWO BEDROOM	24	24%
TWO BEDROOM+DEN	6	6%
THREE BEDROOM	2	2%
	100	100%

BUILDING AREA:

FLOOR		SQ.F.	
UNDERGR.	PARKING	38,570	
FIRST FLO	OR	44,200	
SECOND F	LOOR	38,700	
THIRD FLO	OR	38,700	
TOTAL		160,170	







BUILDING B S/W - COLORS



COMPOPSITE WOOD SIDING

BUILDING A

COMPOSITE WOOD PANELS FIBERCEMENT PANELS @ FIRST 2' AFF








GRAND ARBOR RESERVE
10203 MINERAL POINT ROAD, MADISON, WI
CLIENT:
GRAND ARBOR RESERVE, L
6417 ODANA RD, MADISON, WI 53719

PROJECT: 2014-02 CAD\FILE: DRAWN BY: U.K. DATE: 08/04/14



ALUMINUM RAILING CLEAR ANODIZED FINISH

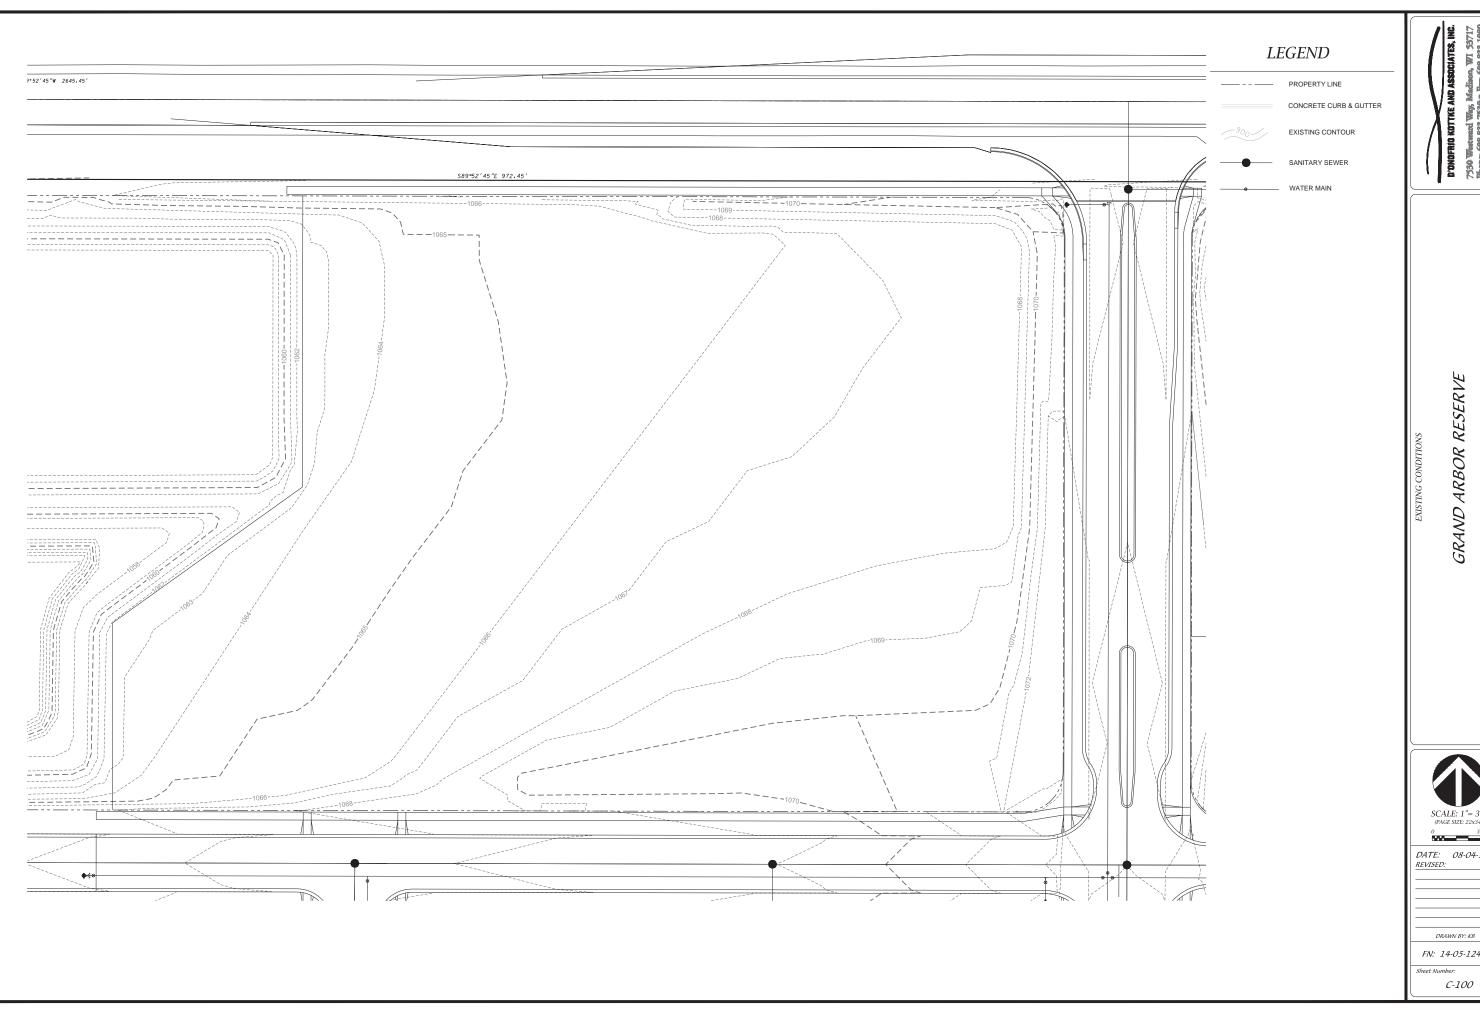


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OR RESERVE

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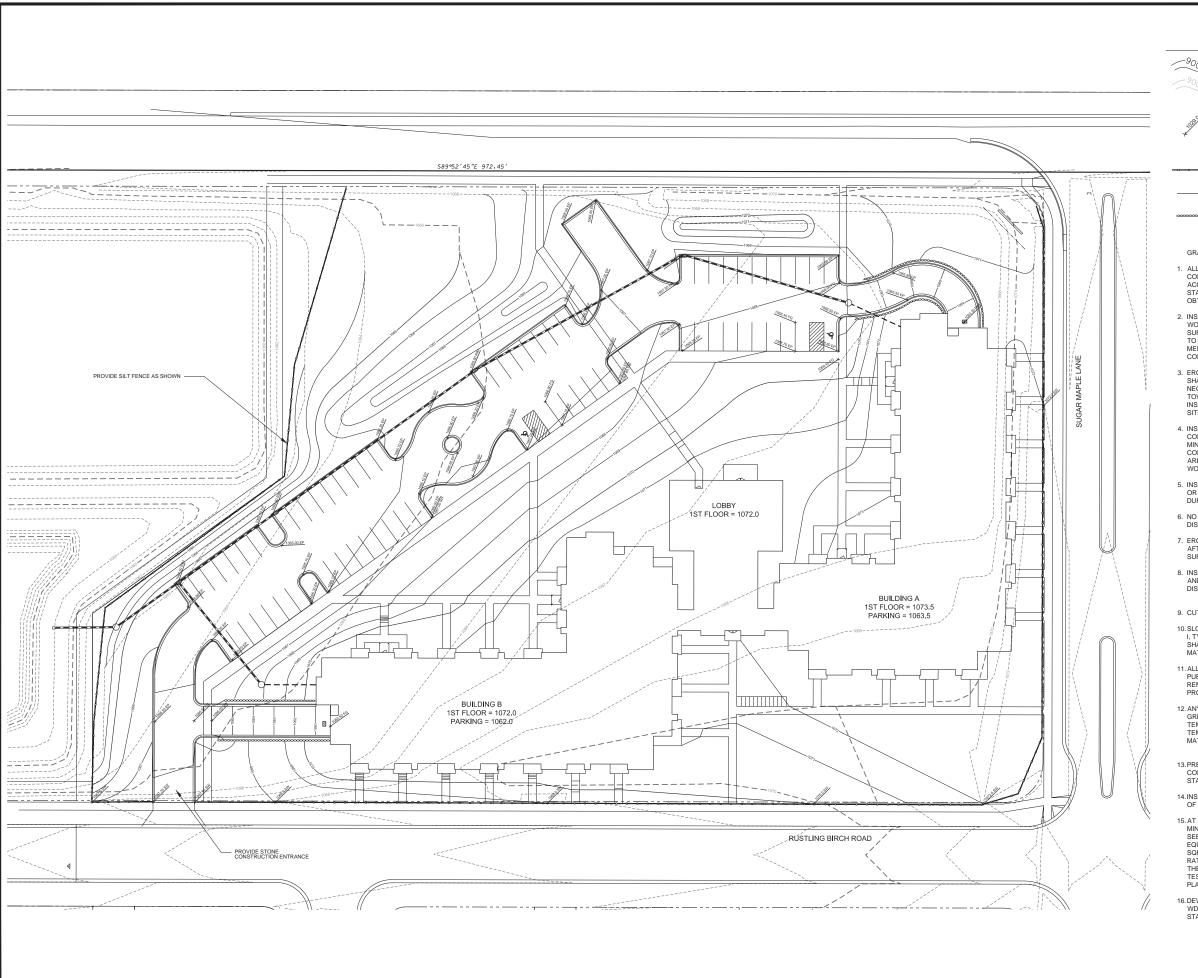
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LEGEND

PROPOSED CONTOUR

EXISTING CONTOUR

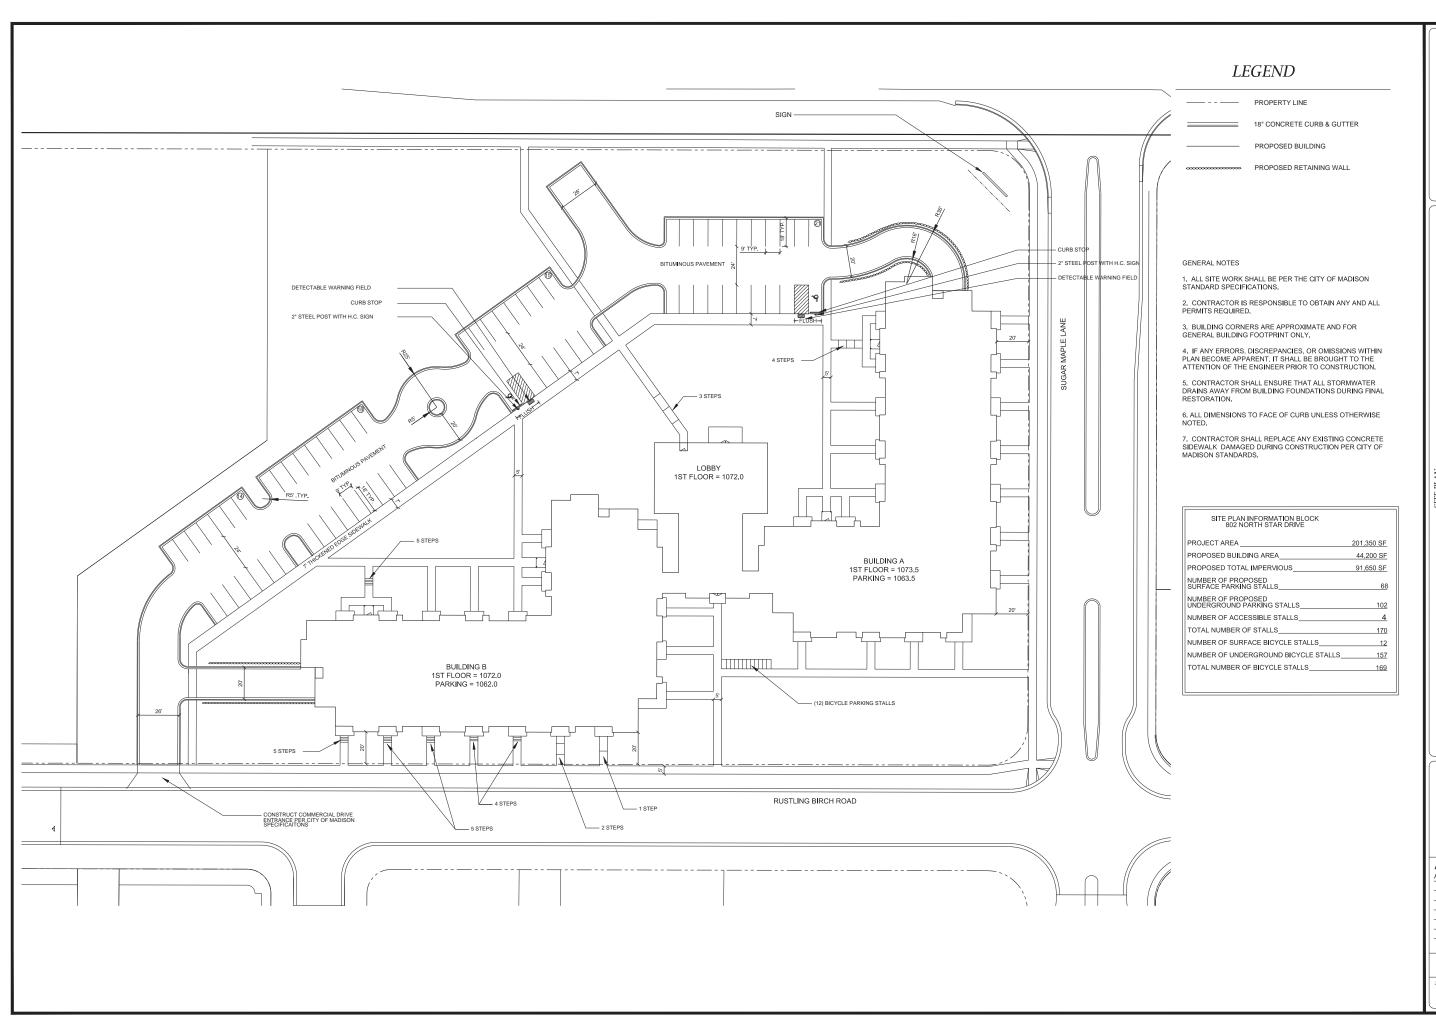

SPOT ELEVATION EP - EDGE OF PAVEMENT FG - FINISHED GRADE

SW - SIDEWALK
TW - TOP OF WALL (GROUND ELEVATION)
BW - BOTTOM OF WALL (GROUND ELEVATION)
RIM - INLET RIM

SILT FENCE

PROPOSED BUILDING

PROPOSED RETAINING WALL

GRADING AND EROSION CONTROL NOTES:

- ALL EROSION CONTROL MEASURES SHALL BE CONSTRUCTED AND MAINTAINED BY THE CONTRACTOR IN ACCORDANCE WITH THE WISCONSIN DNR TECHNICAL STANDARDS. IT IS THE CONTRACTOR'S RESPONSIBILITY TO OBTAIN A COPY OF THESE STANDARDS.
- 2. INSTALL EROSION CONTROL MEASURES PRIOR TO ANY SITE WORK, INCLUDING GRADING OR DISTURBANCE OF EXISTING SURFACE MATERIALS AS SHOWN ON PLAN. MODIFICATIONS TO SEDIMENT CONTROL DESIGN MAY BE CONDUCTED TO MEET UNFORESEEN FIELD CONDITIONS IF MODIFICATIONS CONFORM TO WDNR TECHNICAL STANDARDS.
- 3. FROSION CONTROL MEASURES INDICATED ON THE PLANS SHALL BE CONSIDERED MINIMUMS. IF DETERMINED
 NECESSARY DURING CONSTRUCTION THE COUNTY OR TOWN WILL REQUIRE ADDITIONAL MEASURES TO BE INSTALLED TO PREVENT SEDIMENT FROM LEAVING THE
- 4. INSPECTIONS AND MAINTENANCE OF ALL EROSION CONTROL MEASURES SHALL BE ROUTINE (ONCE PER WEEK MINIMUM) TO ENSURE PROPER FUNCTION OF EROSION CONTROLS AT ALL TIMES. EROSION CONTROL MEASURES ARE TO BE IN WORKING ORDER AT THE END OF EACH
- 5. INSPECT EROSION CONTROL MEASURES AFTER EACH 1/2" OR GREATER RAINFALL. REPAIR ANY DAMAGE OBSERVED DURING THE INSPECTION.
- 6. NO SITE GRADING OUTSIDE OF THE LIMITS OF DISTURBANCE
- 7. EROSION CONTROL MEASURES SHALL BE REMOVED ONLY AFTER SITE CONSTRUCTION IS COMPLETE WITH ALL SOIL SURFACES HAVING AN ESTABLISHED VEGETATIVE COVER
- 8. INSTALL INLET PROTECTION IN ALL STORM SEWER INLETS AND CATCH BASINS THAT MAY RECEIVE RUNOFF FROM DISTURBED AREAS
- 9. CUT AND FILL SLOPES SHALL BE NO GREATER THAN 3:1
- 10. SLOPES EXCEEDING 4:1 SHALL BE STABILIZED WITH CLASS I, TYPE B EROSION MATTING AND ALL DRAINAGE SWALES SHALL BE STABILIZED WITH CLASS II, TYPE B EROSION MATTING.
- 11. ALL INCIDENTAL MUD TRACKING OFF-SITE ONTO ADJACENT PUBLIC THOROUGHFARES SHALL BE CLEANED UP AND REMOVED BY THE END OF EACH WORKING DAY USING PROPER DISPOSAL METHODS.
- 12. ANY DISTURBED AREA THAT REMAINS INACTIVE FOR GREATER THAN 7 DAYS SHALL BE STABILIZED WITH TEMPORARY STABILIZATION METHODS SUCH AS TEMPORARY SEEDING, SOIL TREATMENT, EROSION MATTING, OR MULCH
- 13. PREVENT EXCESSIVE DUST FROM LEAVING THE CONSTRUCTION SITE IN ACCORDANCE WITH LOCAL AND STATE REGULATIONS.
- 14. INSTALL EROSION CONTROLS ON THE DOWNSTREAM SIDE OF STOCKPILES.
- 15. AT A MINIMUM ALL DISTURBED AREAS SHALL RECEIVE A MINIMUM OF 4" OF TOPSOIL FERTILIZER, SEED AND MULCH. SEE MIXTURE SHALL BE WISCONSIN DOT SEED MIX #40 OR EQUIVALENT APPLIED AT A RATE OF 5 POUNDS PER 1000 SOFT ON ALL DISTURBED AREAS. ANNUAL RYEGRASS AT A RATE OF 1½ POUNDS PER 1000 SQFT SHALL BE ADDED TO THE MIXTURE. FERTILIZER SHALL BE PLACED PER A SOIL TEST. SEE LANDSCAPE PLAN FOR A MORE DETAILED PLANTING PLAN AND LANDSCAPE DETAILS.
- 16. DEWATERING, IF APPLICABLE, SHALL BE CONDUCTED PER WDNR STORM WATER MANAGEMENT TECHNICAL STANDARD 1061.

RESERVE ARBOR GRAND



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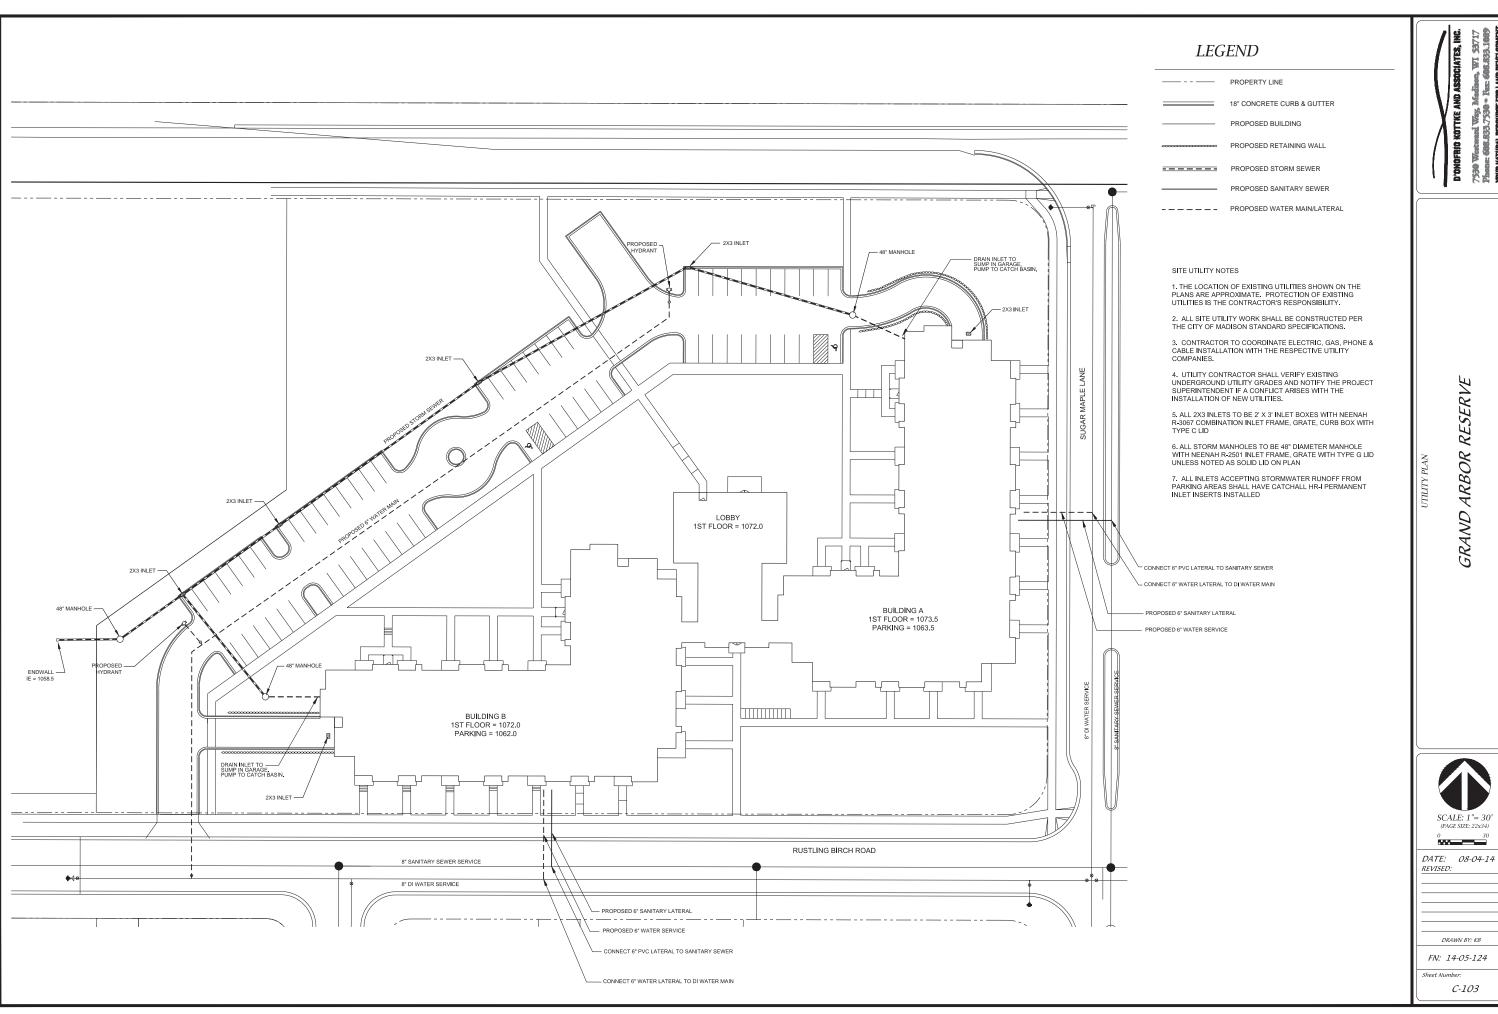
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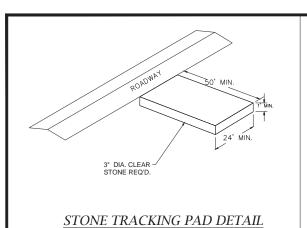
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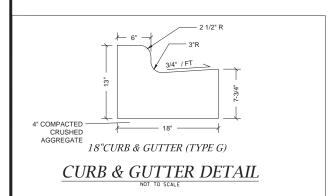
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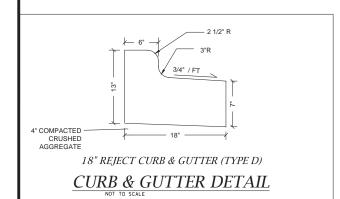
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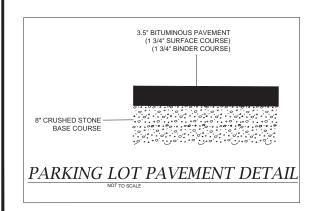



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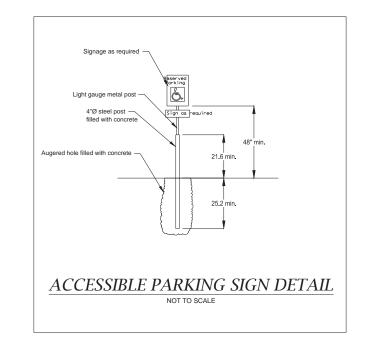












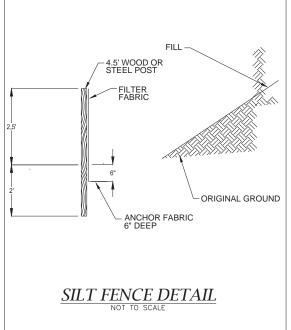

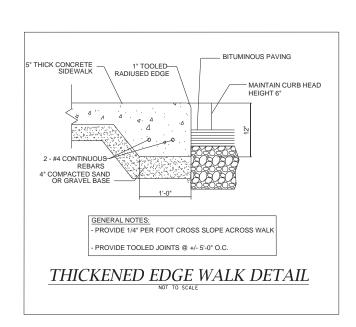

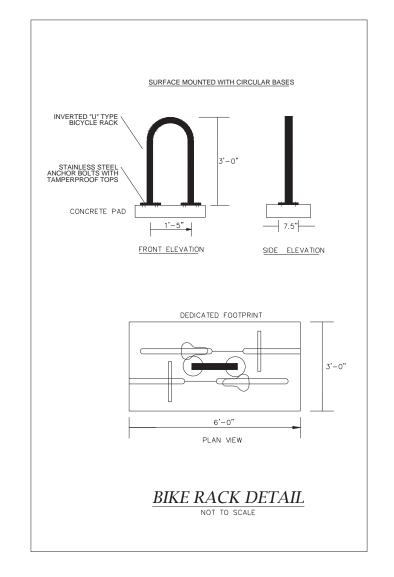






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9. ALL LANDSCAPING SHALL BE IN ACCORDANCE WITH THE CITY OF MADISON

ZONING ORDINANCE.

LANDSCAPE REQUIREMENTS SUMMARY

DEVELOPED AREA REQUIREMENT:

5 PTS PER 300 SQ FT OF DEVELOPED AREA DEVELOPED AREA = 31,890 SQ FT POINTS REQUIRED = 532 POINTS POINTS PROVIDED = 4,372 POINTS

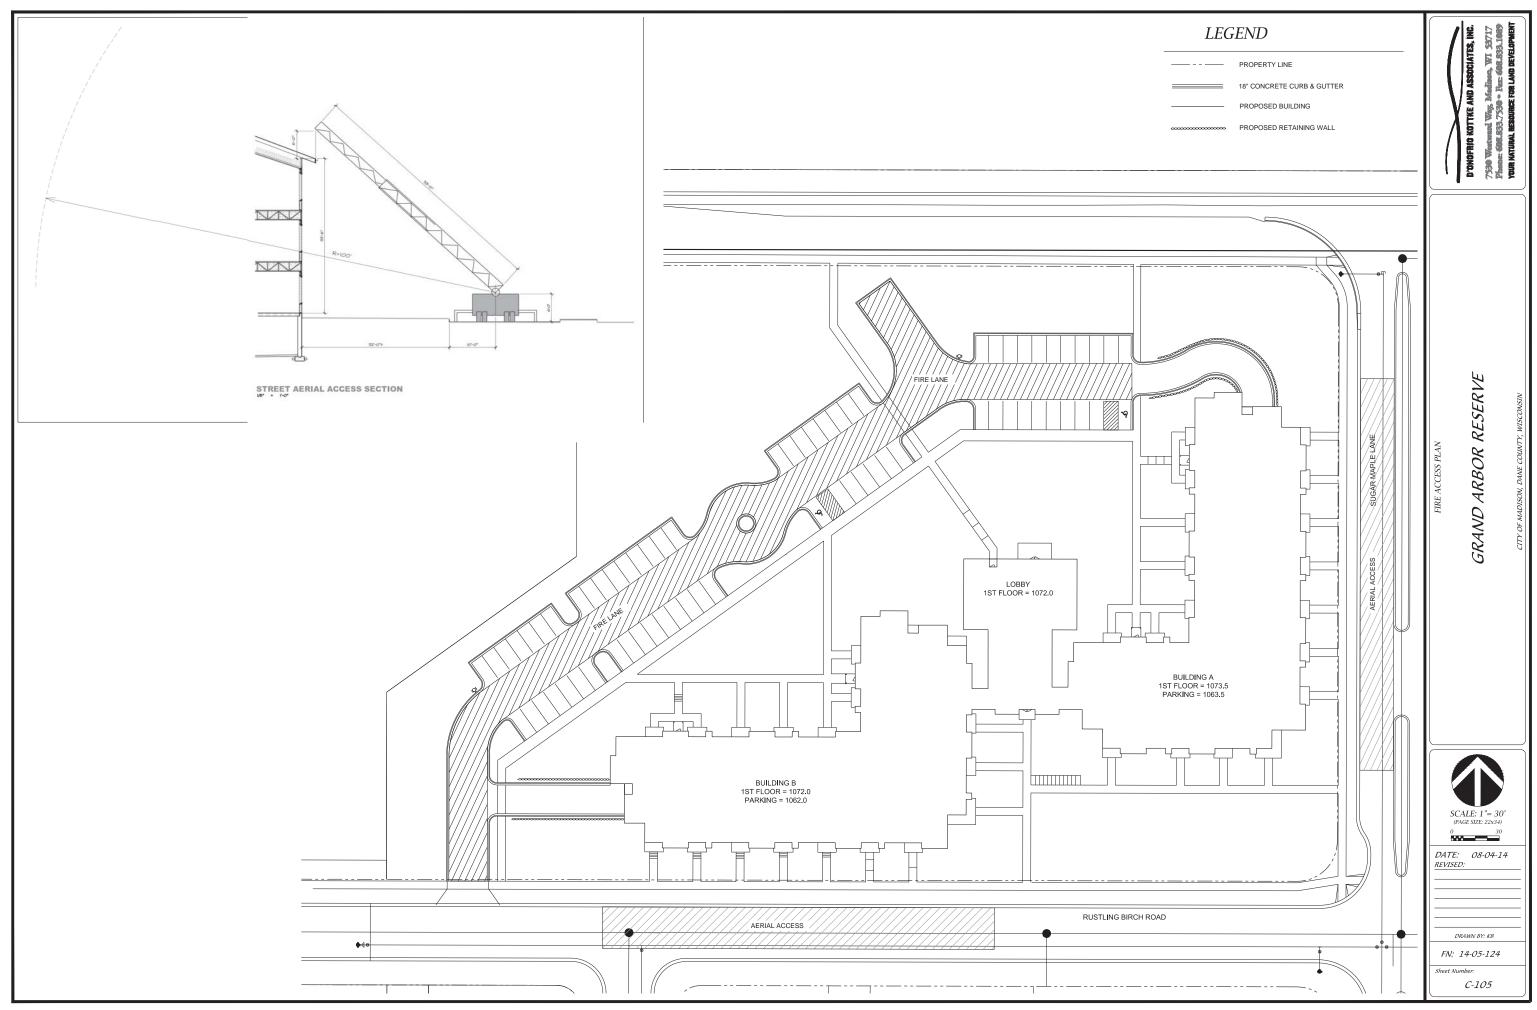STREET FRONTAGE REQUIREMENT:

1 OVERSTORY TREE OR 2 EVERGREEN & 5 SHRUB PER 30 LF

MINERAL POINT ROAD FRONTAGE = 428 FT

PLANTS REQUIRED = 14 OVERSTORY TREES OR

28 EVERGREEN TREES 72 SHRUBS

PLANTS PROVIDED = 2 OVERSTORY TREES 25 EVERGREEN TREES

73 SHRUBS

SUGAR MAPLE LANE FRONTAGE = 58 FT

PLANTS REQUIRED = 1 OVERSTORTY TREES OR

4 EVERGREEN TREES

10 SHRUBS
PLANTS PROVIDED = 1 OVERSTORY TREES

4 EVERGREEN TREES

11 SHRUBS

RUSTLING BIRCH ROAD FRONTAGE = 135 FT

PLANTS REQUIRED = 5 OVERSTORY TREES OR

10 EVERGREEN TREES

PLANTS PROVIDED = 0 OVERSTORY TREES

8 EVERGREEN TREES 24 SHRUBS

PARKING LOT LANDSCAPING REQUIREMENT:

REQUIRED LANDSCAPED AREA = 8% OF DEVELOPED LOT= 2,552 SQ FT AREA PROVIDED = 3,542 SQ FT

PLANT REQUIREMENT = 1 OT PER 160 SQ FT OF REQ'D AREA = 16 OT PLANTS PROVIDED = 16 OT

PLANTING SCHEDULE

CODE	SCIENTIFIC NAME	COMMON NAME	ОТУ	PTS PER	SUB-	SIZE	ROOT	NOTE
	STORY DECIDUOUS TREES	COMINION NAME	QII	PLANT	TOTAL	SIZE	COND	NOTE
	Acer x freemanii 'Autumn Fantasy'	Ta	5	35	175	2.5"	B&B	
		Autumn Fantasy Maple						
	Acer x freemanii 'Sienna Glen'	Sienna Glen Maple	5	35	175	2.5"	B&B	
	Celtis occidentalis	Hackberry	6	35	210	2.5"	B&B	
	Gymnocladus dioica 'Espresso'	Espresso Kentucky Coffee Tree	3	35	105	2.5"	B&B	
	Nyssa sylvatica 'Wildfire'	Wildfire Black Gum	1	35	35	2.5"	B&B	
	Pyrus calleryana 'Autumn Blaze'	Autumn Blaze Pear	5	35	175	2.5"	B&B	
	Quercus macrocarpa	Bur Oak	1	35	35	2.5"	B&B	
	Tilia americana 'Redmond'	Redmond Linden	3	35	105	2.5"	B&B	
	Ulmus 'New Horizon'	New Horizon Elm	4	35	140	2.5"	B&B	
STREE	T TREES (BY CITY)							
AFC	Acer x freemanii 'Celzam'	Celebration Maple	5	-		2.5"	B&B	
GBP	Ginkgo biloba 'Princeton Sentry	Princeton Sentry Ginkgo	7			2.5"	B&B	
	Ulmus 'New Horizon'	New Horizon Elm	5	-		2.5"	B&B	
TALLE	VERGREEN TREE							
AC	Abies concolor	Concolor Fir	13	35	455	6' TALL	B&B	
	Picea glauca v. densata	Black Hills Spruce	16	35	560	6' TALL	B&B	
	Pinus strobus	Eastern White Pine	8	35	280	6' TALL	B&B	
	MENTAL TREE	Lastern vvriite rine	1 0	- 55	200	0 IALL	Dab	
		Autor Brillians Control	1 0	15	90	4.511	B&B	
	Amelanchier x grandiflora 'Autumn Brilliance' Carpinus caroliniana	Autumn Brilliance Serviceberry Musclewood	6 7	15	105	1.5"	B&B B&B	
		Musciewood	_ /	15	105	1.5	B&B	
	HT EVERGREEN SHRUB	h	_			=		
	Juniperus scopulorum 'Welchi'	Welch Juniper	7	10	70	4' TALL	B&B	
	Taxus x media 'Hicksii'	Hick's Yew	8	10	80	4' TALL	B&B	
	Thuja occidentalis 'Smaragd'	Pyramidal Arborvitae	11	10	110	4' TALL	B&B	
	UOUS SHRUB							
	Clethra alnafolia 'Hummingbird'	Hummingbird Clethra	12	3	36	24" TALL	POT	
	Cephalanthus occidentalis	Buttonbush	18	3	54	36" TALL	POT	
	Cornus sericea 'Ivory Halo'	Ivory Halo Red Twig Dogwood	13	3	39	36" TALL	POT	
	Diervilla Ionicera	Dwarf Bush Honeysuckle	15	3	45	24" TALL	POT	
	Fothergilla 'Mt. Airy'	Mt. Airy Fothergilla	7	3	21	24" TALL	POT	
	Hypericum kalmianum 'Deppe'	Sunny Boulevard St. John's Wort	12	3	36	24" TALL	POT	
	Hydrangea macrophylla 'Endless Summer'	Endless Summer Hydrangea	9	3	27	24" TALL	POT	
	Hammelis virginiana	Witchhazel	11	3	33	36" TALL	POT	
	Physocarpus opulifolius 'Seward'	Summer Wine Ninebark	27	3	81	36" TALL	POT	
RA	Rhus aromatica 'Gro-lo'	Grow Low Sumac	21	3	63	24" TALL	POT	
RT	Rhus typhina 'Bailtiger'	Tiger Eyes Sumac	52	3	156	24" TALL	POT	
SM	Syringa 'Minuet'	Minuet Canada Hybrid Lilac	16	3	48	36" TALL	POT	
VDC	Viburnum dentatum 'Christom'	Blue Muffin Viburnum	23	3	69	36" TALL	POT	
WFR	Weigela florida 'Rumba'	Rumba Weigela	21	3	63	18" TALL	POT	
EVERG	REEN SHRUB							
CPG	Chamaecyparis pisifera 'Golden Mop'	Gold Mop False Cypress	15	4	60	24" TALL	POT	
	Juniperus sabina 'Mona'	Calgary Carpet Juniper	10	4	40	3 GAL	POT	
	Rhododendron 'PJM'	PJM Rhododendron	13	4	52	24" TALL	POT	
	Taxus x media 'Tauntonii'	Taunton Yew	12	4	48	24" TALL	POT	
	Thuja occidentalis 'Rheingold	Rheingold Arborvitae	18	4	72	24" TALL	POT	
	MENTAL GRASSES		, ,,,				,	
	Calamagrostis x acutiflora 'Karl Foerster'	Feather Reed Grass	50	2	100	1 GAL	POT	
	Deschampsia cespitosa 'Northern Lights'	Northern Lights Tufted Hair Grass	18	2	36	1 GAL	POT	
	Elymus hystrix	Bottle Brush Grass	53	2	106	1 GAL	POT	
	Panicum virgatum 'Shenandoah'	Shenandoah Switchgrass	15	2	30	1 GAL	POT	
	Sporobolus Heterolepsis	Prairie Dropseed	30	2	60	1 GAL	POT	
	Schizachvrium Scoparium 'Blaze'	Blaze Little Bluestem	12	2	24	1 GAL	POT	
	Helictotrichon sempervirens 'Saphirsprudel'	Blue Oat Grass	34	2	68	1 GAL	POT	
							POLL	

DFRIO KOTTKE AND ASSOCIATES, INC.
Westward Way, Madians, WI 53717
= 608.833.7530 * Fare 608.833.1089
ATUMAL RESOURCE FOR LAND DEVELOPMENT

GRAND ARBOR RESERVE




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SITE LANDSCAPE PLAN - GENERAL NOTES

- 1. CONTACT DIGGER'S HOTLINE 3 WORKING DAYS PRIOR TO THE START OF CONSTRUCTION.
- 2. CONTRACTOR SHALL VERIFY THE LOCATION OF ALL THE PRIVATE UTILITIES PRIOR TO THE START OF WORK.

 3. ALL LANDSCAPE BEDS SHALL CONTAIN A 3" DEPTH OF SHREDDED
- HARDWOOD CONTAINED BY LANDSCAPE EDGING.
- 4. LANDSCAPE EDGING SHALL BE 3/16" x 4" ALUMINUM EDGING.
- 6. ALL TREES IN TURF AREAS SHALL HAVE A 5' DIAMETER CIRCLE OF 3" DEPTH SHREDDED HARDWOOD BARK MULCH CONTAINED BY LANDSCAPE EDGING.
- 7. ALL GENERAL TURF AREAS SHALL BE FINISH GRADED, AND SODDED OR SEEDED PER THE PROJECT MANUAL
- 8. ALL GENERAL LANDSCAPE AREAS SHALL HAVE A MINIMUM 6" COMPACTED DEPTH OF TOPSOIL.
- 9. ALL LANDSCAPING SHALL BE IN ACCORDANCE WITH THE CITY OF MADISON ZONING ORDINANCE.

PLANTING SCHEDULE

CODE	SCIENTIFIC NAME	COMMON NAME	QTY	PTS PER PLANT		SIZE	ROOT	NOTES
VERS	STORY DECIDUOUS TREES							
	Acer x freemanii 'Autumn Fantasy'	Autumn Fantasy Maple	5	35	175	2.5"	B&B	
	Acer x freemanii 'Sienna Glen'	Sienna Glen Maple	5	35	175	2.5"	B&B	
	Celtis occidentalis	Hackberry	6	35	210	2.5"	B&B	
	Gymnocladus dioica 'Espresso'	Espresso Kentucky Coffee Tree	3	35	105	2.5"	B&B	
	Nyssa sylvatica 'Wildfire'	Wildfire Black Gum	1	35	35	2.5"	B&B	
	Pyrus calleryana 'Autumn Blaze'	Autumn Blaze Pear	5	35	175	2.5"	B&B	
	Quercus macrocarpa	Bur Oak	1	35	35	2.5"	B&B	
	Tilia americana 'Redmond'	Redmond Linden	3	35	105	2.5"	B&B	
	Ulmus 'New Horizon'	New Horizon Elm	4	35	140	2.5"	B&B	
	T TREES (BY CITY)	New Horizon Eini	-4	35	140	2.5	Dab	
		la				0.50		
	Acer x freemanii 'Celzam'	Celebration Maple	5	-		2.5"	B&B	
	Ginkgo biloba 'Princeton Sentry	Princeton Sentry Ginkgo	7	-		2.5"	B&B	
	Ulmus 'New Horizon'	New Horizon Elm	5	-		2.5"	B&B	
	VERGREEN TREE		,					
	Abies concolor	Concolor Fir	13	35	455	6' TALL	B&B	
	Picea glauca v. densata	Black Hills Spruce	16	35	560	6' TALL	B&B	
	Pinus strobus	Eastern White Pine	8	35	280	6' TALL	B&B	
	MENTAL TREE							
AGA	Amelanchier x grandiflora 'Autumn Brilliance'	Autumn Brilliance Serviceberry	6	15	90	1.5"	B&B	
CC	Carpinus caroliniana	Musclewood	7	15	105	1.5"	B&B	
IPRIG	HT EVERGREEN SHRUB		•					
JSW	Juniperus scopulorum 'Welchi'	Welch Juniper	7	10	70	4' TALL	B&B	
	Taxus x media 'Hicksii'	Hick's Yew	8	10	80	4' TALL	B&B	
	Thuja occidentalis 'Smaragd'	Pyramidal Arborvitae	11	10	110	4' TALL	B&B	
	UOUS SHRUB	, ,						
	Clethra alnafolia 'Hummingbird'	Hummingbird Clethra	12	3	36	24" TALL	POT	
	Cephalanthus occidentalis	Buttonbush	18	3	54	36" TALL	POT	
	Cornus sericea 'Ivory Halo'	Ivory Halo Red Twig Dogwood	13	3	39	36" TALL	POT	
DL	Diervilla Ionicera	Dwarf Bush Honeysuckle	15	3	45	24" TALL	POT	
	Fothergilla 'Mt. Airv'	Mt. Airy Fothergilla	7	3	21	24" TALL	POT	
	Hypericum kalmianum 'Deppe'	Sunny Boulevard St. John's Wort	12	3	36	24" TALL	POT	
	Hydrangea macrophylla 'Endless Summer'	Endless Summer Hydrangea	9	3	27	24" TALL	POT	
HV	Hammelis virginiana	Witchhazel	11	3	33	36" TALL	POT	
	Physocarpus opulifolius 'Seward'	Summer Wine Ninebark	27	3	81	36" TALL	POT	
RA	Rhus aromatica 'Gro-lo'	Grow Low Sumac	21	3	63	24" TALL	POT	
	Rhus typhina 'Bailtiger'	Tiger Eyes Sumac	52	3	156	24" TALL	POT	
	Syringa 'Minuet'	Minuet Canada Hybrid Lilac	16	3	48	36" TALL	POT	
	Viburnum dentatum 'Christom'	Blue Muffin Viburnum	23	3	69	36" TALL	POT	
	Weigela florida 'Rumba'	Rumba Weigela	21	3	63	18" TALL	POT	
	REEN SHRUB	,						
	Chamaecyparis pisifera 'Golden Mop'	Gold Mop False Cypress	15	4	60	24" TALL	POT	
	Juniperus sabina 'Mona'	Calgary Carpet Juniper	10	4	40	3 GAL	POT	
RP	Rhododendron 'PJM'	PJM Rhododendron	13	4	52	24" TALL	POT	
	Taxus x media 'Tauntonii'	Taunton Yew	12	4	48	24" TALL	POT	
	Thuja occidentalis 'Rheingold	Rheingold Arborvitae	18	4	72	24" TALL	POT	
	MENTAL GRASSES	, , , , , , , , , , , , , , , , , , , ,						
	Calamagrostis x acutiflora 'Karl Foerster'	Feather Reed Grass	50	2	100	1 GAL	POT	
	Deschampsia cespitosa 'Northern Lights'	Northern Lights Tufted Hair Grass	18	2	36	1 GAL	POT	
	Elymus hystrix	Bottle Brush Grass	53	2	106	1 GAL	POT	
	Panicum virgatum 'Shenandoah'	Shenandoah Switchgrass	15	2	30	1 GAL	POT	
	Sporobolus Heterolepsis	Prairie Dropseed	30	2	60	1 GAL	POT	
SS	Schizachyrium Scoparium 'Blaze'	Blaze Little Bluestem	12	2	24	1 GAL	POT	
	Helictotrichon sempervirens 'Saphirsprudel'	Blue Oat Grass	34	2	68	1 GAL	POT	

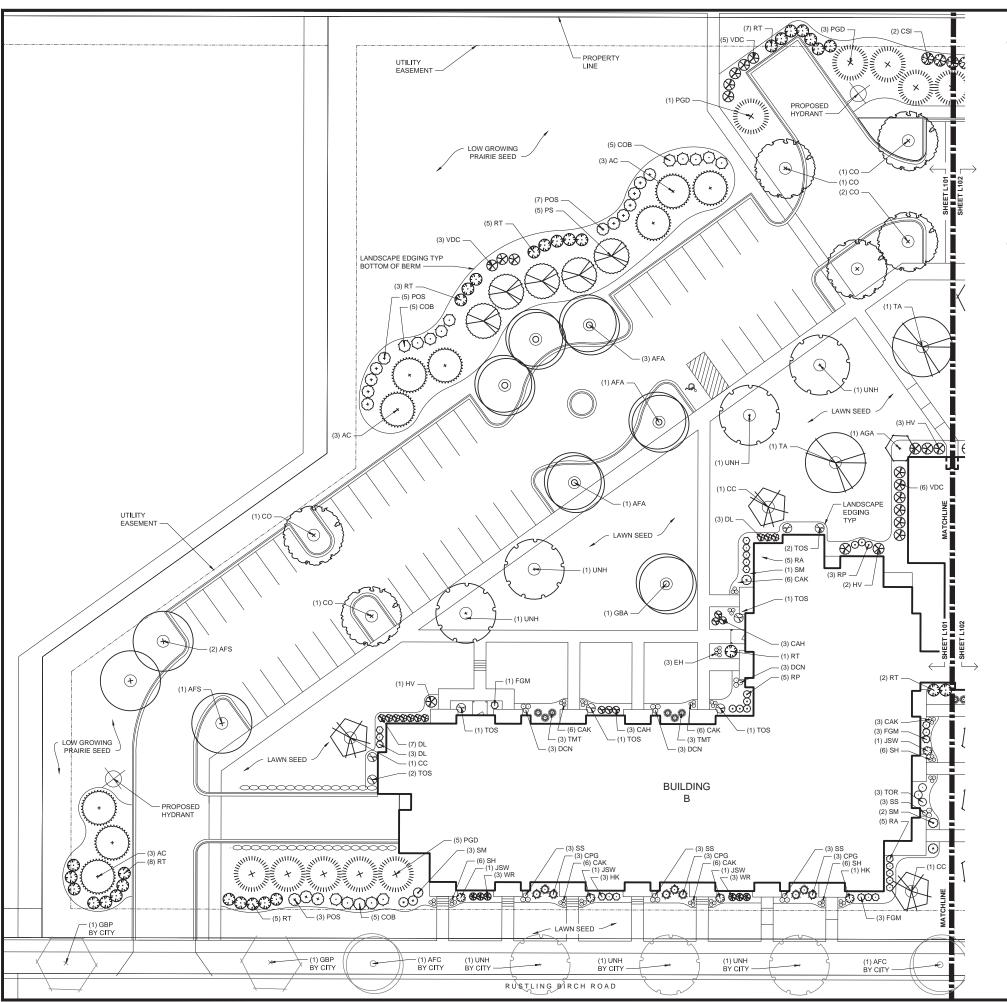
RESERVE GRAND ARBOR



DATE: 08-04-14 REVISED:

FN: 14-05-124

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SITE LANDSCAPE PLAN - GENERAL NOTES

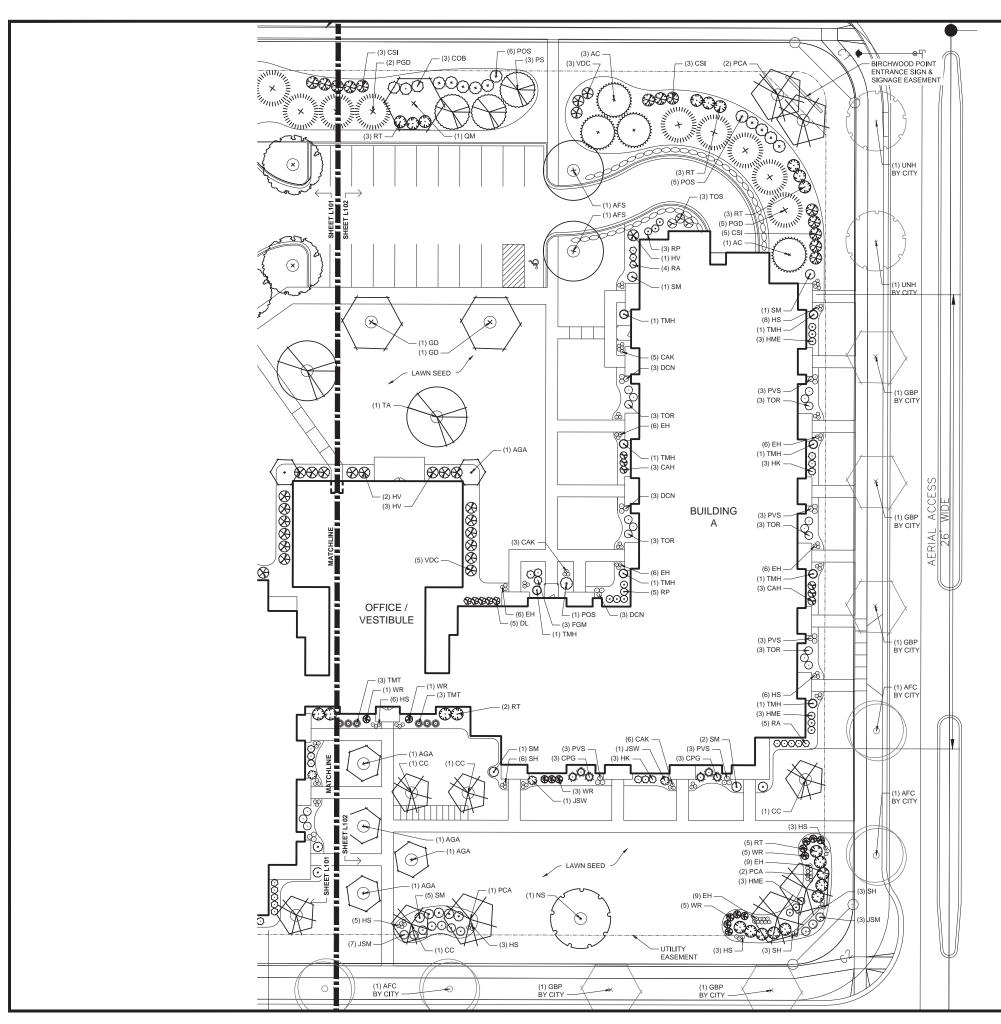- 1. CONTACT DIGGER'S HOTLINE 3 WORKING DAYS PRIOR TO THE START OF CONSTRUCTION.
- 2. CONTRACTOR SHALL VERIFY THE LOCATION OF ALL THE PRIVATE UTILITIES PRIOR TO THE START OF WORK.

 3. ALL LANDSCAPE BEDS SHALL CONTAIN A 3" DEPTH OF SHREDDED
- HARDWOOD CONTAINED BY LANDSCAPE EDGING.
- 4. LANDSCAPE EDGING SHALL BE 3/16" x 4" ALUMINUM EDGING.
- 6. ALL TREES IN TURF AREAS SHALL HAVE A 5' DIAMETER CIRCLE OF 3" DEPTH SHREDDED HARDWOOD BARK MULCH CONTAINED BY LANDSCAPE EDGING.
- 7. ALL GENERAL TURF AREAS SHALL BE FINISH GRADED, AND SODDED OR SEEDED PER THE PROJECT MANUAL
- 8. ALL GENERAL LANDSCAPE AREAS SHALL HAVE A MINIMUM 6" COMPACTED DEPTH OF TOPSOIL.
- 9. ALL LANDSCAPING SHALL BE IN ACCORDANCE WITH THE CITY OF MADISON ZONING ORDINANCE.

PLANTING SCHEDULE

				PTS PER	SUB-		ROOT	
	SCIENTIFIC NAME	COMMON NAME	QTY	PLANT	TOTAL	SIZE	COND	NOTE
OVERS	STORY DECIDUOUS TREES							
AFA	Acer x freemanii 'Autumn Fantasy'	Autumn Fantasy Maple	5	35	175	2.5"	B&B	
AFS	Acer x freemanii 'Sienna Glen'	Sienna Glen Maple	5	35	175	2.5"	B&B	
CO	Celtis occidentalis	Hackberry	6	35	210	2.5"	B&B	
GD	Gymnocladus dioica 'Espresso'	Espresso Kentucky Coffee Tree	3	35	105	2.5"	B&B	
NS	Nyssa sylvatica 'Wildfire'	Wildfire Black Gum	1	35	35	2.5"	B&B	
PCA	Pyrus calleryana 'Autumn Blaze'	Autumn Blaze Pear	5	35	175	2.5"	B&B	
	Quercus macrocarpa	Bur Oak	1	35	35	2.5"	B&B	
TA	Tilia americana 'Redmond'	Redmond Linden	3	35	105	2.5"	B&B	
	Ulmus 'New Horizon'	New Horizon Elm	4	35	140	2.5"	B&B	
	T TREES (BY CITY)	TOW TIGHEOIT EITH		- 00	1.10	2.0	Dab	
	Acer x freemanii 'Celzam'	Celebration Maple	5			2.5"	B&B	
	Ginkgo biloba 'Princeton Sentry	Princeton Sentry Ginkgo	7	-:-		2.5"	B&B	
	Ulmus 'New Horizon'	New Horizon Elm	5	-		2.5"	B&B	
	VERGREEN TREE	New Horizon Elm	5			2.5	Вав	
ALL E	Abies concolor	Concolor Fir	13	35	455	6' TALL	B&B	
			13	35	455 560		B&B B&B	
	Picea glauca v. densata	Black Hills Spruce				6' TALL		
	Pinus strobus	Eastern White Pine	8	35	280	6' TALL	B&B	
	MENTAL TREE							
	Amelanchier x grandiflora 'Autumn Brilliance'		6	15	90	1.5"	B&B	
	Carpinus caroliniana	Musclewood	7	15	105	1.5"	B&B	
	HT EVERGREEN SHRUB							
	Juniperus scopulorum 'Welchi'	Welch Juniper	7	10	70	4' TALL	B&B	
	Taxus x media 'Hicksii'	Hick's Yew	8	10	80	4' TALL	B&B	
	Thuja occidentalis 'Smaragd'	Pyramidal Arborvitae	11	10	110	4' TALL	B&B	
ECID	UOUS SHRUB							
	Clethra alnafolia 'Hummingbird'	Hummingbird Clethra	12	3	36	24" TALL	POT	
COB	Cephalanthus occidentalis	Buttonbush	18	3	54	36" TALL	POT	
CSI	Cornus sericea 'Ivory Halo'	Ivory Halo Red Twig Dogwood	13	3	39	36" TALL	POT	
DL	Diervilla Ionicera	Dwarf Bush Honeysuckle	15	3	45	24" TALL	POT	
	Fothergilla 'Mt. Airy'	Mt. Airy Fothergilla	7	3	21	24" TALL	POT	
	Hypericum kalmianum 'Deppe'	Sunny Boulevard St. John's Wort	12	3	36	24" TALL	POT	
HME	Hydrangea macrophylla 'Endless Summer'	Endless Summer Hydrangea	9	3	27	24" TALL	POT	
HV	Hammelis virginiana	Witchhazel	11	3	33	36" TALL	POT	
	Physocarpus opulifolius 'Seward'	Summer Wine Ninebark	27	3	81	36" TALL	POT	
	Rhus aromatica 'Gro-lo'	Grow Low Sumac	21	3	63	24" TALL	POT	
	Rhus typhina 'Bailtiger'	Tiger Eyes Sumac	52	3	156	24" TALL	POT	
	Syringa 'Minuet'	Minuet Canada Hybrid Lilac	16	3	48	36" TALL	POT	
	Viburnum dentatum 'Christom'	Blue Muffin Viburnum	23	3	69	36" TALL	POT	
	Weigela florida 'Rumba'	Rumba Weigela	21	3	63	18" TALL	POT	
	GREEN SHRUB							
CPG	Chamaecyparis pisifera 'Golden Mop'	Gold Mop False Cypress	15	4	60	24" TALL	POT	
	Juniperus sabina 'Mona'	Calgary Carpet Juniper	10	4	40	3 GAL	POT	
RP	Rhododendron 'PJM'	PJM Rhododendron	13	4	52	24" TALL	POT	
TMT	Taxus x media 'Tauntonii'	Taunton Yew	12	4	48	24" TALL	POT	
	Thuja occidentalis 'Rheingold	Rheingold Arborvitae	18	4	72	24" TALL	POT	
	MENTAL GRASSES	<u> </u>						
	Calamagrostis x acutiflora 'Karl Foerster'	Feather Reed Grass	50	2	100	1 GAL	POT	
DCN	Deschampsia cespitosa 'Northern Lights'	Northern Lights Tufted Hair Grass	18	2	36	1 GAL	POT	
EH	Elymus hystrix	Bottle Brush Grass	53	2	106	1 GAL	POT	
PVS	Panicum virgatum 'Shenandoah'	Shenandoah Switchgrass	15	2	30	1 GAL	POT	
SH	Sporobolus Heterolepsis	Prairie Dropseed	30	2	60	1 GAL	POT	
SS	Schizachyrium Scoparium 'Blaze'	Blaze Little Bluestem	12	2	24	1 GAL	POT	
HS	Helictotrichon sempervirens 'Saphirsprudel'	Blue Oat Grass	34	2	68	1 GAL	POT	
		•	•	TOTAL:	4372	POINTS		

RESERVE ARBOR


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DATE: 08-04-14 REVISED:

FN: 14-05-124


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ULIAN KISSIOV
ARCHITECT
476 PRESIDENTIAL LN
MADISON WI 53711

GRAND ARBOR RESERVE
10203 MINERAL POINT ROAD, MADISON, WI
CLIENT:
GRAND ARBOR RESERVE, LLC
6417 ODANA RD, MADISON, WI 53719



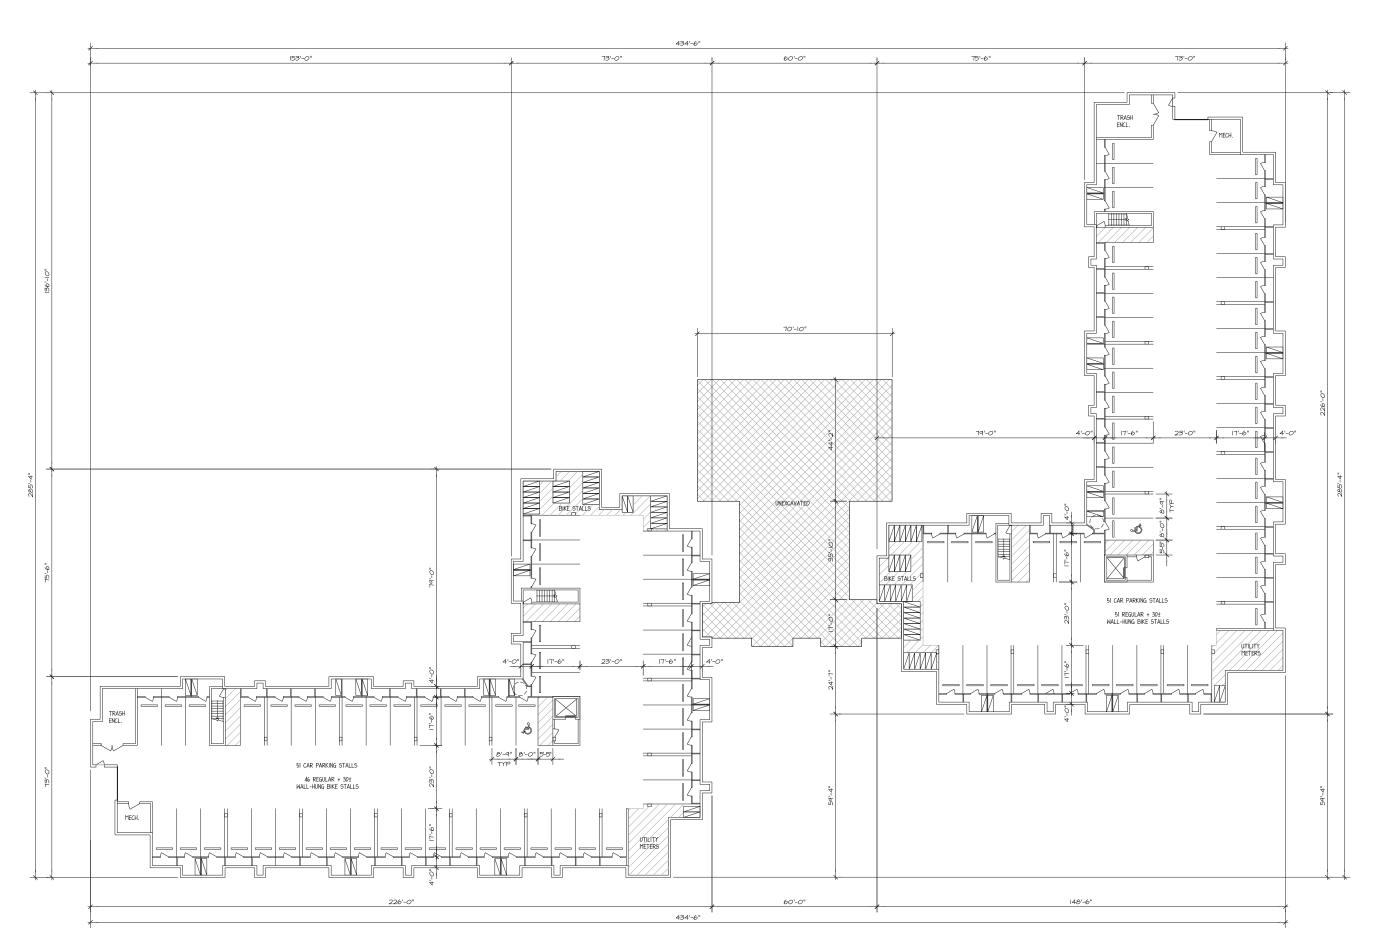


ULIAN KISSIO ARCHITECT 476 PRESIDENTIAL MADISON, WI 53'
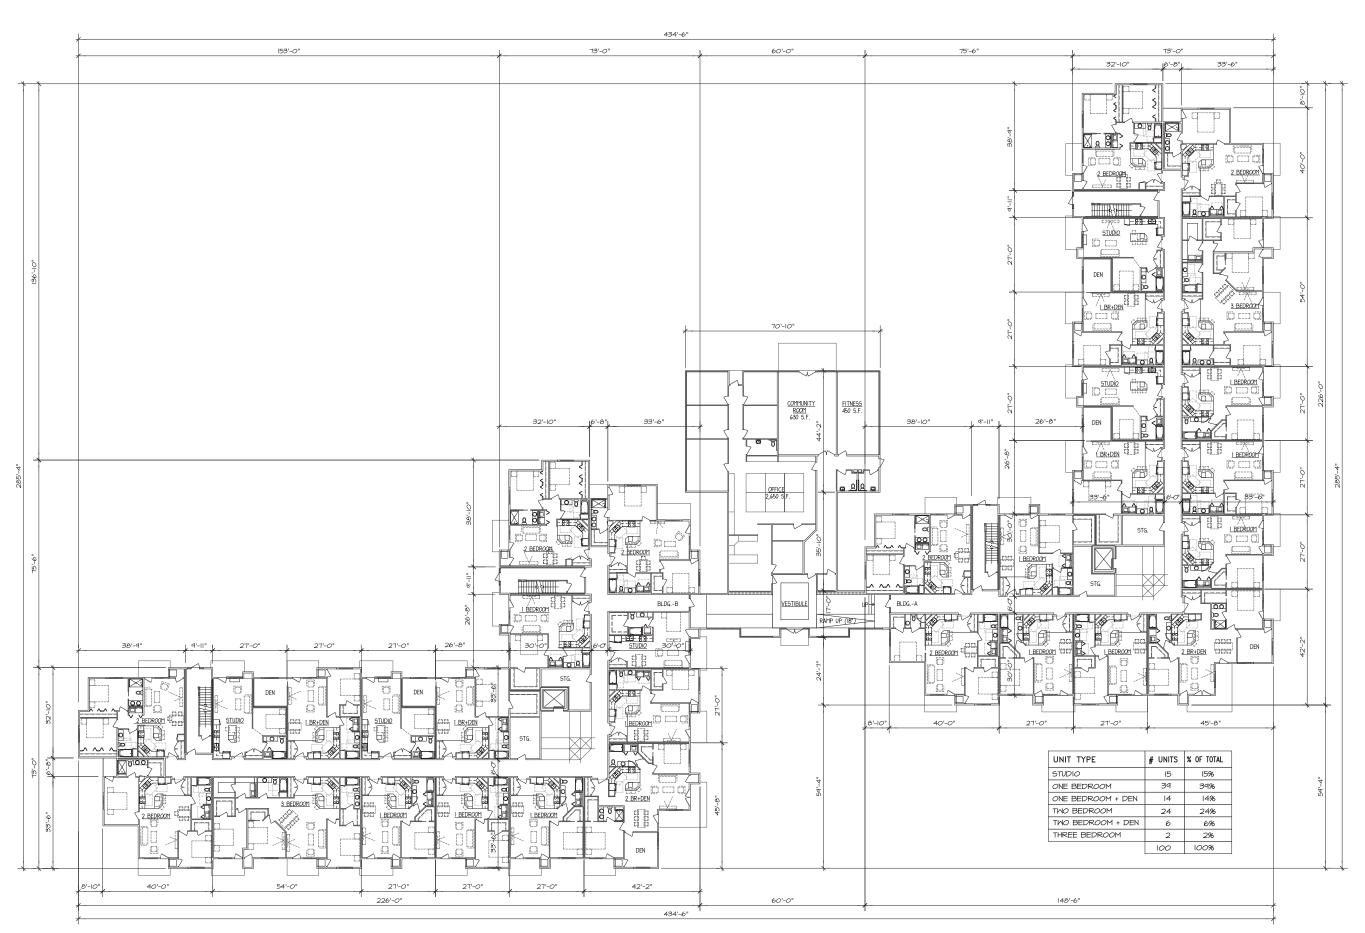
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GRAND ARBOR RESERVE 10203 MINERAL POINT ROAD, MADISON, WI CLIENT:
GRAND ARBOR RESERVE, 6417 ODANA RD, MADISON, WI 53719







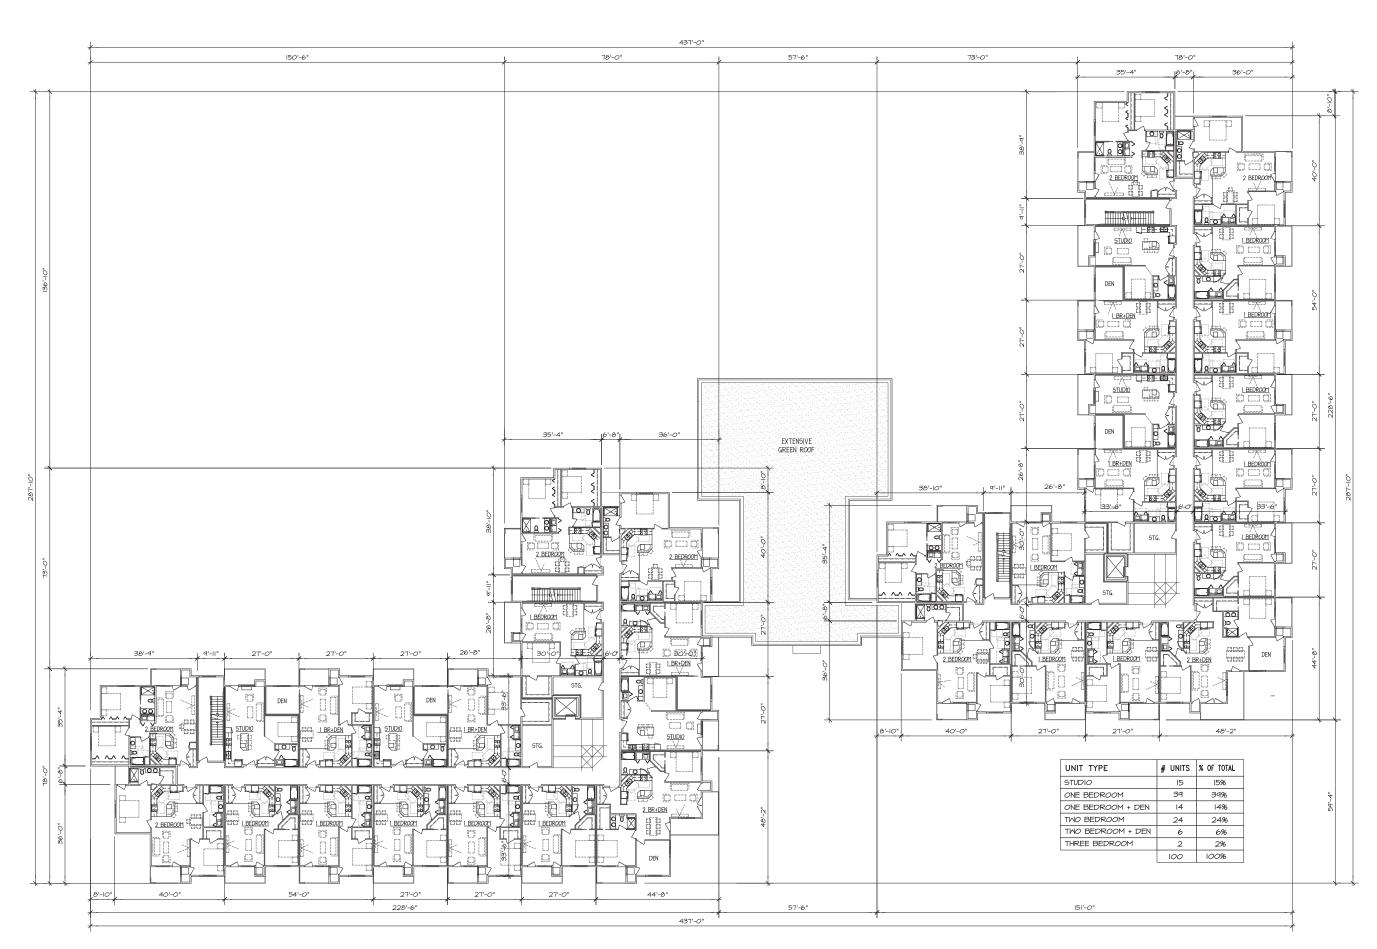

GRAND ARBOR RESERVE
10203 MINERAL POINT ROAD, MADISON, WI
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GRAND ARBOR RESERVE, LLC
6417 ODANA RD, MADISON, WI 53719



LLC



OVERALL NORTH FAÇADE (SEE SHEET A-O FOR EXTERIOR FINISHES) |/|6" = |'-0"



OVERALL SOUTH FAÇADE
1/16" = 1'-0" (SEE SHEET A-0 FOR EXTERIOR FINISHES)



BUILDING A - NORTH FAÇADE


3/32" = 1'-0" (SEE SHEET A-0 FOR EXTERIOR FINISHES)



BUILDING A - EAST FAÇADE
3/32" = 1'-0" (SEE SHEET A-0 FOR EXTERIOR FINISHES)

GRAND ARBOR RESERVE
10203 MINERAL POINT ROAD, MADISON, WI
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GRAND ARBOR RESERVE, L
6417 ODANA RD, MADISON, WI 53719

LLC

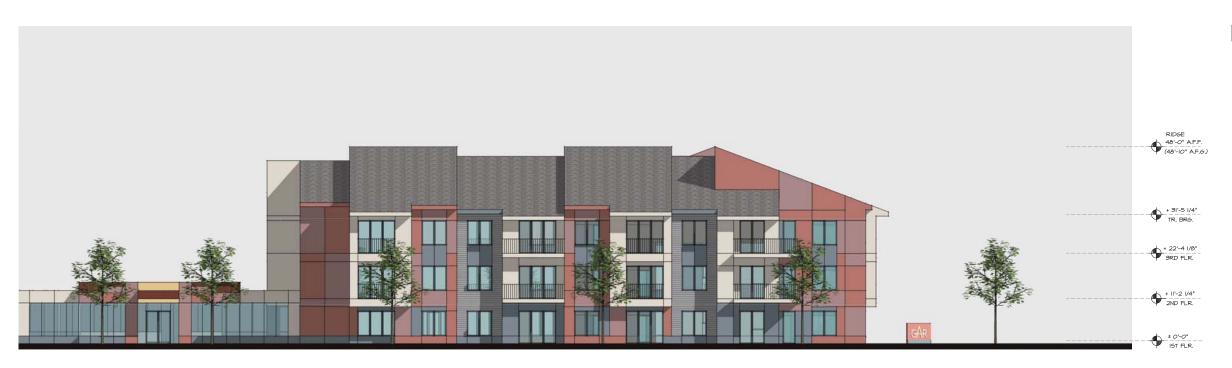

BUILDING A - SOUTH FAÇADE
3/32" = 1'-0" (SEE SHEET A-0 FOR EXTERIOR FINISHES)




BUILDING A - WEST FAÇADE
3/32" = 1'-0" (SEE SHEET A-0 FOR EXTERIOR FINISHES)

PROJECT: 2014-02 CAD\FILE: DRAWN BY: U.K. DATE: 08/04/14

LLC



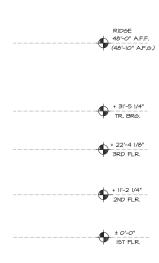

BUILDING B - EAST FAÇADE

3/32" = 1'-0" (SEE SHEET A-0 FOR EXTERIOR FINISHES)



BUILDING B - SOUTH FAÇADE (SEE SHEET A-0 FOR EXTERIOR FINISHES)

PROJECT: 2014-02 CAD\FILE: DRAWN BY: U.K. DATE: 08/04/14

LLC







BUILDING B - NORTH FAÇADE
3/32" = 1'-0" (SEE SHEET A-0 FOR EXTERIOR FINISHES)

GRAND ARBOR RESERVE
10203 MINERAL POINT ROAD, MADISON, WI
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