

**Notes**

1. A SIDE WALK WITH A PITCH GREATER THAN 1:20 IS A RAMP. THE MAXIMUM PITCH OF ANY RAMP OR WALK SHALL BE 1:12. RAMPS OVERCOMING MORE THAN 6" CHANGE IN ELEVATION TO HAVE HANDRAILS ON BOTH SIDES.
2. ALL DRIVEWAYS, CURB ADJACENT TO DRIVEWAYS, AND SIDEWALK CONSTRUCTION WITHIN THE PUBLIC RIGHT-OF-WAY, SHALL BE COMPLETED IN ACCORDANCE WITH CITY OF MADISON STANDARD SPECIFICATIONS FOR PUBLIC WORKS CONSTRUCTION BY A CONTRACTOR CURRENTLY LICENSED BY THE CITY.
3. ALL NEW DRIVES TO BE CONSTRUCTED WITH CLASS III APPROACHES IN ACCORDANCE WITH MADISON GENERAL ORDINANCE SECTION 10.08(4).
4. ALL TRASH AND RECYCLING TO BE COLLECTED IN TRASH ROOM IN THE BUILDING BASEMENT.
5. SEE SITE GRADING AND UTILITY PLANS FOR ADDITIONAL INFORMATION.
6. COMM 62.0500(1)-REQUIRED FIRE LANES SHALL BE PROVIDED PRIOR TO THE PLACEMENT OF COMBUSTIBLE MATERIALS AT THE BUILDING SITE, OR THE CONSTRUCTION OF ANY PORTION OF A BUILDING ABOVE THE FOOTING AND FOUNDATION.
7. ALL WORK IN THE RIGHT OF WAY SHALL BE PERFORMED BY A CITY LICENSED CONTRACTOR.
8. BIKE STALLS TO BE IN ACCORDANCE TO MADISON GENERAL ORDINANCE 28.11, (SEE SUBSECTIONS (B)(6) AND (B)(H)(2)). BIKE RACKS SHALL BE .
9. ALL SIDEWALK, CURB, AND GUTTER ABUTTING THE PROPERTY WHICH IS DAMAGED DURING CONSTRUCTION OR THAT THE CITY ENGINEER DETERMINES TO BE NECESSARY SHALL BE REPLACED.

**Revisions**

PUD-SIP Submittal - September 02, 2009

**Project Title**

1252 Williamson St.

**Drawing Title**


Site Plan

**Project No.**

0916

**Drawing No.**

C-1.1

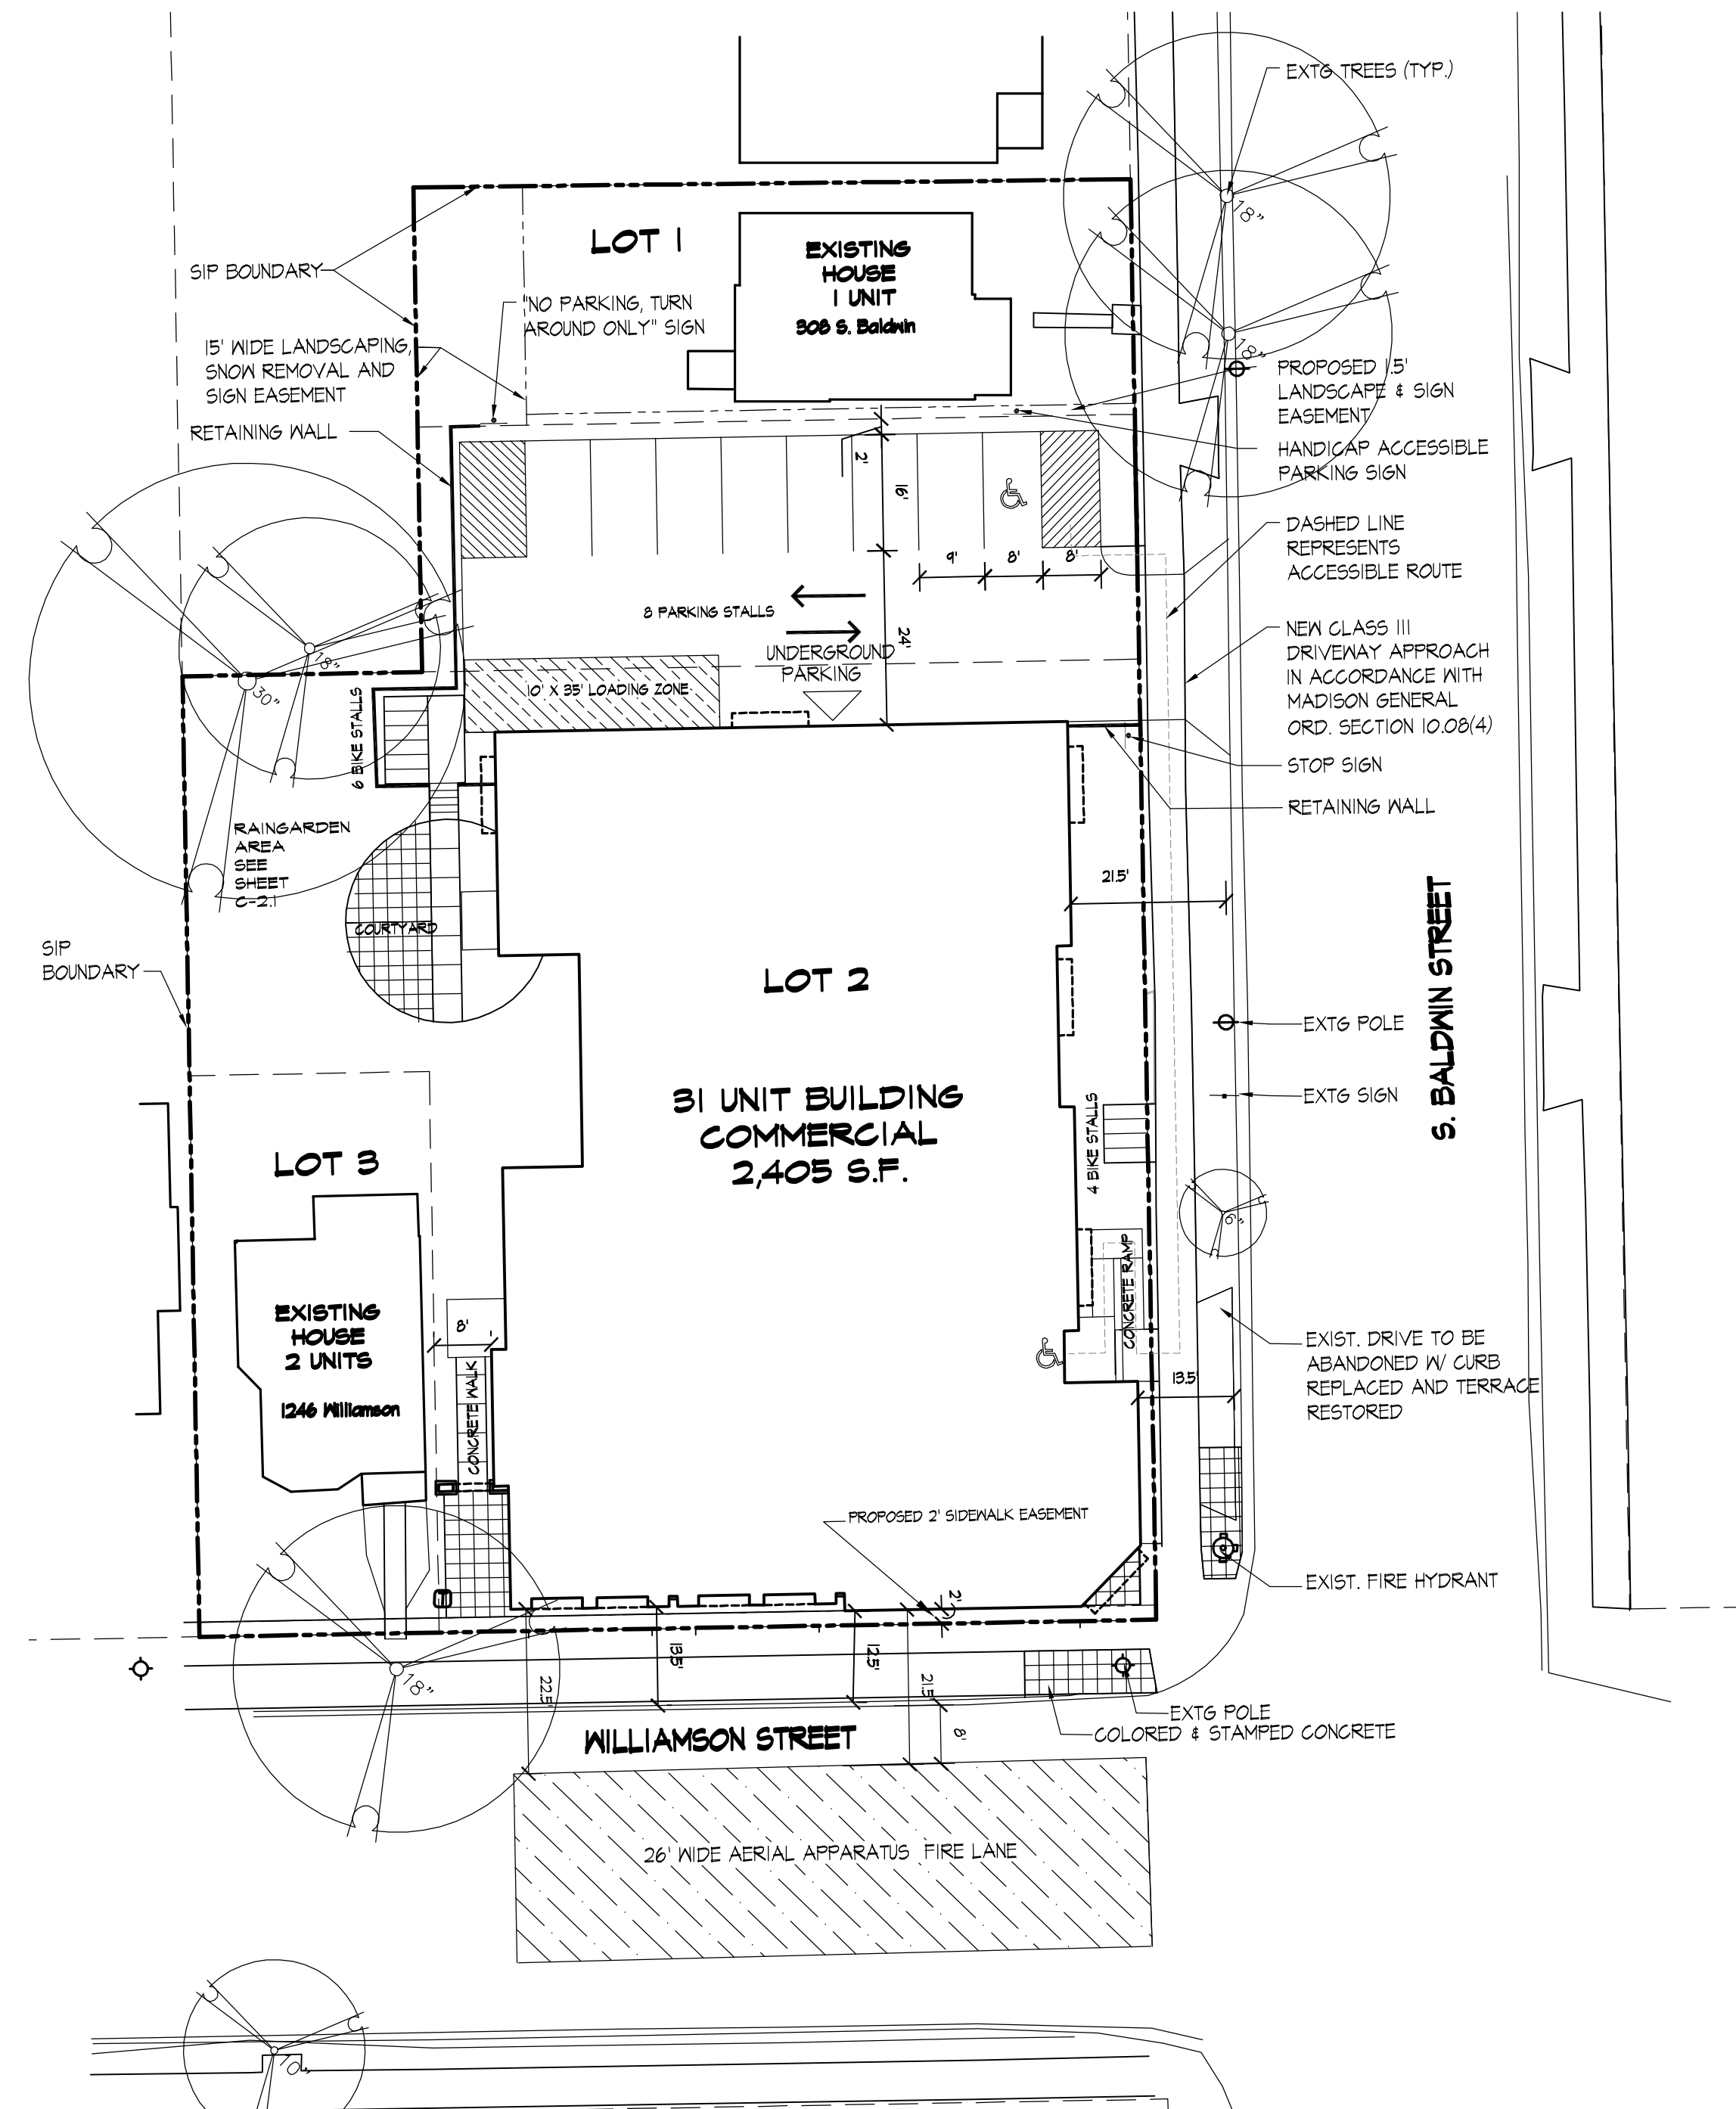



**SHEET INDEX:**

SITE	
C-1.1	SITE PLAN
C-1.2	SITE SURVEY
C-1.3	SITE DEMOLITION PLAN
C-2.1	SITE GRADING & EROSION CONTROL PLAN
C-3.1	SITE UTILITY PLAN
L-4.1	PLANTING PLAN
ARCHITECTURAL	
1	BASEMENT & FIRST FLOOR PLAN
2	SECOND & THIRD FLOOR PLAN
3	ELEVATIONS
4	ELEVATIONS

**SITE DEVELOPMENT DATA:**

<b>DENSITIES:</b>				
LOT AREA	23,912 Sq.Ft. / .55 ACRE			
COMMERCIAL AREA	2,405 S.F.			
DWELLING UNITS	34 UNITS			
LOT AREA / D.U.	105.0 Sq.Ft. / UNIT			
DENSITY	61.8 UNITS / ACRE			
<b>DWELLINGS UNIT MIX:</b>				
	LOT 1	LOT 2	LOT 3	TOTAL
STUDIO	0	4	0	4
ONE BEDROOM	0	22	0	22
ONE BEDROOM + DEN	0	1	0	1
TWO BEDROOM	0	4	2	6
THREE BEDROOM	1	0	0	1
TOTAL	1	31	2	34
<b>BUILDING HEIGHT:</b> 3 STORIES (39' - 43' HIGH)				
<b>FLOOR AREA (LOT 2):</b>				
NEW RESIDENTIAL	25,800 S.F.			
COMMERCIAL	2,405 S.F.			
Gross Floor Area	28,205 S.F.			
(Excludes Underground parking)				
<b>FLOOR AREA RATIO = 1.17</b>				
<b>VEHICLE PARKING STALLS:</b>				
SURFACE	8			
UNDERGROUND	24			
TOTAL	32			
<b>BICYCLE PARKING STALLS:</b>				
SURFACE	10			
UNDERGROUND	21			
TOTAL	31			

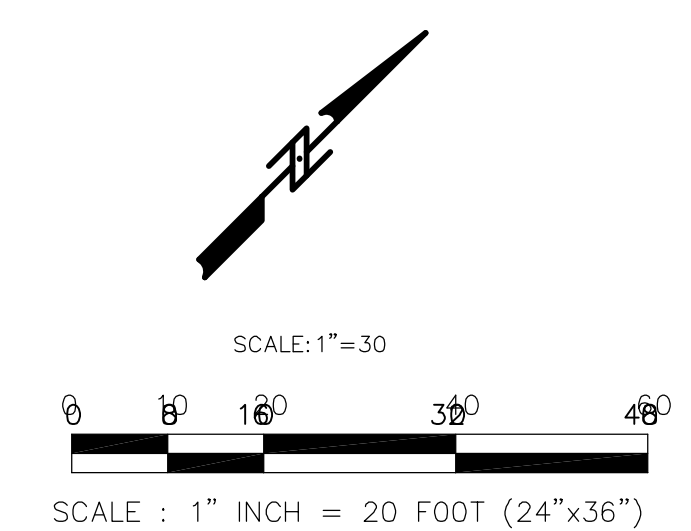

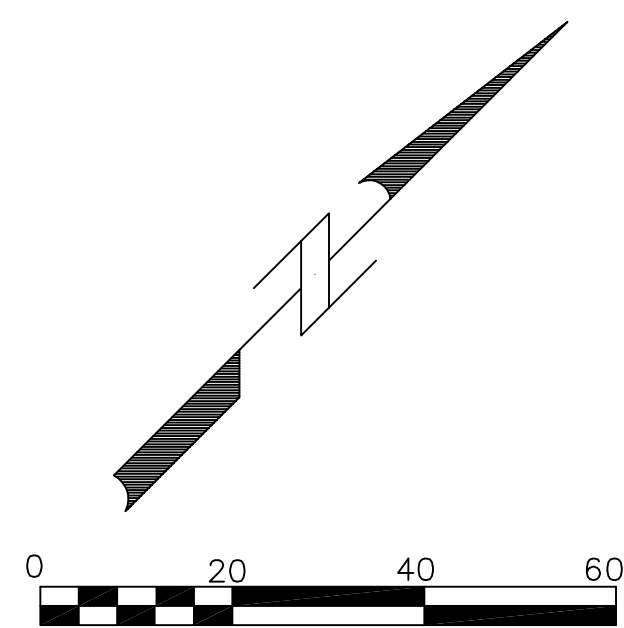


SCALE : 1" = 40' (11 X 17)  
SCALE : 1" = 20' (24 X 36)

1. ORIGINAL SURVEY INFORMATION PROVIDED BY BURSE SURVEYING AND ENGINEERING. BOUNDARY SURVEY INFORMATION VERIFIED BY I&S GROUP, INC.
2. LOCATIONS OF UTILITIES SHOWN ARE BASED UPON AS-BUILT DRAWINGS AND 'ONE-CALL' LOCATION INFORMATION PROVIDED BY OTHERS. CONTRACTOR SHALL VERIFY THE LOCATION OF ANY UTILITY NECESSARY TO COMPLETE HIS WORK PRIOR TO CONSTRUCTION.

**LEGEND**

• 3/4" SOLID IRON ROD FOUND	— OVERHEAD UTILITY LINE	⊙ STORM MANHOLE	⊕ STOPTLIGHT
● 1-1/4" SOLID IRON ROD FOUND	— BURIED GAS LINE	⊕ MANHOLE	⊕ ELECTRIC PEDESTAL
○ MAG NAIL FOUND	— WATER MAIN	⊕ WATER VALVE	⊕ TV PEDESTAL
× CHISELED "X" FOUND	— SANITARY SEWER	⊕ STORM "H" INLET	⊕ TELEPHONE PEDESTAL
⊙ 1" OUTSIDE DIAMETER IRON PIPE FOUND (UNLESS OTHERWISE NOTED)	— STORM SEWER	⊕ STORM INLET	⊕ PROPERTY IRON FOUND
○ 3/4" x 18" SOLID IRON RE-ROD SET, WT. 1.50 LBS./FT.	— BURIED ELECTRIC LINE	⊕ UTILITY POLE	⊕ HYDRANT
( ) INDICATES RECORDED AS	— BURIED CABLE TELEVISION LINE	⊕ LIGHT POLE	⊕ SIGN
DISTANCES ARE MEASURED TO THE NEAREST HUNDREDTH OF A FOOT.	⊕ TELEPHONE MANHOLE	⊕ HANDICAP PARKING STALL	
	⊕ SANITARY MANHOLE	⊕ GUY WIRE	

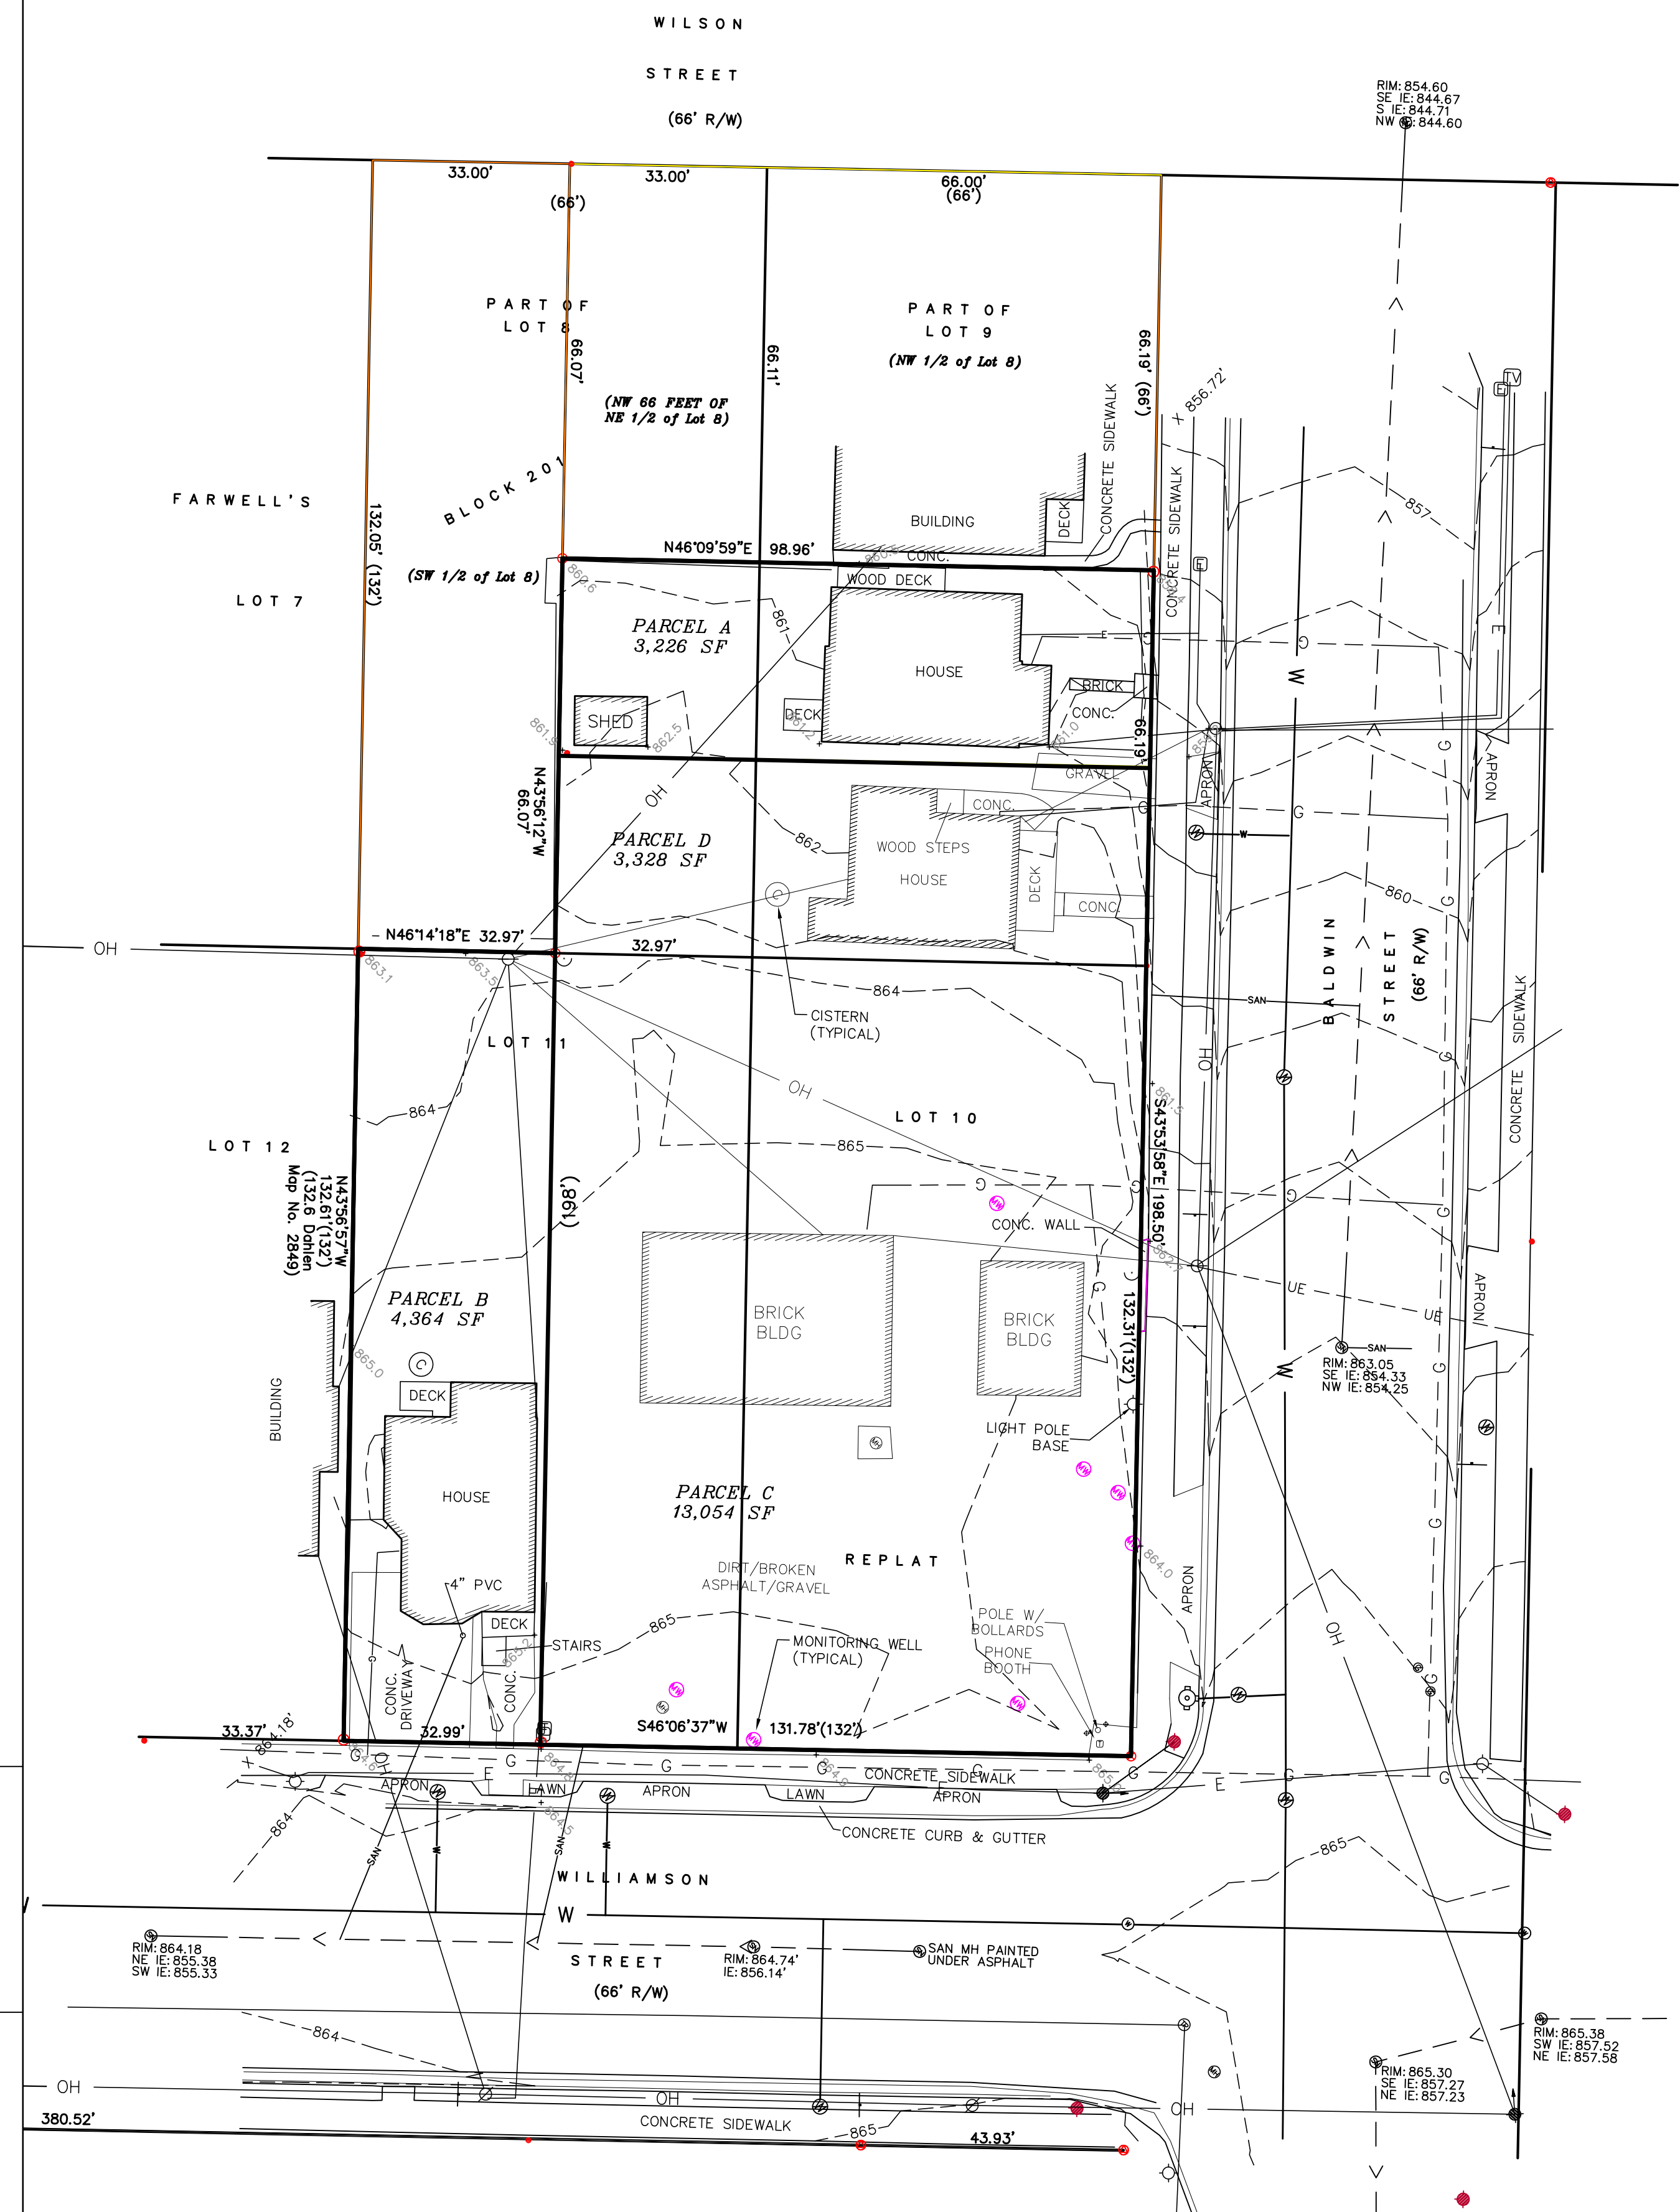


DATE: 08-27-09
REVISIONS:
DATE: 09-02-09

1252 WILLIAMSON STREET  
SITE SURVEY

Madison Office  
2690 Research Park Drive, Suite H  
Madison, WI 53711  
Ph: 608-442-9500  
Fax: 608-442-9501


Foribault, Minnesota: 507-331-1500  
Maricopa, Minnesota: 507-387-6651  
Web: www.i-s-group.com



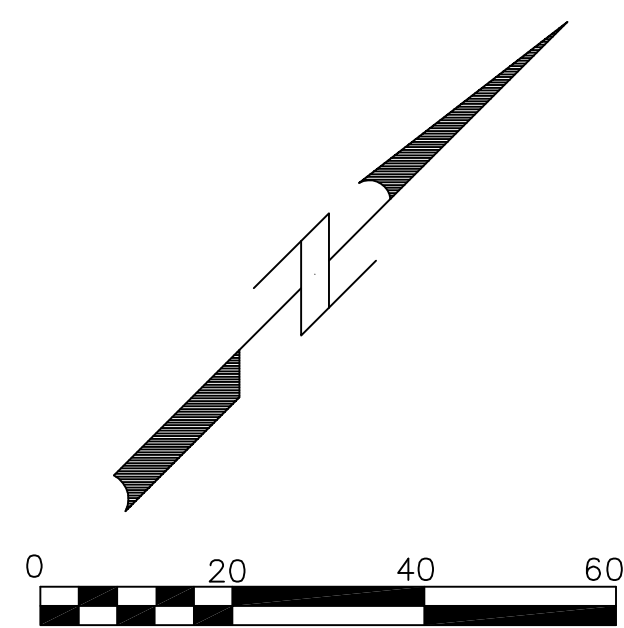

SCALE : 1" = 40' (11 X 17)  
SCALE : 1" = 20' (24 X 36)

1. ORIGINAL SURVEY INFORMATION PROVIDED BY BURSE SURVEYING AND ENGINEERING. BOUNDARY SURVEY INFORMATION VERIFIED BY I&S GROUP, INC.
2. LOCATIONS OF UTILITIES SHOWN ARE BASED UPON AS-BUILT DRAWINGS AND 'ONE-CALL' LOCATION INFORMATION PROVIDED BY OTHERS. CONTRACTOR SHALL VERIFY THE LOCATION OF ANY UTILITY NECESSARY TO COMPLETE HIS WORK PRIOR TO CONSTRUCTION.
3. MONITORING WELLS TO BE REMOVED PER DEPARTMENT OF NATURAL RESOURCES REQUIREMENTS.

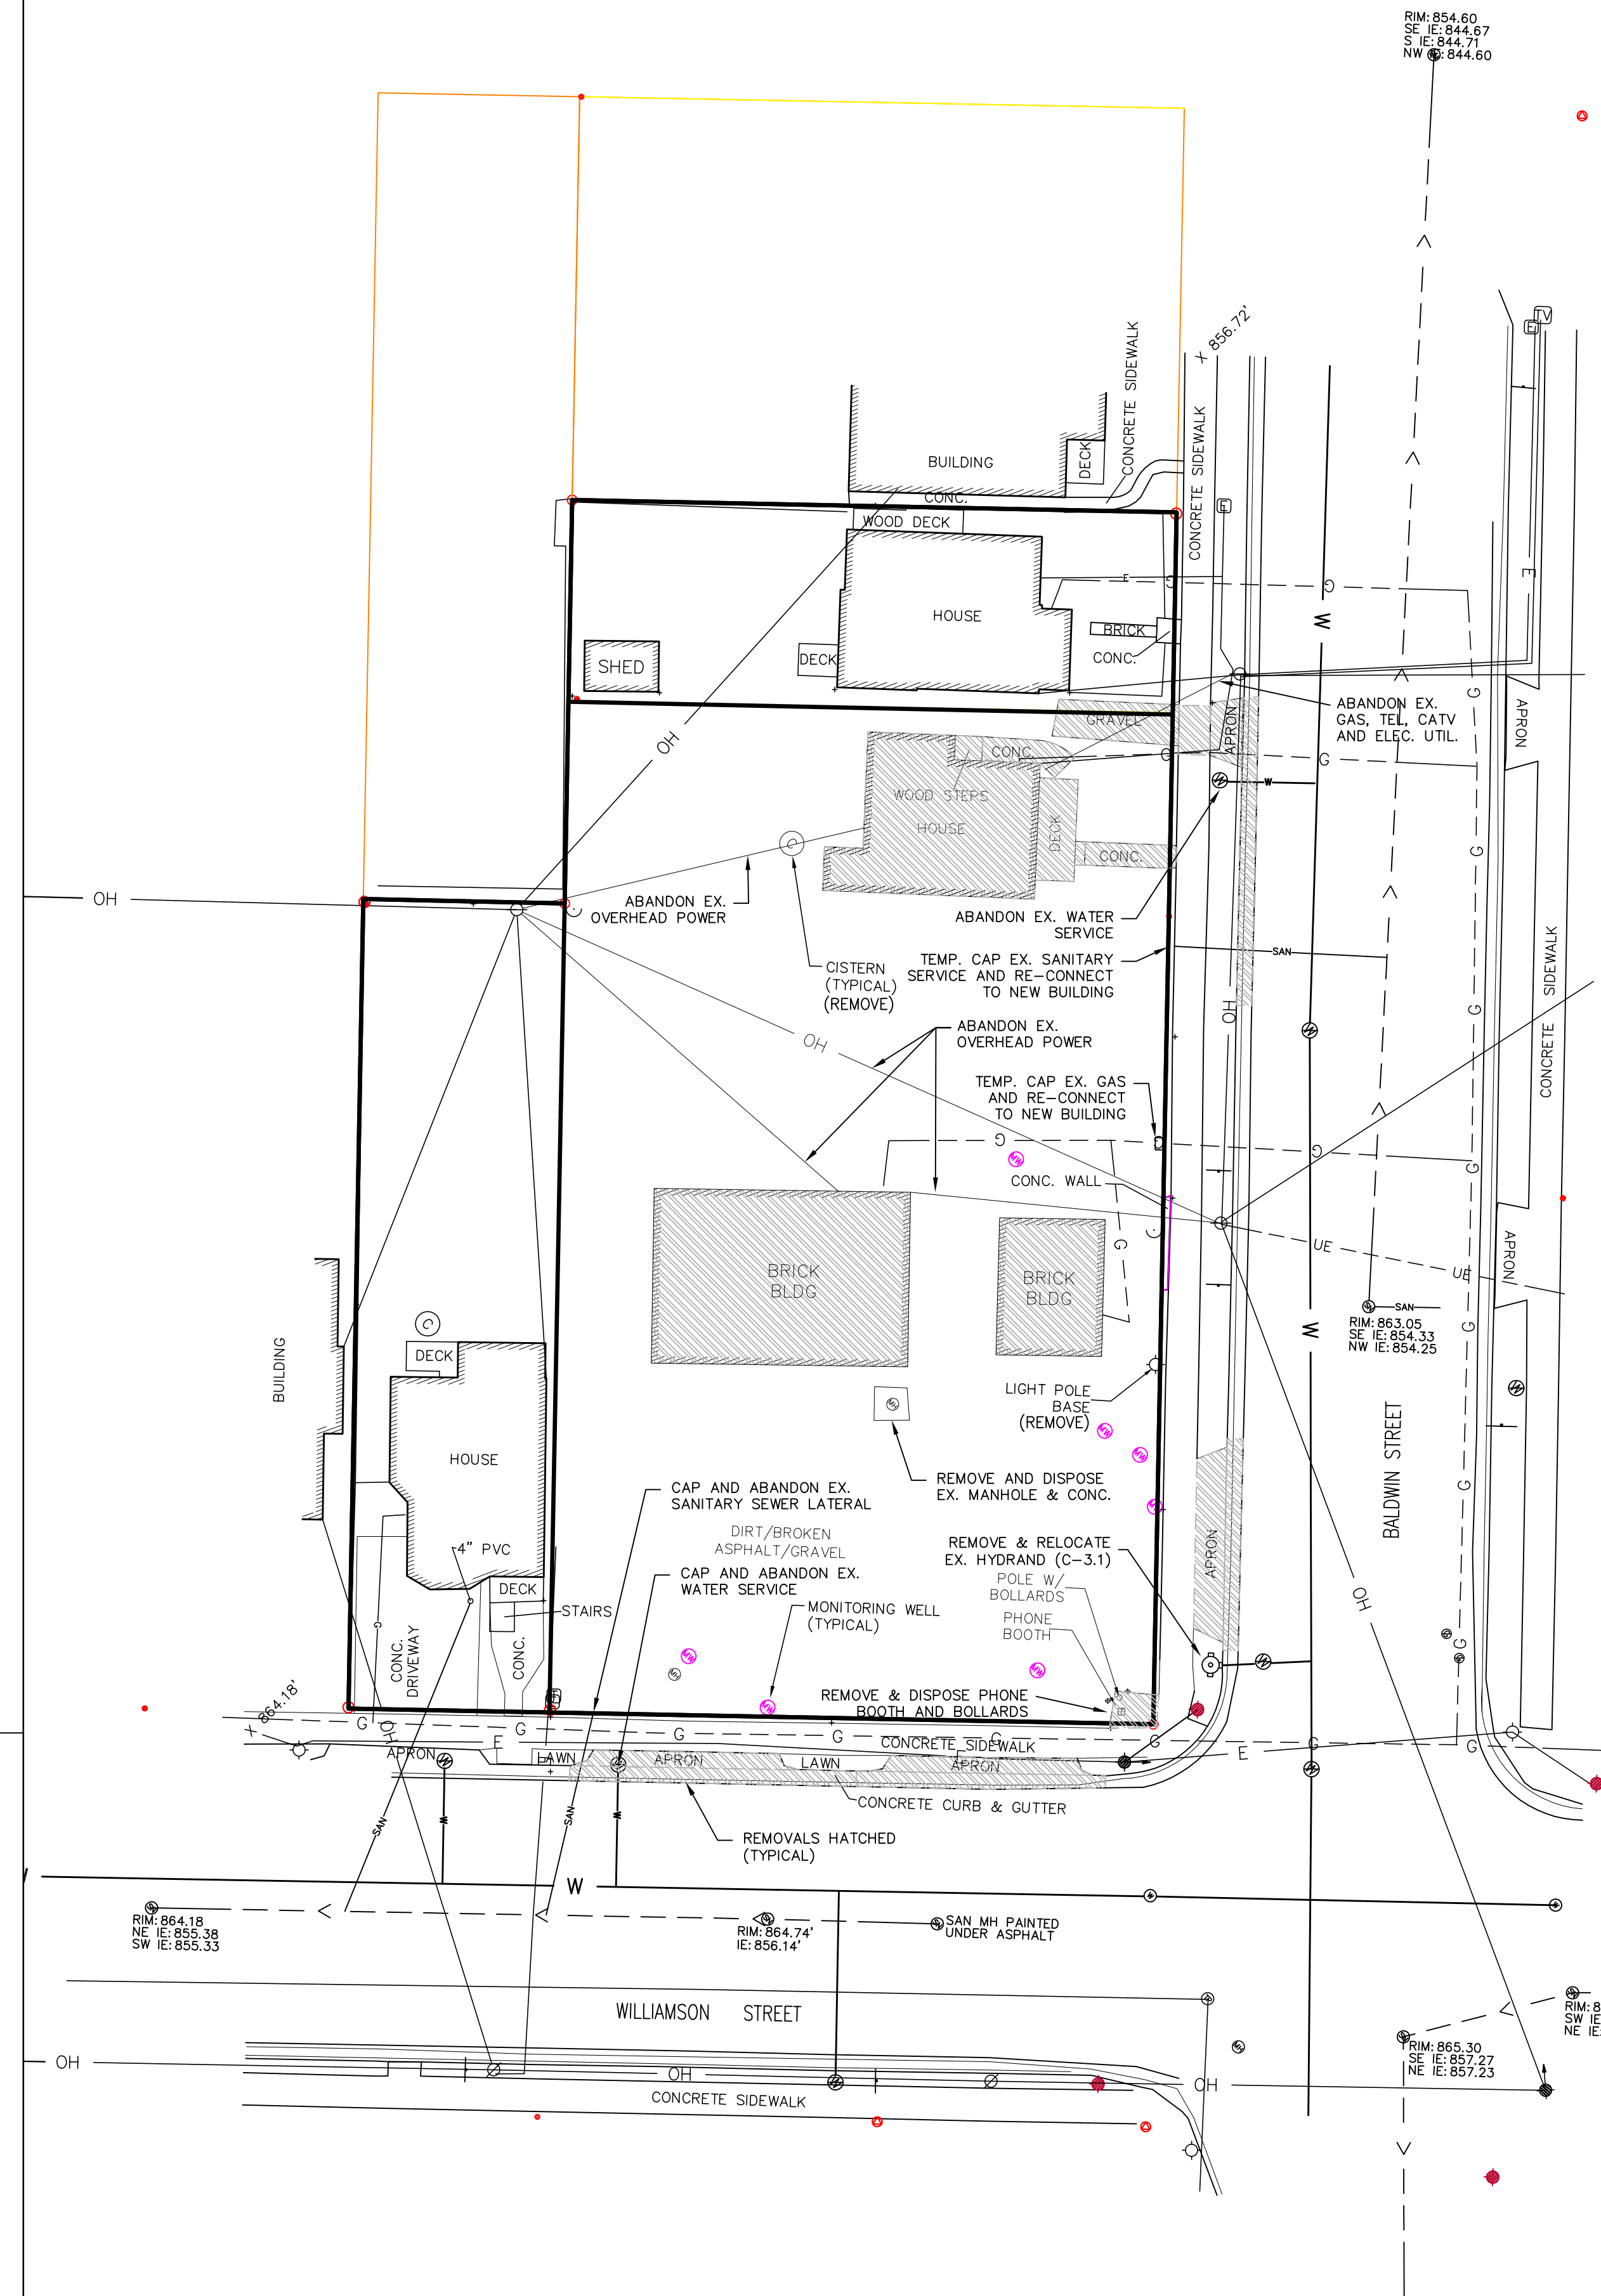

DATE: 08-27-09

REVISIONS:  
DATE: 09-02-09

1252 WILLIAMSON STREET  
SITE DEMOLITION PLAN

Madison Office  
2690 Research Park Drive, Suite H  
Madison, WI 53711  
Ph: 608-442-9500  
Fax: 608-442-9501

Foribault, Minnesota: 507-331-1500  
Minnetonka, Minnesota: 507-387-6651  
Web: www.i-s-gp.com



SHEET  
C-1.3

M:\12243 WILLIAMSON STREET-BALDWIN STREET\12243 CIVIL-SURVEY\12243 BASE.DGN


DATE: 08-27-09
REVISIONS:
DATE: 09-02-09

1252 WILLIAMSON STREET  
GRADING & EROSION CONTROL PLAN


M:\12243 WILLIAMSON STREET-BALDWIN STREET\12243 CIVIL-SURVEY\12243 BASE.DGN

Madison Office  
2690 Research Park Drive, Suite H  
Madison, WI 53711  
Ph: 608-442-9500  
Fx: 608-442-9501

Foribault, Minnesota: 507-331-1500  
Minnetonka, Minnesota: 507-387-6651  
Web: www.iis-gp.com

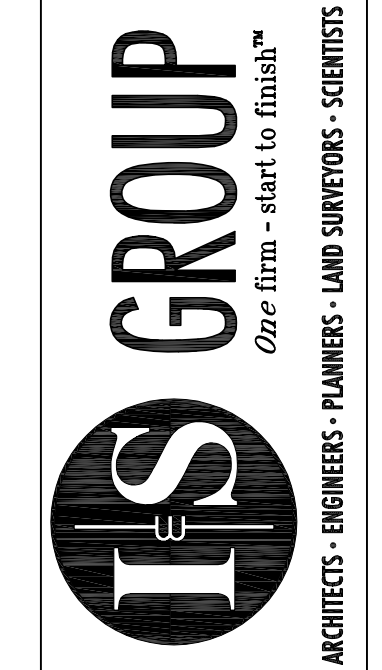

SHEET  
C-2.1

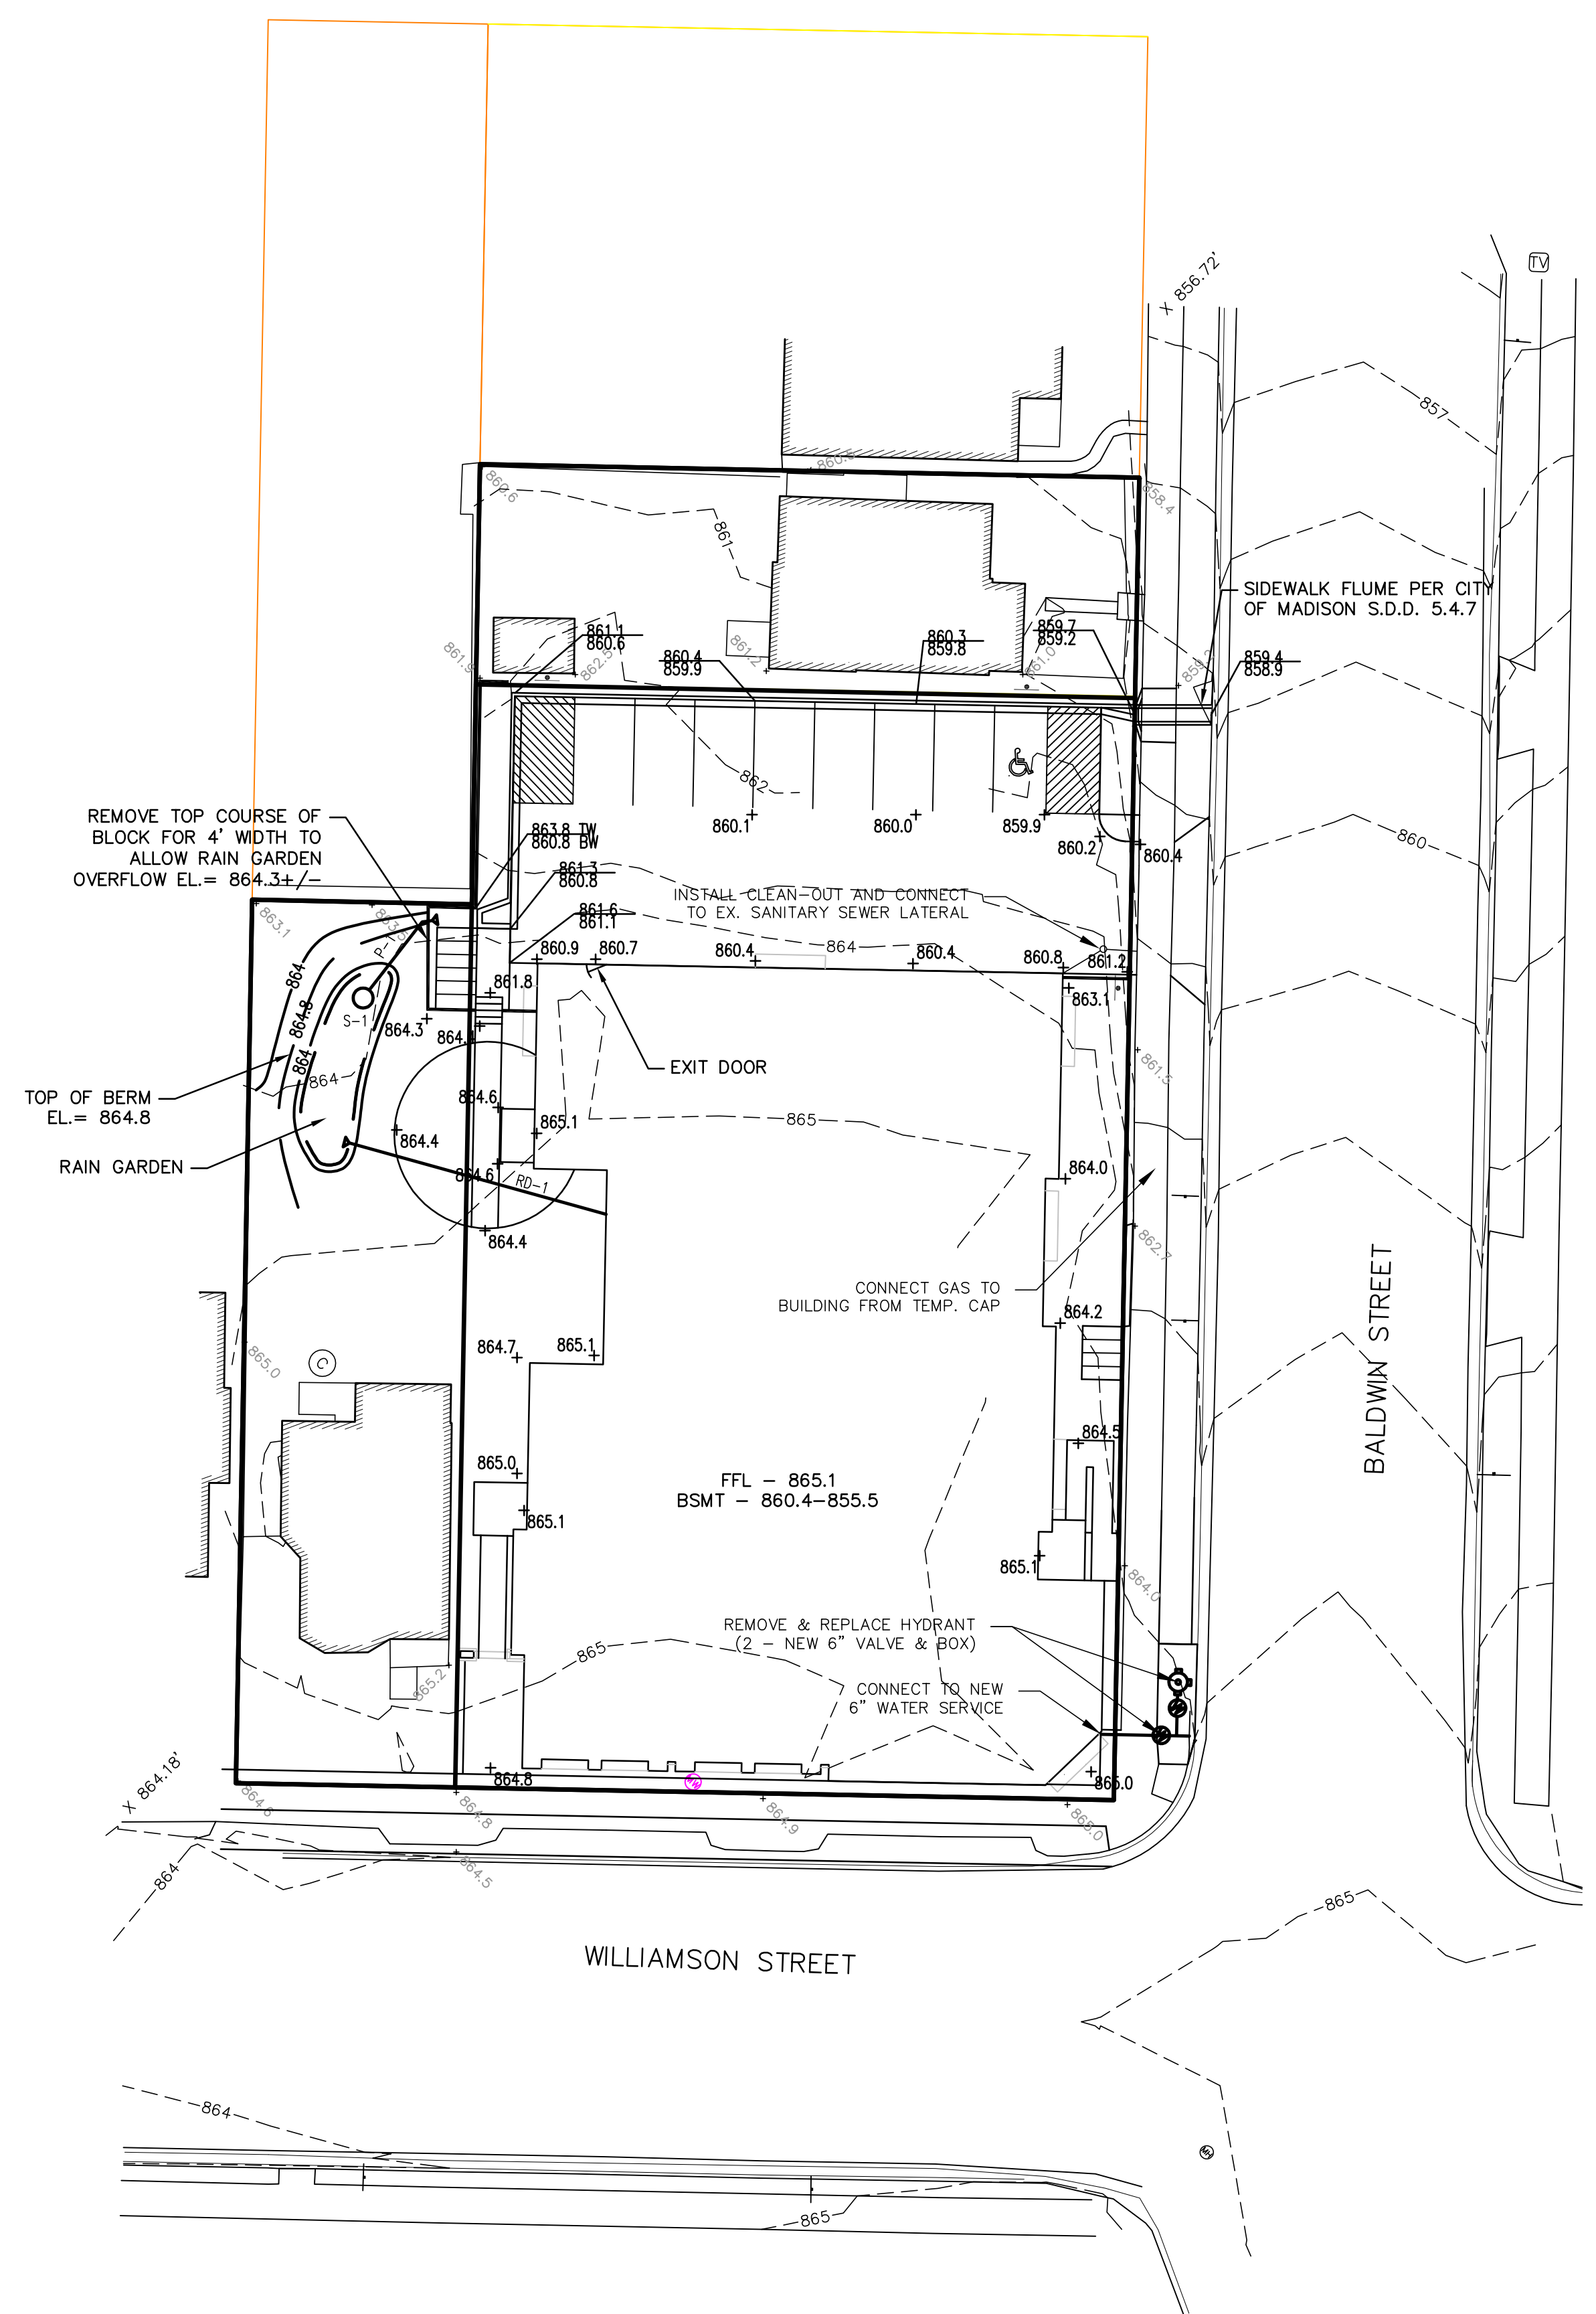


**EROSION CONTROL SCHEDULE:**  
 INSTALL EROSION CONTROL MEASURES: SEPTEMBER 27, 2009  
 BEGIN CONSTRUCTION: OCTOBER 1, 2009  
 GRAVEL BASE COURSE INSTALLATION COMPLETED: NOV. 15, 2009

NOTE: AN EROSION CONTROL PERMIT EXTENSION SHALL BE FILED WITH THE CITY OF MADISON PRIOR TO THE GRAVEL BASE COURSE INSTALLATION DATE INDICATED ABOVE IF THIS DATE WILL NOT BE MET. CONTRACTOR SHALL NOTIFY ENGINEER IF AN EXTENSION IS NECESSARY.

- LEGEND:**
- 900.50 = TOP OF CURB/SW ELEV.
  - 900.00 = PAVEMENT ELEV.
  - X 900.00 = PROPOSED SPOT ELEVATION
  - X 900.00 = EXISTING SPOT ELEVATION


- GENERAL NOTES:**
- STONE CONSTRUCTION ENTRANCE SHALL BE INSTALLED PRIOR TO ANY GRADING OPERATIONS AND MAINTAINED UNTIL GRAVEL BASE IS INSTALLED.
  - SILT FENCE AND ALL OTHER EROSION CONTROL MEASURES SHALL BE INSTALLED PRIOR TO ANY GRADING OPERATIONS AND MAINTAINED THROUGHOUT THE CONSTRUCTION PHASE OF THIS PROJECT.
  - TRACKED MATERIAL TO ADJACENT STREETS SHALL BE COLLECTED AT THE END OF EACH WORK DAY OR AS REQUIRED BY THE CITY OF MADISON.
  - ALL AREAS WHICH ARE NOT PAVED SHALL RECEIVE A MINIMUM OF 4" TOPSOIL PRIOR TO SEEDING.
  - GRASS AREAS SHALL RECEIVE FERTILIZER, SEED, AND MULCH. SEED SHALL BE MIXTURE 40 IN ACCORDANCE WITH SECTION 630 OF D.O.T. SPECIFICATIONS AND SHALL BE APPLIED AT A RATE OF FOUR POUNDS PER 1,000 SQUARE FEET. FERTILIZER SHALL MEET THE REQUIREMENTS THAT FOLLOW: NITROGEN, NOT LESS THAN 16%; PHOSPHORIC ACID, NOT LESS THAN 8%; POTASH, NOT LESS THAN 8%. FERTILIZER SHALL BE APPLIED AT THE RATE OF SEVEN POUNDS PER 1,000 SQUARE FEET.
  - MULCH SHOULD BE APPLIED SO THAT THE SOIL SURFACE IS UNIFORMLY COVERED. ACTUAL APPLICATION RATES MAY VARY DEPENDING UPON THE INDIVIDUAL SITE CHARACTERISTICS AND THE TYPE OF MULCH USED. MULCHING APPLICATION SHALL CONSIST OF STRAW AT A MIN. RATE OF 1.5 TONS PER ACRE. MULCH MUST BE CRIMPED.
  - PUMPING OF WATER FROM FOUNDATION AREA DURING CONSTRUCTION SHALL NOT EXCEED A RATE OF 70 GALLONS PER MINUTE. SUMP PUMP SHALL BE PLACED ON A CLEAR STONE BEDDING AND A CLOTH/MESH SOCK SHALL BE PLACED ON THE OUTLET END OF THE PIPE TO CONTROL SEDIMENT LOSS.
  - ALL EROSION AND SEDIMENT CONTROL MEASURES AND STRUCTURES SHALL BE INSPECTED AT LEAST WEEKLY AND WITHIN 24 HOURS AFTER A 0.5 INCH OR GREATER RAINFALL EVENT. ALL NECESSARY MAINTENANCE SHALL FOLLOW WITHIN 24 HOURS OF THE INSPECTION.
  - FOR THE FIRST SIX WEEKS AFTER THE INITIAL STABILIZATION OF A DISTURBED AREA, PROVISIONS SHALL BE MADE FOR WATERING WHENEVER MORE THAN SEVEN DAYS OF DRY WEATHER ELAPSE.
  - EROSION AND SEDIMENT CONTROL MEASURES SHALL BE INSPECTED AND REPAIRED BY THE CONTRACTOR, IF NECESSARY, EVERY 7 DAYS AND WITHIN 24 HOURS AFTER A PRECIPITATION EVENT OF 0.5" OR GREATER. ALL NECESSARY MAINTENANCE SHOULD FOLLOW THE INSPECTIONS WITHIN 24 HOURS.
  - ALL INLETS SHALL HAVE TYPE "D" PROTECTION DURING CONSTRUCTION.
  - FILTER FABRIC FOR INLET BAGS SHALL MEET THE REQUIREMENTS OF THE WISCONSIN DEPARTMENT OF TRANSPORTATION PRODUCT ACCEPTABILITY LIST, TYPE "D", OR EQUAL, AND SHALL BE ULTRAVIOLET STABILIZED.

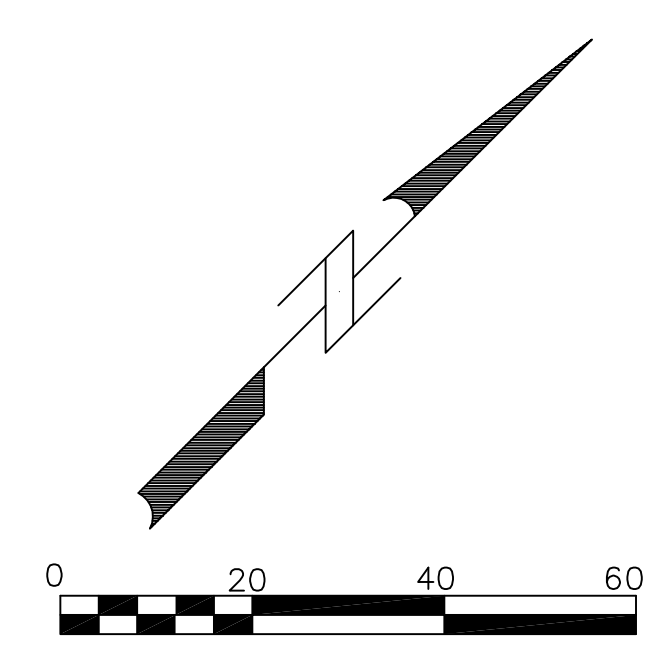

SCALE : 1" = 20' (11 X 17)  
 SCALE : 1" = 40' (24 X 36)

**GENERAL NOTES:**

- CONTRACTOR SHALL OBTAIN NECESSARY CONNECTION AND EXCAVATION PERMITS FROM CITY ENGINEERING PRIOR TO WORK COMMENCING.
- CONTRACTOR SHALL FIELD VERIFY THE SIZE, TYPE, LOCATION, AND ELEVATION OF EXISTING UTILITIES.
- THE CONTRACTOR SHALL NOTIFY ALL AREA UTILITY COMPANIES PRIOR TO COMMENCING WORK UNDER THIS CONTRACT AND REQUEST THAT UNDERGROUND UTILITIES BE LOCATED IN ACCORDANCE WITH SECTION 182.0175(2) OF THE WISCONSIN STATUTES. ANY LOCATIONS AS SHOWN ON THE PLANS ARE APPROXIMATE ONLY. CONTRACTOR SHALL FIELD VERIFY THE SIZE, TYPE, LOCATION, AND ELEVATION OF EXISTING UTILITIES.
- ALL WORK WITHIN THE PUBLIC RIGHT OF WAY SHALL BE CONSTRUCTED PER THE CITY OF MADISON STANDARD SPECIFICATIONS FOR PUBLIC WORKS CONSTRUCTION AND SHALL BE PERFORMED BY A CITY LICENSED CONTRACTOR.
- ALL STORM SEWER SHALL BE INSTALLED WITHIN THE PROPOSED UNDERGROUND PARKING STRUCTURE. PIPE SUPPORT DETAILS ARE SHOWN WITH OTHER STRUCTURAL DETAILS IN THE PLAN SET.
- ALL SANITARY SEWER, WATER MAIN, AND STORM SEWER SHALL BE CONSTRUCTED PER THE CITY OF MADISON STANDARD SPECIFICATIONS FOR PUBLIC WORKS CONSTRUCTION.
- STORM SEWER SHALL BE PVC.
- PRIVATE SANITARY SEWER AND LATERALS SHALL BE PVC (ASTM D3034-SDR35).
- ALL SANITARY LATERALS ARE TO BE AT A SLOPE OF  $\frac{1}{8}$ "/FT UNLESS OTHERWISE SPECIFIED.
- COORDINATE WORK WITH BUILDING PLUMBING CONTRACTOR(S).
- ALL GRATES ARE NEENAH FOUNDRY COMPANY CATALOG DESIGNATIONS.
- THE CONTRACTOR SHALL REPLACE ALL SIDEWALK AND CURB AND GUTTER ABUTTING THE PROPERTY, WHICH IS DAMAGED BY THE CONSTRUCTION OR ANY SIDEWALK AND CURB AND GUTTER THAT THE CITY ENGINEER DETERMINES NEEDS TO BE REPLACED BECAUSE IT IS NOT AT A DESIRABLE GRADE REGARDLESS OF WHETHER THE CONDITION EXISTED PRIOR TO BEGINNING CONSTRUCTION.
- PUMPING OF WATER FROM TRENCHES DURING CONSTRUCTION SHALL NOT EXCEED A RATE OF 70 GALLONS PER MINUTE. SUMP PUMP SHALL BE PLACED ON A CLEAR STONE BEDDING AND A CLOTH/MESH SOCK SHALL BE PLACED ON THE OUTLET END OF THE PIPE TO CONTROL SEDIMENT LOSS.
- ELEVATIONS DEPICTED IN ( ) ARE PER INFORMATION SHOWN ON CITY OF MADISON PROJECT NO. 5380878, CONTRACT NO. 6003.

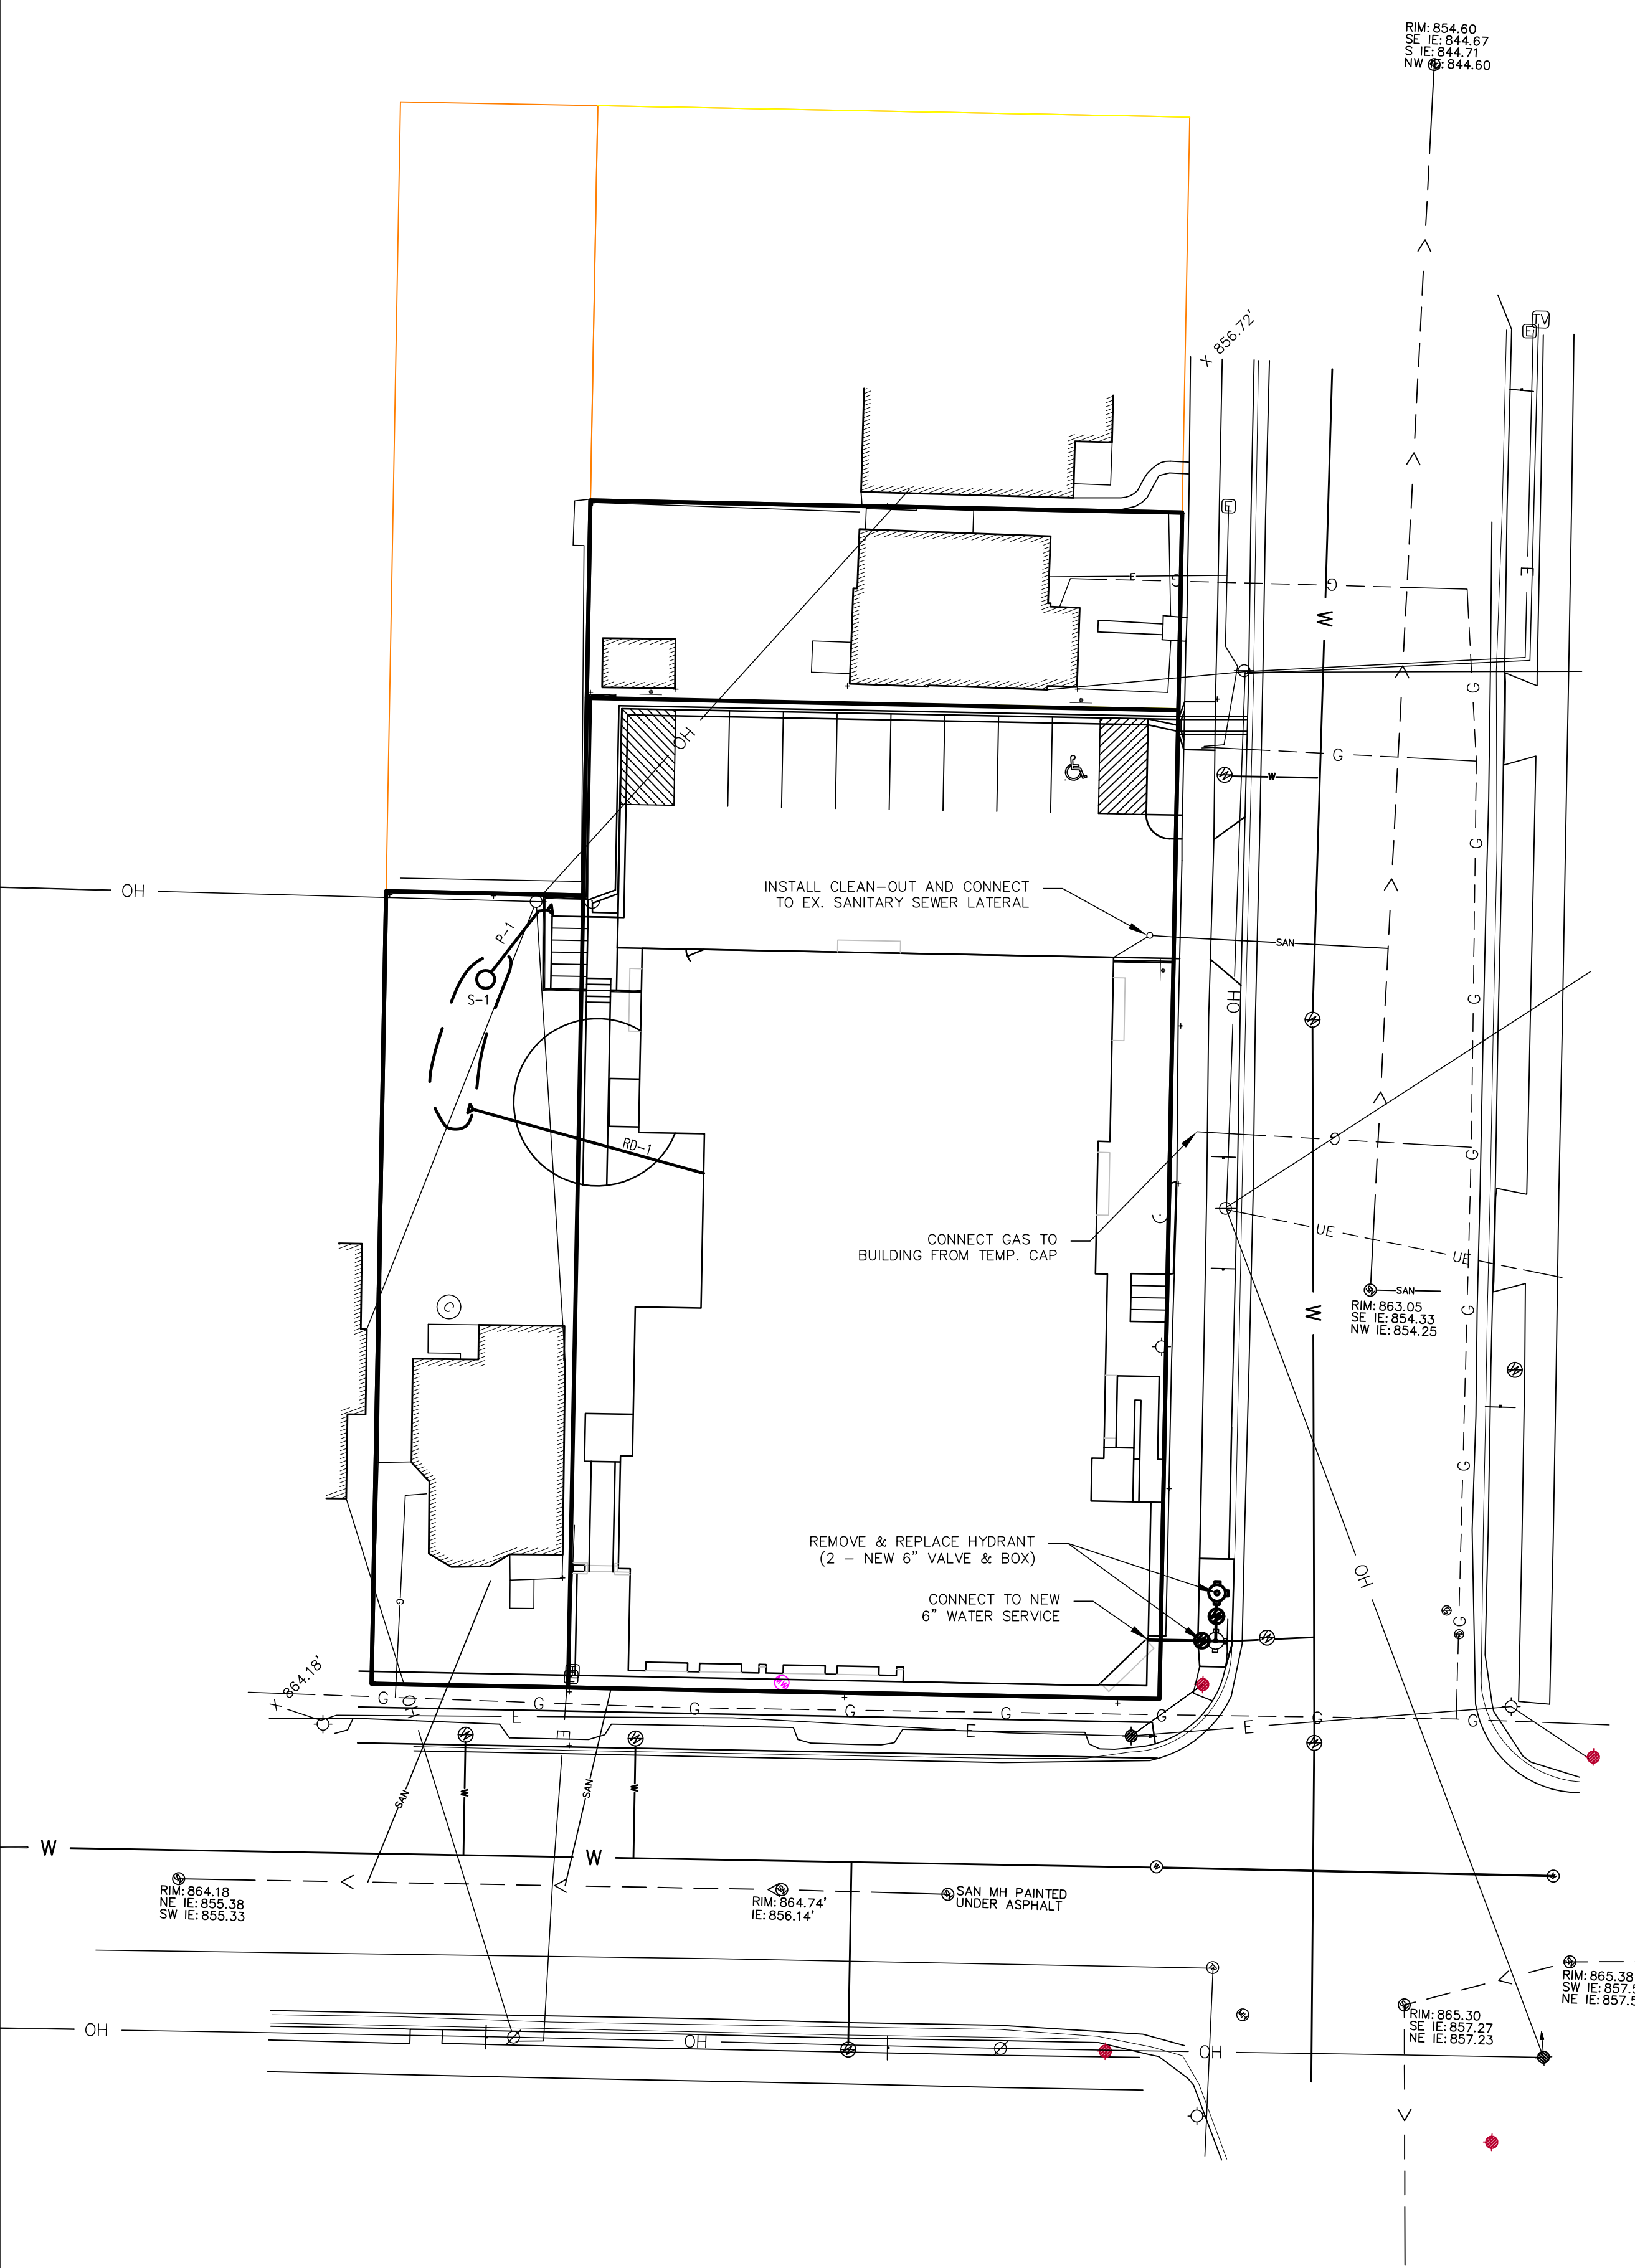


**STORM SEWER STRUCTURE DETAIL**

STRUCTURE NUMBER	TYPE	GRATE/LID TYPES	TOP OF CASTING	INVERT	DEPTH (FT)
S-1	AREA INLET	R-2561	863.8	862.0	1.8

**STORM SEWER PIPE SCHEDULE**

PIPE NUMBER	FROM (UPSTREAM)	TO (DOWNSTREAM)	LENGTH (FT)	INLET INVERT	DISCHARGE INVERT	SLOPE (%)	DIAMETER OF PIPE (IN)
RD-1	BLDG	RAIN GARDEN	45	SEE ARCH.	863.8	0.52	6
P-1	S-1	ENDWALL	25	861.9	861.7	.0104	8

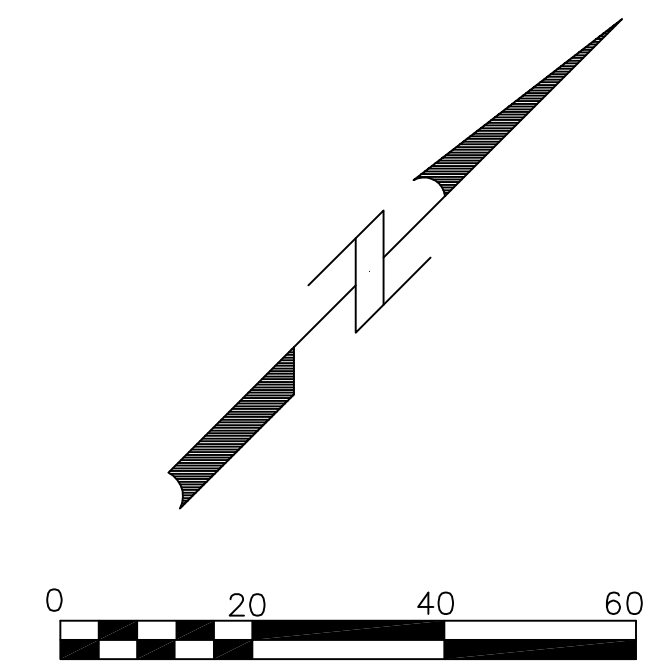

SCALE : 1" = 20' (11 X 17)  
SCALE : 1" = 40' (24 X 36)

**1252 WILLIAMSON STREET  
UTILITY PLAN**

DATE: 08-27-09  
REVISIONS:  
DATE: 09-02-09

M:\12243 WILLIAMSON STREET-BALDWIN STREET\12243 CIVIL-SURVEY\12243 BASE.DGN

Madison Office  
2690 Research Park Drive, Suite H  
Madison, WI 53711  
Ph: 608-442-9500  
Fx: 608-442-9501

Foribault, Minnesota: 507-331-1500  
Minnetonka, Minnesota: 507-387-6651  
Web: www.iis-gp.com

**IIS GROUP**  
*One firm - start to finish™*

ARCHITECTS - ENGINEERS - PLANNERS - LAND SURVEYORS - SCIENTISTS

SHEET  
C-3.1

Consultant

Notes




LANDSCAPE ARCHITECTS



303 S. PATERSON SUITE ONE MADISON, WI 53703  
Phone: 608 251-3600  
Fax: 608 251-9330  
www.ksd-la.com

**NOT FOR BIDDING OR CONSTRUCTION**



Revisions  
PUD-SIP Submittal - September 2, 2009

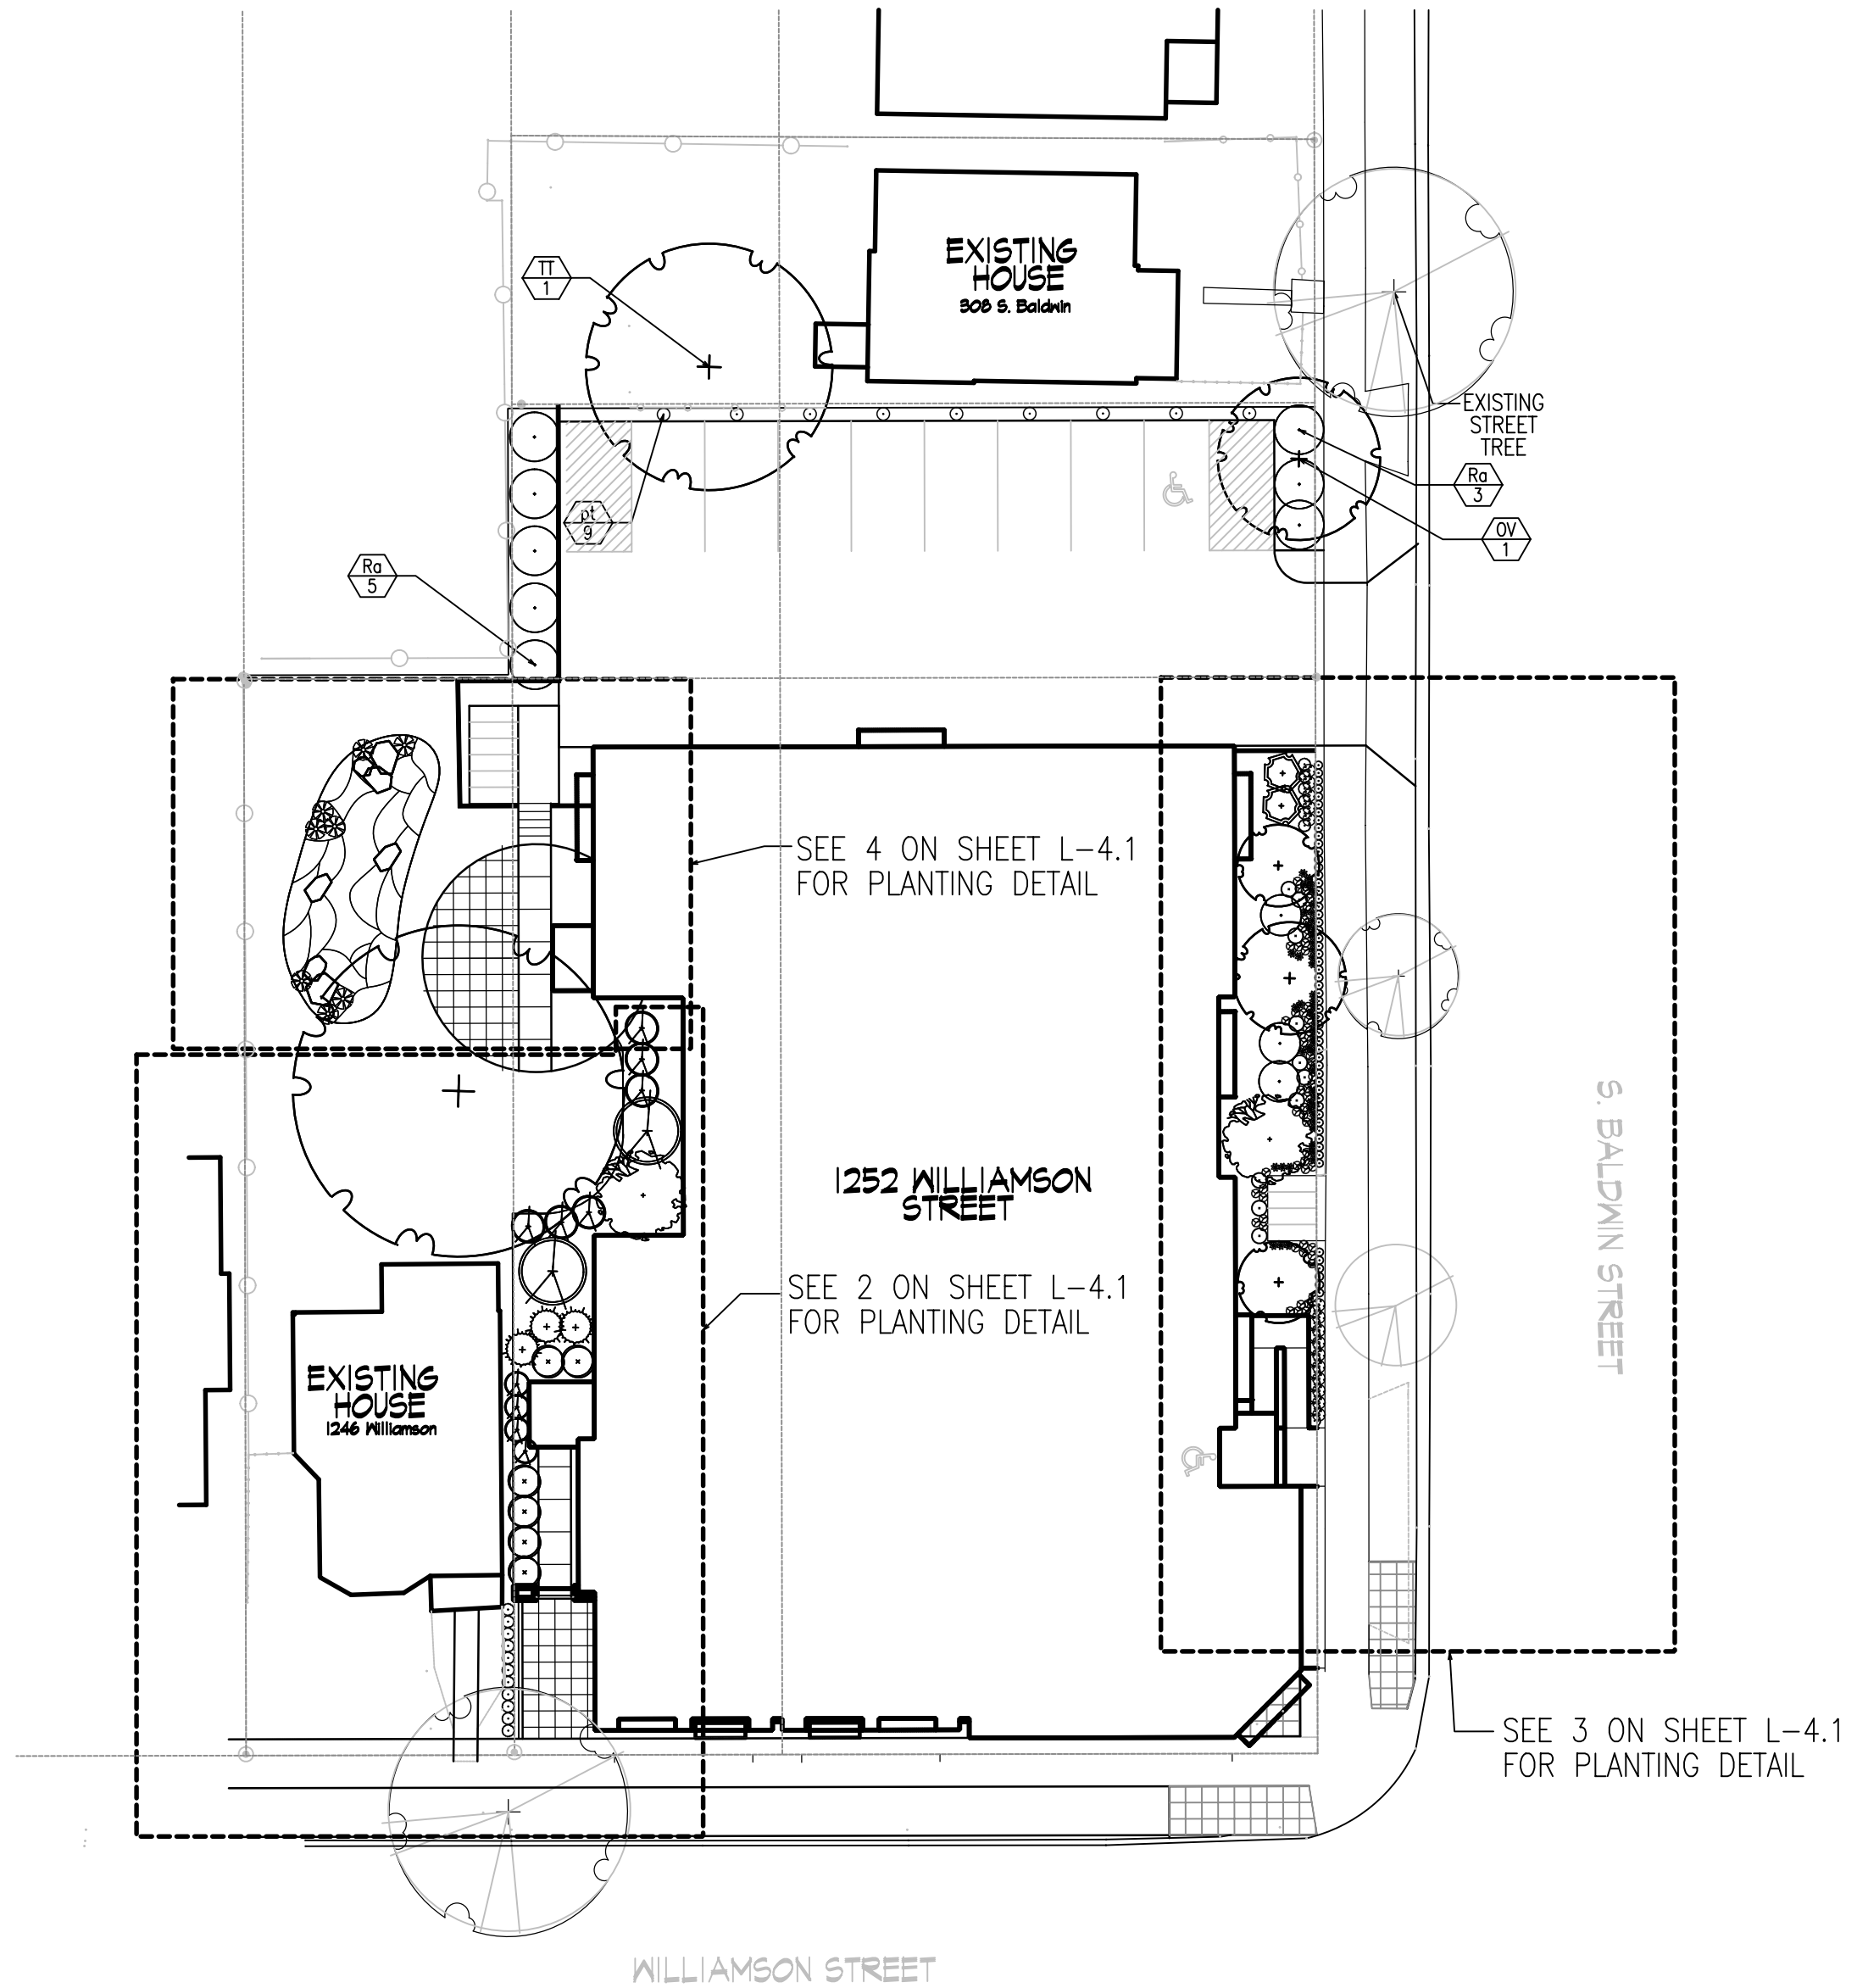



1 PLANTING PLAN  
1" = 20'-0"

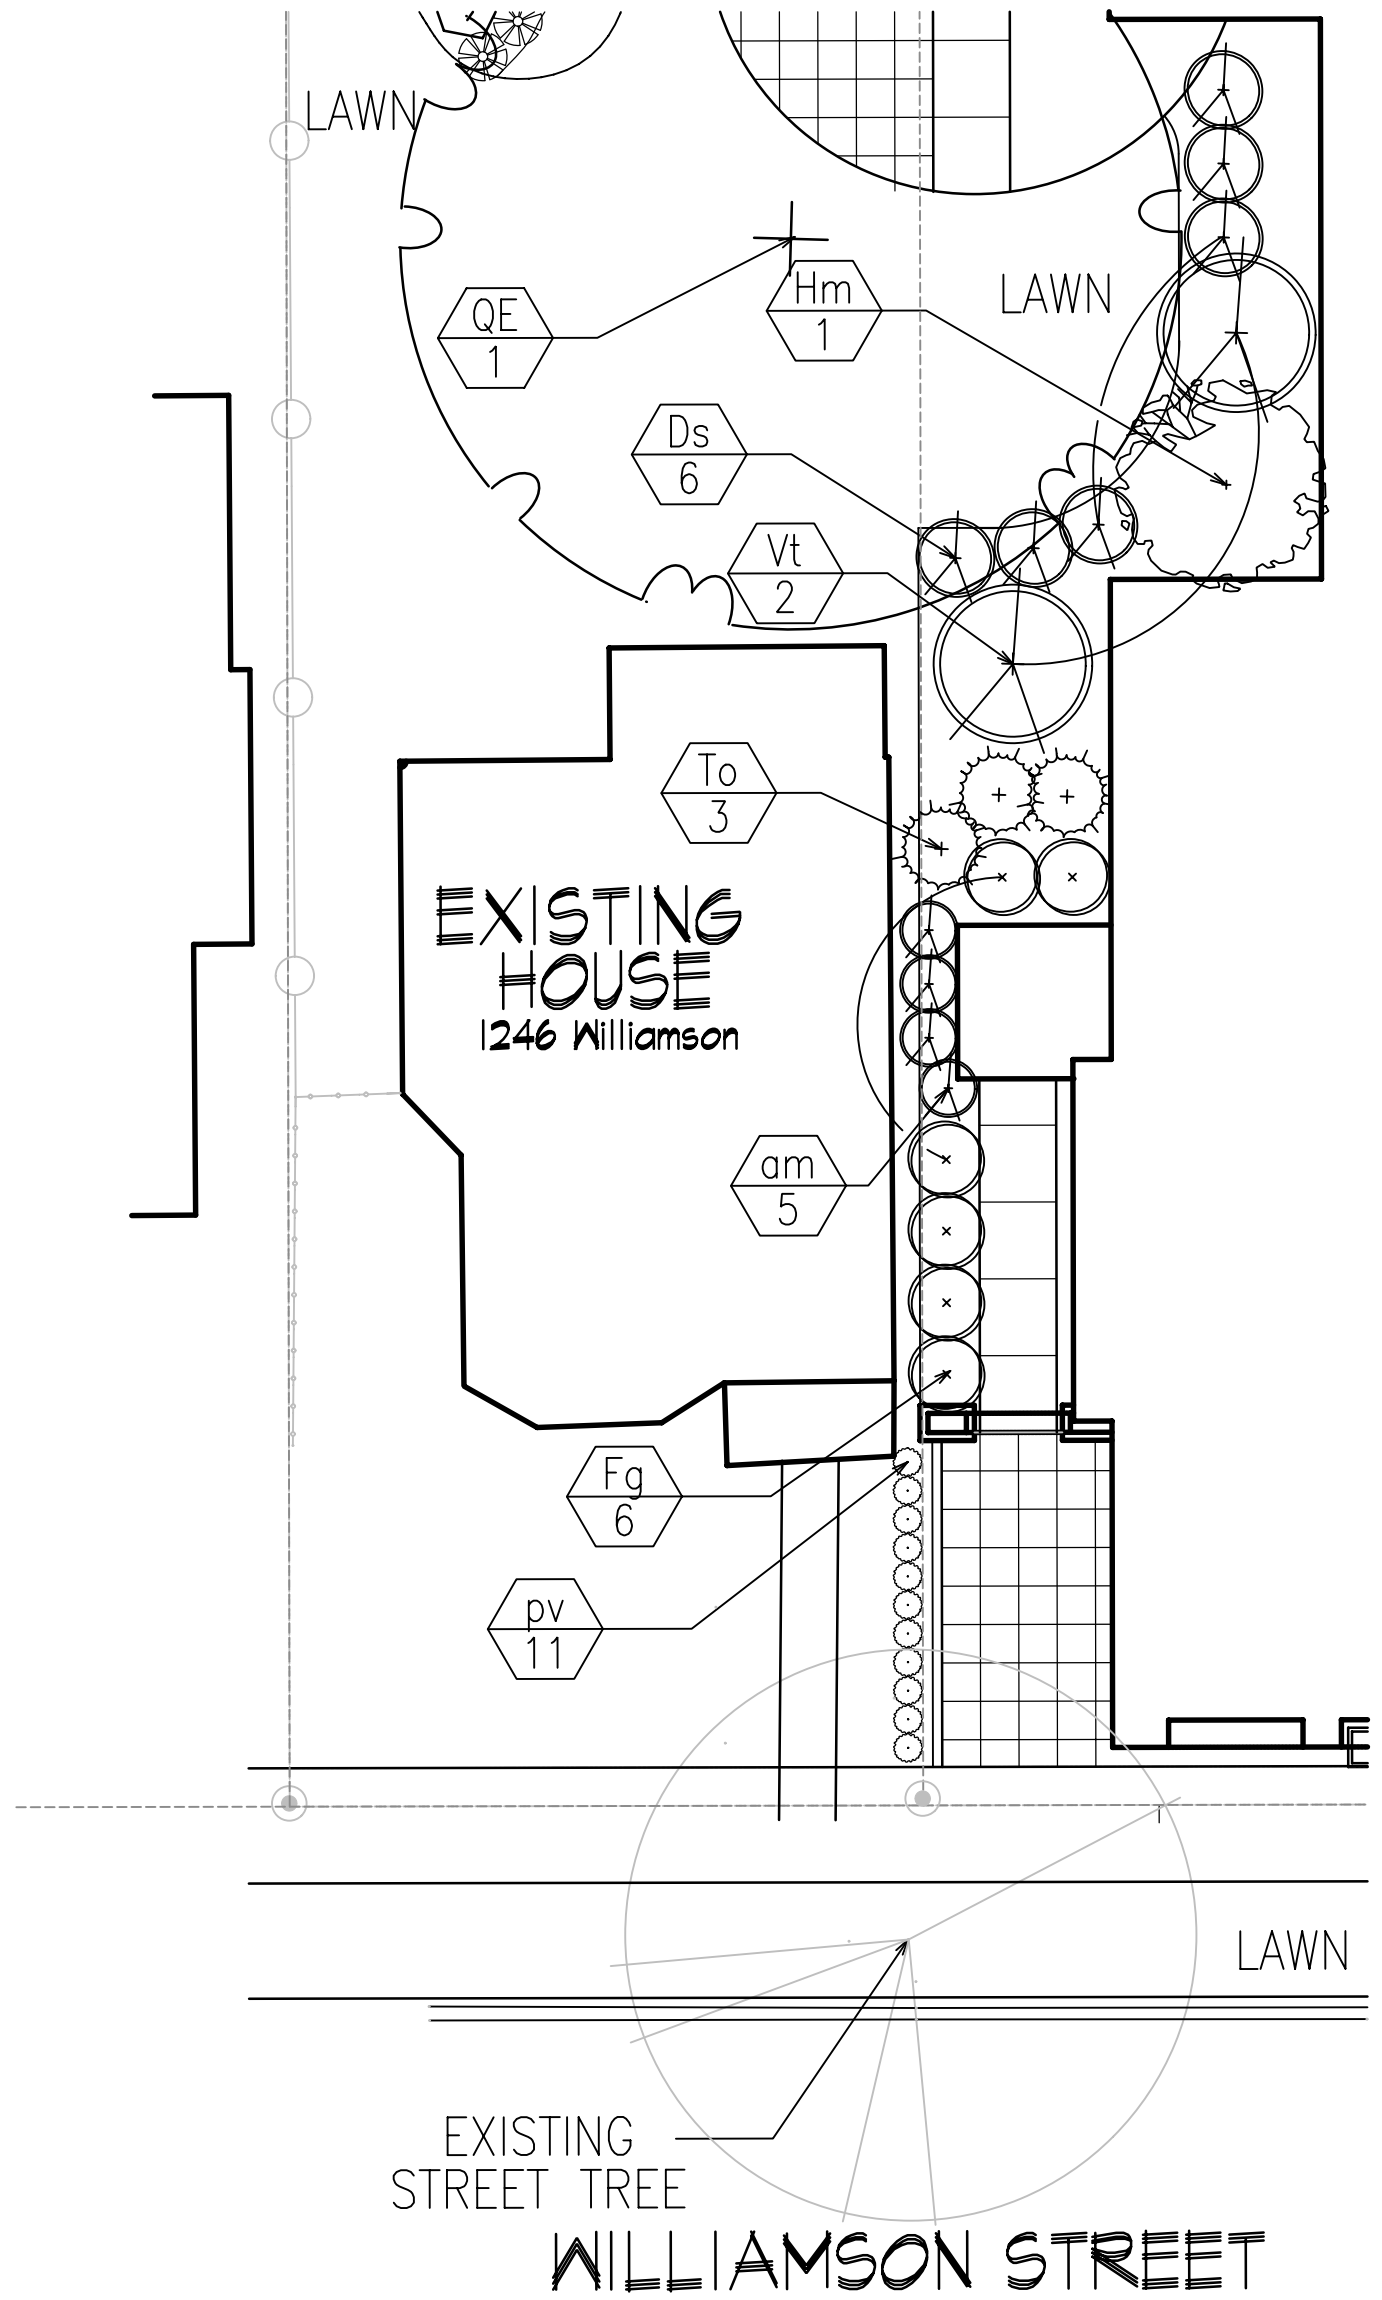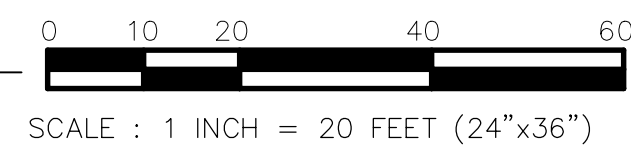


2 PLANTING DETAIL  
1" = 10'-0"

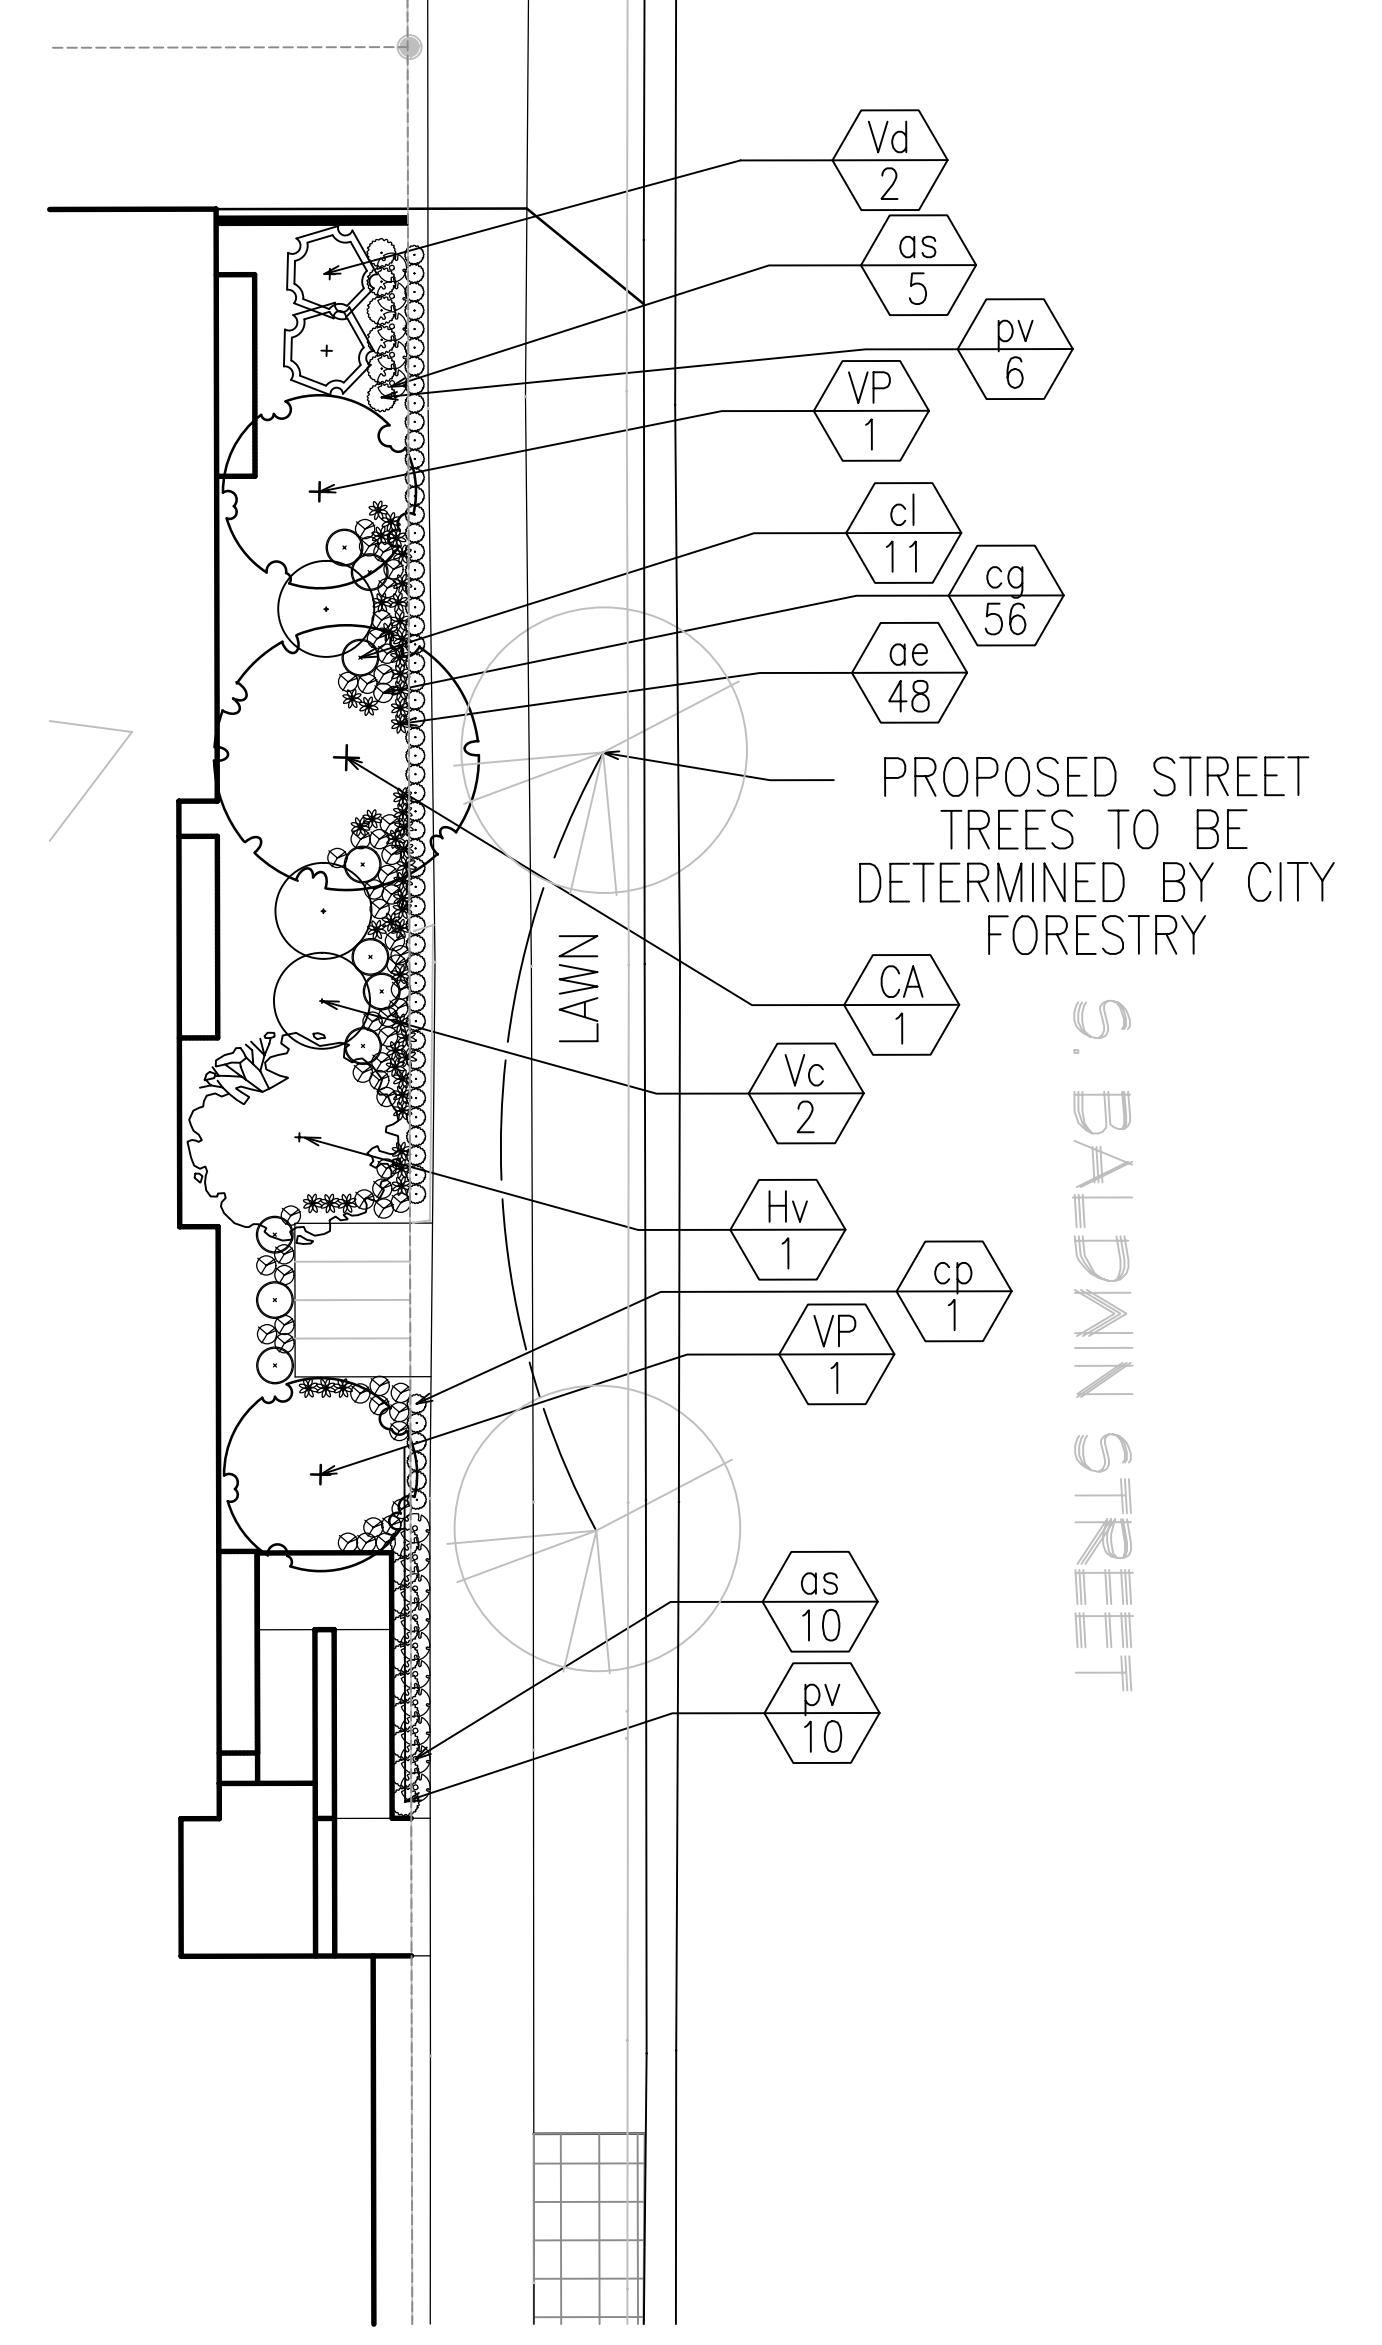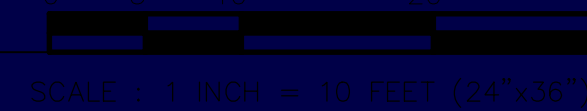

3 PLANTING DETAIL  
1" = 10'-0"

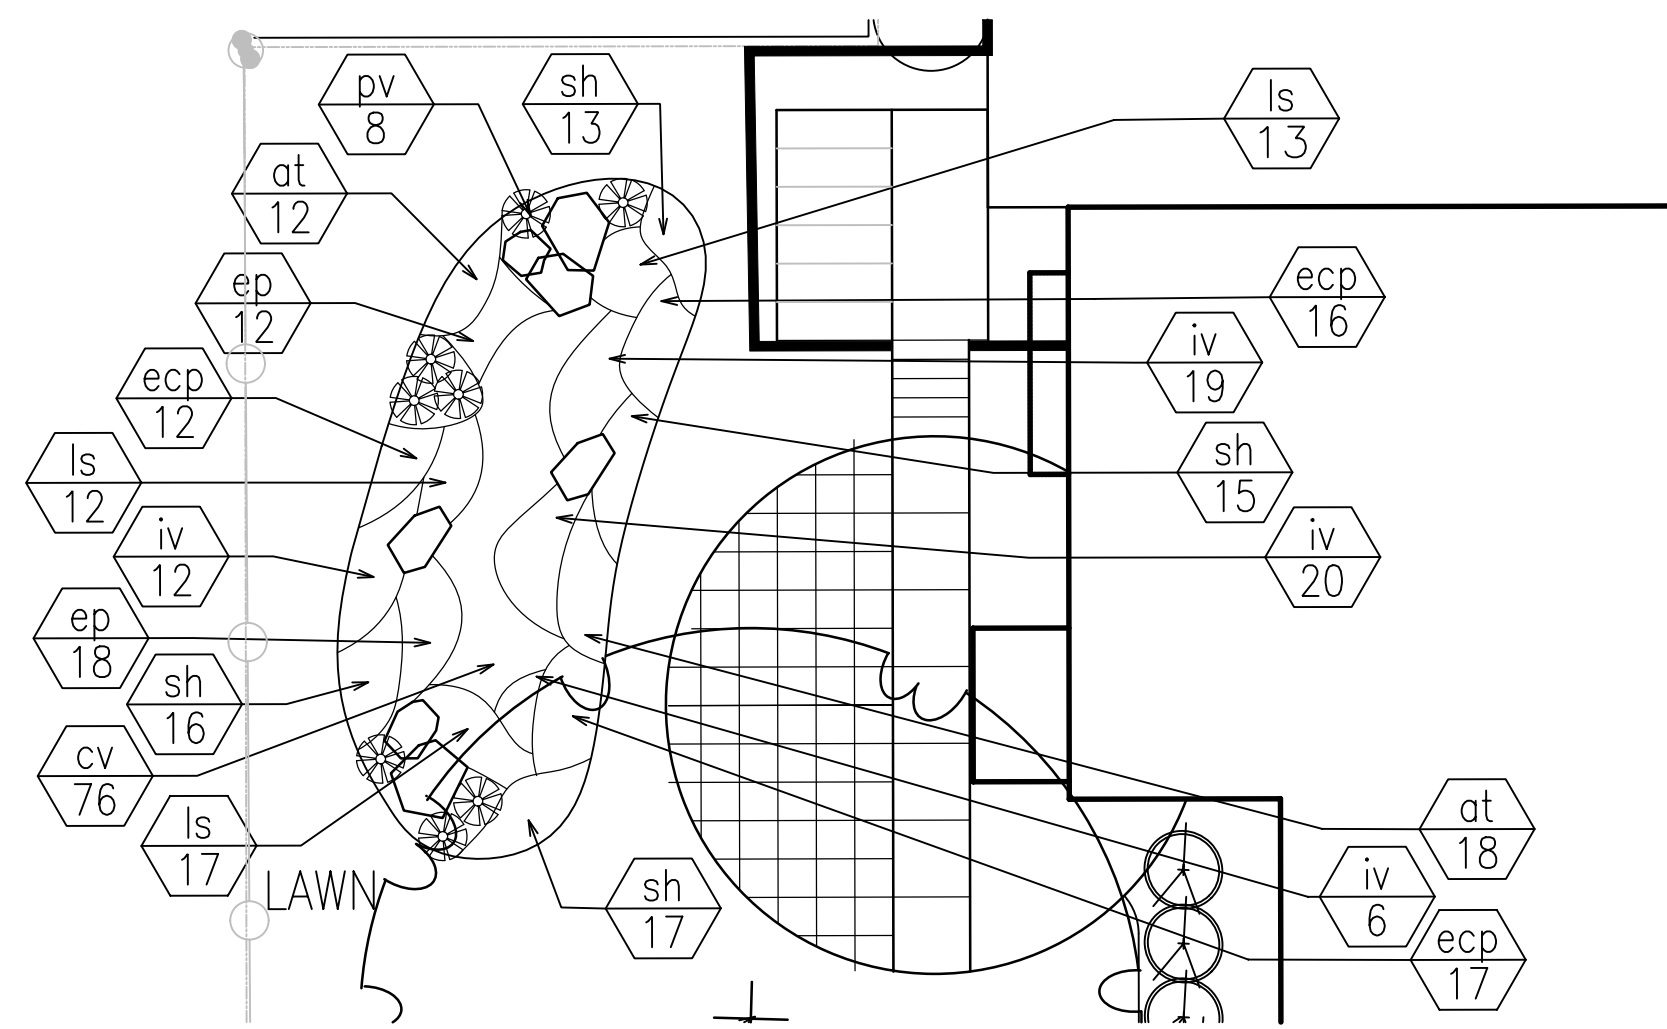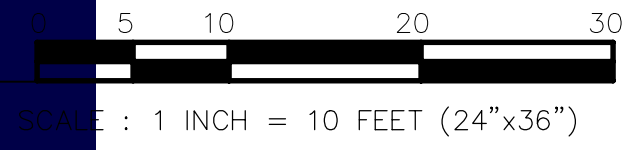

4 PLANTING DETAIL  
1" = 10'-0"

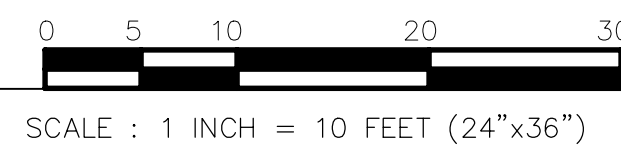

Plant Code	Plant Name	Quantity	Size	Notes
AF	Asplenium Platyneuron	1	7"	100%
OV	Asplenium Platyneuron	1	7"	100%
QE	Asplenium Platyneuron	1	7"	100%
TT	Asplenium Platyneuron	1	7"	100%
<b>Am</b>				
Am	Asplenium Platyneuron	2	7"	100%
Ds	Asplenium Platyneuron	1	7"	100%
Fg	Asplenium Platyneuron	1	7"	100%
Hv	Asplenium Platyneuron	2	7"	100%
Ra	Asplenium Platyneuron	1	7"	100%
Vd	Asplenium Platyneuron	2	7"	100%
Vt	Asplenium Platyneuron	2	7"	100%
To	Asplenium Platyneuron	1	7"	100%
<b>cl</b>				
cl	Asplenium Platyneuron	11	7"	100%
VP	Asplenium Platyneuron	1	7"	100%
<b>cg</b>				
cg	Asplenium Platyneuron	56	7"	100%
<b>ae</b>				
ae	Asplenium Platyneuron	48	7"	100%
<b>CA</b>				
CA	Asplenium Platyneuron	1	7"	100%
<b>Vc</b>				
Vc	Asplenium Platyneuron	2	7"	100%
<b>Hv</b>				
Hv	Asplenium Platyneuron	1	7"	100%
<b>VP</b>				
VP	Asplenium Platyneuron	1	7"	100%
<b>cp</b>				
cp	Asplenium Platyneuron	1	7"	100%
<b>as</b>				
as	Asplenium Platyneuron	10	7"	100%
<b>pv</b>				
pv	Asplenium Platyneuron	10	7"	100%

Project Title  
1252 Williamson Street

Drawing Title  
Planting Plan

Project No.  
0916

Drawing No.  
L-4.1

This document contains confidential or proprietary information of Knothe & Bruce Architects. Neither the document nor the information herein is to be reproduced, distributed, used, or disclosed, either in whole or in part, except as specifically authorized by Knothe & Bruce Architects. Knothe & Bruce Architects is a Limited Liability Company of Wisconsin.

Consultant

Notes

Revisions  
PUD-SIP Submittal - Sept. 2, 2009


Project Title  
1252 Williamson Street

Drawing Title  
Basement and First Floor Plan


Project No. Drawing No.

0916

This document contains confidential or proprietary information of Knothe & Bruce Architects. Neither the document nor the information herein is to be reproduced, distributed, used, or disclosed, either in whole or in part, except as specifically authorized by Knothe & Bruce Architects. Knothe & Bruce Architects is a Limited Liability Company of Wisconsin.

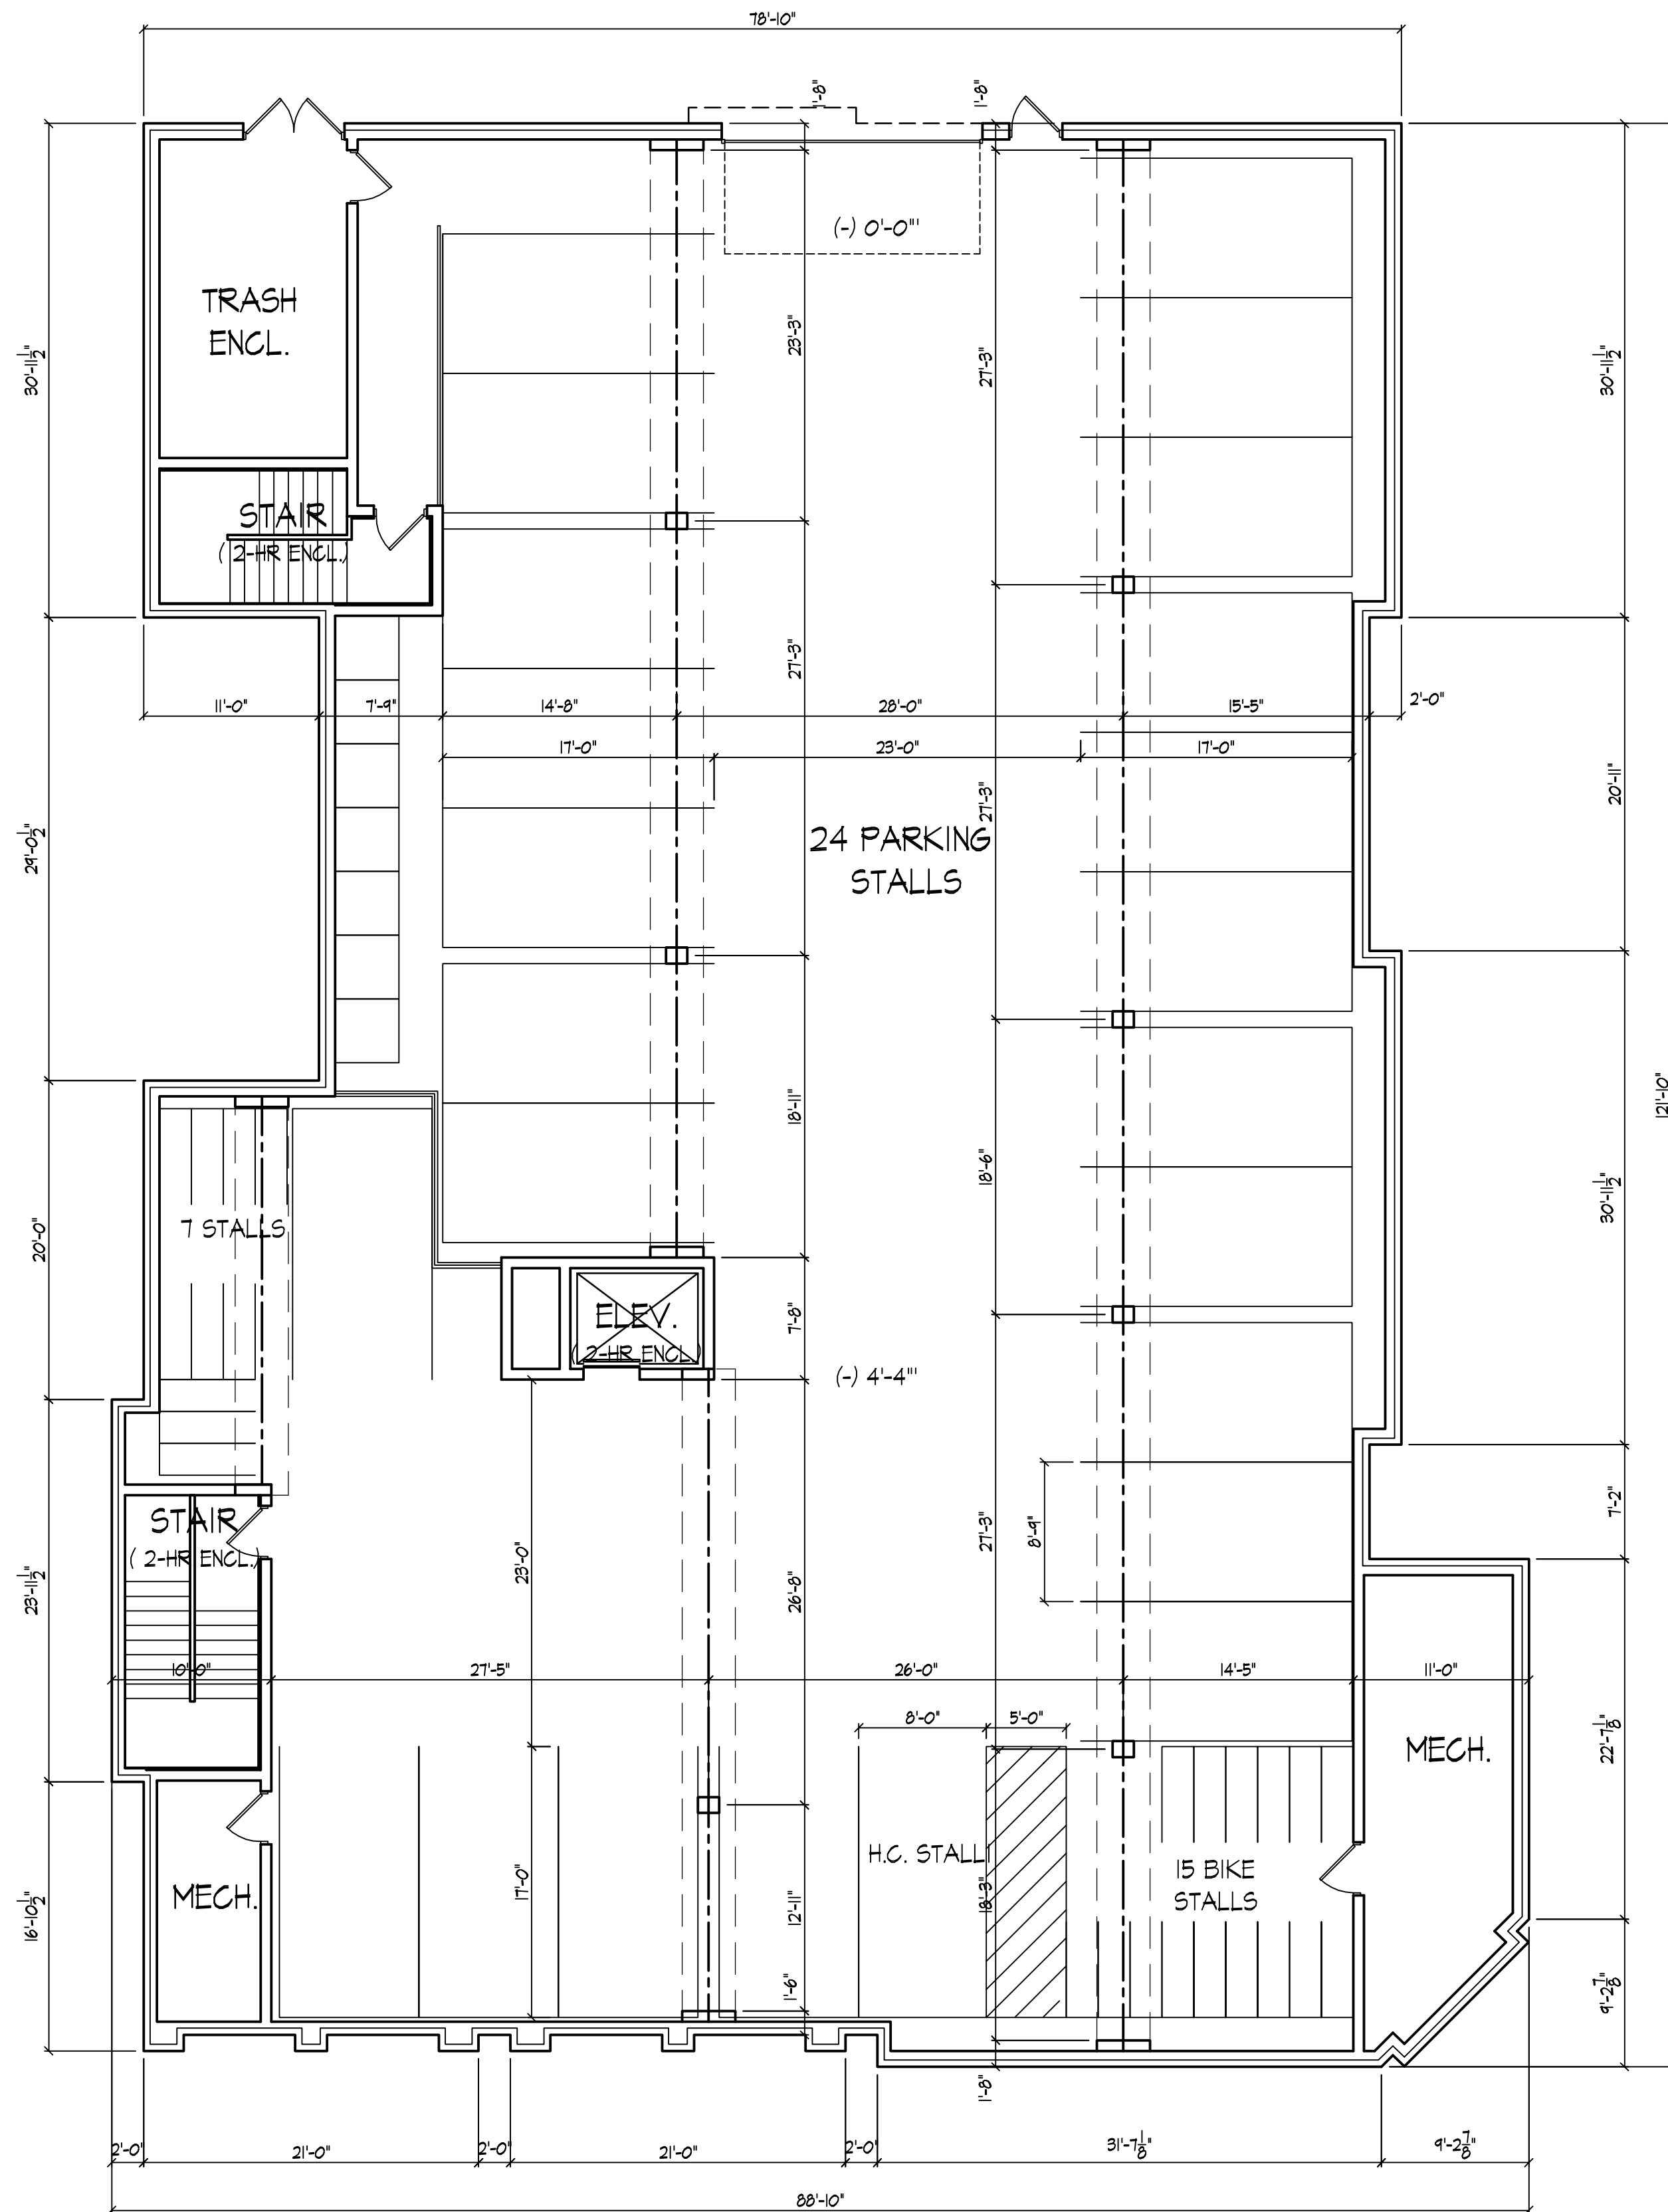

**BASEMENT FLOOR PLAN**  
1/8" = 1'-0"

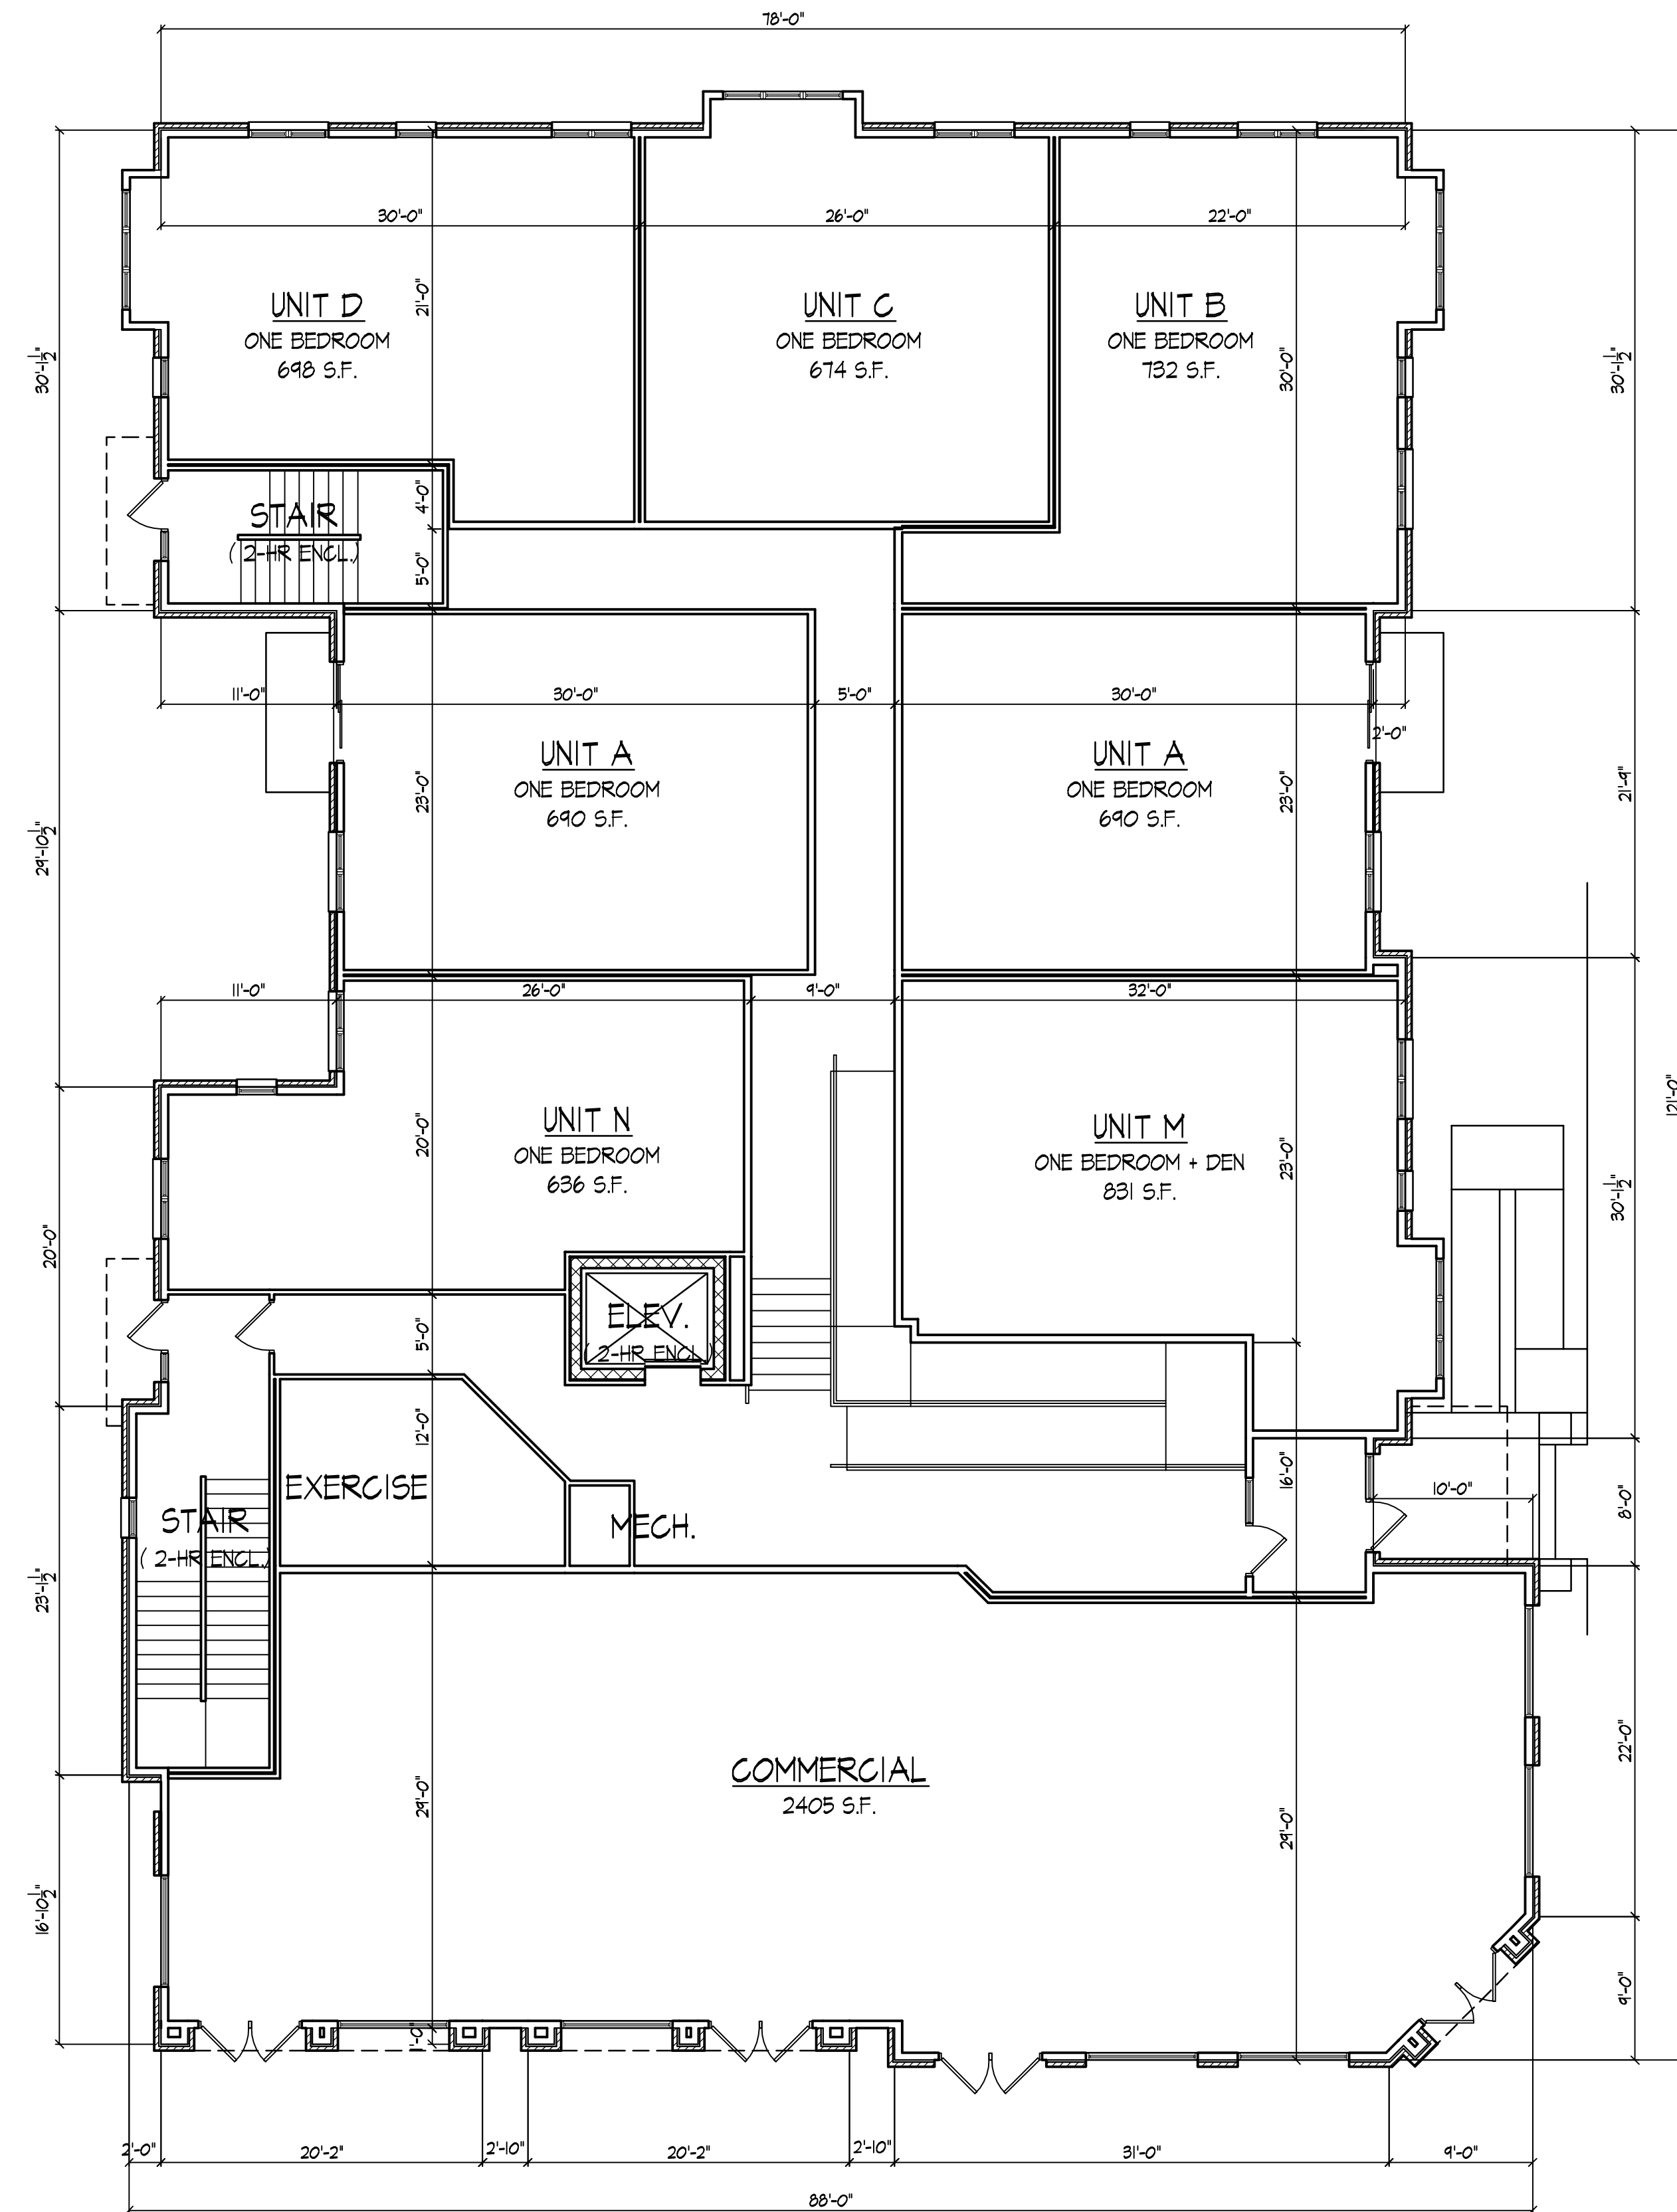

**FIRST FLOOR PLAN**  
1/8" = 1'-0"

Consultant

Notes

Revisions  
PUD-SIP Submittal - Sept. 2, 2009


Project Title  
1252 Williamson Street

Drawing Title  
Second and Third  
Floor Plan


Project No. Drawing No.

0916 2

This document contains confidential or proprietary information of Knothe & Bruce Architects. Neither the document nor the information herein is to be reproduced, distributed, used, or disclosed, either in whole or in part, except as specifically authorized by Knothe & Bruce Architects. Knothe & Bruce Architects is a Limited Liability Company of Wisconsin.

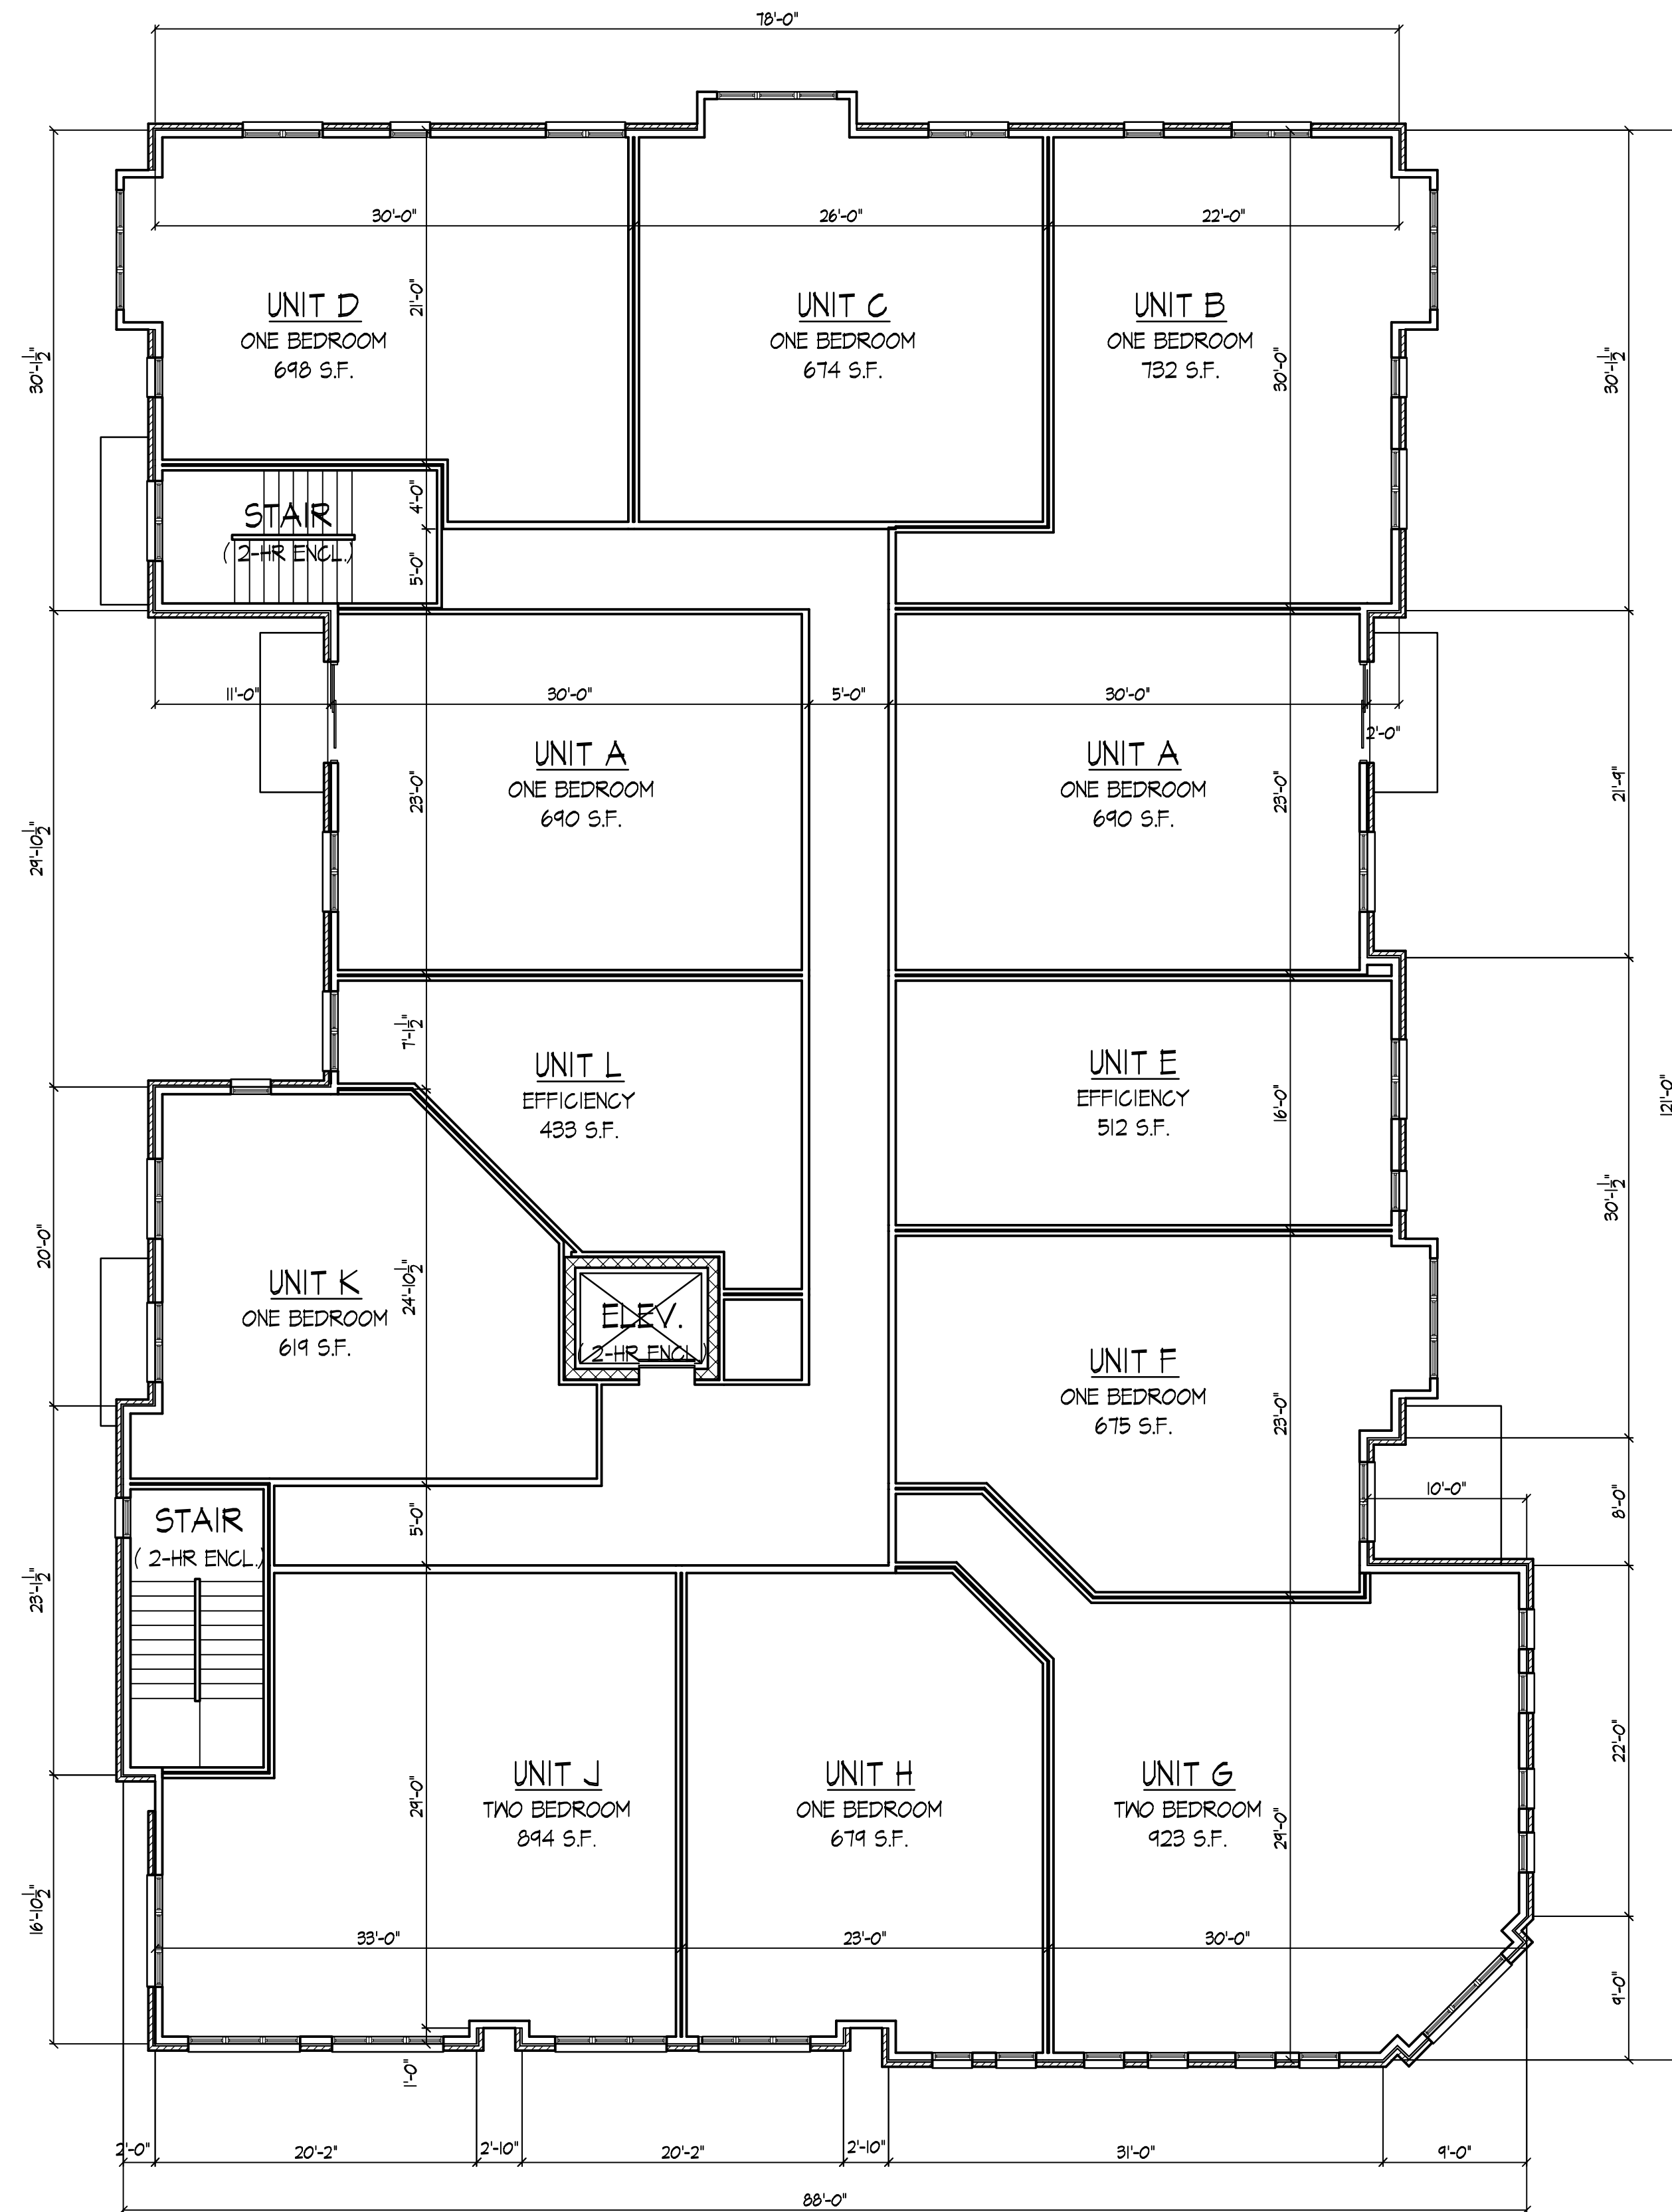

**SECOND FLOOR PLAN**  
1/8" = 1'-0"

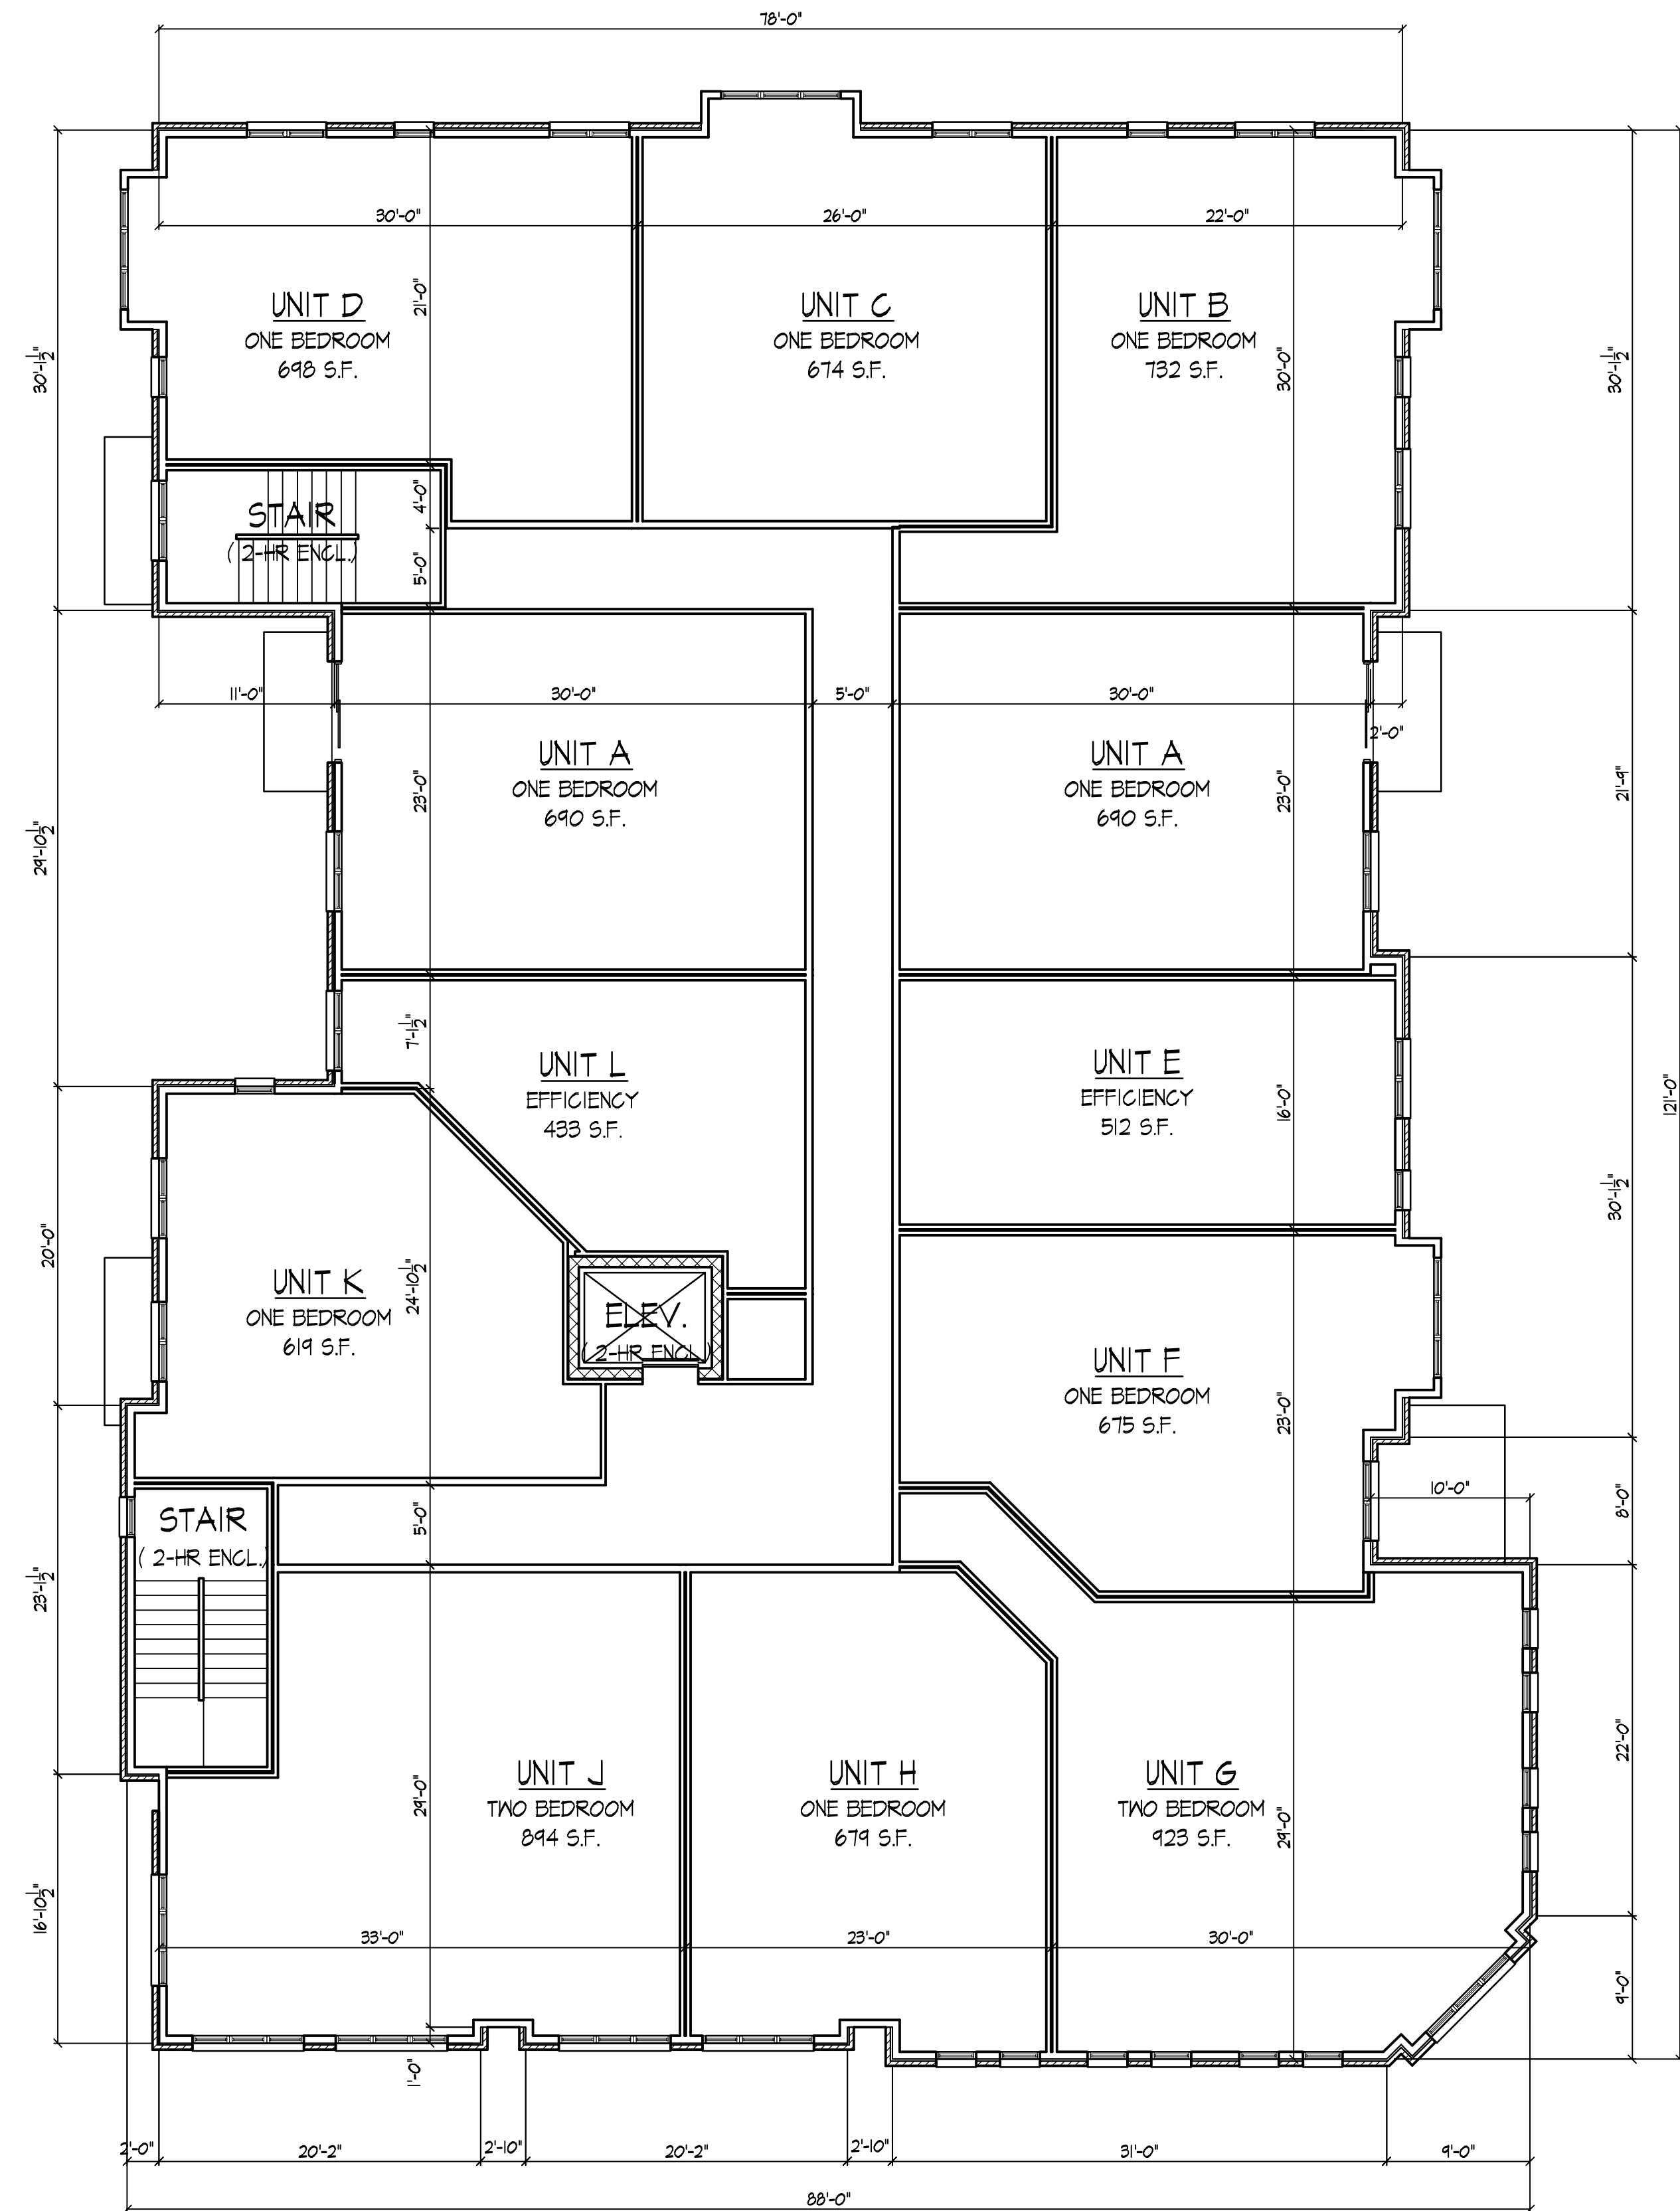

**THIRD FLOOR PLAN**  
1/8" = 1'-0"





**ELEVATION ALONG WILLIAMSON STREET**  
3/82' = 1'-0"



**ELEVATION ALONG S. BALDWIN**  
3/82' = 1'-0"

- TYPICAL MATERIALS**
- ALUMINUM COPING ON PAINTED HARDI-PLANK TRIM
  - BRICK VENEER
  - PRECAST WINDOW HEADS
  - PRECAST WINDOW SILL
  - RECESSED BRICK BANDS
  - PRECAST BANDS
  - SIGNAGE PANEL
  - PRECAST BAND
  - PRECAST WATER TABLE
  - PAINTED WOOD PANELS

- TYPICAL MATERIALS**
- ALUMINUM COPING ON PAINTED HARDI-PLANK TRIM
  - BRICK VENEER
  - PAINTED METAL TRELLIS
  - BRICK SOLDIER COURSE
  - RECESSED BRICK BANDS
  - ALUM. RAILING RAILING
  - PAINTED HARDI-PLANK BAYS
  - RENAISSANCE BASE

Revisions  
PUD-SIP Submittal - Sept. 2, 2009

Project Title  
**1252 Williamson Street**

Drawing Title  
**Elevations**

Project No. **0916** Drawing No. **3**

Consultant

Notes



**NORTHWEST ELEVATION**  
1/8" = 1'-0"



**NORTHEAST ELEVATION**  
1/8" = 1'-0"

Revisions  
PUD-SIP Submittal - Sept. 2, 2009

Project Title  
**1252 Williamson Street**

Drawing Title  
**Elevations**

Project No. Drawing No.  
**0916 4**

This document contains confidential or proprietary information of Knothe & Bruce Architects. Neither the document nor the information herein is to be reproduced, distributed, used, or disclosed, either in whole or in part, except as specifically authorized by Knothe & Bruce Architects. Knothe & Bruce Architects is a Limited Liability Company of Wisconsin.