


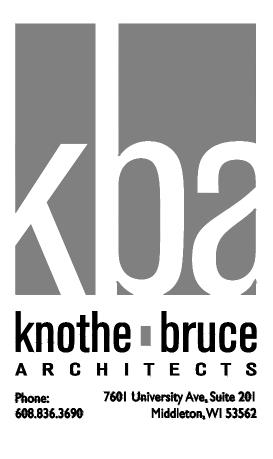

SITE INDEX SHEET SITE C-1.0 C-1.1 C-1.2 C-1.3	OVERALL SITE PLAN SITE PLAN SITE LIGHTING PLAN FIRE DEPARTMENT ACCESS PLAN
C-2.0	GRADING AND EROSION CONTROL PLAN
C-3.0	UTILITY PLAN
LI	LANDSCAPE PLAN
ARCHITECTURAL	
A-1.0	BASEMENT PLAN
A-1.1	FIRST FLOOR PLAN
A-1.2	SECOND FLOOR PLAN
A-1.3	THIRD FLOOR PLAN
A-2.1	ELEVATIONS
A-2.2	ELEVATIONS
A-2.3	ELEVATIONS



SITE DEVELOPMEN	STATISTICS	
LOT AREA	73,715 S.F./1.69 A	CRES
DWELLING UNITS	71 D.U.	
LOT AREA/ D.U.	1,038 S.F./D.U.	
DENSITY	42 UNITS/ACRE	
BUILDING HEIGHT	3 STORIES	
GROSS FLOOR AREA	93,265 S.F.	
(excluding underground p	arking)	
FLOOR AREA RATIO	1.26	
UNIT MIX		
GUEST SUITE	I	
ONE BEDROOM	25	
TWO BEDROOM	29	
THREE BEDROOM	16	
TOTAL	71	
VEHICLE PARKING		
SURFACE	18	
UNDERGROUND	88	
TOTAL	106	
BIKE PARKING		
FLOOR STALL, SURFA		14
WALL HUNG, UNDER		14
FLOOR STALL, UNDER	GROUND	50
TOTAL		78
USABLE OPEN SPACE		
GROUND LEVEL	14,438 S.F.	
DECKS & PATIOS	3,150 S.F.	


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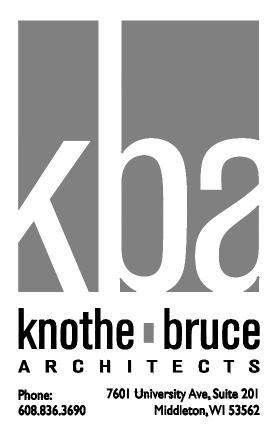
PROJECT TITLE

ROYSTER CROSSINGS LOT 5

SHEET TITLE OVERALL SITE PLAN

C-1.0



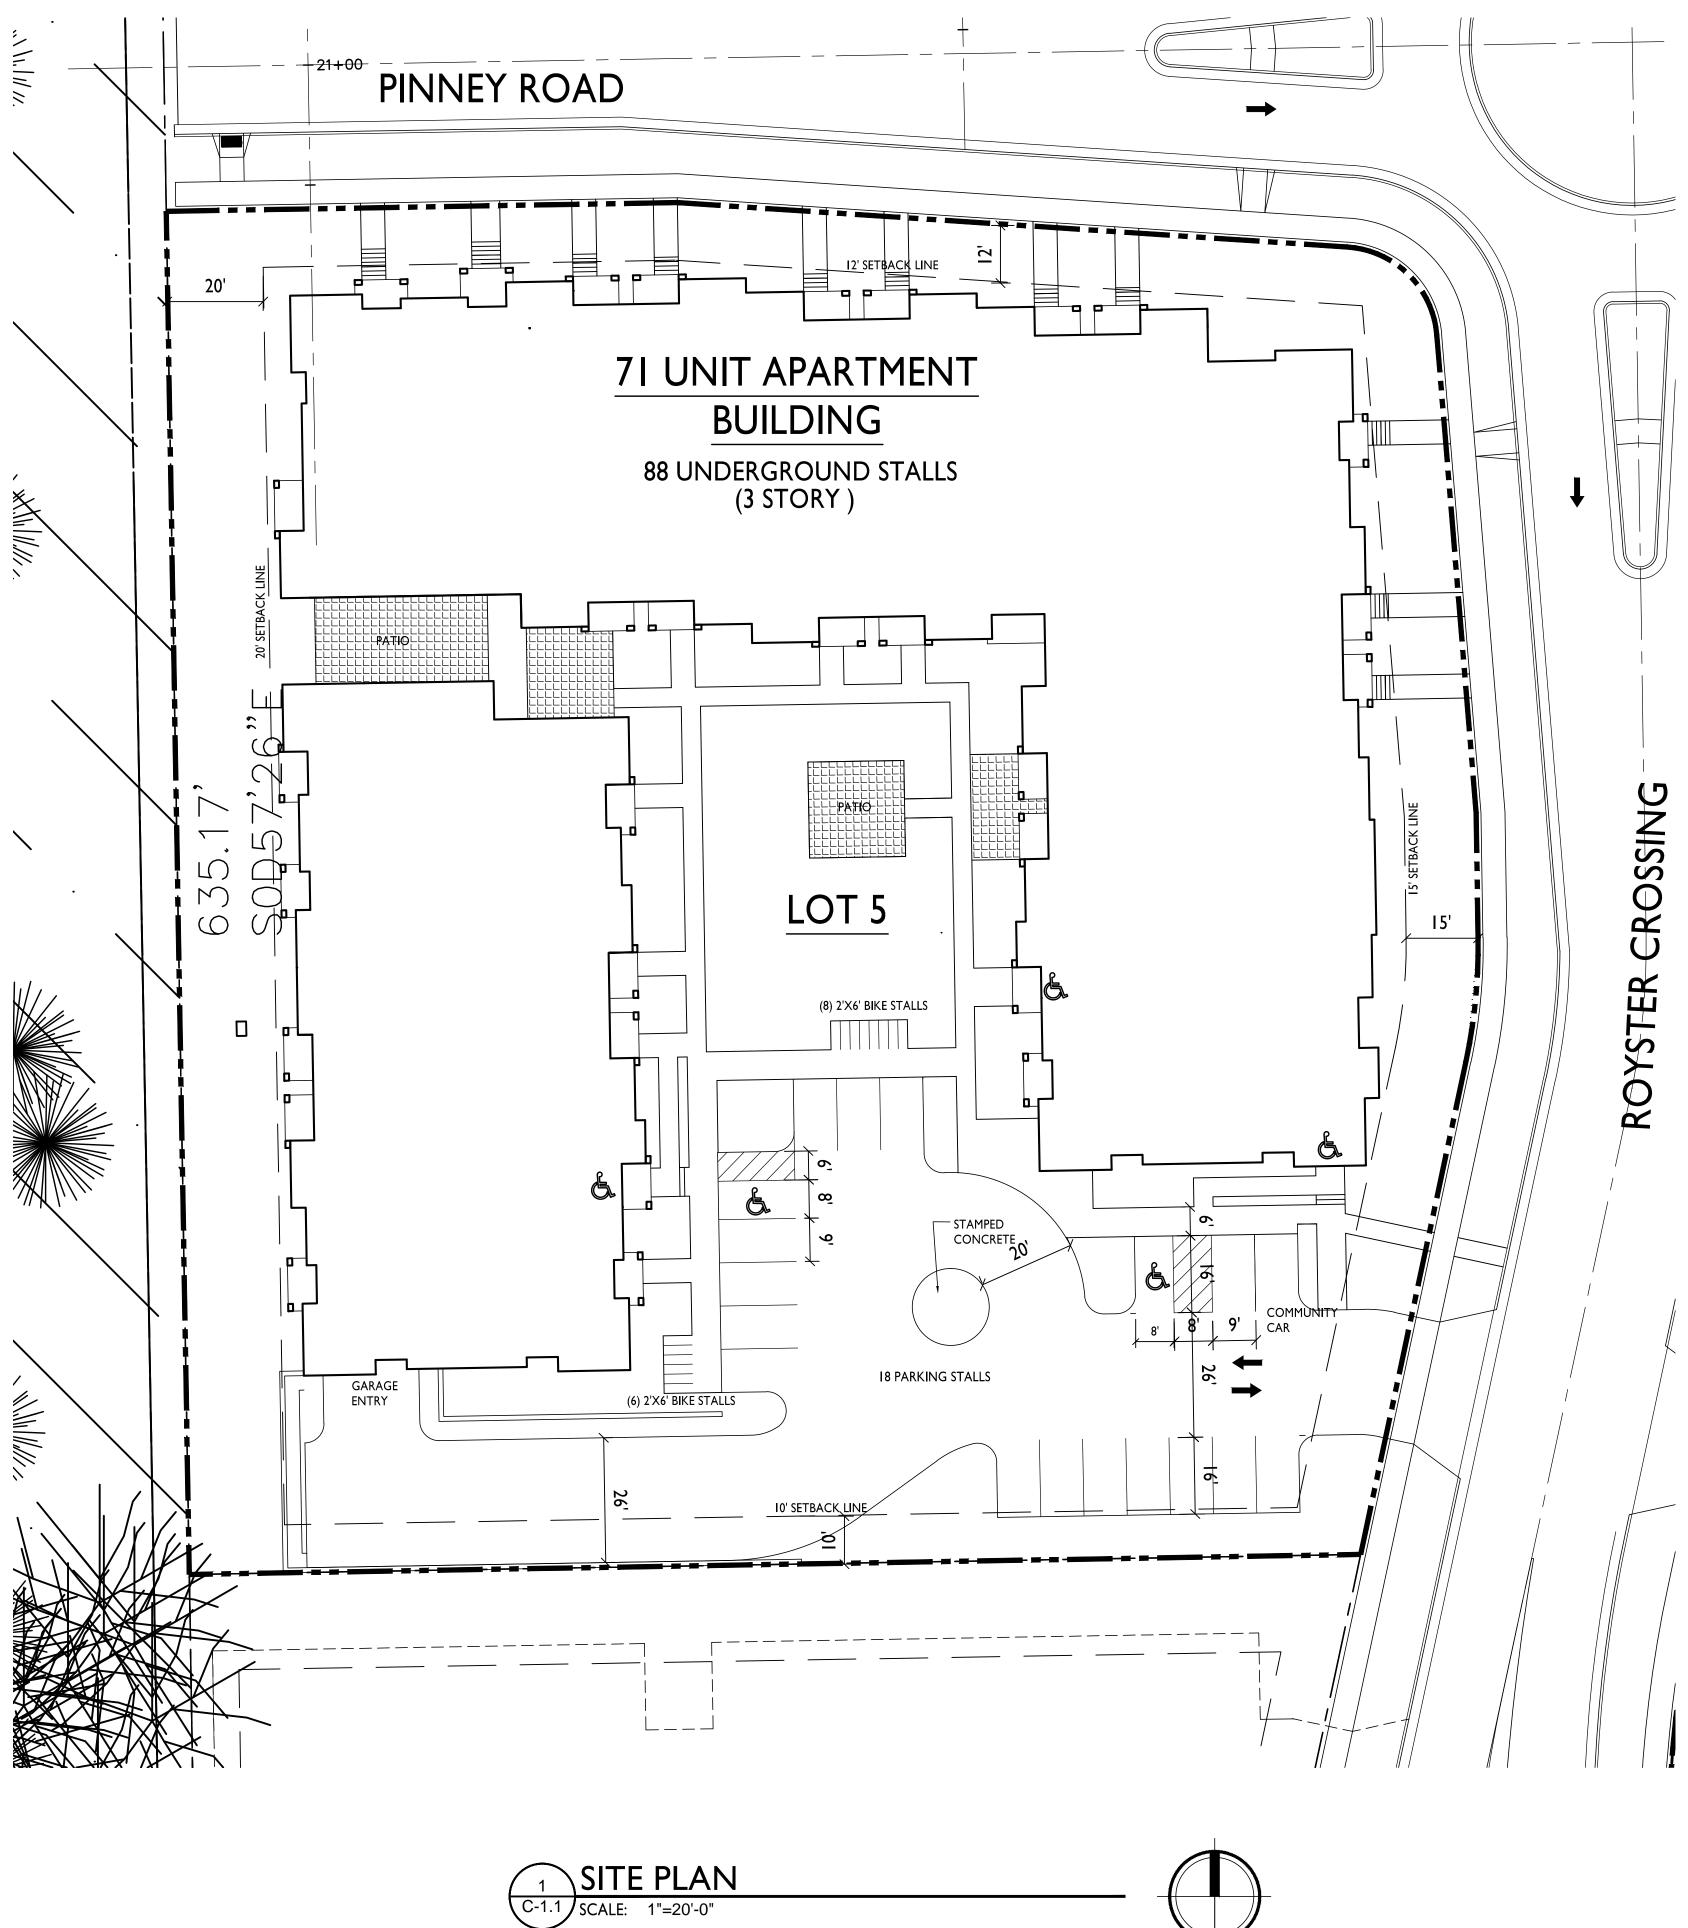

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PROJECT TITLE


ROYSTER CROSSINGS LOT 5

sheet title SITE PLAN


SHEET NUMBER

C-1.1

PROJECT NO. 1344 © 2013 Knothe & Bruce Architects

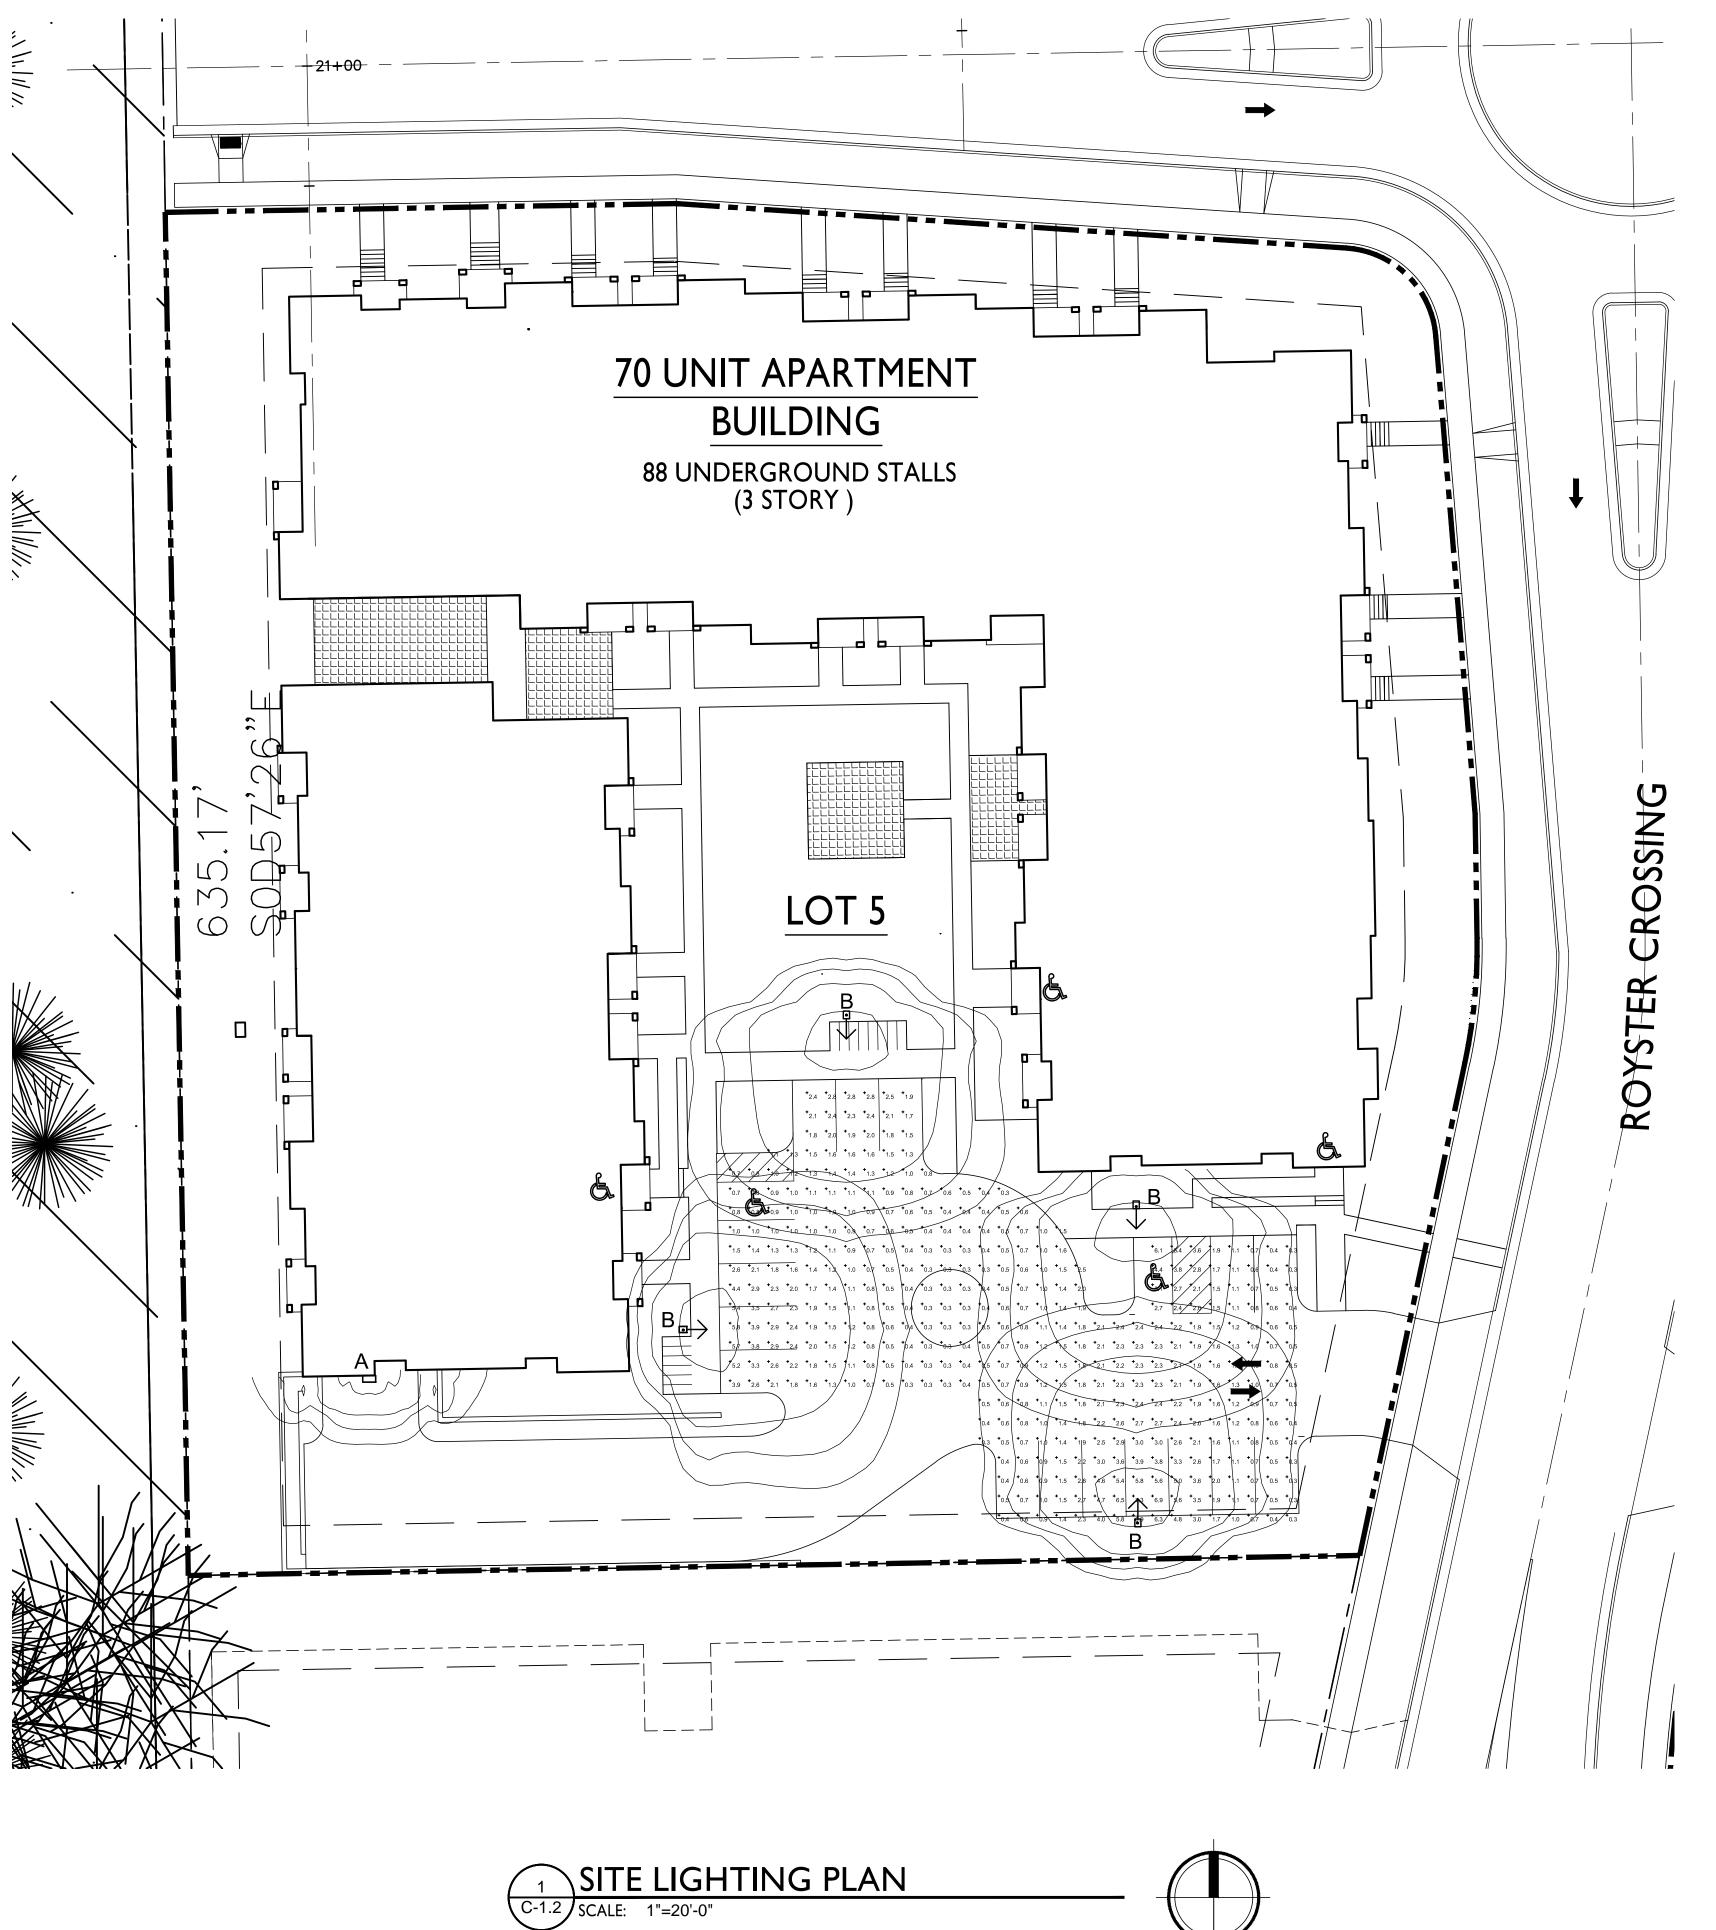



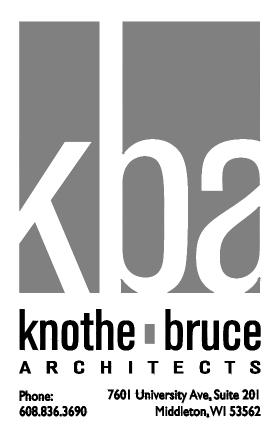

REVISIONS


PROJECT TITLE ROYSTER CROSSINGS LOT 5

LIGHTING SCHEDULE										
Symbol	Label	Qty	Manufacturer	Catalog Number	Description	Lamp	File	Mounting		
	А	1	RUUD LIGHTING	E8405	RECTANGULAR SECURITY / DEEP SHIELDED	50WATT MH	E8507.IES	8'-0" AOVE GRADE ON SIDE OF BUILDING		
\uparrow	В	4	RUUD LIGHTING	MAC410SBL	12" AREA CUTOFF / W/BACK LT. SHIELD	100 WATT MH	MAC417SBL.ie s	14'-0" POLE ON 2'-0" TALL CONC. BASE		


LIGHTING STATIS	TICS					
Description	Symbol	Avg	Max	Min	Max/Min	Avg/Min
PARKING	+	1.2 fc	7.3 fc	0.3 fc	24.3:1	4.0:1

SHEET TITLE SITE LIGHTING PLAN

C-1.2

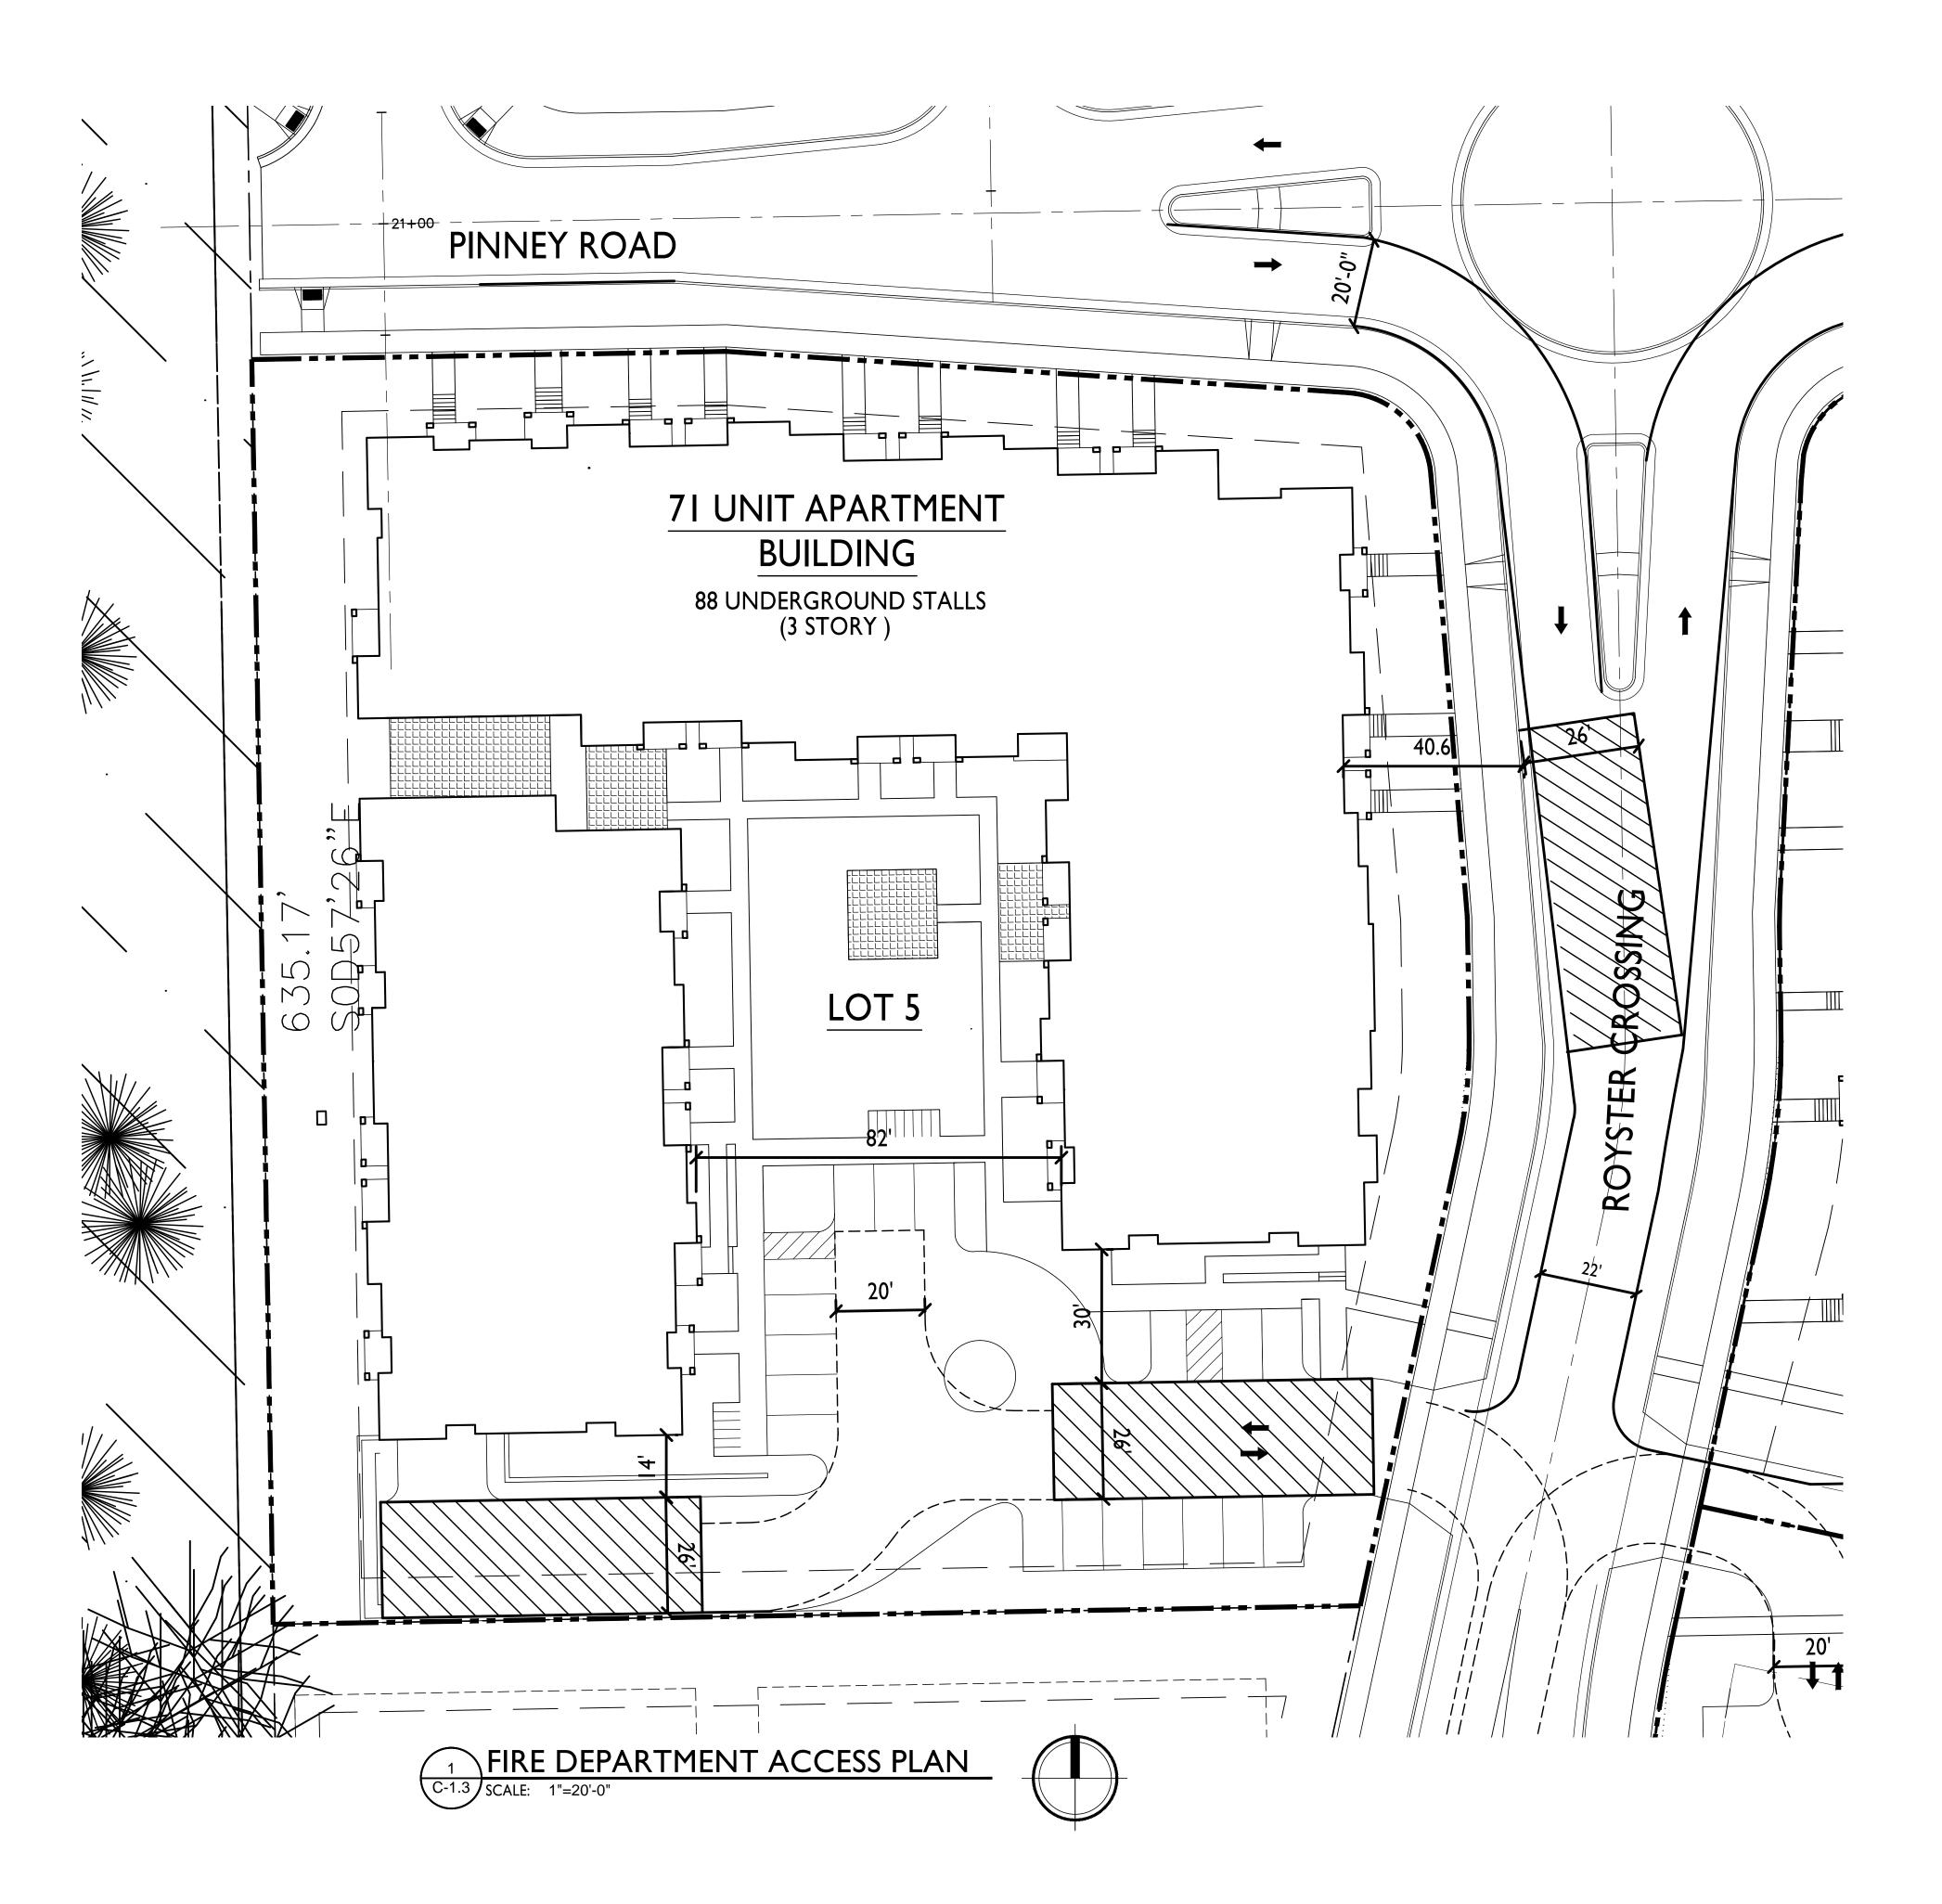

I. = 26' WIDE AERIAL APPARATUS FIRE LANE PARALLEL TO ONE ENTIRE SIDE OF A BUILDING AND WITHIN 30'.

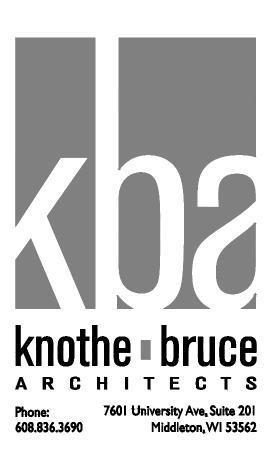


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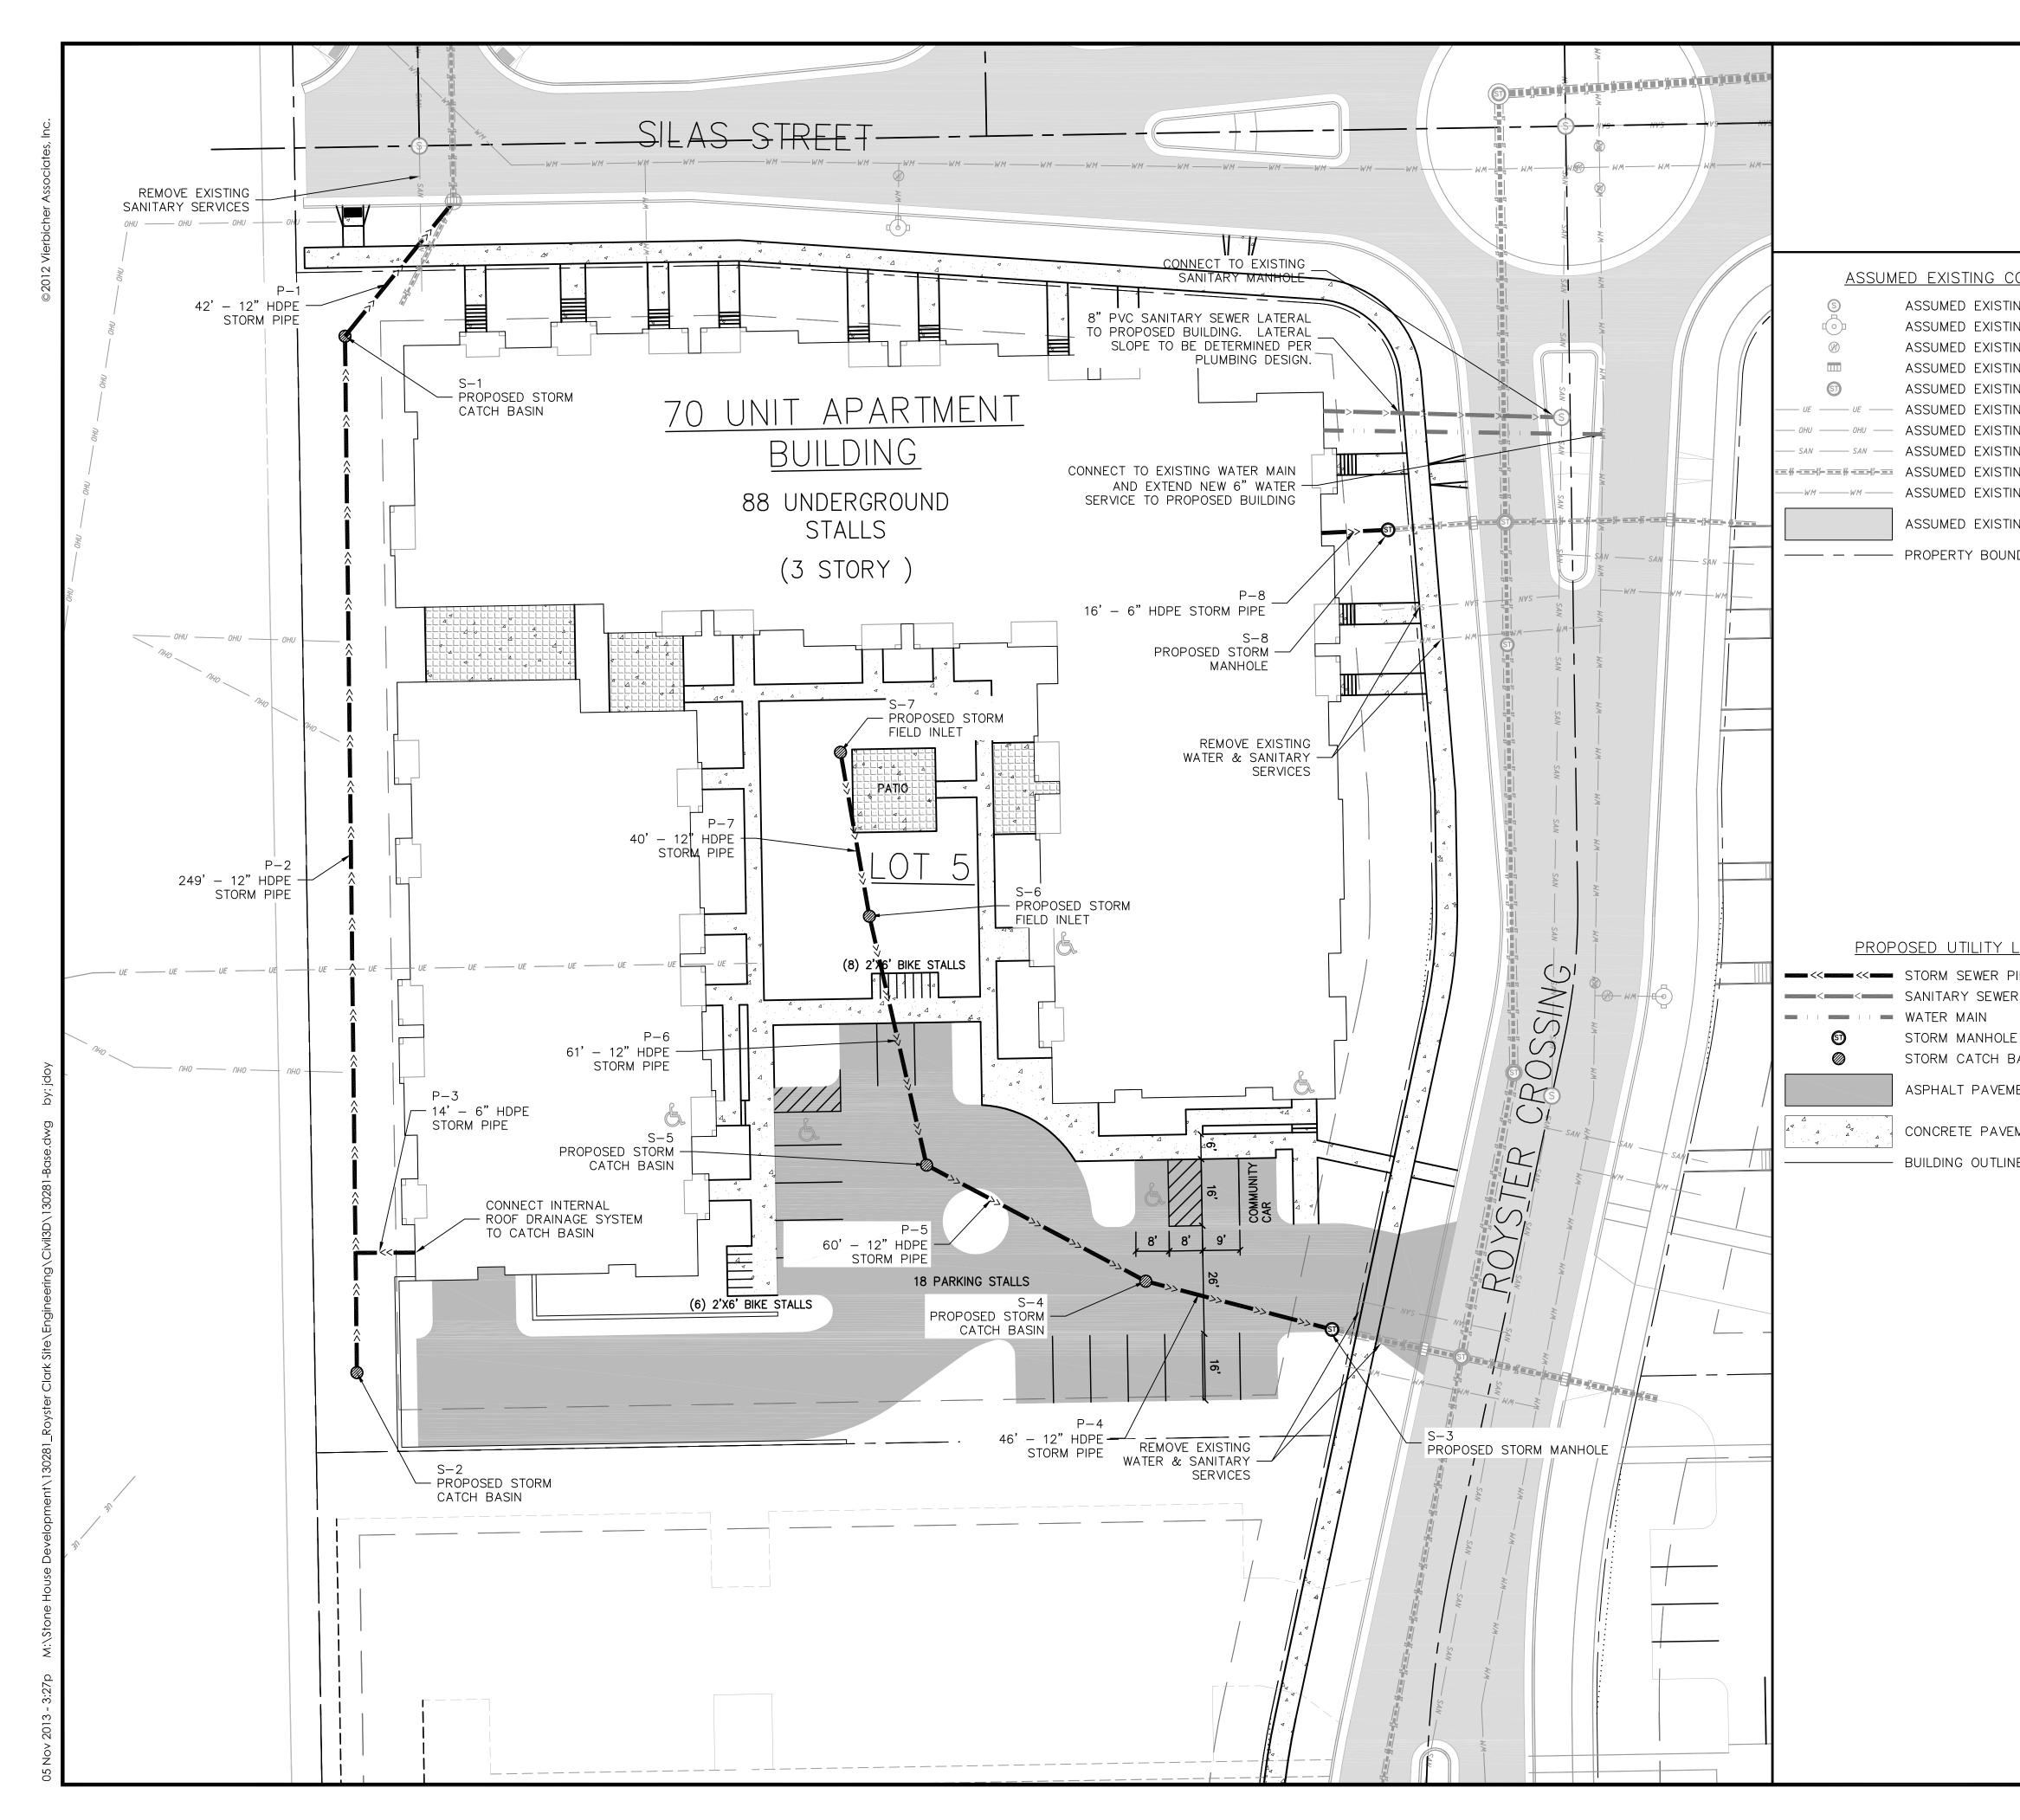
PROJECT TITLE ROYSTER CROSSINGS LOT 2, 3 AND 5

SHEET TITLE FIRE ACCESS PLAN LOT 5


C-1.3



CALL DIGGER'S HOTLINE 1-800-242-8511 TOLL FREE BLEFAX: 1-800-338-3800 TOL FREE BLEFAX: 1-800-338-3800 TOL FREE MUSTATUTE 182.0175 (1979) WS. STATUTE 182.0175 (1979) REQUIRES MINIMUM OF 3 WORKING DAYS O 10 D 20 40 GRADING & EROSION CONTROL LEGEND - - - - ASSUMED EXISTING MAJOR CONTOURS (PLAT DESIGN CONTOURS) - - - - B18 PROPOSED CONTOURS - SILT FENCE B63.13 PROPOSED SPOT ELEVATIONS			olanners engineers advisors	REEDSBURG - MADISON - PRAIRIE DU CHIEN 999 Fourier Dive. Suite 201 - Madison , Wisconsin 53217	Phone: (608) 826-0532 Fax: (608) 826-0530
PROPOSED BUILDING OUTLINE PROPERTY BOUNDARY CURB AND GUTTER PROPOSED STORM MANHOLE PROPOSED STORM CATCH BASIN/FIELD INLET PROPOSED CONCRETE PROPOSED ASPHALT PAVEMENT EXISTING ASPHALT PAVEMENT C = BACK OF CURB PROPOSED ACCESSIBLE ROUTE C = GRADE					
EROSION CONTROL MEASURE NOTES EROSION CONTROL SHALL BE IN ACCORDANCE WITH THE CITY EROSION CONTROL ORDINANCE AND CHAPTER NR 216 OF THE WISCONSIN ADMINISTRATIVE CODE. CONSTRUCT AND MAINTAIN ALL EROSION AND SEDIMENT CONTROL MEASURES IN ACCORDANCE WITH WISCONSIN DNR TECHNICAL STANDARDS (http://dnr.wi.gov/runoff/stormwater/techstds.htm) AND WISCONSIN CONSTRUCTION SITE BEST MANAGEMENT PRACTICE HANDBOOK. INSTALL SEDIMENT CONTROL PRACTICES (TRACKING PAD, PERIMETER SILT FENCE, ETC.) PRIOR TO INITIATING OTHER LAND DISTURBING CONSTRUCTION ACTIVITIES. THE CONTRACTOR IS REQUIRED TO MAKE EROSION CONTROL INSPECTIONS AT THE END OF EACH WEEK AND WHEN 0.5 NCHES OF RAIN FALLS WITHIN 24 HOURS. INSPECTION REPORTS SHALL BE PREPARED AND FILED AS REQUIRED BY THE DNR AND/OR CITY. ALL MAINTENANCE WILL FOLLOW AN INSPECTION WITHIN 24 HOURS. EROSION CONTROL IS THE RESPONSIBILITY OF THE CONTRACTOR UNTIL ACCEPTANCE OF THIS PROJECT. EROSION CONTROL WEASURES AS SHOWN SHALL BE THE MINIMUM PRECAUTIONS THAT WILL BE ALLOWED. ADDITIONAL EROSION CONTROL MEASURES, AS REQUESTED IN WRITING BY THE STATE OR LOCAL INSPECTORS, OR THE DEVELOPER'S ENGINEER, SHALL BE INSTALLED WITHIN 24 HOURS.			royster crossing	ITY OF MADISON	DANE COUNTY, WISCONSIN
ADJACENT PAVED PUBLIC ROADWAY. SEDIMENT TRACKING PAD SHALL CONFORM TO WisDNR TECHNICAL STANDARD 1057. SEDIMENT REACHING THE PUBLIC ROAD SHALL BE REMOVED BY STREET CLEANING (NOT HYDRAULIC FLUSHING) BEFORE THE END OF EACH WORK DAY. STABILIZED DISTURBED GROUND: ANY SOIL OR DIRT PILES WHICH WILL REMAIN IN EXISTENCE FOR MORE THAN 7-CONSECUTIVE DAYS, WHETHER TO BE WORKED DURING THAT PERIOD OR NOT, SHALL NOT BE LOCATED WITHIN 25-FEET OF ANY ROADWAY, PARKING LOT, PAVED AREA, OR DRAINAGE STRUCTURE OR CHANNEL (UNLESS INTENDED TO BE USED AS PART OF THE EROSION CONTROL MEASURES). TEMPORARY STABILIZATION AND CONTROL MEASURES (SEEDING, WULCHING, TARPING, EROSION MATTING, BARRIER FENCING, ETC.) ARE REQUIRED FOR THE PROTECTION OF DISTURBED AREAS AND SOIL PILES, WHICH WILL REMAIN UN-WORKED FOR A PERIOD OF MORE THAN 14-CONSECUTIVE CALENDAR DAYS. THESE MEASURES SHALL REMAIN IN PLACE UNTIL SITE HAS STABILIZED. SITE DE-WATERING; WATER PUMPED FROM THE SITE SHALL BE TREATED BY TEMPORARY SEDIMENTATION BASINS OR OTHER APPROPRIATE CONTROL MEASURES. SEDIMENTATION BASINS SHALL HAVE A DEPTH OF AT LEAST 3 FEET, BE SURROUNDED BY SNOWFENCE OR EQUIVALENT BARRIER AND HAVE SUFFICIENT SURRACE AREA TO PROVIDE A SURFACE SETTLING RATE OF NO MORE THAN 750 GALLONS PER SQUARE FOOT PER DAY AT THE HIGHEST DEWATERING PUMPING RATE. WATER MAY NOT BE DISCHARCED IN A MANNER THAT CAUSES EROSION OF THE SITE, A NEICHBORNE SITE, OR THE BED OR BANKS OF THE RECEIVING WATER. POLYMERS MAY BE USED AS DIRECTED BY DNR TECHNICAL STANDARD 1061 (DE-WATERING). PUMPING OF WATER FROM FOUNDATION AREA DURING CONSTRUCTION SHALL NOT EXCEED A RATE OF 70 GALLONS PER WINUTE. SUMP PUMP SHALL BE PLACED ON A CLEAR STONE BEDDING AND A CLOTH/MESH SOCK SHALL BE PLACED ON THE OUTLET END OF THE PIPE TO CONTROL SEDIMENT LOSS. WASHED STONE WEEPERS OR TEMPORARY EARTH BERMS SHALL BE BUILT AS NECESSARY BY CONTRACTOR TO TRAP SEDIMENT OR SLOW THE VELOCITY OF STORM WATER. INLET FILTERS ARE TO BE PLACED IN STORMWATER INLET STRUCTURES AS SOON AS THEY ARE INSTALLED. ALL PROJECT A	REVISIONS REVISIONS	DATE REMARKS NO. DATE REMARKS	/06/13 CITY SUBMITTAL		
ALL AREAS WHICH ARE NOT PAVED SHALL RECEIVE A MINIMUM OF 4" TOPSOIL PRIOR TO SEEDING. SEED, FERTILIZER AND MULCH SHALL BE APPLIED WITHIN 7 DAYS AFTER FINAL GRADE HAS BEEN ESTABLISHED. IF DISTURBED AREAS WILL NOT BE RESTORED IMMEDIATELY AFTER ROUGH GRADING, TEMPORARY SEED SHALL BE PLACED. FOR THE FIRST SIX WEEKS AFTER RESTORATION (E.G. SEED & MULCH, EROSION MAT, SOD) OF A DISTURBED AREA, NCLUDE SUMMER WATERING PROVISIONS OF ALL NEWLY SEEDED AND MULCHED AREAS WHENEVER 7 DAYS ELAPSE WITHOUT A RAIN EVENT. EROSION MAT (TYPE I CLASS A PER WISCONSIN D.O.T. P.A.L.) SHALL BE INSTALLED ON ALL SLOPES 3:1 OR GREATER BUT LESS THAN 1:1. SOIL STABILIZERS SHALL BE APPLIED TO DISTURBED AREAS WITH SLOPES BETWEEN 10% AND 3:1 (DO NOT USE IN CHANNELS). SOIL STABILIZERS SHALL BE TYPE B, PER WISCONSIN D.O.T. P.A.L. (PRODUCT ACCEPTABILITY LIST), OR EQUAL. APPLY AT RATES AND METHODS SPECIFIED PER MANUFACTURER. SOIL STABILIZERS SHALL BE RE—APPLIED WHENEVER VEHICLES OR OTHER EQUIPMENT TRACK ON THE AREA. SILT FENCE TO BE USED ACROSS AREAS OF THE LOT THAT SLOPE TOWARDS A PUBLIC STREET OR WATERWAY. SEDIMENT SHALL BE CLEANED FROM CURB AND GUTTER AFTER EACH RAINFALL AND PRIOR TO PROJECT ACCEPTANCE. ALL CONSTRUCTION ENTRANCES SHALL HAVE TEMPORARY ROAD CLOSED SIGNS THAT WILL BE IN PLACE WHEN THE ENTRANCE IS NOT IN USE AND AT THE END OF EACH DAY. ANY PROPOSED CHANGES TO THE EROSION CONTROL PLAN MUST BE SUBMITTED AND APPROVED BY THE CITY OF MADISON. THE CITY OF MADISON, OWNER AND/OR ENGINEER MAY REQUIRE ADDITIONAL EROSION CONTROL MEASURES AT ANY TIME DURING CONSTRUCTION.	CH PRC SHE	ALE AS TE 10 AFTEF ECKE CJEC 1. CJEC 1. CJEC 1. CJEC 1. CJEC	- 31- 3 SHC - 31- 3028 T NO 3028 DF	-13 1 2	

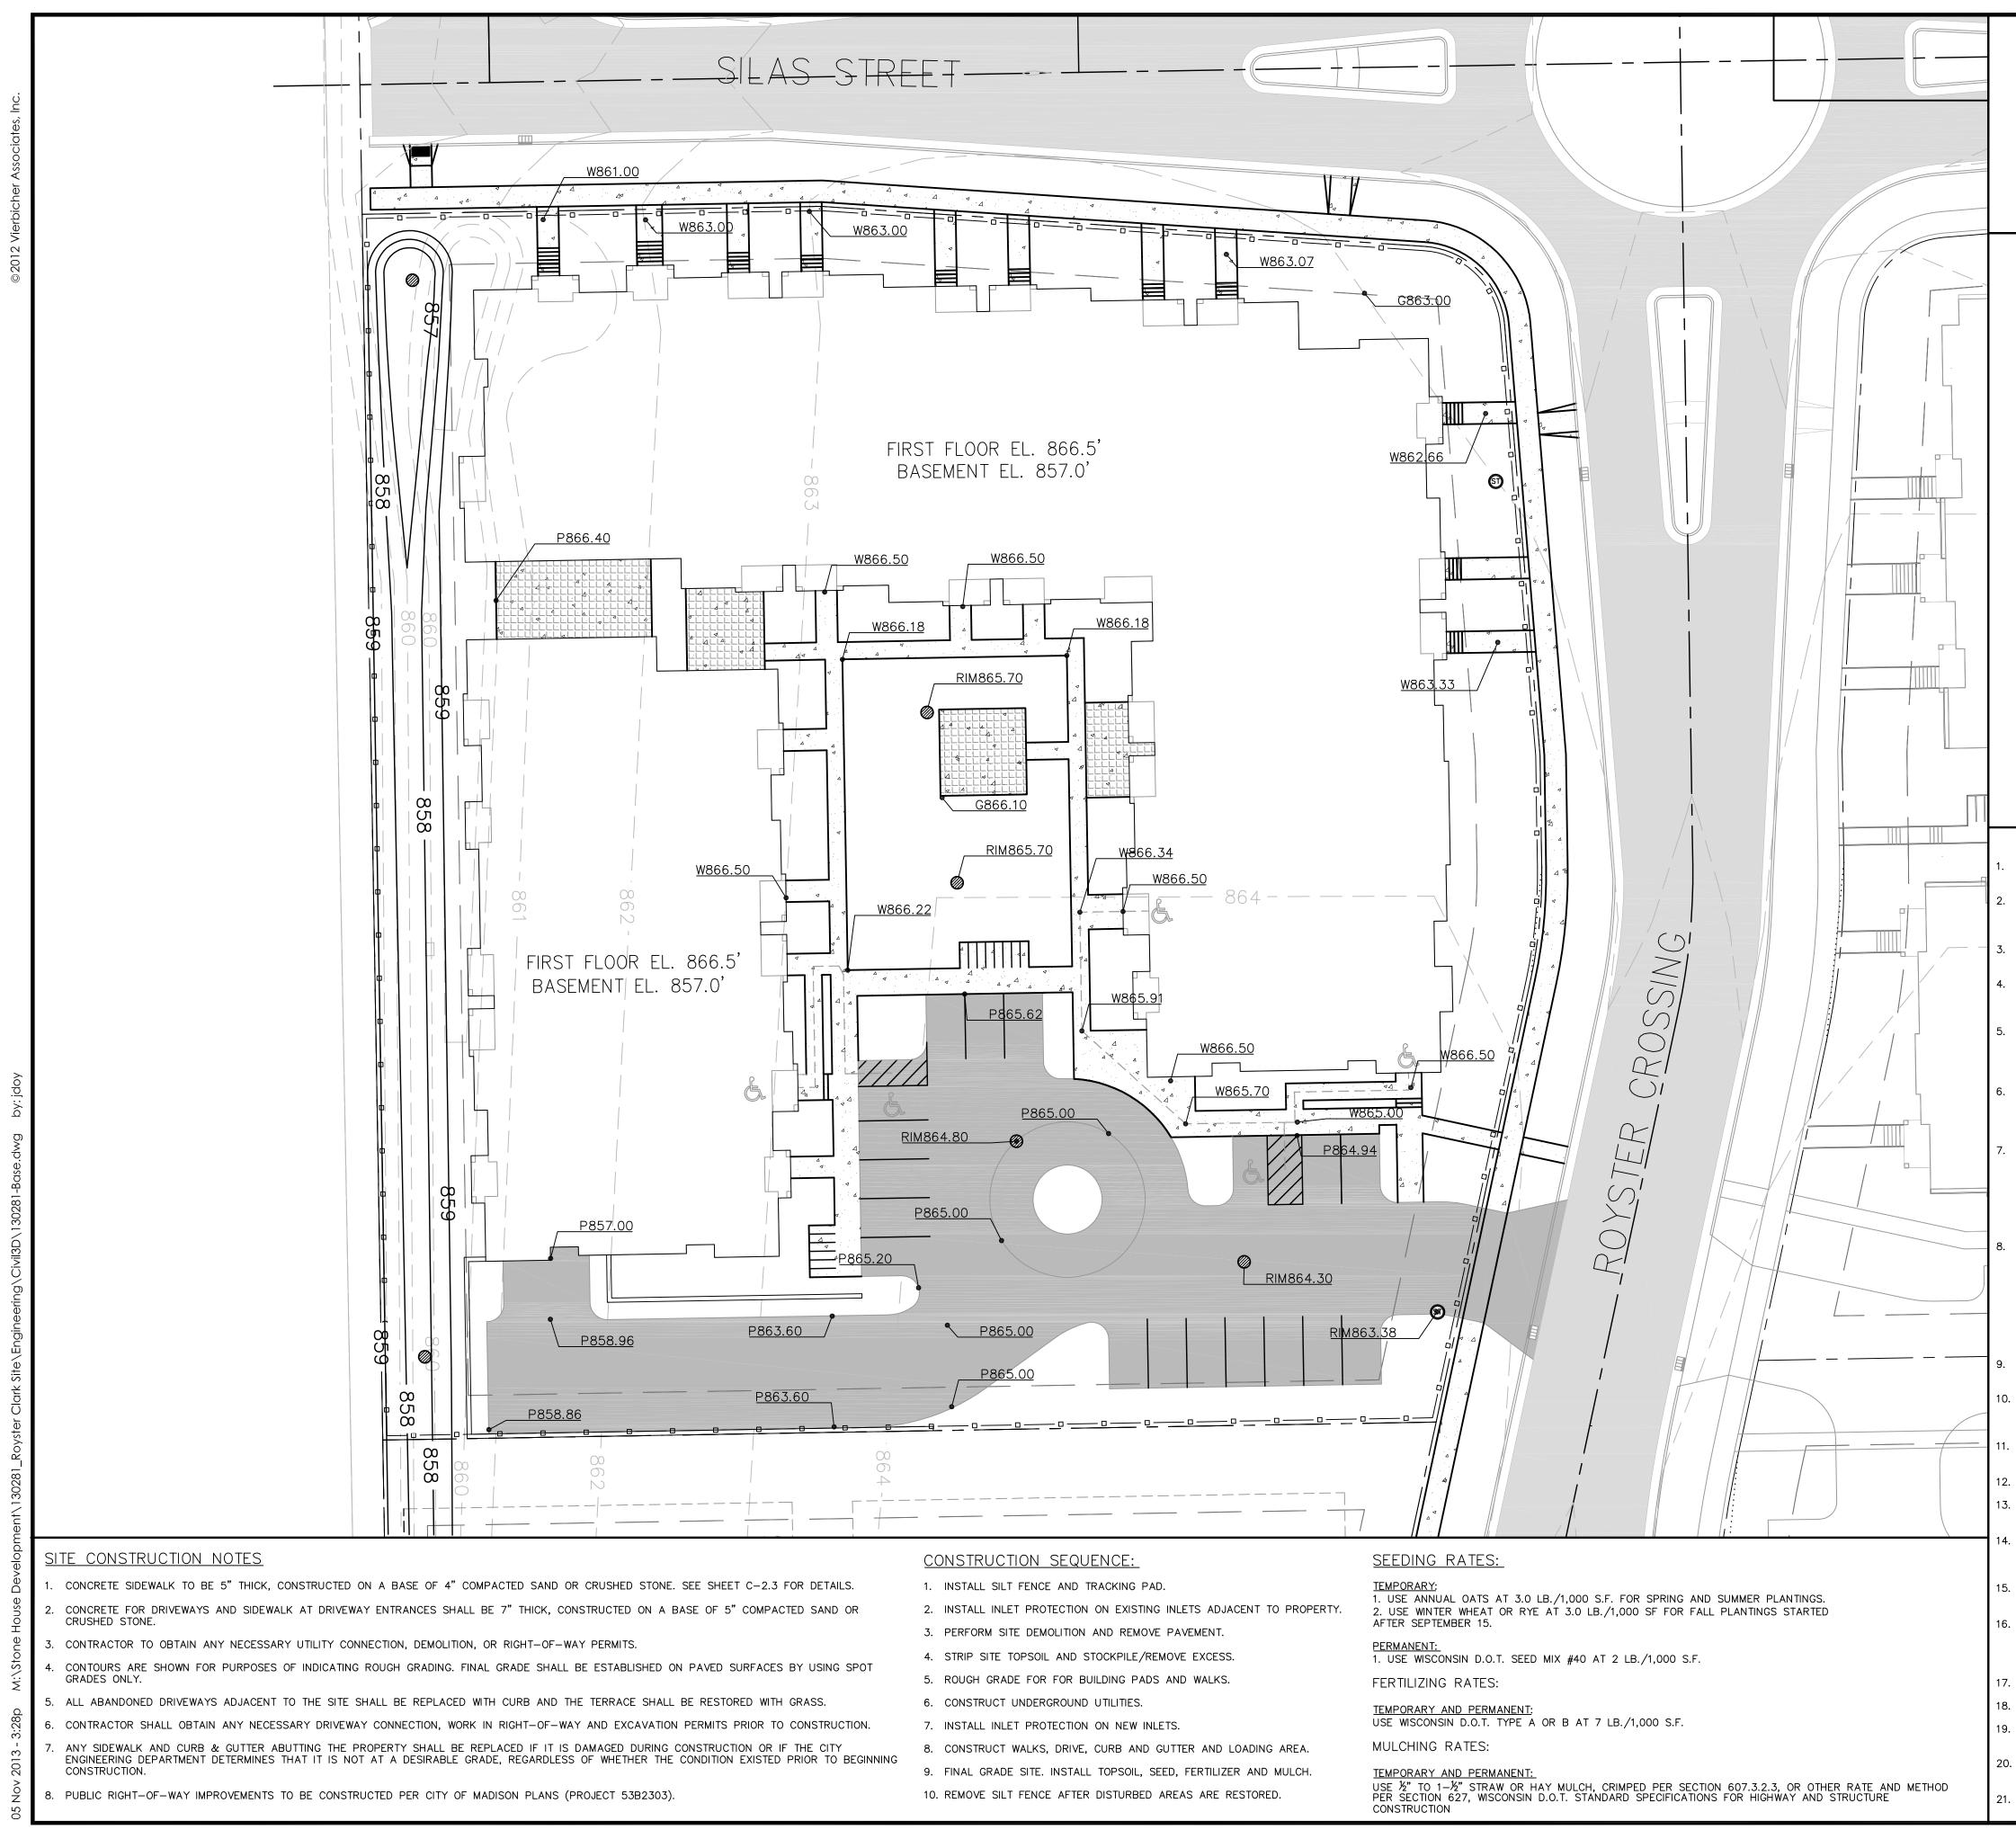


CALL DIGGER'S HOTLINE 1–800–242–8511 TOLL FREE TELEFAX: 1–800–338–3860 TDC (FOR HEARING IMPAIRED): 1–800–542–2289 WIS. STATUTE 182.0175 (1979) REQUIRES MINIMUM OF 3 WORKING DAYS NOTICE BEFORE YOU EXCAVATE.	RAPHIC SCALE FEET	s advisors MADISON - PRAIRE DU CHIEN 201 Madison, Wisconsin 53717 26-0532 Fax: (608) 826-0530
CONDITIONS LEGEND TING SANITARY MANHOLE TING FIRE HYDRANT TING WATER MAIN VALVE TING WATER MAIN VALVE TING CURB INLET TING STORM MANHOLE TING UNDERGROUND ELECTRIC LINE TING OVERHEAD GENERAL UTILITIES TING OVERHEAD GENERAL UTILITIES TING SANITARY SEWER LINE TING STORM SEWER LINE TING WATER MAIN TING ASPHALT PAVEMENT JNDARY	 UTILITY NOTES: PRIVATE WATER MAIN AND SERVICES SHALL BE DUCTILE IRON (AWWA C-151, CLASS 52) OR APPROVED EQUAL MATERIAL THAT CONFORMS TO COMM 84.30(4)(d). PRIVATE SANITARY SEWER AND LATERALS SHALL BE POLYVINYL CHLORIDE (PVC) ASTM D3034 - SDR 35 OR APPROVED EQUAL MATERIAL THAT CONFORMS TO COMM 84.30(2)(c). A MEANS TO LOCATE BURIED UNDERGROUND EXTERIOR NON METALLIC SEWERS/MAINS AND WATER SERVICES/MAINS MUST BE PROVIDED WITH TRACER WIRE OR OTHER METHODS IN ORDER TO BE LOCATED PER COMM 82.10(11)(h) AND COMM 82.40(8)(k). EXTERIOR WATER SUPPLY PIPING SETBACKS AND CROSSINGS SHALL BE IN ACCORDANCE WITH COMM 82.40(8)(b.). NO PERSON MAY ENGAGE IN WORK AT PLUMBING IN THE STATE UNLESS LICENSED TO DO SO BY THE DEPARTMENT OF COMMERCE PER S.145.06. SITE CONTRACTOR SHALL LEAVE SANITARY AND WATER LATERALS FIVE (5) FEET SHORT (HORIZONTALLY) FROM THE BUILDING. BUILDING PLUMBER SHALL VERIFY SIZE AND EXACT LOCATION OF PROPOSED SANITARY AND WATER LATERALS. CONTRACTOR SHALL FIELD VERIFY THE SIZE, TYPE, LOCATION, AND ELEVATION OF EXISTING UTILITIES PRIOR TO INSTALLING ANY ON-SITE UTILITIES OR STRUCTURES. CONTACT ENGINEER PRIOR TO INSTALLATION IF DISCREPANCY EXISTS WITHIN THESE 	Vierbich Planners engineers o REEDSBURG - MA 999 Fourier Drive, Suite 201 Phone: (608) 826-05
LEGEND PIPE ER PIPE (GRAVITY) LE BASIN/FIELD INLET IMENT /EMENT	 PLANS. 8. PROPOSED UTILITY SERVICE LINES AS SHOWN ARE APPROXIMATE. COORDINATE THE EXACT LOCATIONS WITH THE PLUMBING DRAWINGS. COORDINATE THE LOCATIONS WITH THE PLUMBING CONTRACTOR AND/OR OWNER'S CONSTRUCTION REPRESENTATIVE PRIOR TO INSTALLATION OF ANY NEW UTILITIES. 9. CONTRACTOR SHALL BE RESPONSIBLE FOR COORDINATING THE RELOCATION OF ANY UTILITIES ENCOUNTERED AND REPLACEMENT OF ANY UTILITIES DAMAGED WITHIN INFLUENCE ZONE OF NEW CONSTRUCTION. CONTACT ENGINEER IF THE EXISTING UTILITIES VARY APPRECIABLY FROM THE PLANS. 10. ALL WATER MAIN AND SERVICES SHALL BE INSTALLED AT A MINIMUM DEPTH OF 6.5' FROM TOP OF FINISHED GROUND ELEVATION TO TOP OF MAIN. 11. CLEAN OUT ALL EXISTING AND PROPOSED STORM INLETS AND CATCH BASINS AT THE COMPLETION OF CONSTRUCTION. 12. EXISTING WATER AND SANITARY LATERALS MUST BE PROPERLY ABANDONED PER CITY REQUIREMENTS. 13. CONTRACTOR SHALL OBTAIN ANY NECESSARY WORK IN RIGHT-OF WAY, EXCAVATION, UTILITY CONNECTION, PLUGGING, ABANDONMENT, AND DRIVEWAY CONNECTION PERMITS PRIOR TO CONSTRUCTION. 14. THE DEVELOPER SHALL INSTALL THE 3M ™ ELECTRONIC MARKER SYSTEM (EMS) 4" EXTENDED RANGE 5' BALL MARKERS-WASTEWATER (MODEL #1404-XR) FOR EACH SANITARY AND STORM SEWER LATERALS. THE CITY SHALL SUPPLY ALL THE REQUIRED MARKERS TO THE DEVELOPER OR ITS CONTRACTOR (GENERALLY REQUIRES 2 PER LATERAL) AND THE CONTRACTOR SHALL INSTALL THEM PER THE 	UTILITY PLAN Reyster crossing City of Madison Dane county, Wisconsin
INE	 MANUFACTURER'S REQUIREMENTS OR AS DIRECTED BY THE CITY ENGINEER. 15. ALL WORK IN THE PUBLIC RIGHT-OF-WAY SHALL BE PERFORMED BY A CITY-LICENSED CONTRACTOR. 16. PUBLIC RIGHT-OF-WAY IMPROVEMENTS TO BE CONSTRUCTED PER CITY OF MADISON PLANS (PROJECT 53B2364). 17. ALL DAMAGE TO THE PAVEMENT ON COTTAGE GROVE ROAD ADJACENT TO THIS DEVELOPMENT SHALL BE RESTORED IN ACCORDANCE WITH THE CITY'S PAVEMENT PATCHING CRITERIA. 18. CONTRACTOR SHALL REPLACE ALL SIDEWALK AND CURB AND GUTTER ABUITING THE PROPERTY, WHICH IS DAMAGED BY THE CONSTRUCTION, OR ANY SIDEWALK AND CURB AND CUTER THAT THE CITY ENGINEER DETERMINES NEEDS TO BE REPLACED BECAUSE IT IS NOT AT A DESIRABLE GRADE REGARDLESS OF WHETHER THE CONDITION EXISTED PRIOR TO BEGINNING CONSTRUCTION. 	SUCISINAL SUCISINAL

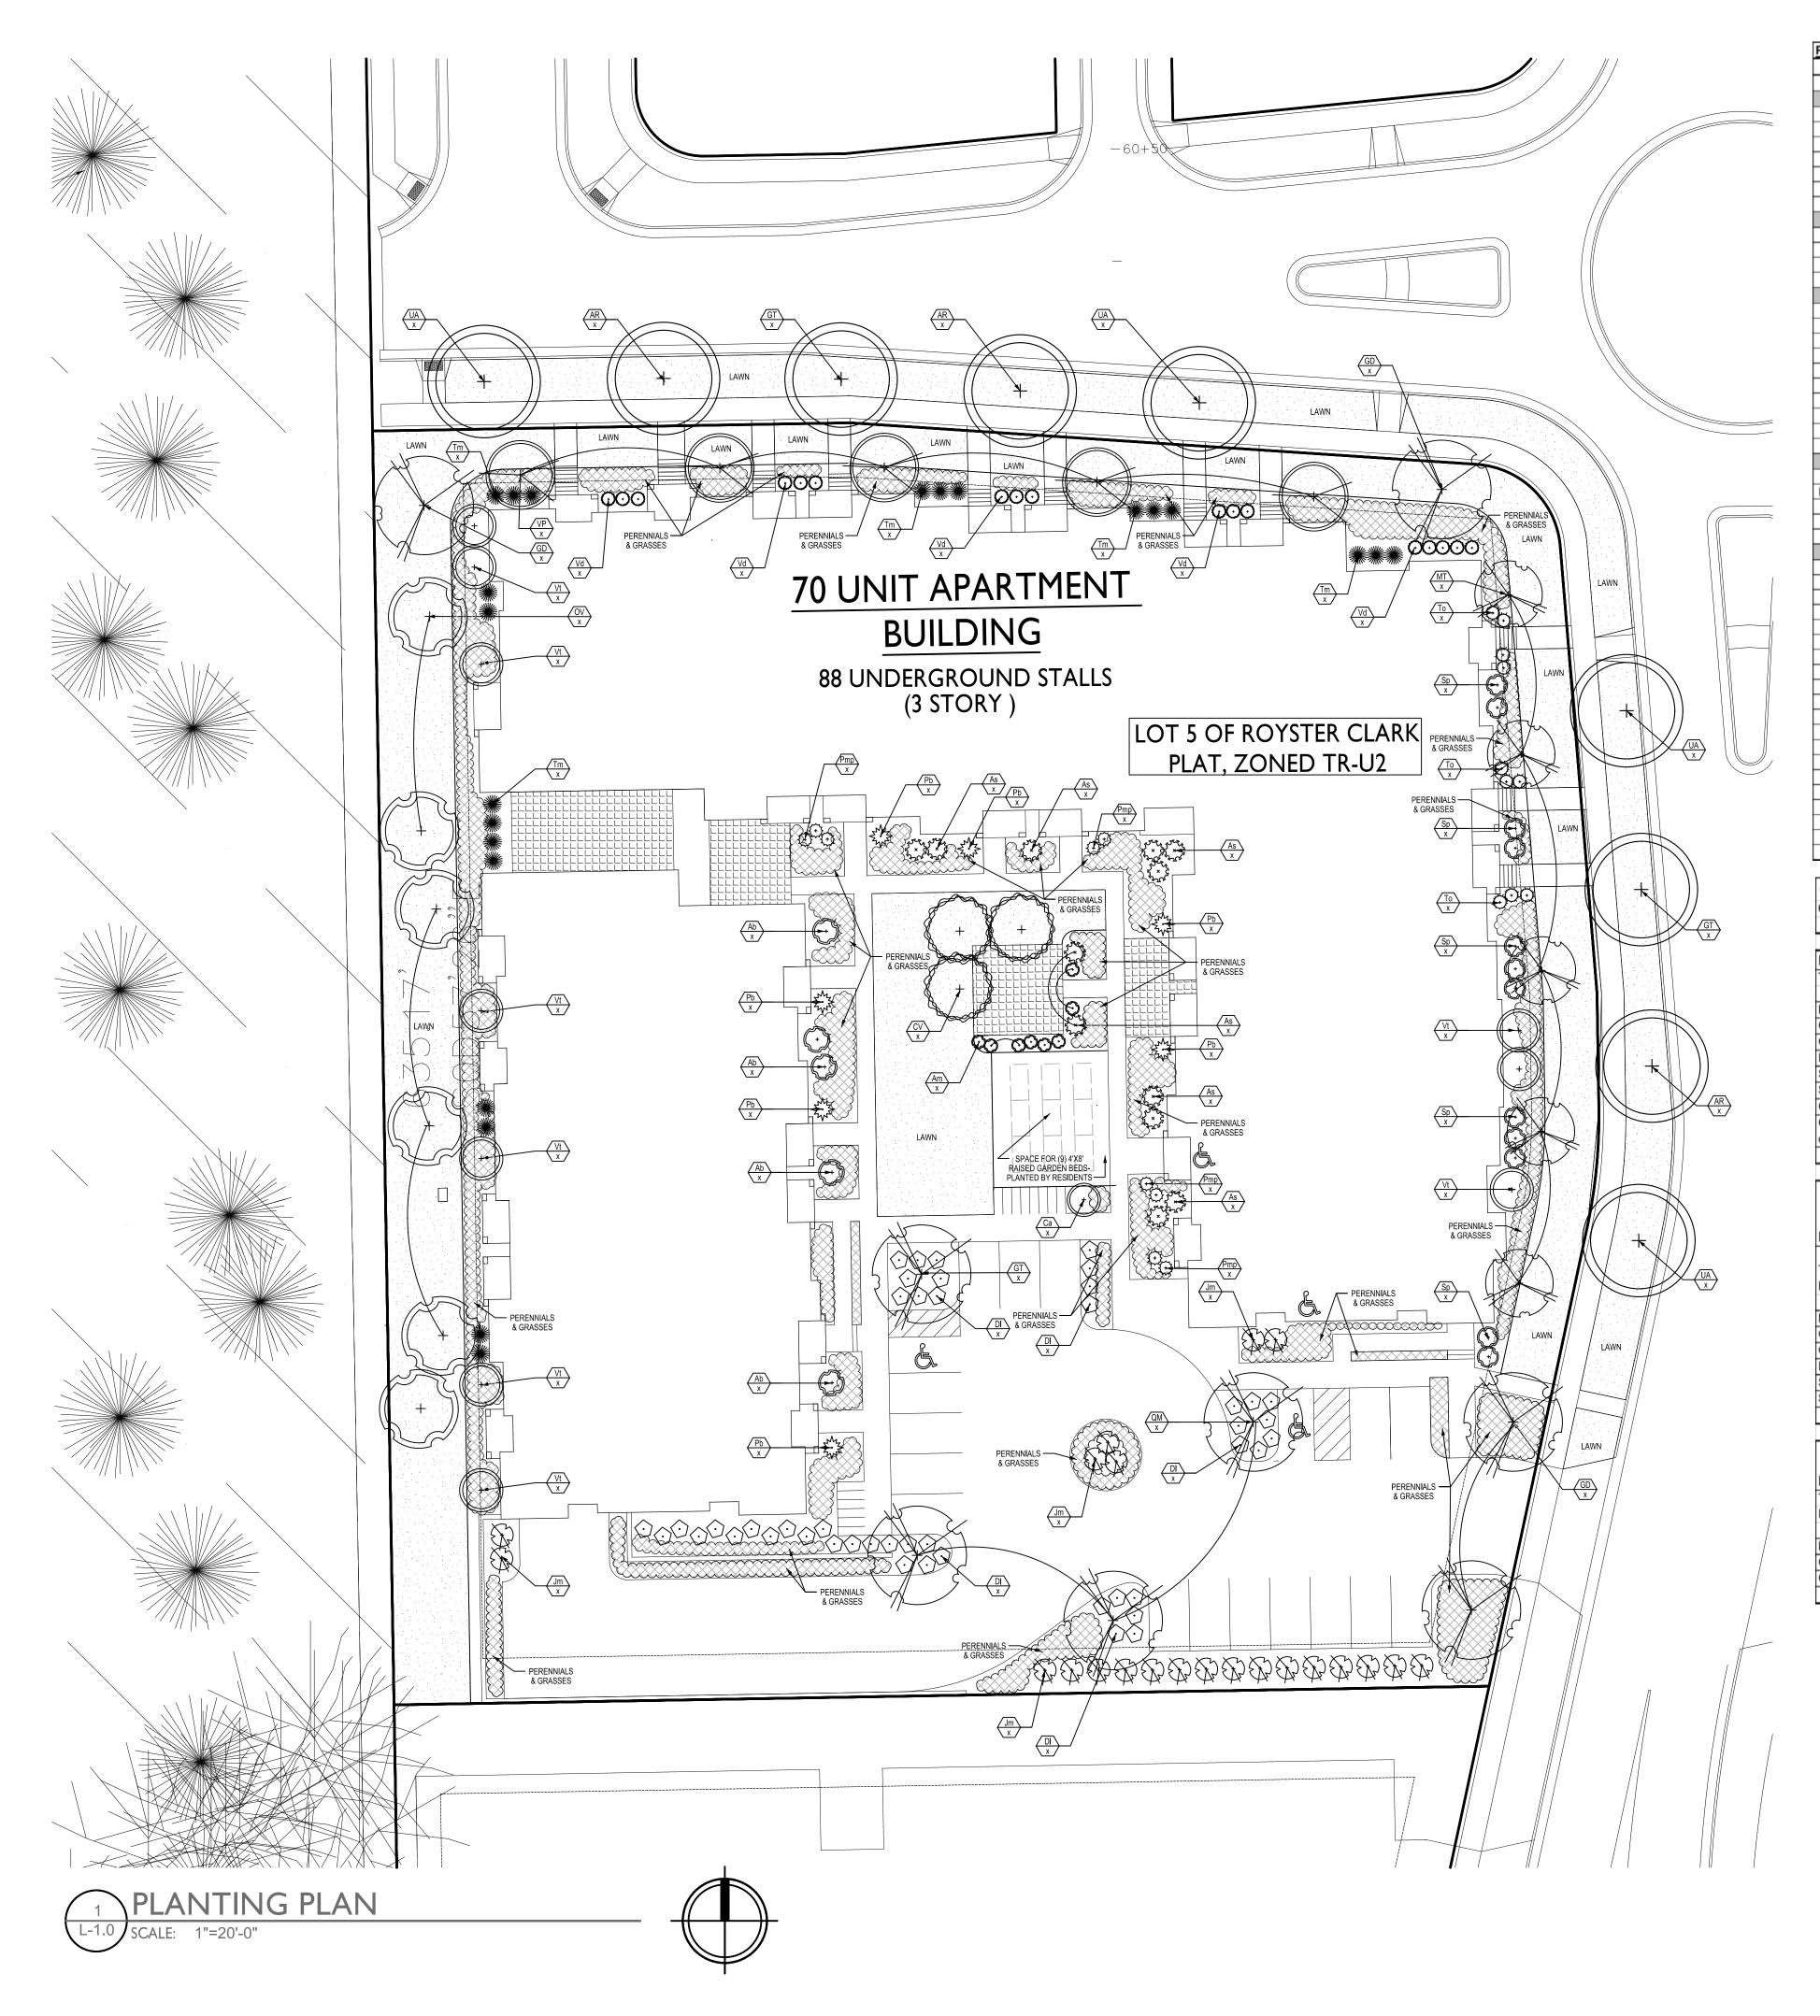

Plant	List					
	Botanical Name	Common Name	Quantity	Size	Spec	Comments
	Deciduous Trees					
AR	Acer freemanii 'Armstrong'	Armstrong Freeman Maple		2.5" cal.	B&B	
GD	Gymnocladus dioica 'Espresso'	Espresso Kentucky Coffee Tree		1 1/2" cal.	B&B	
GT	Gleditsia triacanthos var. inermis 'Skycole'	Skyline Honeylocust		1 1/4" cal.	B&B	
OV	Ostrya virginiana	Hophornbeam		1 1/4" cal.	B&B	
QM	Quercus muhlenbergii	Chinkapin Oak		2.5" cal.	B&B	
UA	Ulmus americana 'Princeton'	Princeton Elm		2" cal.	B&B	
A.C.	Ornamental Trees	Dahia Hill Apple Conjectory		01 64	D ° D	Multi eterre
	Amelanchier x grandiflora 'Robin Hill' Crataegus viridis 'Winter King'	Robin Hill Apple Serviceberry		8' ht. 6' ht.	B&B	Multi-stem
	Malus transitoria 'Schmidtcutleaf'	Winter King Hawthorn			B&B	
MT	Marus transitoria Schmidtcutiear	Golden Raindrops Crabapple		1 1/4" cal.	B&B	
	Deciduous Shrubs					
Ab	Aronia arbutifolia 'Brilliantissima'	Brilliant Aronia		18-24" ht.	cont.	
Am	Aronia melanocarpa 'Iroqois Beauty'	Irogois Beauty Aronia		18" Ht	cont.	space 3' on center
As	Amelanchier stonlonifera	Running Serviceberry		12" Ht.	cont.	
Ca	Corylus americana	American Filbert		24" Ht.	cont.	
DI	Diervilla lonicera 'Jewel'	Dwarfbush Honeysuckle		2 Gal.	cont.	
Sp	Salix purpurea 'Nana'	Arctic Blue Leaf Willow	<u> </u>	18" ht.	cont.	Space per plan; match specimen
Vd	Viburnum dentatum 'Synnestvedt'	Chicago Luster Arrowwood Vib.	+	2 - 3' ht.	cont.	opuce per plan, mater opcomen
Vt	Viburnum trilobum 'JN Select'	Redwing Viburnum		5 Gal.	cont.	
		riounny riounnan			oona	
	Evergreen Shrubs					
Pb	Pinus strobus 'Blue Shag'	Blue Shag Dwarf White Pine		24" Ht./#5	cont.	space per plan
	Pinus mugo 'Pumilo'	Dwarf Mugo Pine		12-15"	cont.	
Tm	Taxus x media 'Tauntonii'	Taunton Yew		24" Spd.	cont.	space 4' on center
То	Thuja occidentalis 'Little Gem'	Little Gem Arborvitae		2' ht.	cont.	Space per plan; match specimen
	Paran niala/Craca a /Cracun da avara					
_	Perennials/Grasses/Groundcovers Andropogon gerardii	Big Bluestem	_	#1	Cont.	
	Bouteloua curtipendula	Sideoats Gramma	+	#1		
	Elymus canadensis	Canada Wild Rye	+	#1	Cont. Cont.	
	Panicum virgatum 'Shenandoah'	Switch Grass	+	4.5"	Cont.	
	Panicum virgatum 'Cloud Nine'	Switch Grass		4.5	Cont.	
	Schizachyrium scoparium	Little Bluestem		4.5 1 gal.	Cont.	
	Sorgastrum nutans 'Sioux Blue'	Blue Indiangrass		4.5"	Cont.	
	Sporobolus heterolepis	Prairie Dropseed		4.5 1 gal.	Cont.	
	Aruncus aethusifolius	Dwarf Goatsbeard		#1	Cont.	
	Baptisia australis var. minor	Dwarf blue Indigo	+	#1	Cont.	
	Geum triflorum	Prairie Smoke		4.5"	Cont.	
	Elymus canadensis	Canada Wild Rye		#1	Cont.	
	Eryngium yuccifolium	Rattelsnake Master		#1	Cont.	
	Geranium maculatum	Wild geranium		#1	Cont.	
	Iris versicolor	Blue Flag		#1	Cont.	
	Solidago 'Fireworks'	Goldenrod		#1	Cont.	
	Liastris aspera	Button blazing Star		#1	Cont.	
	Tiarella cordifolia	Heartleaved Foamflower		#1	Cont.	
	Osmunda cinnamomea	Cinnamon Fern		4.5", gal.	Cont.	
	Penstemon digitalis 'Husker Red'	onnanon ren		- 1 .5 , yai.	Cont.	

City of Madison, WI Landscape Worksheet 6-Nov-13

Developed Lot	SF	Landscape Units Req.	Landscape Points Req.
Total Developed Area	18,630	62	311
Element	Point Value	Quantity	Total Points
Overstory Deciduous Tree	35	6	210
Ornamental Tree	15	0	0
Evergreen Tree	15	0	0
Shrub, deciduous	2	59	118
Shrub, evergreen	3	38	114
Ornamental Grass	2	0	0
Ornamental/Decorative Fence			
or Wall (4 pts/10 LF)	4	0	0
			442
		Overstory Tree Req	
		(or x2 for	
		Orn./Evergreen	
Development Frontage	LF	Tree Sub.)	Shrubs Req.
Total LF of Street Frontage			
Between Bldg./Parking & street	532	18	89
Element	Point Value	Quantity	
Overstory Deciduous Tree	35	13	455
Ornamental Tree	15	10	150
Evergreen Tree	15	0	0
Shrub, deciduous	2	32	64
Shrub, evergreen	3	22	66
		Overstory Tree Req	
		(or x2 for Orn. Tree	
Interior Parking Lots	SF	Sub.)	
Total Parking Lot Area	8,026		
Req. Parking Lot Islands (5%)	401	3	
Element	Point Value	-	
Overstory Deciduous Tree	35	5	
Ornamental Tree	15	0	

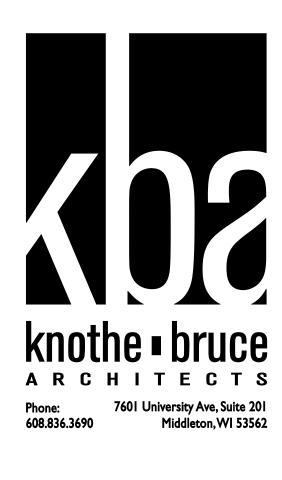

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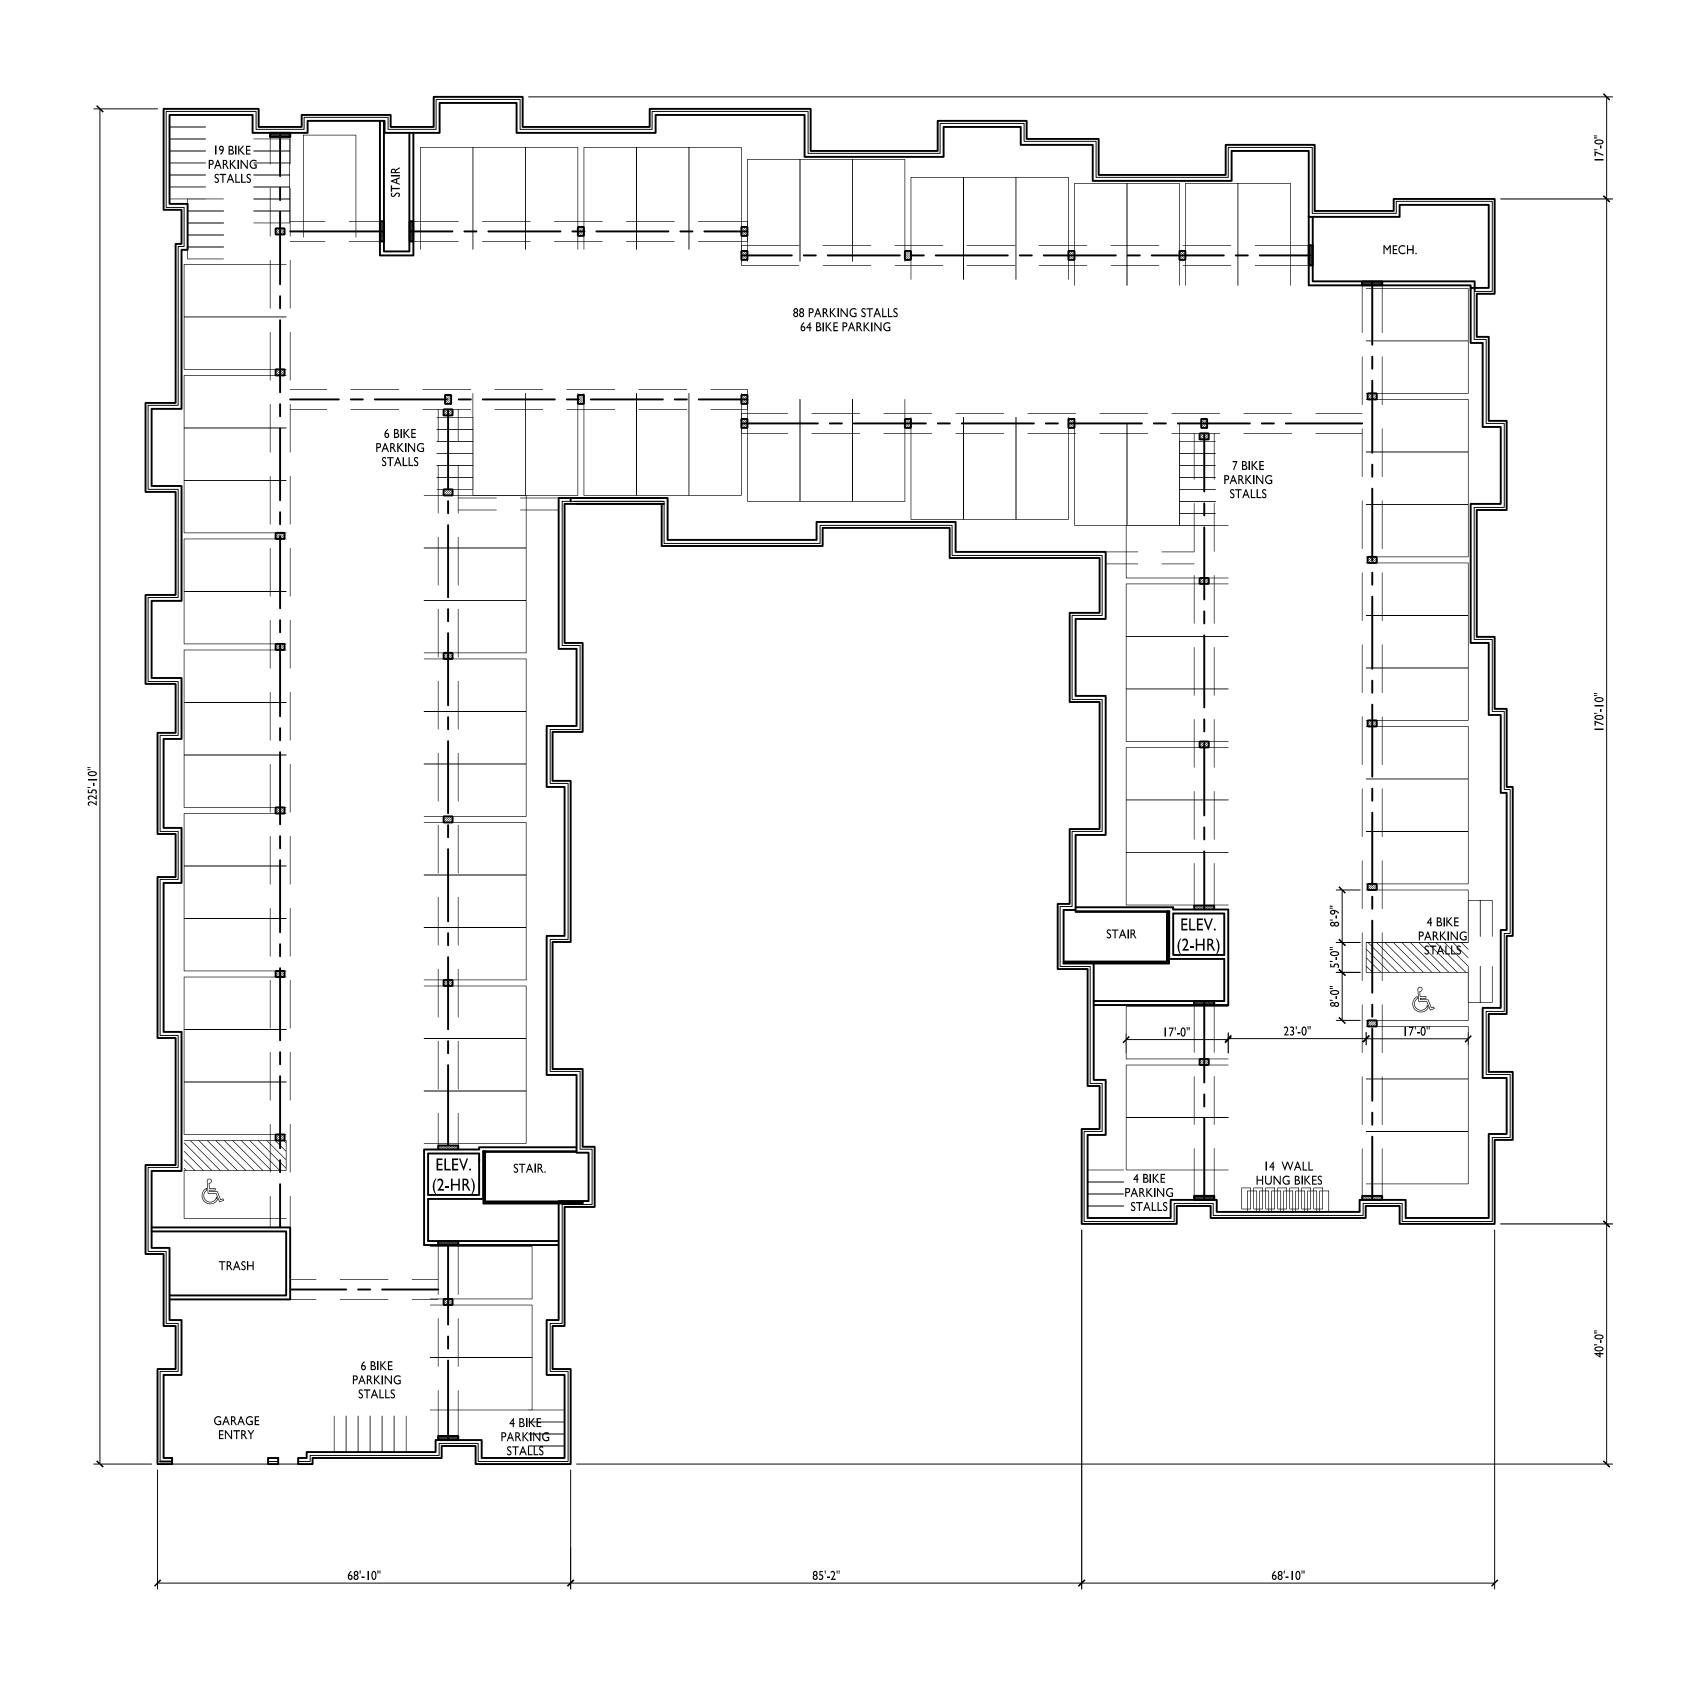
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PROJECT TITLE ROYSTER CROSSINGS LOT 2, 3 AND 5

SHEET TITLE LANDSCAPE PLAN


SHEET NUMBER

L-1.0





A-1.0 SCALE: 1/16"=1'-0"

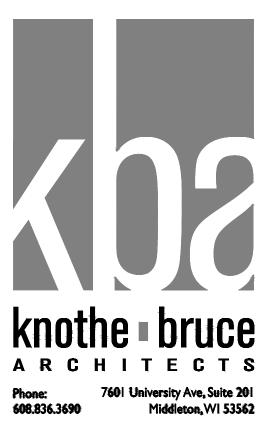

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PROJECT TITLE ROYSTER CROSSINGS LOT 5

SHEET TITLE BASEMENT PLAN

A-1.0



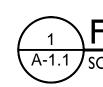


 Image: https://www.scale.com/



CONSULTANT


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PROJECT TITLE ROYSTER CROSSINGS LOT 5


SHEET TITLE FIRST FLOOR PLAN


A-1.1



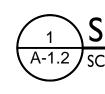

1 SECOND FLOOR PLAN A-1.2 SCALE: 1/16"=1'-0"

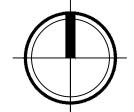

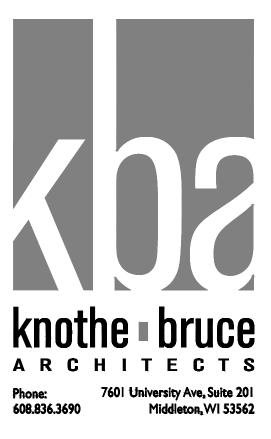

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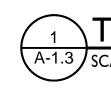
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PROJECT TITLE ROYSTER CROSSINGS LOT 5


SHEET TITLE SECOND FLOOR PLAN


A-1.2





1 A-1.3 SCALE: 1/16"=1'-0"

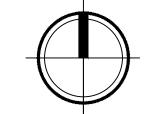

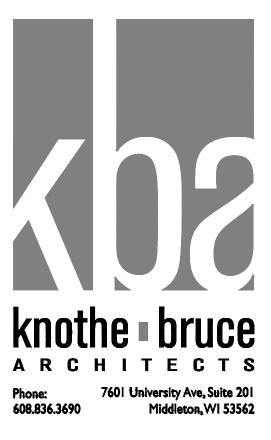

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PROJECT TITLE ROYSTER CROSSINGS LOT 5

SHEET TITLE THIRD FLOOR PLAN


A-1.3










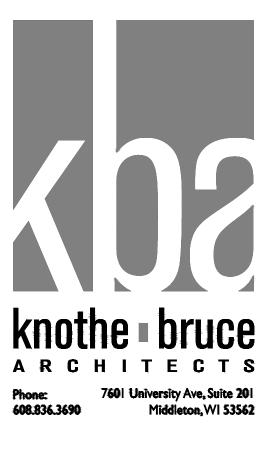

CONSULTANT

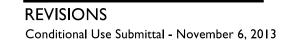

PROJECT TITLE ROYSTER CROSSINGS LOT 5

SHEET TITLE ELEVATIONS

A-2.1











REVISIONS Conditional Use Submittal - November 6, 2013

A-2.2