
UTILITY PLAN ELECTRICAL PLAN

CITY OF MADISON

CITY ENGINEERING DIVISION DEPARTMENT OF PUBLIC WORKS PLAN OF PROPOSED IMPROVEMENTS

518–542 JUNCTION ROAD

CITY PROJECT NO. 10836 CITY CONTRACT NO. 7583

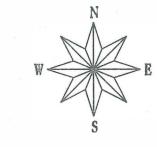

PUBLIC IMPROVEMENT PROJECT APPROVED


JANUARY 5, 2016


BY THE COMMON COUNCIL OF MADISON, WISCONSIN

PUBLIC IMPROVEMENT DESIGN APPROVED BY:






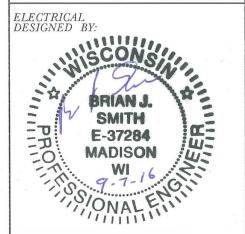

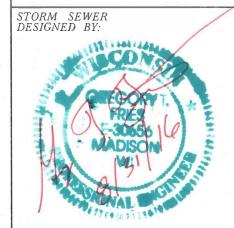

PROJECT LIMITS

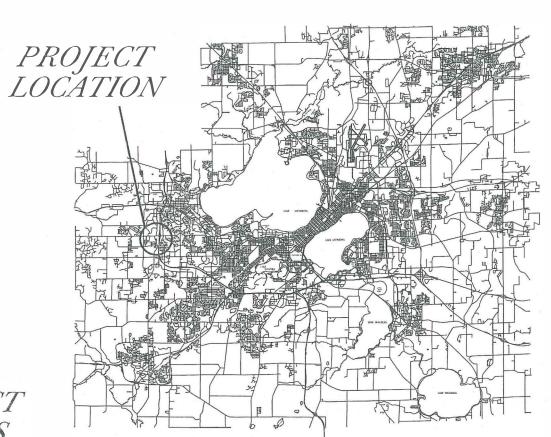

THE LOCATION AND INFORMATION FOR PROPOSED NEW TREES, IN THE PUBLIC RIGHT OF WAY OR ON PUBLIC LANDS ARE APPROXIMATE AND ARE SHOWN FOR REFERENCE ONLY. THE LOCATIONS, SPECIFICATIONS AND PLANTING METHODS OF ALL PROPOSED NEW OR REPLACEMENT TREES IN THE PUBLIC RIGHT OF WAY OR ON PUBLIC IANDS SHALL BE APPROVED BY THE CITY FORESTER PRIOR TO INSTALLATION.

NO TREES IN THE RIGHT OF WAY OR ON PUBLIC LANDS SHALL BE TRIMMED, PRUNED, REMOVED OR ADVERSELY AFFECTED IN ANY WAY UNTIL THE DEVELOPER HAS RECEIVED WRITTEN PERMISSION FROM THE CITY ENGINEER OR CITY FORESTER. SAID WRITTEN PERMISSION SHALL INCLUDE LANGUAGE INDICATING THAT SECTION 10.101 OF THE MADISON GENERAL ORDINANCES AND ADMINISTRATIVE PROCEDURE MEMORANDUM NO. 6-2, REFERING TO NOTIFICATION OF PROPERTY OCCUPANTS ANDWOR OWNERS, HAS BEEN COMPLIED WITH.

ALL GUTTERS SHALL DRAIN WITH A MINIMUM GRADES OF 0.5% TOWARD STORM SEWER INLETS.

ALL DITCHES SHALL DRAIN WITH A MINIMUM GRADES OF 0.5%

THE CROSS SLOPE OF SIDEWALKS AND BARRIER FREE SIDEWALK CURB
RAMPS SHALL BE 1.5%. THE LONGITUDINAL GRADE OF BARRIER
FREE SIDEWALK CURB RAMPS SHALL NOT EXCEED 8.33%. ALL SIDEWALK
RAMPS SHALL BE CONSTRUCTED ACCORDING TO S.D.D. 3.03. AT ALL
OTHER LOCATIONS THE LONGITUDINAL GRADE OF SIDEWALKS SHALL
NOT EXCEED 5.0 % OR THE ADJACENT STREET GRADE WHICHEVER
IS GREATER NOR BE LESS THAN 0.5% AND SHALL DRAIN TOWARD
STORM SEWER INLETS. SIDE SLOPES WITHIN TEN FEET OF A PUBLIC
SIDEWALK SHALL NOT EXCEED 4.00:1. ALL SIDEWALK AND SIDEWALK RAMP
ELEVATIONS AND GRADES SHALL BE FIELD VERIFIED AND SET TO COMPLY WITH
THE CITY OF MADISON STANDARD SPECIFICATIONS AND THE A.D.A. GUIDELINES.

OBTAIN A PRINT OUT OF THE ALIGNMENT FROM THE CITY ENGINEER PRIOR TO STAKING THIS PROJECT.

CURB STATION AND OFFSETS SHALL BE TO THE FACE OF CURB UNLESS OTHERWISE INDICATED. CURB ELEVATIONS SHALL BE TO THE TOP OF CURB (OR EXTENDED TOP OF CURB FOR DRIVEWAYS OR RAMPS) UNLESS OTHERWISE INDICATED.

POWER POLES AND OTHER OBSTRUCTIONS SHALL BE MOVED TO PROVIDE 2 FEET MINIMUM OF CLEAR DISTANCE FROM ANY FACE OF CURB OR EDGE OF SIDEWALK.

ANY INFORMATION SHOWN ON THIS PLAN, WHICH IS NOT PART OF THIS PROJECT, IS PRELIMINARY AND NOT FOR CONSTRUCTION.

THERE MAY BE EXISTING UTILITIES OR OTHER FEATURES WHICH ARE EITHER NOT SHOWN OR SHOWN INCORRECTLY ON THIS PLAN. IT IS THE RESPONSIBILITY OF THE DEVELOPER TO LOCATE AND IDENTIFY ALL UTILITIES AND TOPOGRAPHY WHICH MAY AFFECT THE CONSTRUCTION OF THESE IMPROVEMENTS.

ALL PERMANENT SIGNING AND POSTING WILL BE DETERMINED AND PROVIDED BY THE TRAFFIC ENGINEERING DIVISION, FOLLOWING CONSTRUCTION OF THESE IMPROVEMENTS.

THE DEVELOPER SHALL PROVIDE, INSTALL AND MAINTAIN ALL STREET END BARRICADES, SIGNING AND TRAFFIC CONTROL, AS REQUIRED BY THE CITY TRAFFIC ENGINEER.

PAVEMENT SAWCUTS SHALL BE AS DIRECTED BY THE CITY CONSTRUCTION ENGINEER. SAWCUTS SHOWN ON THE PLAN ARE APPROXIMATE.

DEVELOPER SHALL COORDINATE WITH ALL PRIVATE UTILITY COMPANIES REGARDING ANY RELOCATIONS OR ADJUSTMENTS NECESSARY FOR CONSTRUCTION OF PUBLIC IMPROVEMENTS.

518 - 542 JUNCTION ROAD PROJECT NO. 10836 SHEET NO. D-1

DETAIL

STANDARD NOTES AND COMMENTS

CITY OF MADISON

PLO

EV. DATE:


AADISON, STREETS DIVISION

518-542 JUNCTION ROAD SHEET NO. PROJECT NO. 10836 D-2

DETAIL


CITY OF MADISON

TYPICAL SECTIONS

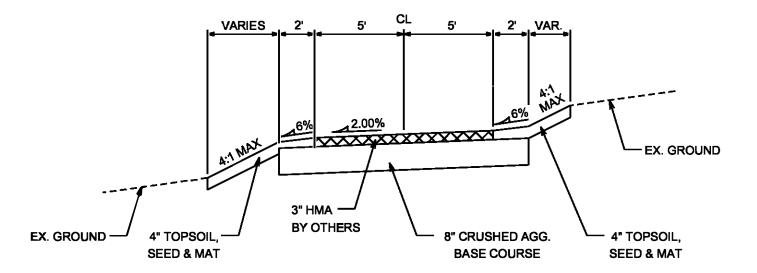

TYPICAL SECTION

PATH FROM STA 10+50 TO STA 11+44.50 STA 14+20 TO STA 16+30

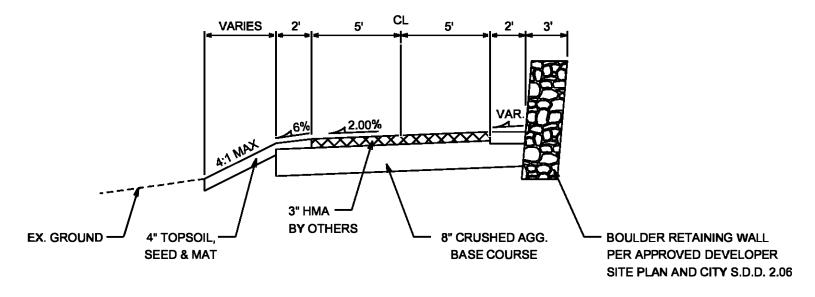

NOTES


1. HMA PAVEMENT CONSTRUCTED AS FOLLOWS (BY OTHERS):


TYPE	LAYER	THICK	NOM. AGG SIZE
4 LT 8-28 S	SINGLE	3.0"	12.5 MM


TYPICAL SECTION
PATH FROM STA 11+44.50 TO STA 14+20


FILE NAME: M:\DESIGN\Projects\10836\Streets\Design\10836EN_Typical Section.dgn

DATE: 9/2/2016

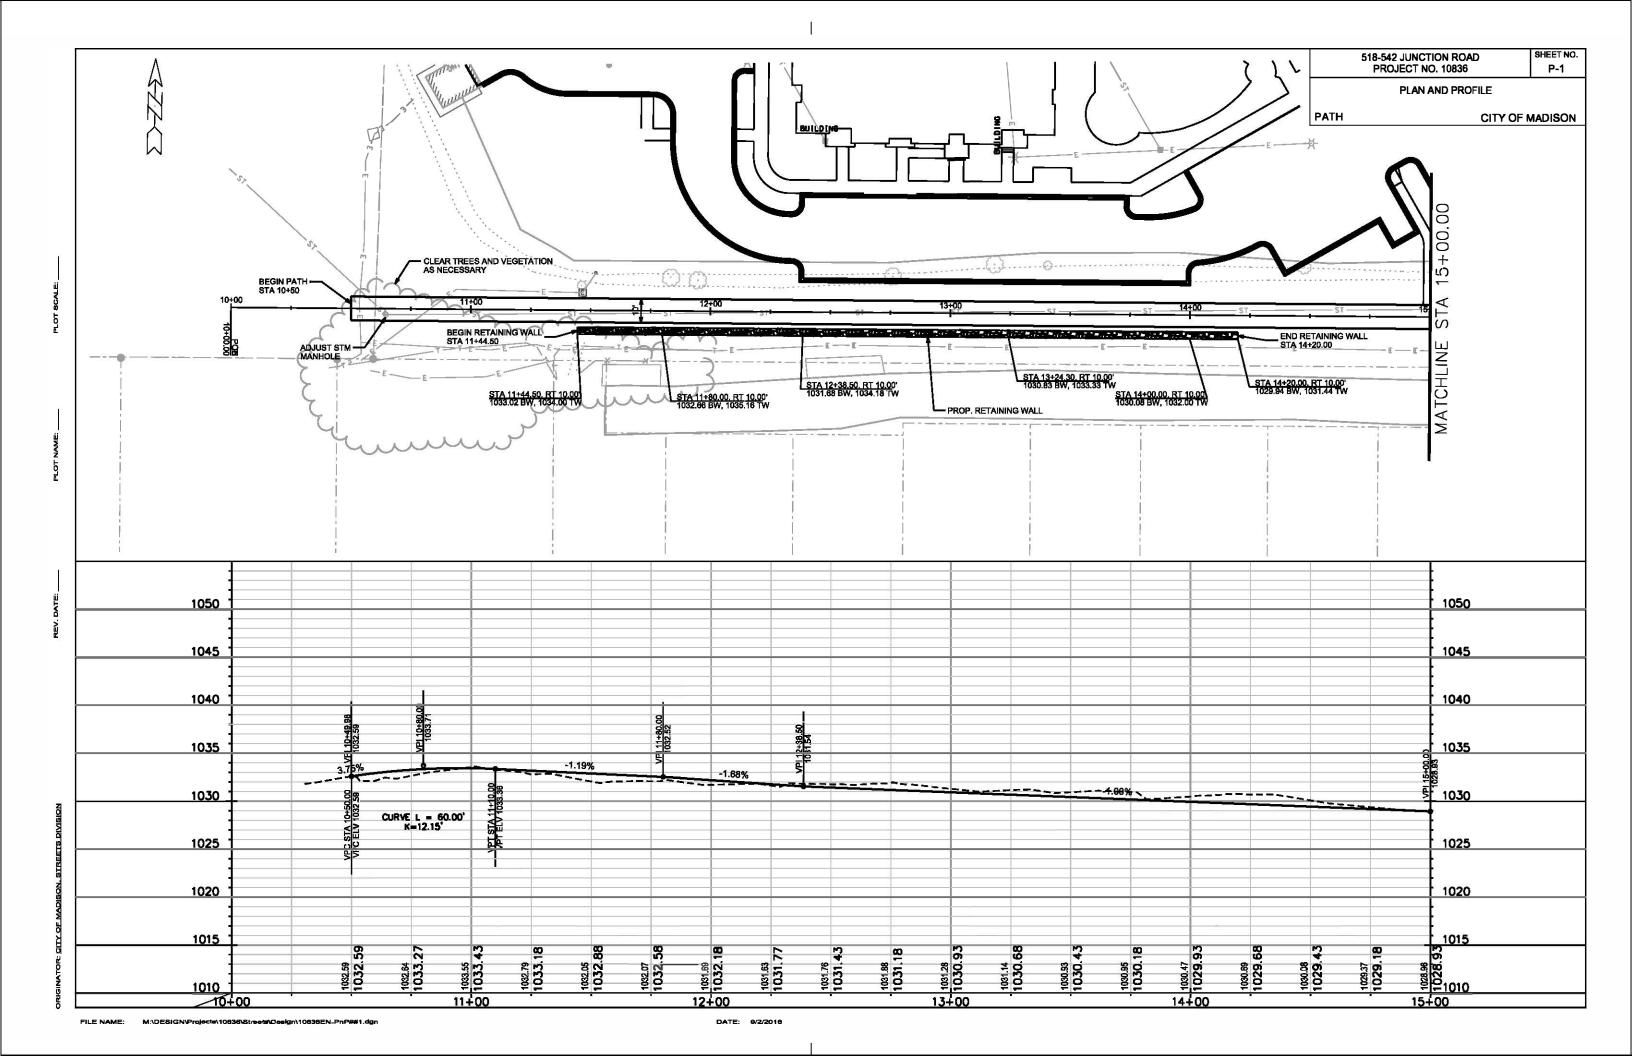

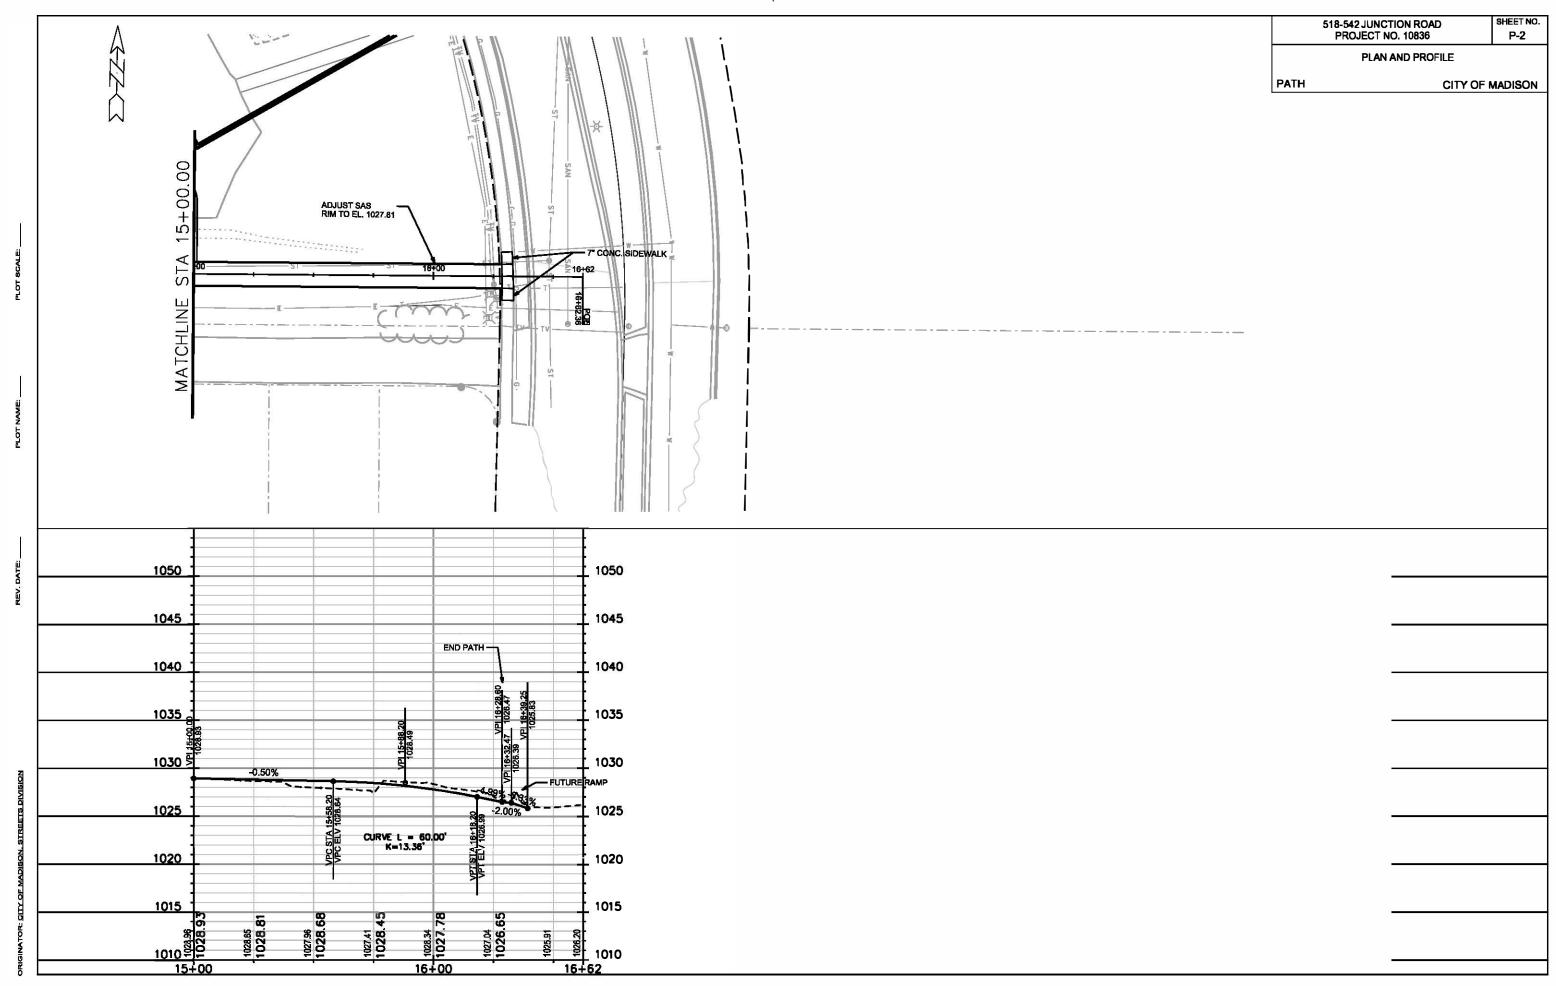

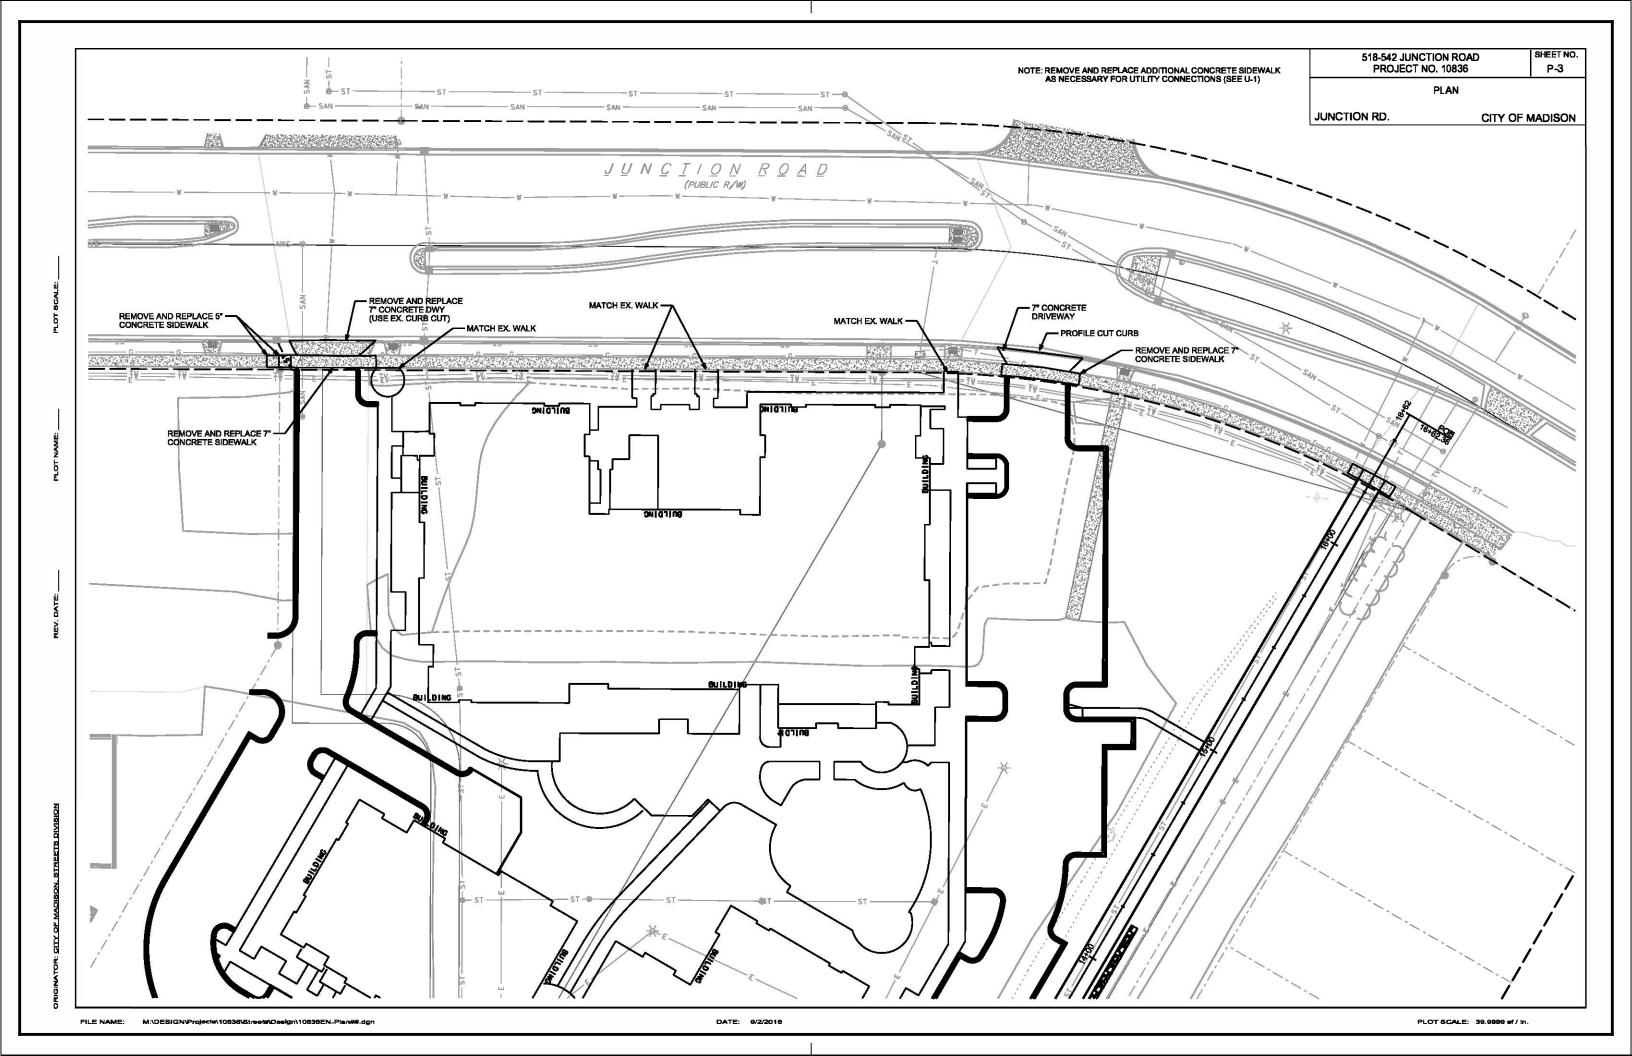

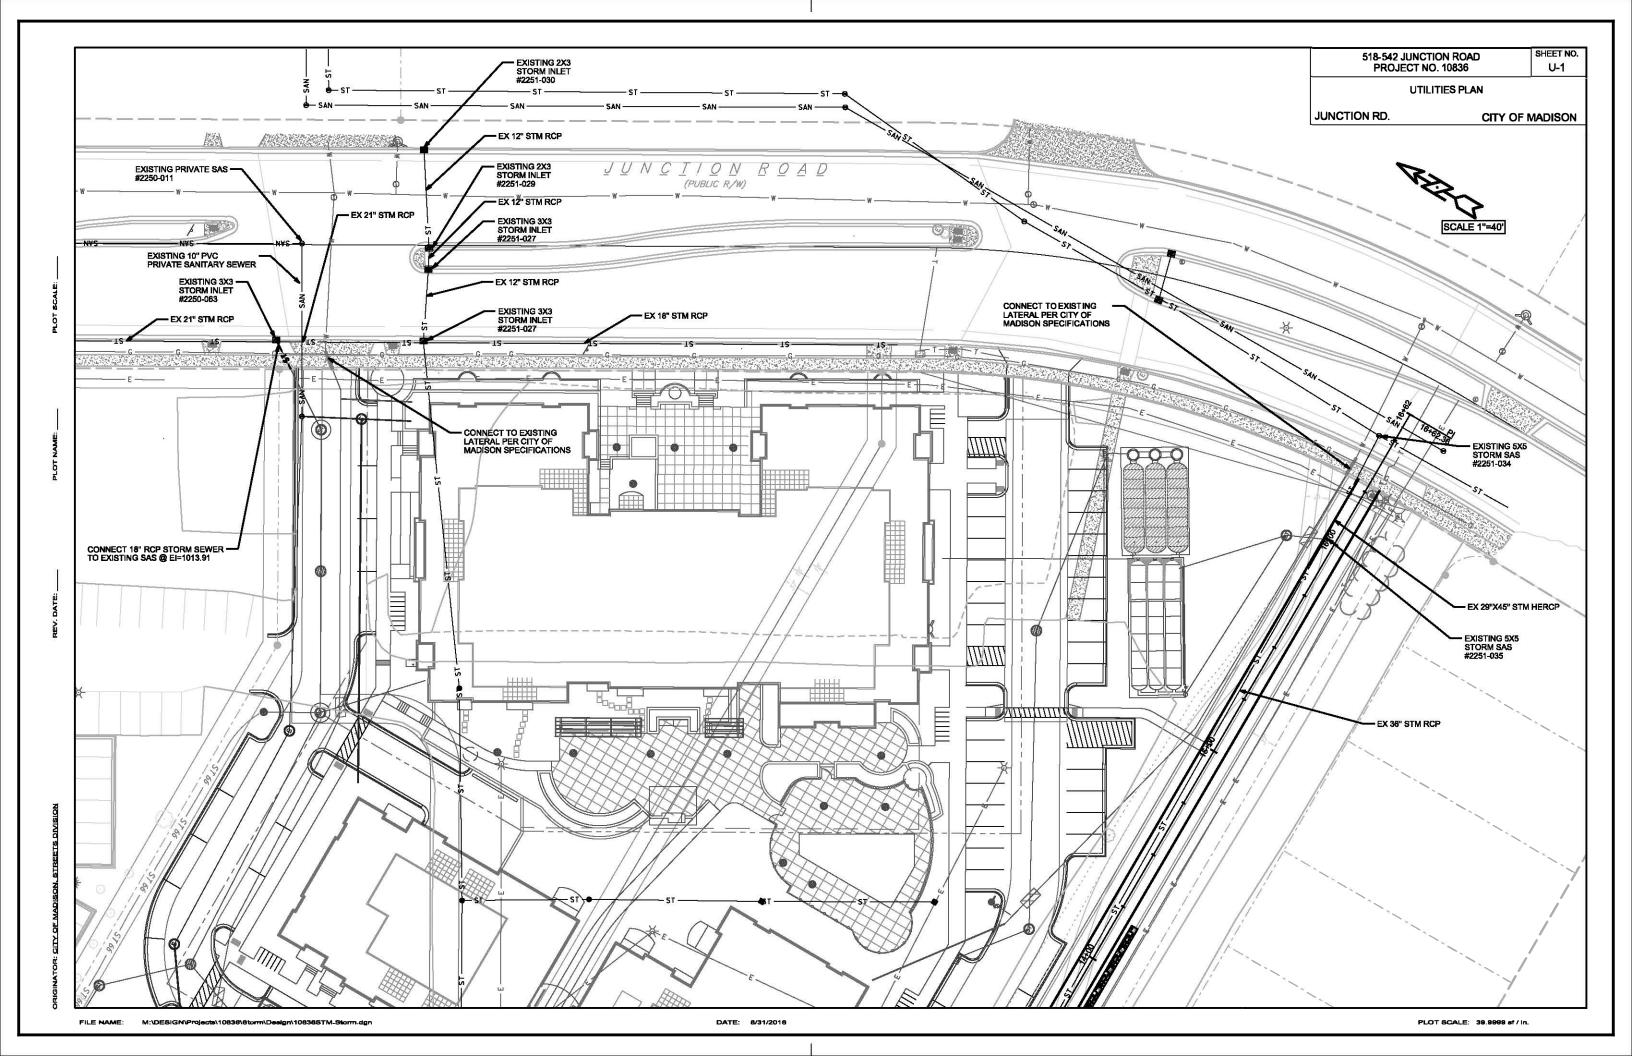

518-542 JUNCTION ROAD PROJECT NO. 10836

ЕΙ

ELECTRICAL SHEET

JUNCTION ROAD DRIVEWAY CITY OF MADISON

GNERAL ELECTRICAL NOTES:

- 1. ALL LOCATIONS ARE APPROXIMATE. THE TRAFFIC ENGINEER SHALL APPROVE FINAL LOCATIONS INCLUDING SETBACK IN THE FIELD. AFTER CONTRACTOR SURVEYS STAKING, THE CONTRACTOR SHALL NOTIFY BRIAN SMITH (261-9625) CITY TRAFFIC ENGINEERING, AT LEAST 24-HOURS IN ADVANCE OF NEEDING BASE LOCATIONS MARKED.
- 2. THE CONTRACTOR SHALL DO ALL WORK IN ACCORDANCE WITH CITY OF MADISON STANDARD SPECIFICATIONS FOR PUBLIC WORKS CONSTRUCTION 2016 EDITION AND ALL ADDENDUMS THERETO.
 - ALL CONDUIT SHALL BE PVC SCHEDULE 80 UNDER PAVEMENT OR SCHEDULE 40 OTHERWISE. PULL WIRE REQUIRED AS PER STANDARD SPECIFICATIONS.
- 3. THE CONTRACTOR SHALL CALL MIKE CHRISTOPH (266-4767) AT THE TRAFFIC ENGINEERING SHOP AT LEAST 24-HOURS IN ADVANCE OF POURING BASES OR BURYING CONDUIT TO ARRANGE FOR INSPECTION.
- 4. PRIOR TO REMOVAL OF THE EXISTING STREET LIGHT (SL1) THE CONTRACTOR IS REQUIRED TO INSTALL NEW TYPE LB-3 CONCRETE BASE AND COORDINATE WITH TRAFFIC ENGINEERING, MIKE CHRISTOPH, TO HAVE CITY CREWS PROVIDE TEMPORARY SIGNAL CABLES TO EXISTING SL-1 AND RELOCATE THE ELECTRIC SERVICE METER PEDESTAL.
- 5. ALL EXISTING CONDUITS ARE TO REMAIN UNLESS AND UNTIL AUTHORIZED TO REMOVE BY TRAFFIC ENGINEERING.
- 6. THE CONTRACTOR SHALL INSTALL LOOP LEED DUCT CONDUITS FROM TS-1 PRIOR TO CITY CREWS INSTALLING LOOP DETECTOR WIRES. NOTIFY MIKE CHRISTOPH (266-4767) A MINIMUM OF 24 HOURS AND MAXIMUM OF 48 HOURS PRIOR TO FINAL BASE COURSE COMPACTION AND TRIMMING FOR CITY CREWS TO INSTALL LOOP DETECTION WIRES IN THE BASE COURSE PRIOR TO PLACEMENT OF THE DRIVEWAY.
- 7. THE FOLLOWING CITY FURNISHED MATERIALS ARE TO BE PICKED UP AT THE TRAFFIC OPERTION SHOP, 1120 SAYLE STREET, NOTIFY DENNIS ROWE AT 266-9034 TWENTY FOUR (24) HOURS PRIOR TO PICKING UP THE MATERIAL.

3/4" x 19" ANCHOR BOLTS: 1" X 40" ANCHOR BOLTS:

LEGEND

PLACE SIGNAL/COMMUNICATION PVC COUNDUIT, 2" UNLESS NOTED AS OTHER

EXISTING SIGNAL/COMMUNICATION CONDUIT

CONSTRUCT LB-3 BASE


CONSTRUCT TYPE G BASE

EXISTING STREET LIGHT POLE/BASE

EXISTING TRAFFIC SIGNAL POLE/BASE

EXISTING TYPE-1 ELECTRICAL HANDHOLE

EXISTING CONTROLLER CABINET BASE

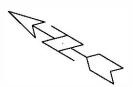

SCALE: 1'' = 30'

