ELECTRICAL PLAN SHEET NO. PI-P3 STREET PLAN AND PROFILES LANDSCAPING PLAN


UTILITIES PLAN

CITY OF MADISON

CITY ENGINEERING DIVISION DEPARTMENT OF PUBLIC WORKS PLAN OF PROPOSED IMPROVEMENT

211 N. CARROLL STREET

CITY PROJECT NO. 11973 CITY CONTRACT NO. 8281 MUNIS NO. 11973

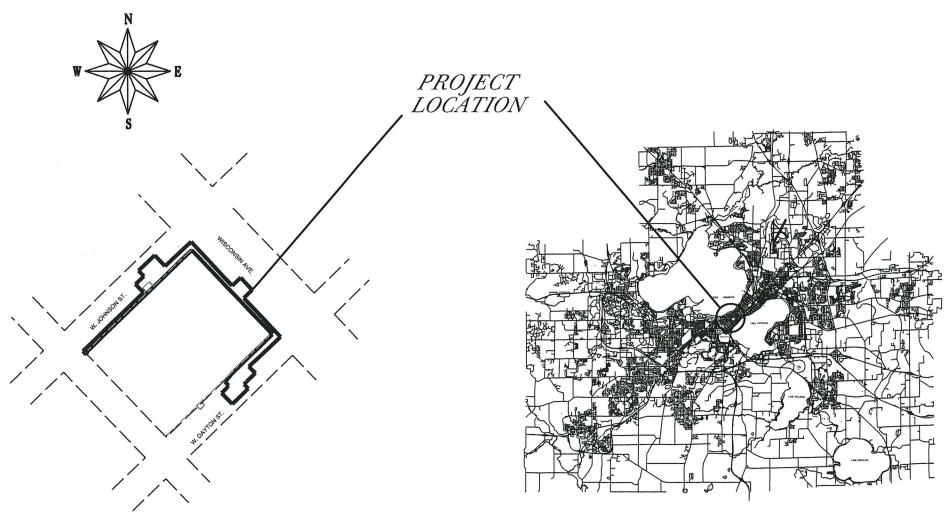

PUBLIC IMPROVEMENT PROJECT APPROVED

JANUARY 8, 2019

BY THE COMMON COUNCIL OF MADISON, WISCONSIN

PUBLIC IMPROVEMENT DESIGN APPROVED BY:



STREET & SANITARY SEWER DESIGNED BY:

ELECTRICAL DESIGNED B

ALL ASPHALT PAVEMENT WITHIN THE PROJECT LIMITS SHALL MAX EXISTING THICKNESSES OR MEET TYPE "C" ASPHALT PAVEMENT PER S.D.D. 4.06, WHICHEVER IS GREATER.

THE DEVELOPER SHALL REPLACE ALL CURB & GUTTER AND SIDEWALK THAT IS DAMAGED OR DETERMINED TO BE IN UNSATISFACTORY CONDITION.

ALL GUTTERS SHALL DRAIN WITH A MINIMUM GRADES OF 0.5% TOWARD STORM SEWER INLETS.

ALL DISTURBED TERRACE AREAS SHALL BE RESTORED WITH 6-INCHES OF TOP SOIL AND SEED UNLESS DIRECTED OTHERWISE ON THE PLAN OR BY THE CITY CONSTRUCTION ENGINEER.

TYPICAL PAVEMENT CROSS SLOPES SHALL BE 2% AND TERRACES SHALL SLOPE AT A 4% GRADE TOWARD THE GUTTER.

THE CROSS SLOPE OF SIDEWALKS AND BARRIER FREE SIDEWALK CURB RAMPS SHALL BE 1.5%. THE LONGITUDINAL GRADE OF BARRIER FREE SIDEWALK CURB RAMPS SHALL NOT EXCEED 8.33%. ALL SIDEWALK RAMPS SHALL BE CONSTRUCTED ACCORDING TO S.D.D. 3.03. AT ALL OTHER LOCATIONS THE LONGITUDINAL GRADE OF SIDEWALKS SHALL NOT EXCEED 5.0% OR THE ADJACENT STREET GRADE WHICHEVER IS GREATER NOR BE LESS THAN 0.5% AND SHALL DRAIN TOWARD STORM SEWER INLETS. CONCRETE TERRACE SHALL BE INSTALLED BETWEEN THE SIDEWALK AND THE BACK OF CURB AT SIDEWALK LOW POINTS WHICH CANNOT OTHERWISE BE DRAINED DIRECTLY TO THE GUTTER. SIDE SLOPES WITHIN TEN FEET OF A PUBLIC SIDEWALK SHALL NOT EXCEED 4.00:1. ALL SIDEWALK AND SIDEWALK RAMP ELEVATIONS AND GRADES SHALL BE FIELD VERIFIED AND SET TO COMPLY WITH THE CITY OF MADISON STANDARD SPECIFICATIONS AND THE A.D.A. GUIDELINES.

OBTAIN A PRINT OUT OF THE ALIGNMENT FROM THE CITY ENGINEER PRIOR TO STAKING THIS PROJECT.

CURB STATION AND OFFSETS SHALL BE TO THE FACE OF CURB UNLESS OTHERWISE INDICATED. CURB ELEVATIONS SHALL BE TO THE TOP OF CURB (OR EXTENDED TOP OF CURB FOR DRIVEWAYS OR RAMPS) UNLESS OTHERWISE INDICATED.

POWER POLES AND OTHER OBSTRUCTIONS SHALL BE MOVED TO PROVIDE 2 FEET MINIMUM OF CLEAR DISTANCE FROM ANY FACE OF CURB OR EDGE OF SIDEWALK.

ANY INFORMATION SHOWN ON THIS PLAN, WHICH IS NOT PART OF THIS RIGHT-OF-WAY PROJECT, IS PRELIMINARY AND NOT FOR CONSTRUCTION.

THERE MAY BE EXISTING UTILITIES OR OTHER FEATURES WHICH ARE EITHER NOT SHOWN OR SHOWN INCORRECTLY ON THIS PLAN. IT IS THE RESPONSIBILITY OF THE DEVELOPER TO LOCATE AND IDENTIFY ALL UTILITIES AND TOPOGRAPHY WHICH MAY AFFECT THE CONSTRUCTION OF THESE IMPROVEMENTS.

ALL PERMANENT SIGNING AND POSTING WILL BE DETERMINED AND PROVIDED BY THE TRAFFIC ENGINEERING DIVISION, FOLLOWING CONSTRUCTION OF THESE IMPROVEMENTS.

THE DEVELOPER SHALL PROVIDE, INSTALL AND MAINTAIN ALL STREET END BARRICADES, SIGNING AND TRAFFIC CONTROL, AS REQUIRED BY THE CITY TRAFFIC ENGINEER.

PAVEMENT SAWCUTS AND FINAL PAVEMENT PATCHING LIMITS SHALL BE
AS DIRECTED BY THE CITY CONSTRUCTION ENGINEER. SAWCUTS AND LIMITS
SHOWN ON THE PLAN ARE BASED ON ANTICIPATED DISTURBANCE AND THE
PATCHING CRIETERIA BUT SHALL BE CONSIDERED APPROXIMATE. ALL
PAVEMENT PATCHING SHALL BE PER THE CITY'S PATCHING CRITERIA.

THE LOCATION AND INFORMATION FOR PROPOSED NEW TREES, IN THE PUBLIC RIGHT OF WAY OR ON PUBLIC LANDS ARE APPROXIMATE AND ARE SHOWN FOR REFERENCE ONLY. THE LOCATIONS, SPECIFICATIONS AND PLANTING METHODS OF ALL PROPOSED NEW OR REPLACEMENT TREES IN THE PUBLIC RIGHT OF WAY OR ON PUBLIC LANDS SHALL BE APPROVED BY THE CITY FORESTER PRIOR TO INSTALLATION.

NO TREES IN THE RIGHT OF WAY OR ON PUBLIC LANDS SHALL BE TRIMMED, PRUNED, REMOVED OR ADVERSELY AFFECTED IN ANY WAY UNTIL THE DEVELOPER HAS RECEIVED WRITTEN PERMISSION FROM THE CITY ENGINEER OR CITY FORESTER. SAID WRITTEN PERMISSION SHALL INCLUDE LANGUAGE INDICATING THAT SECTION 10.101 OF THE MADISON GENERAL ORDINANCES AND ADMINISTRATIVE PROCEDURE MEMORANDUM NO. 6–2, REFERING TO NOTIFICATION OF PROPERTY OCCUPANTS ANDOOR OWNERS, HAS BEEN COMPLIED WITH.

ALL TREES WITHIN THE RIGHT-OF-WAY THAT ARE TO REMAIN, SHALL BE PROTECTED THROUGHOUT CONSTRUCTION. MATERIALS SHALL NOT BE STORED AROUND THE TREES AND SOILS SHALL NOT BE COMPACTED FURTHER THAN THE CONDITION PRIOR TO CONSTRUCTION.

COORDINATE WITH CITY FORESTRY PRIOR TO INSTALLATION OF PROPOSED TREE GRATES. TREE GRATE INSTALLATION INCLUDES PRELIMINARY EXCAVATION OF PROPOSED SITES TO ENSURE THAT IT IS APPROPRIATE FOR A NEW TREE PLANTING.

THE CONTRACTOR SHALL SUBMIT A TRAFFIC CONTROL PLAN FOR REVIEW TO THE CITY TRAFFIC ENGINEERING DIVISION AT LEAST 10 WORKING DAYS PRIOR TO WORK BEGINNING WITHIN THE UNIVERSITY AVE OR GRAND AVE RIGHT OF WAY. THE TRAFFIC CONTROL PLAN SHALL COMPLY WITH ALL MUTCD REQUIREMENTS. WORK SHALL NOT PROCEED ON UNIVERSITY AVE OR GRAND AVE UNTIL THE TRAFFIC CONTROL PLAN HAS BEEN APPROVED. THE TRAFFIC CONTROL PLAN MAY INCLUDE BUT IS NOT LIMITED TO: LANE CLOSURE RESTRICTIONS, PEAK HOUR WORKING RESTRICTIONS, ACCESS REQUIREMENTS, ETC. THE CONTRACTOR SHALL BE RESPONSIBLE FOR PHASING WORK AS NECESSARY TO MEET THE REQUIREMENTS OF THE APPROVED TRAFFIC CONTROL PLAN.

211 N. CARROLL STREET PROJECT NO. 11973			SHEET NO. D-1
	DETAILS		
NOTES		CITY OF N	MADISON

Pavement Patching Criteria

Criteria use on:

Streets with pavement rating > 6
Arterial Streets

- Length of Patch
 - a. Minimum 50 feet long
 - b. Minimum of 15 feet beyond the excavation
 - c. Where multiple patches are created and the separation between them is less than 100 feet, the patches shall be combined into a single patch.
 - d. The patches shall be adjusted in the field to meet special conditions such as previous paving or patching limits.
- 2. Width of Patch (all dimensions are curb face to curb face)
 - a. All Streets Except Divided or one way roadways
 - i. Street Width 0 to 24 feet wide Patch entire street width
 - ii. Street Width 25 to 37 feet wide Patch one half the street width (curb to centerline of roadway). Note - Utility Engineer may adjust paving limit to correspond with a painted centerline in situations where the painted centerline is not in the center of the street.
 - iii. Street Width 38 feet and up Patch width of entire lane for each lane which was disturbed by the excavation.
 - 1. If the lane is adjacent to a bike lane, include the bike lane. (except when there is a parking lane between the bike lane and the curb)
 - 2. If the lane is a bike lane and adjacent to a parking lane, include the parking lane.
 - 3. If the lane is a bike lane and not adjacent to a parking lane, include the adjacent travel lane.
 - b. Divided Roadways and One Way Streets
 - i. Street 0 to 19 feet wide Patch entire street width
 - ii. Street Width 20 feet and up Patch width of entire lane for each lane which was disturbed by the excavation.
 - If the lane is adjacent to a bike lane, include the bike lane. (except when there is a parking lane between the bike lane and the curb)
 - 2. If the lane is a bike lane and adjacent to a parking lane, include the parking lane.
 - 3. If the lane is a bike lane and not adjacent to a parking lane, include the adjacent travel lane.

STREET RATINGS

STREET NAME	CLASSIFICATION	PAVEMENT RATING			
W. JOHNSON ST.	ARTERIAL	6			
W. DAYTON ST.	ARTERIAL	8			
WISCONSIN AVE.	COLLECTOR	6			

211 N. CARROLL STREET PROJECT NO. 11973 ESMT DETAIL VARIES 34.25' TYP. 6.5' TYP 4' TYP TYPICAL SECTIONS R/W VARIES ASPHALT PVMT TO MATCH EXISTING 1.50% VARIES 2" MILL & OVERLAY; LIMITS PER PATCHING CRITERIA 5" CONC. WALK - SAWCUT 6" TOPSOIL, SEED & MAT OR 5" CONC WHERE INDICATED REMOVE & REPLACE TYPE 'A' CURB (LOCATIONS PER PLAN) REMOVE & REPLACE ASPHALT - AND CRUSHED AGG. BASE, WHERE NECESSARY; MATCH EX. TYPICAL SECTION - W. JOHNSON ST. NOT TO SCALE 12" SQ. FILTER FABRIC OVER R/W DRAIN HOLE 1"2 SCH. 40 PVC DRAIN HOLE, 3'-0" 10' TYP 21' TYP 35' TYP O.C. FILLED WITH ¹/₄" PEA GRAVEL INSTALL FLUSH WITH TOP & BOTTOM OF CONCRETE BASE. POLYMERIC SAND SWEPT JOINTS - UNIT PAVERS *5" CONC. WALK -6" TOPSOIL, SEED & MAT OR 5" CONC WHERE INDICATED * PORTION OF SIDEWALK IS CONSTRUCTED WITH PAVERS ON CONCRETE BASE. SEE DETAIL, THIS SHEET EXISTING CURB TO REMAIN ☐ FLUSH CONCRETE CONTAINMENT BAND TYPICAL SECTION - WISCONSIN AVE. BITUMINOUS SETTING BED WITH 2% NEOPRENE MODIFIED NOT TO SCALE ASPHALT ADHESIVE TACK COAT. CONCRETE BASE, SLOPE TO MATCH SURFACE GRADES & ALLOW FOR POSITIVE DRAINAGE **ESMT** - DENSE GRADED BASE VARIES 35' TYP. PREPARED SUBGRADE 6.5' TYP 4' TYP PAVERS ON CONCRETE BASE DETAIL NOT TO SCALE ASPHALT PVMT TO MATCH EXISTING 1.50% VARIES 2" MILL & OVERLAY; - LIMITS PER PATCHING 5" CONC. WALK -5" CONC. TERRACE REMOVE & REPLACE TYPE 'A' CURB (LOCATIONS PER PLAN) REMOVE & REPLACE ASPHALT - AND CRUSHED AGG. BASE, WHERE NECESSARY; MATCH EX. TYPICAL SECTION - W. DAYTON ST. NOT TO SCALE

DATE: 8/26/2019

SHEET NO.

D-2

CITY OF MADISON

SCALE: 1" = 30'

211 N. CARROLL STREET SHEET NO. PROJECT NO. 11973 E-1

ELECTRICAL PLAN

W JOHNSON ST. CITY OF MADISON

GENERAL ELECTRICAL NOTES:

1. ALL LOCATIONS ARE APPROXIMATE. THE TRAFFIC ENGINEER SHALL APPROVE FINAL LOCATIONS INCLUDING SETBACK IN THE FIELD. AFTER CONTRACTOR SURVEYS STAKING, THE CONTRACTOR SHALL NOTIFY GRETCHEN AVILES PINEIRO (266-4899) CITY TRAFFIC ENGINEERING, AT LEAST 24-HOURS IN ADVANCE OF NEEDING BASE LOCATIONS MARKED.

2. THE CONTRACTOR SHALL DO ALL WORK IN ACCORDANCE WITH CITY OF MADISON STANDARD SPECIFICATIONS FOR PUBLIC WORKS CONSTRUCTION 2019 EDITION AND ALL ADDENDUMS THERETO. ALL CONDUIT SHALL BE PVC SCHEDULE 80 UNDER PAVEMENT OR SCHEDULE 40 OTHERWISE. PULL WIRE REQUIRED AS PER STANDARD SPECIFICATIONS.

3. THE CONTRACTOR SHALL CALL TROY VANT (266-4767) AT THE TRAFFIC ENGINEERING SHOP AT LEAST 24-HOURS IN ADVANCE OF POURING BASES, BURYING CONDUIT AND CONSTRUCTING ELECTRICAL HANDHOLES TO ARRANGE FOR INSPECTION.

4. ALL EXISTING CONDUITS AND STREET LIGHTS ARE TO REMAIN UNLESS AND UNTIL AUTHORIZED TO REMOVE BY TRAFFIC ENGINEERING, EXISTING CONDUITS CROSSING ENDEAVOR LN.

5. THE FOLLOWING CITY FURNISHED MATERIALS ARE TO BE PICKED UP AT THE TRAFFIC TRAFFIC OPERTION SHOP, 1120 SAYLE STREET. NOTIFY ED SMITH AT 266-9034 TWENTY FOUR (24) HOURS PRIOR TO PICKING UP THE MATERIAL:

3/4"X24" ANCHOR BOLTS: 6 SETS OF 4 FOR LB-1 BASES 1-1/4"X48" ANCHOR BOLTS: 1 SETS OF 4 FOR LB-8 BASES

LEGEND

PLACE STREET LIGHTING (1) -2" PVC CONDUIT, UNLESS NOTED AS OTHER

— PLACE SIGNAL/COMMUNICATION (2) -3" PVC COUNDUITS, UNLESS NOTED AS OTHER


CONSTRUCT TYPE-1 ELECTRICAL HANDHOLE

☑ CONSTRUCT TYPE 5 ELECTRICAL HANDHOLE

★ CONSTRUCT LB-1 CONCRETE BASE

O CONSTRUCT LB-8 CONCRETE BASE

† EXISTING BASE TO BE MAINTAINED

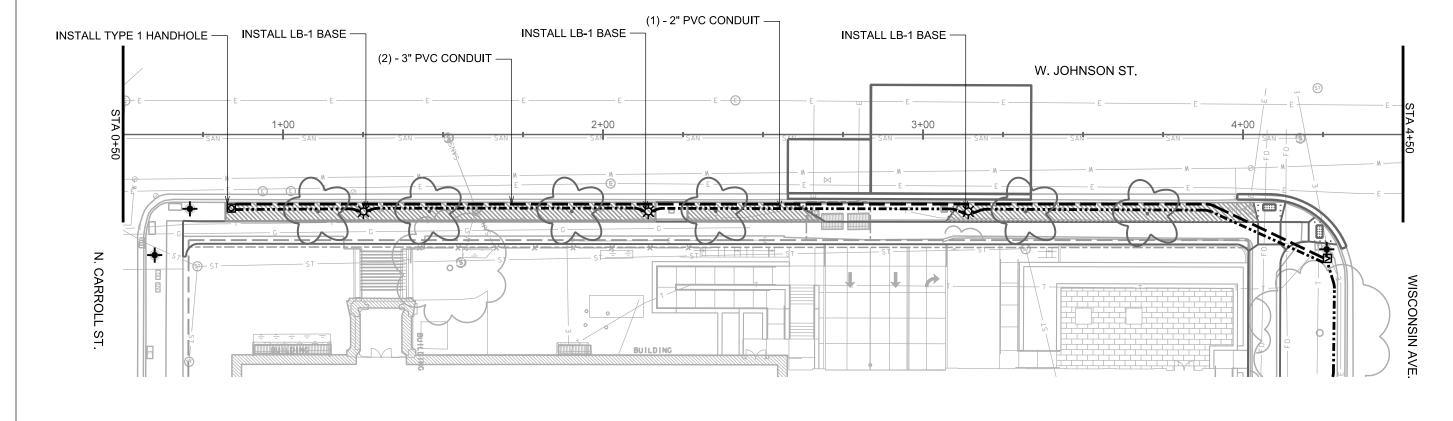

SHEET NO. E-2

ELECTRICAL PLAN

— (2) - 3" PVC CONDUIT

WISCONSIN AVE.

CITY OF MADISON

SCALE: 1" = 30'

(1) - 2" PVC CONDUIT REMOVE EXISTING HANDHOLE AND REPLACE WITH HANDHOLE TYPE 5 COORDINATE WITH CITY OF MADISON - TRAFFIC ENGINEERING, MIKE BENZSCHAWEL 266-9031 NEW 2" CONDUIT INTO EXISTING HANDHOLE COORDINATE WITH CITY OF MADISON - TRAFFIC (1) - 2" PVC CONDUIT — INSTALL LB-1 BASE — INSTALL LB-1 BASE -ENGINEERING, MIKE BENZSCHAWEL 266-9031 INSTALL LB-1 BASE -W DAYTON ST W. JOHNSON ST. REMOVE EXISTING BASE CORRDINATE WITH CITY TE TO REMOVE EXISTING POLE AND ATTACHMENTS INSTALL LB-8 BASE 101+00 102+00 103+00 WISCONSIN AVE.

LEGEND

PLACE STREET LIGHTING (1) -2" PVC CONDUIT, UNLESS NOTED AS OTHER

— PLACE SIGNAL/COMMUNICATION (2) -3" PVC COUNDUITS, UNLESS NOTED AS OTHER

CONSTRUCT TYPE-1 ELECTRICAL HANDHOLE

CONSTRUCT TYPE 5 ELECTRICAL HANDHOLE

CONSTRUCT LB-1 CONCRETE BASE

CONSTRUCT LB-8 CONCRETE BASE

EXISTING BASE TO BE MAINTAINED

ORIGINATOR: CITY OF MADISON, TRAFFIC EN

FILE NAME: \$\$....deslanfile....\$\$

DATE: \$\$...plottlngdate...\$\$

