**INDEX OF SHEETS** SHEET NO. C1.0

SHEET NO. C2.0

SHEET NO. C2.1

SHEET NO. C3.0

SHEET NO. C4.0

SHEET NO. L1.0

SHEETNO. C4.1-C4.2

SHEET NO. C5.0-C5.1

SHEET NO. S1, S5-S6

NO MAINTENANCE

PLAN

**EXISTING CONDITIONS MAP** 

BIKE LANE AND SIDEWALK

SIDEWALK PLAN & PROFILE

SANITARY PLAN & PROFILE

NOTES AND DETAILS

STRUCTURAL PLANS

LANDSCAPE PLAN

AND DEMOLITION PLAN

TRAFFIC PLAN

CLOSURE PLAN

UTILITY PLAN

### CITY OF MADISON CITY ENGINEERING DIVISION DEPARTMENT OF PUBLIC WORKS PLAN OF PROPOSED IMPROVEMENT

PUBLIC IMPROVEMENT DESIGN APPROVED BY:

BY THE COMMON COUNCIL OF MADISON, WISCONSIN

PUBLIC IMPROVEMENT PROJECT

Oct 4, 2021

City Engineer

**APPROVED** 

MARCH 16, 2021


Date

STREET **DESIGNED BY:** 

5133 UNIVERSITY AVENUE

CITY PROJECT NO. 13464 CONTRACT NO. 9021

**PROJECT LOCATION** 

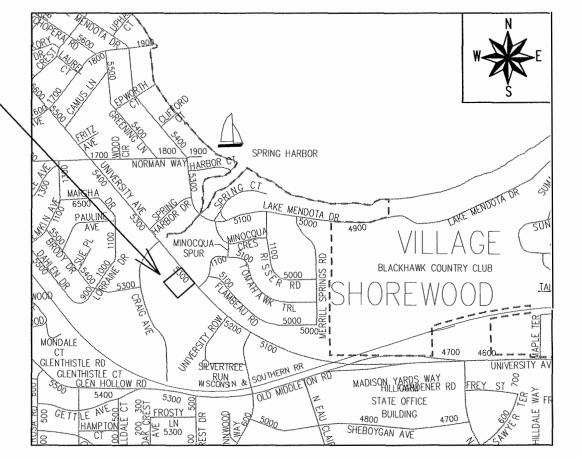

STRUCTURAL

**DESIGNED BY:** 

REVISED 7/5/22 - FBEG

Replaced Sheets - C1.0 & C4.0

SEE **INDIVIDUAL** SHEET


SANITARY SEWER DESIGNED BY:


STORM SEWER **DESIGNED BY:** 

> LATERALS ONLY

WATER DESIGNED BY:

> LATERALS ONLY

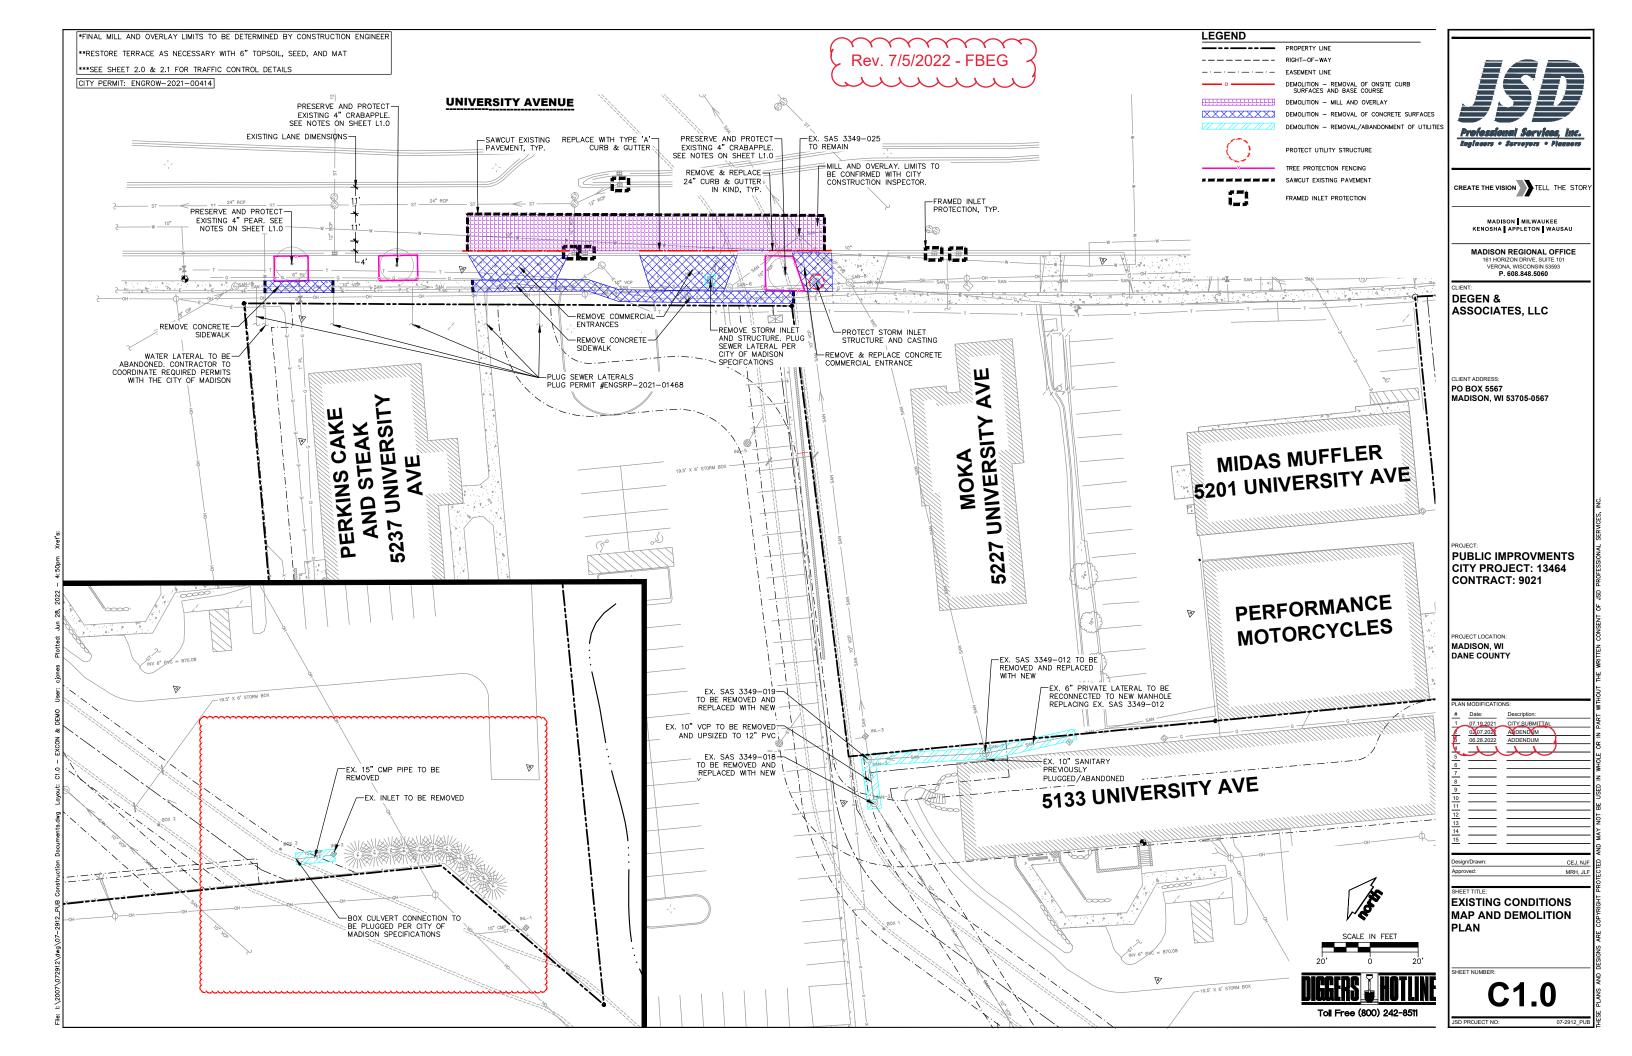

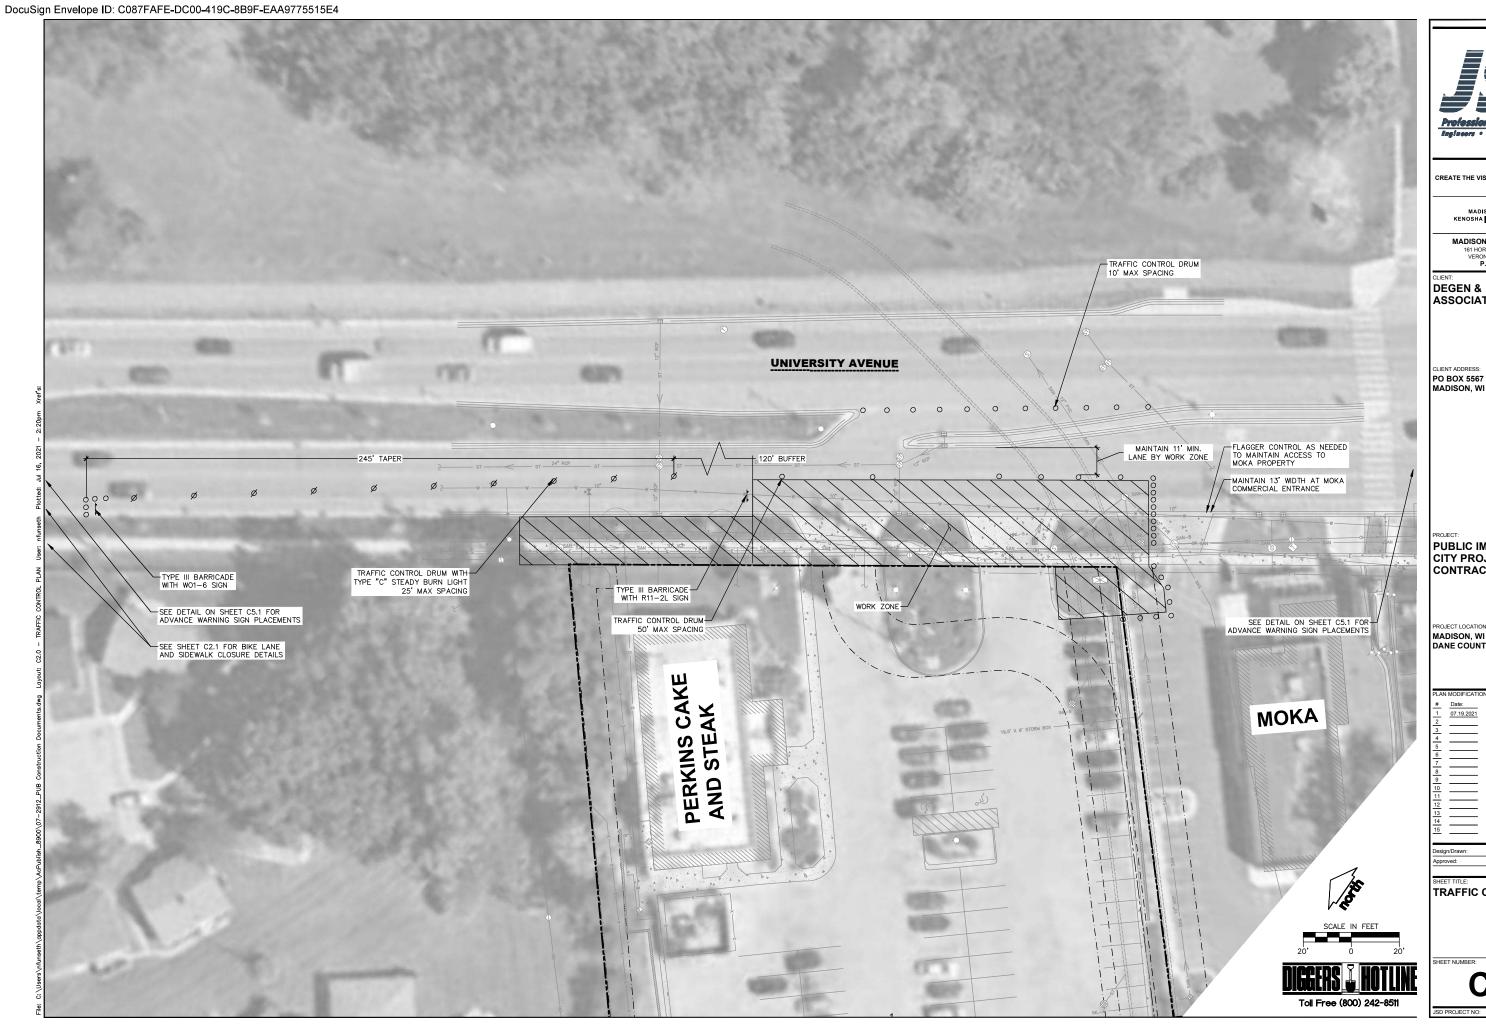



CREATE THE VISION TELL THE STORY

MADISON MILWAUKEE KENOSHA APPLETON WAUSAU

MADISON REGIONAL OFFICE

161 HORIZON DRIVE, SUITE 101 VERONA, WISCONSIN 535 P. 608.848.5060

ASSOCIATES, LLC

LIENT ADDRESS: PO BOX 5567 MADISON, WI 53705-0567


PUBLIC IMPROVMENTS CITY PROJECT: 13464 CONTRACT: 9021


PROJECT LOCATION: MADISON, WI DANE COUNTY


#_	Date:	Description:	I
1	07.19.2021	CITY SUBMITTAL	
1 2 3 4 5 6 7 8 9 10 11 12 13			The second secon
3			
4			
5			
6			
7			
8			i i
9			
10			
11			
12			
13			
			_
15			


CEJ, NJF MRH, JLF


TRAFFIC CONTROL PLAN

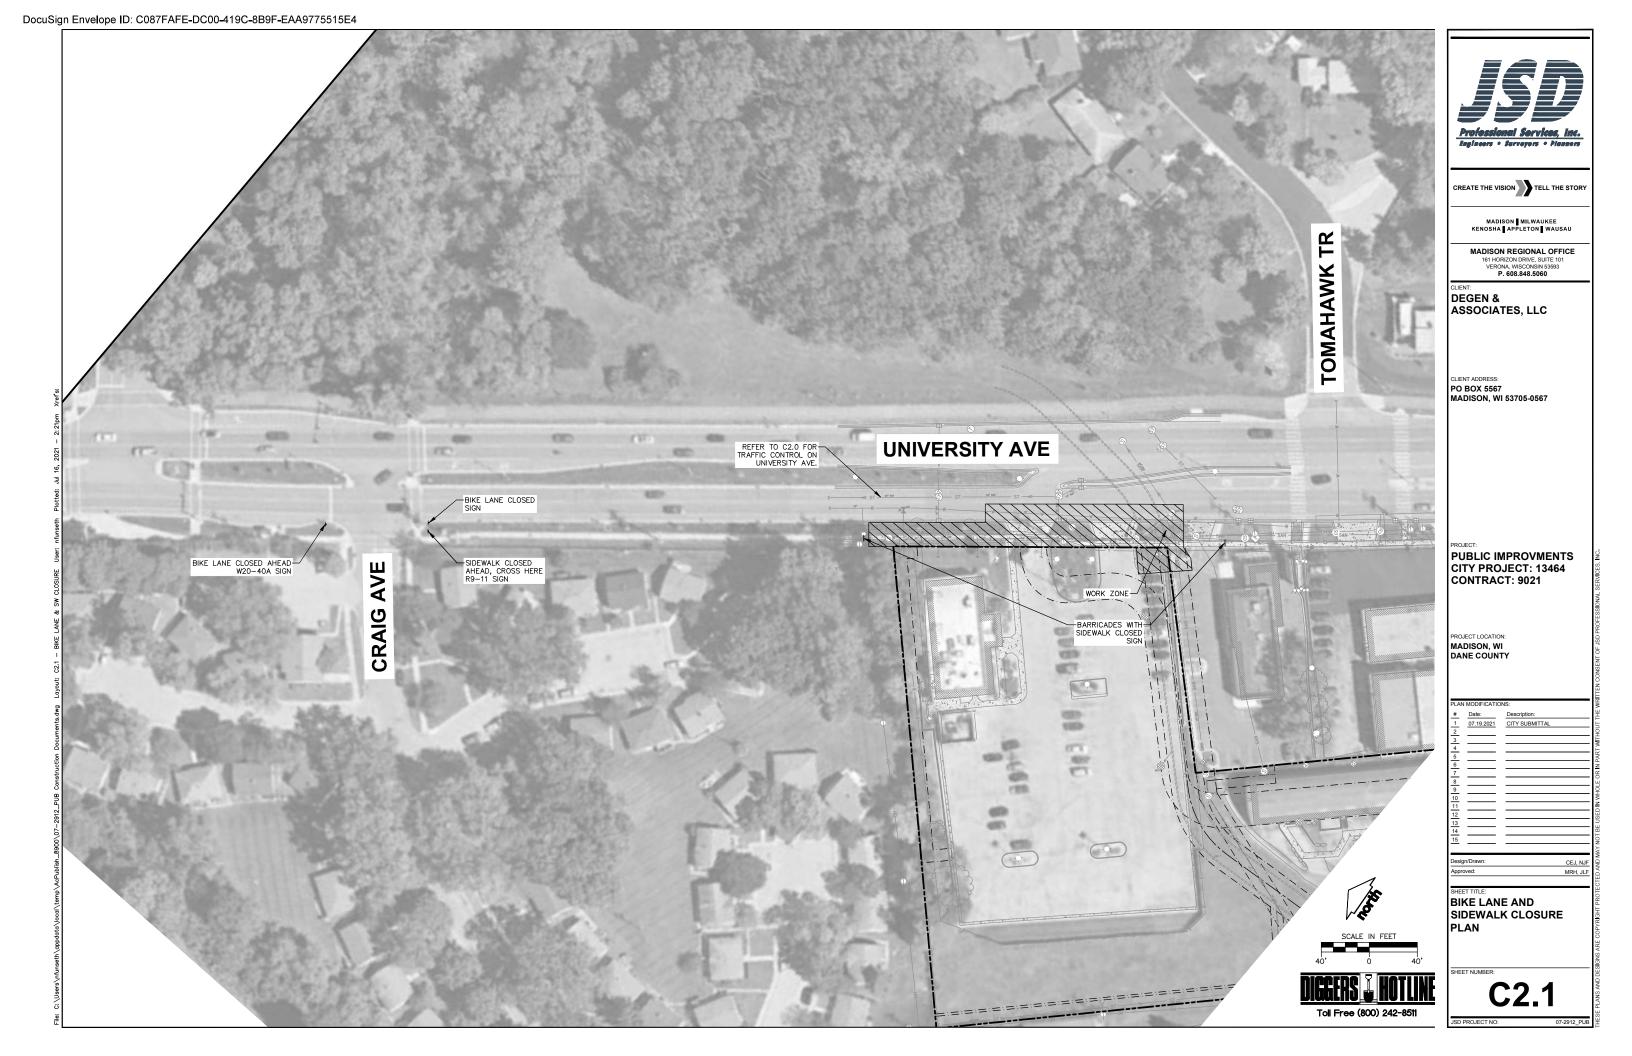

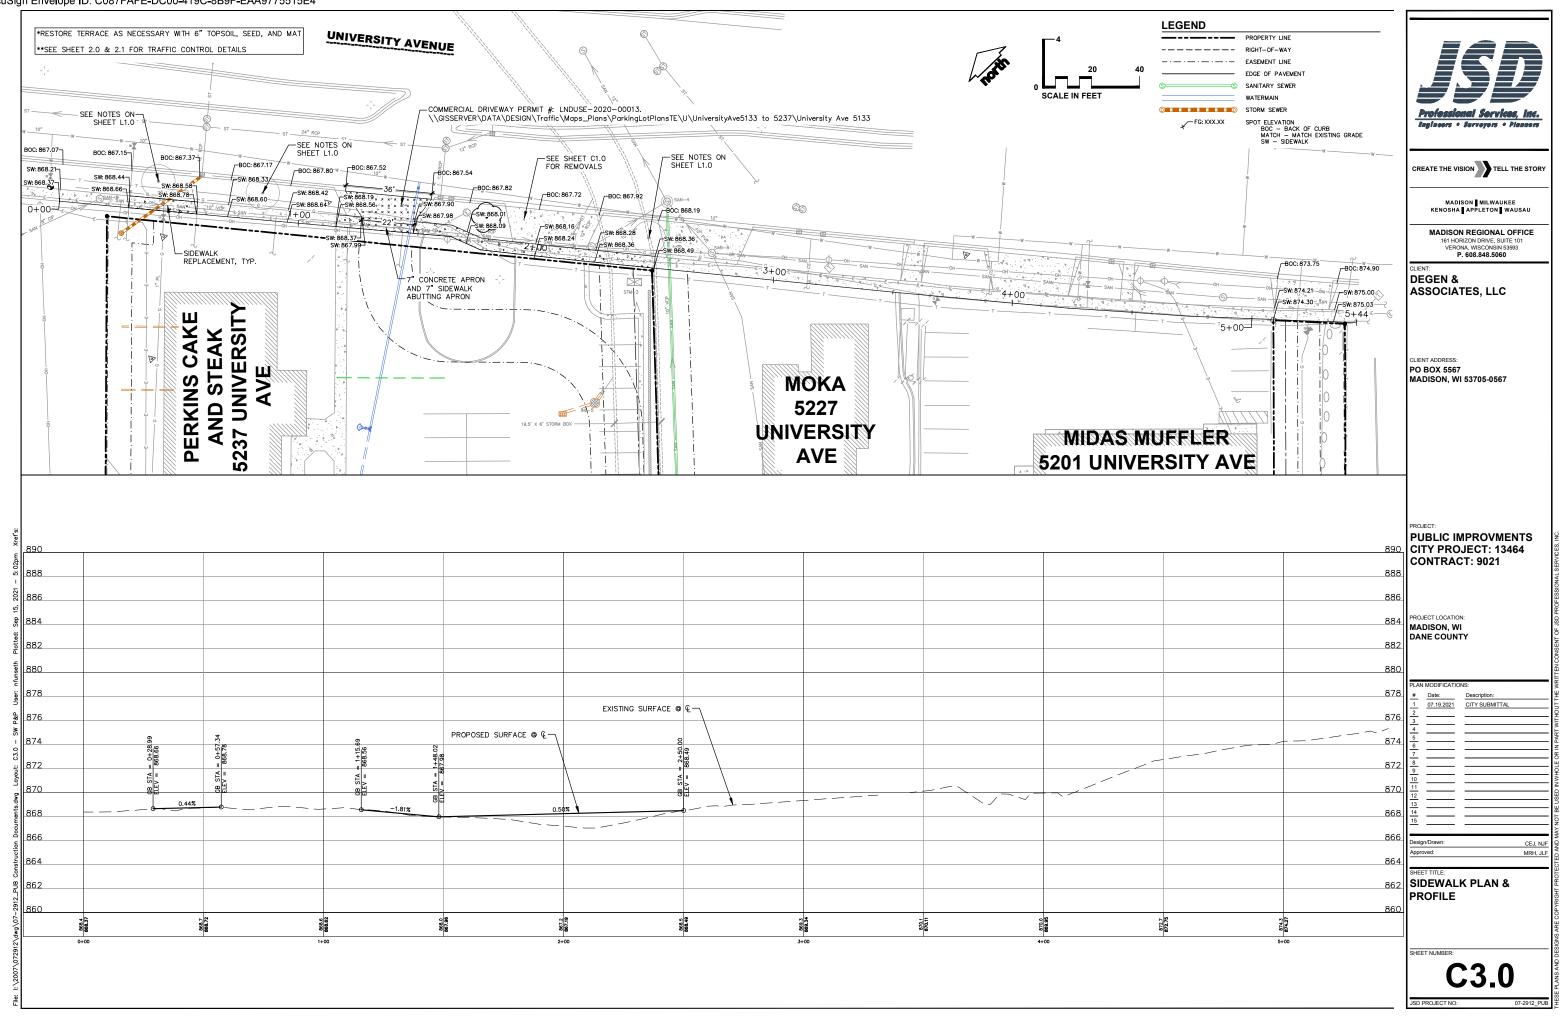

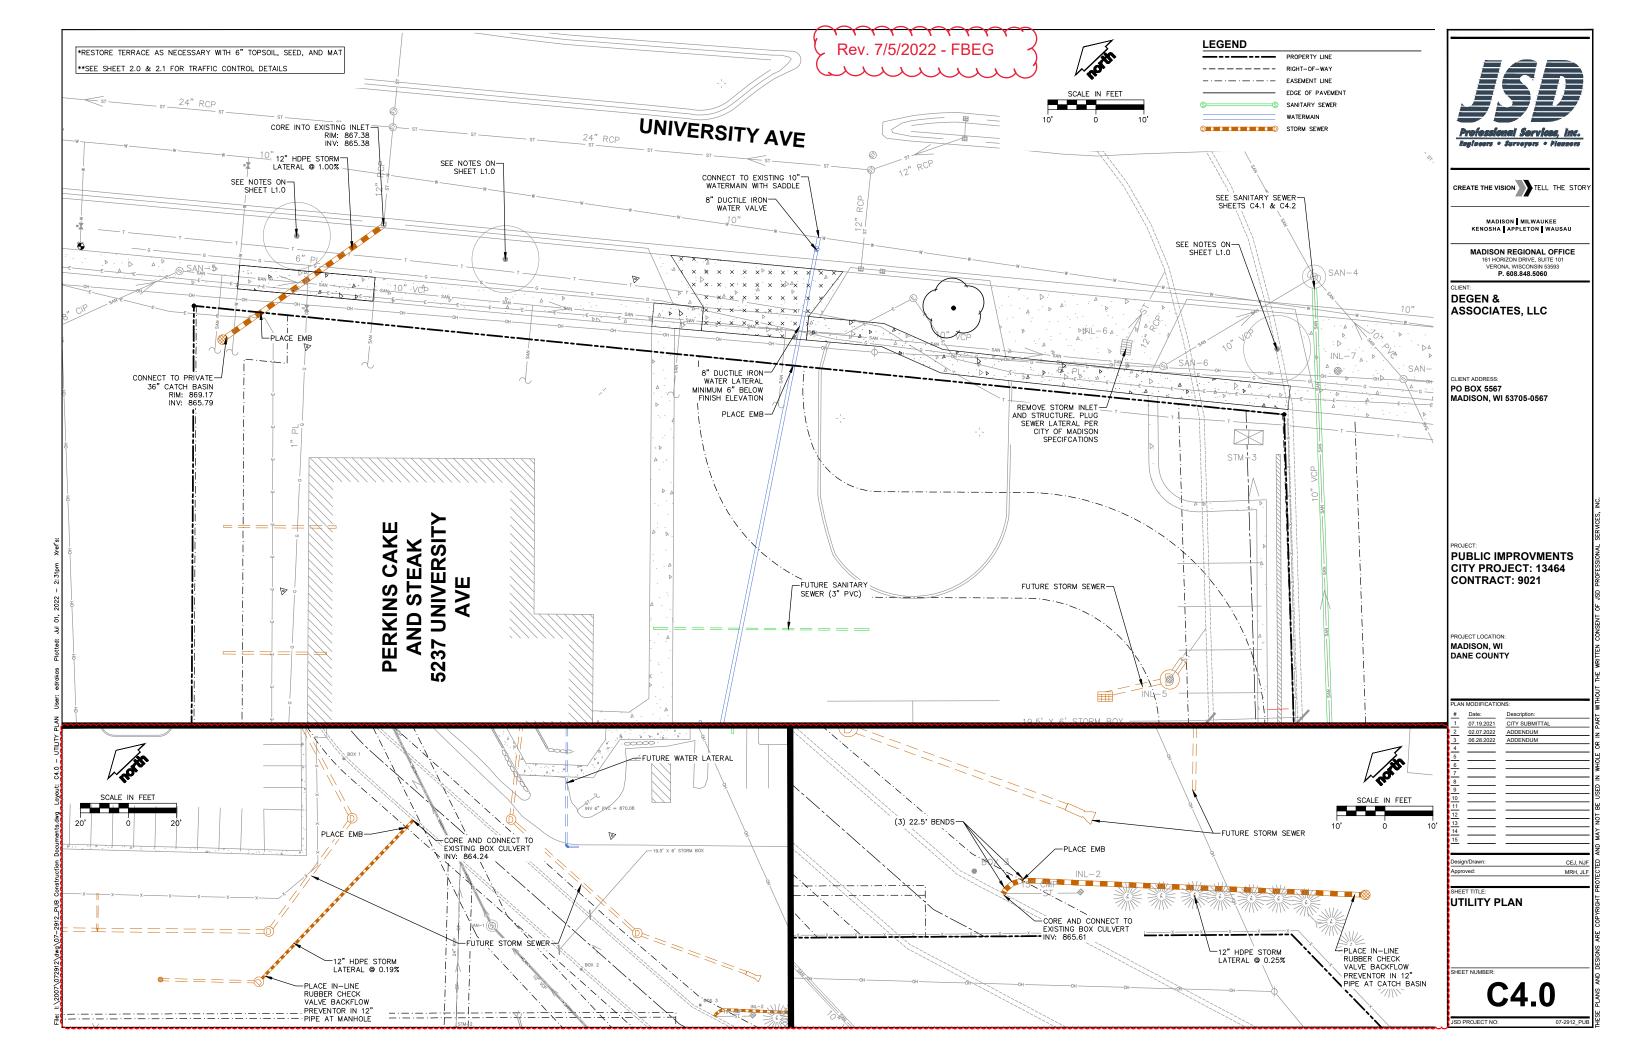

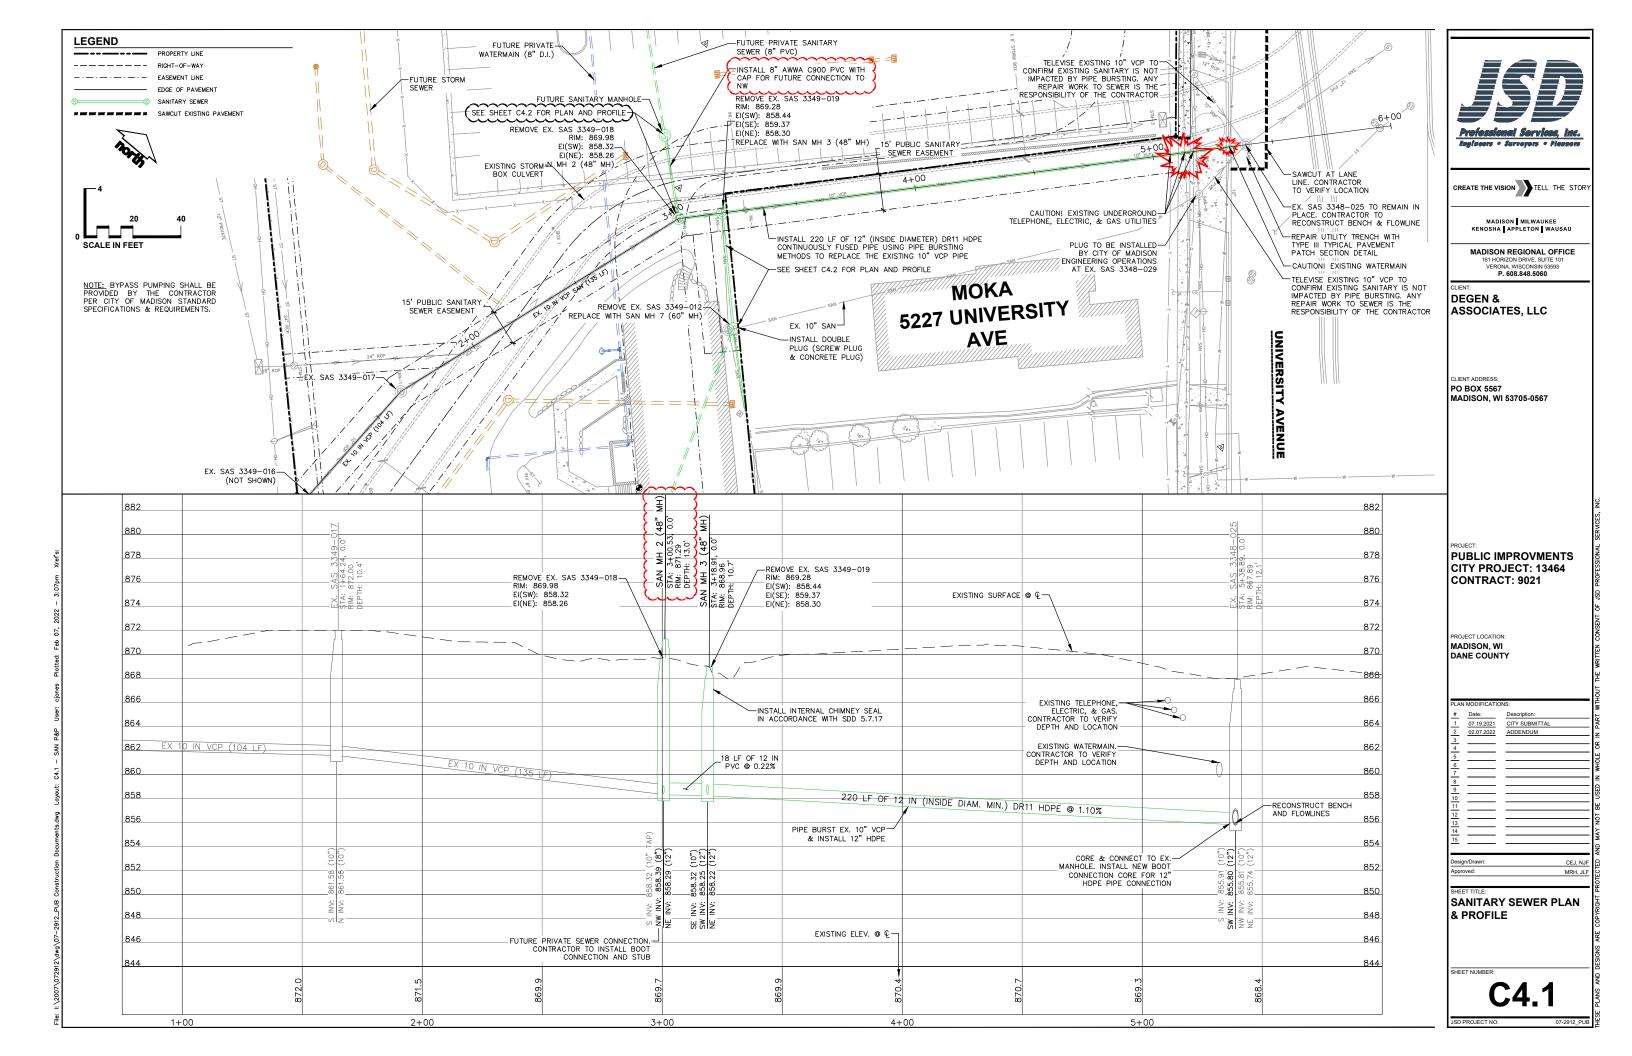

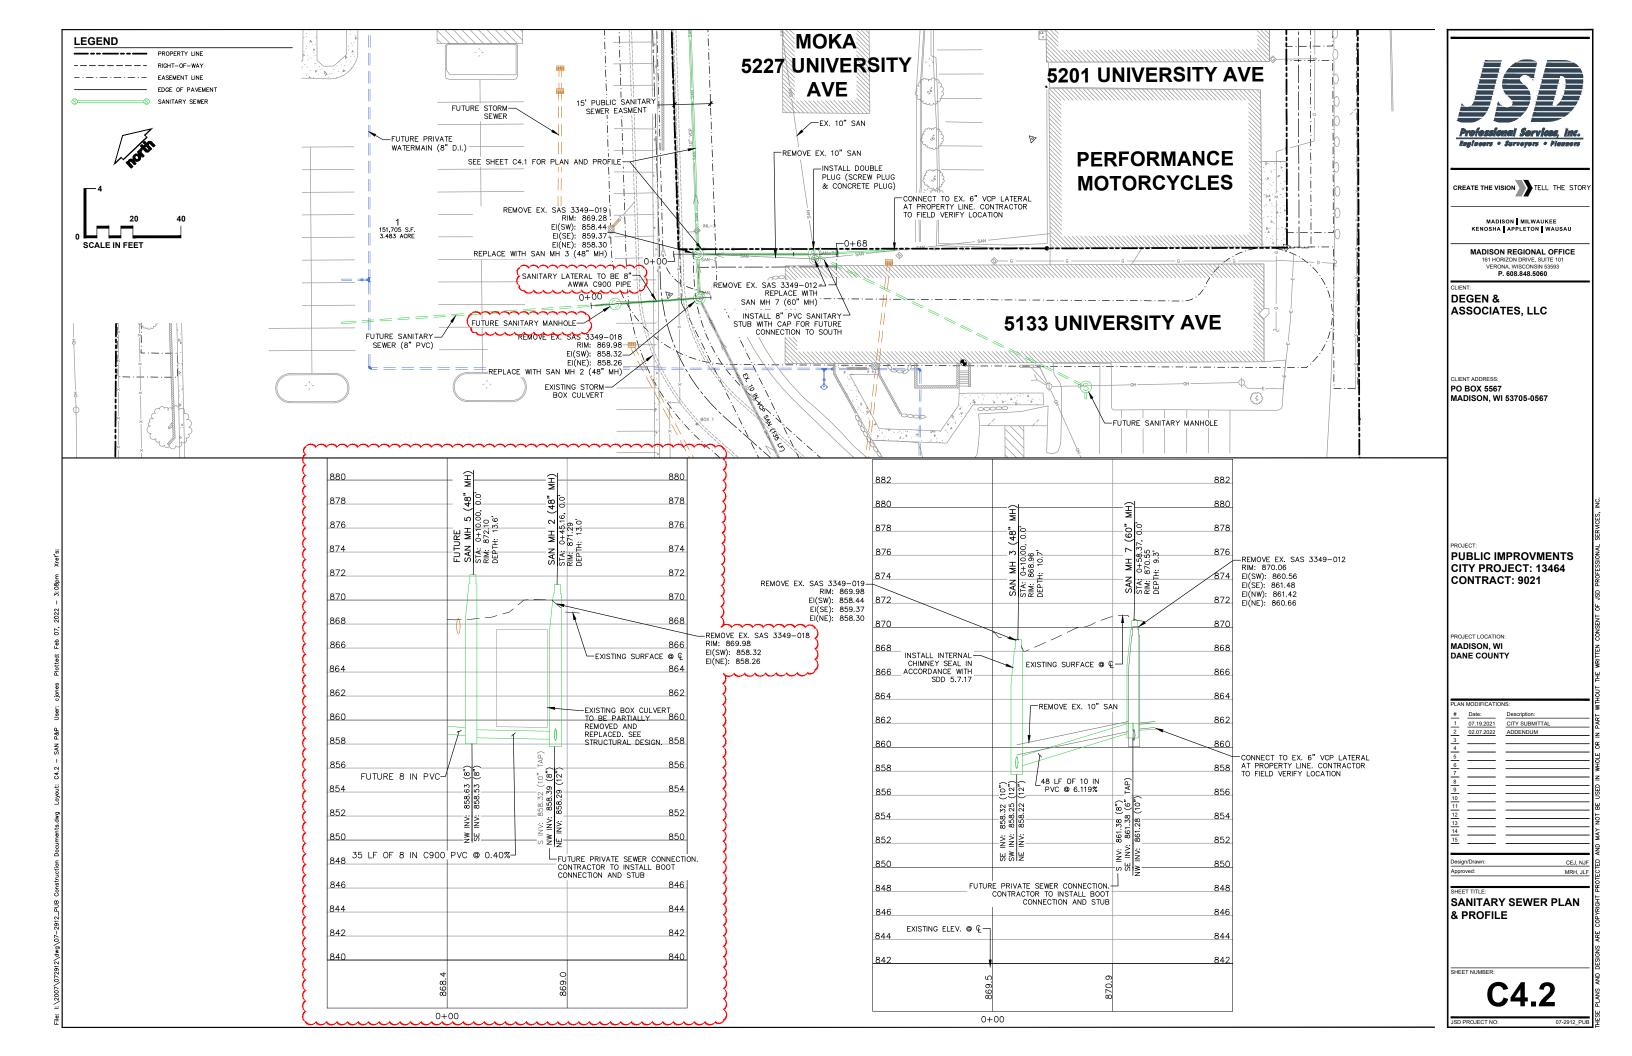

2. PAVEMENT SAWCUTS AND FINAL PAVEMENT PATCHING LIMITS SHALL BE AS DIRECTED BY THE CITY CONSTRUCTION ENGINEER. SAWCUTS AND LIMITS SHOWN ON THE PLAN ARE BASED ON ANTICHAED DISTURBANCE AND THE PATCHING CRITERIA BUT SHALL BE CONSIDERED APPROXIMATE. ALL PAVEMENT PATCHING SHALL BE PER THE CITY'S PATCHING CRITERIA.

3. ALL GUTTERS SHALL DRAIN WITH A MINIMUM GRADES OF 0.5% TOWARD STORM SEWER INLETS.

4. ALL DISTURBED TERRACE AREAS SHALL BE RESTORED WITH 6-INCHES OF TOP SOIL AND SEED UNLESS DIRECTED OTHERWISE ON THE PLAN OR BY THE CITY CONSTRUCTION ENGINEER.

5. TYPICAL PAVEMENT CROSS SLOPES SHALL BE 2% AND TERRACES SHALL SLOPE AT A 4% GRADE TOWARD THE GUTTER.

6. THE CROSS SLOPE OF SIDEWALKS AND BARRIER FREE SIDEWALK CURB RAMPS SHALL BE 1.5%. THE LONGITUDINAL GRADE OF BARRIER FREE SIDEWALK CURB RAMPS SHALL NOT EXCEED 8.33% ALL SIDEWALK RAMPS SHALL BE CONSTRUCTED ACCORDING TO S.D.D.3.03. AND SHALL DITER LOCATIONS THE LONGITUDINAL GRADE OF SIDEWALKS SHALL NOT EXCEED 5.0 % OR THE ADJACENT STREET GRADE WHICHEVER IS GREATER NOR BE LESS THAN 0.5% AND SHALL DRAIN TOWARD STORMS EWER INLETS. CONCRETE TERRACE SHALL BE INSTALLED BETWEEN THE SIDEWALK AND THE BACK OF CURB AT SIDEWALK LOW POINTS WHICH CANNOT OTHERWISE BE DRAINED DIRECTLY TO THE GUTTER. SIDE SLOPES WITHIN TEN FEET OF A PUBLIC SIDEWALK SHALL NOT EXCEED 4.00:1. ALL SIDEWALK AND SIDEWALK RAMP ELEVATIONS AND GRADES SHALL BE FREID VERFIELD AND SET TO COMPLY WITH THE CITY OF MADISON STANDARD SPECIFICATIONS AND THE A.D.A. GUIDELINES.

7. OBTAIN A PRINT OUT OF THE ALIGNMENT FROM THE CITY ENGINEER PRIOR TO STAKING THIS PROJECT.

8. CURB STATION AND OFFSETS SHALL BE TO THE EDGE OF PAVEMENT UNLESS OTHERWISE INDICATED. CURB ELEVATIONS SHALL BE TO THE EDGE OF PAVEMENT UNLESS OTHERWISE INDICATED.

9. POWER POLES AND OTHER OBSTRUCTIONS SHALL BE MOVED TO PROVIDE 2 FEET MINIMUM OF CLEAR DISTANCE FROM ANY FACE OF CURB OR EDGE OF SIDEWALK.

10. ANY INFORMATION SHOWN ON THIS PLAN, WHICH IS NOT PART OF THIS RIGHT-OF-WAY PROJECT. IS PRELIMINARY AND NOT FOR CONSTRUCTION.

11. THERE MAY BE EXISTING UTILITIES OR OTHER FEATURES WHICH ARE EITHER NOT SHOWN OR SHOWN INCORRECTLY ON THIS PLAN, IT IS THE RESPONSIBILITY OF THE CONTRACTOR TO LOCATE AND IDENTIFY ALL UTILITIES AND TOPOGRAPHY WHICH MAY AFFECT THE CONSTRUCTION OF THESE IMPROVEMENTS.

12. RELOCATION OR ADJUSTING OF PRIVATE UTILITY FACILITIES SUCH AS POLES, PEDESTALS, BOXES, STRUCTURES, CASTINGS OR HANDHOLES, SHALL BE COORDINATED WITH PRIVATE UTILITY COMPANIES.


13. ALL PERMANENT SIGNING AND POSTING WILL BE DETERMINED AND PROVIDED BY THE TRAFFIC ENGINEERING DIVISION, FOLLOWING CONSTRUCTION OF THESE IMPROVEMENTS.


14. THE CONTRACTOR SHALL PROVIDE, INSTALL, AND MAINTAIN ALL STREET END BARRICADES, SIGNING, AND TRAFFIC CONTROL, AS REQUIRED BY THE CITY TRAFFIC ENGINEER.


SIGNING, AND TRAFFIC CONTROL. AS REQUIRED BY THE CITY TRAFFIC ENGINEER.


15. THE CONTRACTOR SHALL SUBMIT A TRAFFIC CONTROL PLAN FOR REVIEW TO THE CITY TRAFFIC ENGINEERING DIVISION AT LEAST 10 WORKING DAYS PRIOR TO WORK BEGINNING. THE TRAFFIC CONTROL PLAN SHALL COMPLY WITH ALL MUTTO REQUIREMENTS. WORK SHALL NOT PLAN PROPERTY OF THE PLAN FOR THE PLAN FOR THE PLAN HAY INCLUDE BUT IS NOT INNETTED TO: LANE CLOSURE RESPICTIONS, PEAK HOUR WORKING RESTRICTIONS, ACCESS REQUIREMENTS, ETC. THE CONTRACTOR SHALL BE RESPONSIBLE FOR PHASING WORK AS NECESSARY TO MEET THE REQUIREMENTS OF THE APPROVED TRAFFIC CONTROL PLAN.


11. PAVEMENT SAWCUTS AND FINAL PAVEMENT PATCHING LIMITS SHALL BE AS DIRECTED BY THE CITY CONSTRUCTION ENGINEER. SAWCUTS AND LIMITS SHOWN ON THE PLAN ARE BASED ON ANTICIPATED DISTURBANCE AND THE PATCHING CRITERIA BUT SHALL BE CONSIDERED APPROXIMATE. ALL PAVEMENT PATCHING SHALL BE PET THE CITY'S PATCHING CRITERIA.

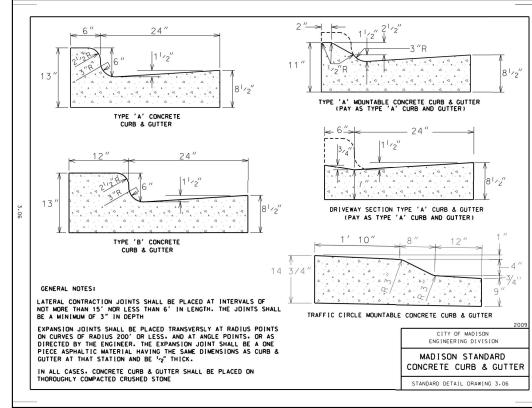


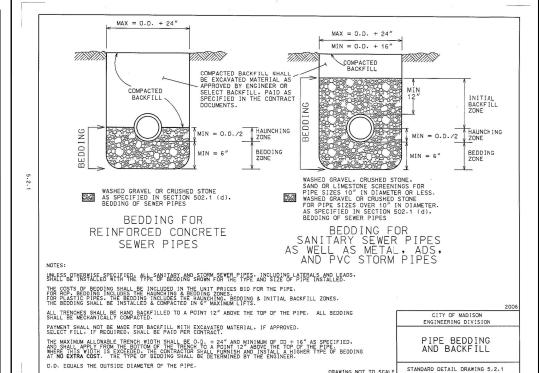


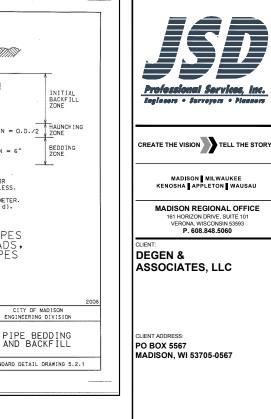

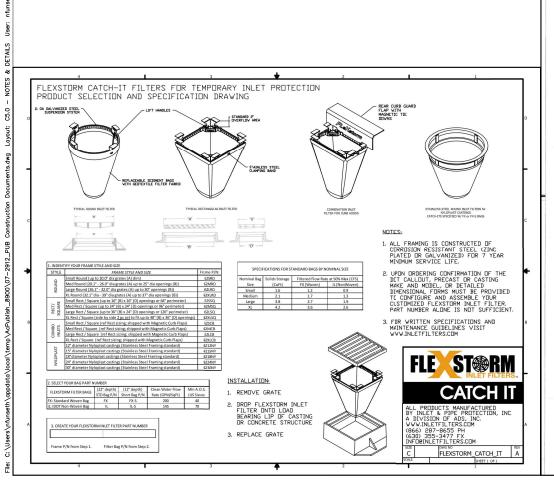


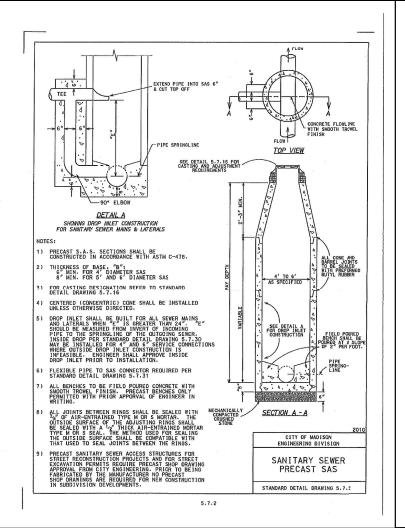

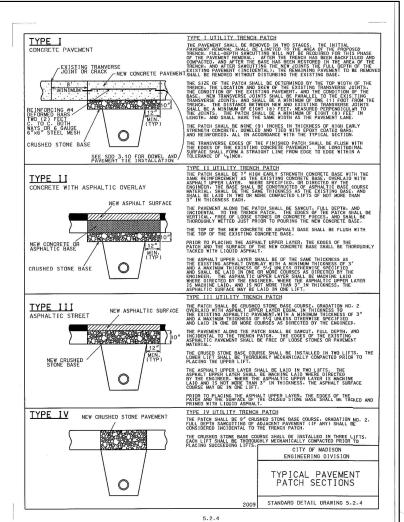

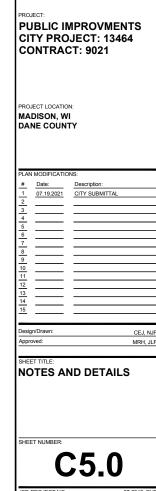

P 608 848 5060

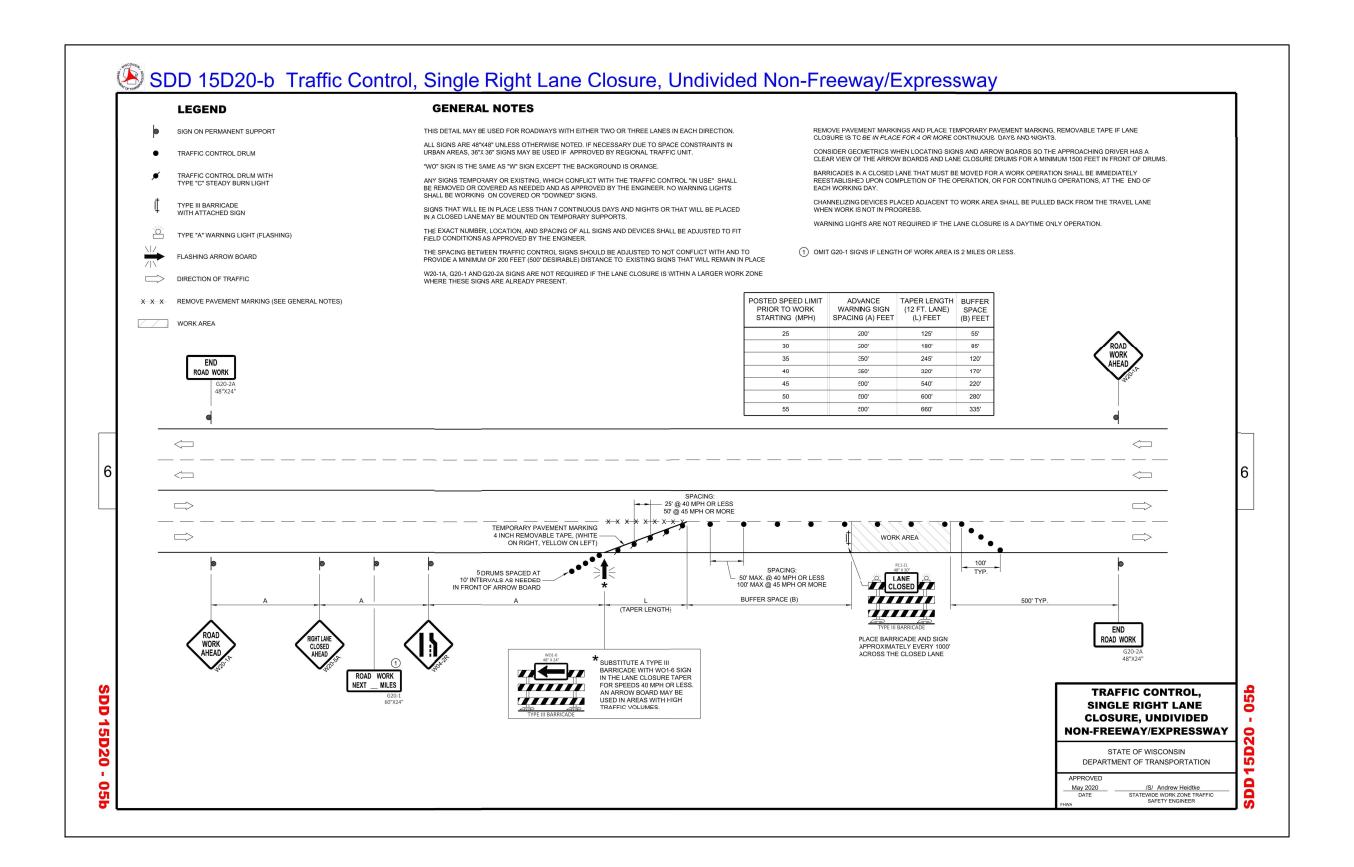



CREATE THE VISION TELL THE STORY

MADISON MILWAUKEE KENOSHA APPLETON WAUSAU

MADISON REGIONAL OFFICE P. 608.848.5060

**DEGEN &** 

ASSOCIATES, LLC

PO BOX 5567


PUBLIC IMPROVMENTS CITY PROJECT: 13464 **CONTRACT: 9021** 


ROJECT LOCATION MADISON, WI DANE COUNTY


PLAN MODIFICATIONS:		
#	Date:	Description:
1	07.19.2021	CITY SUBMITTAL

CEJ, NJF

NOTES AND DETAILS

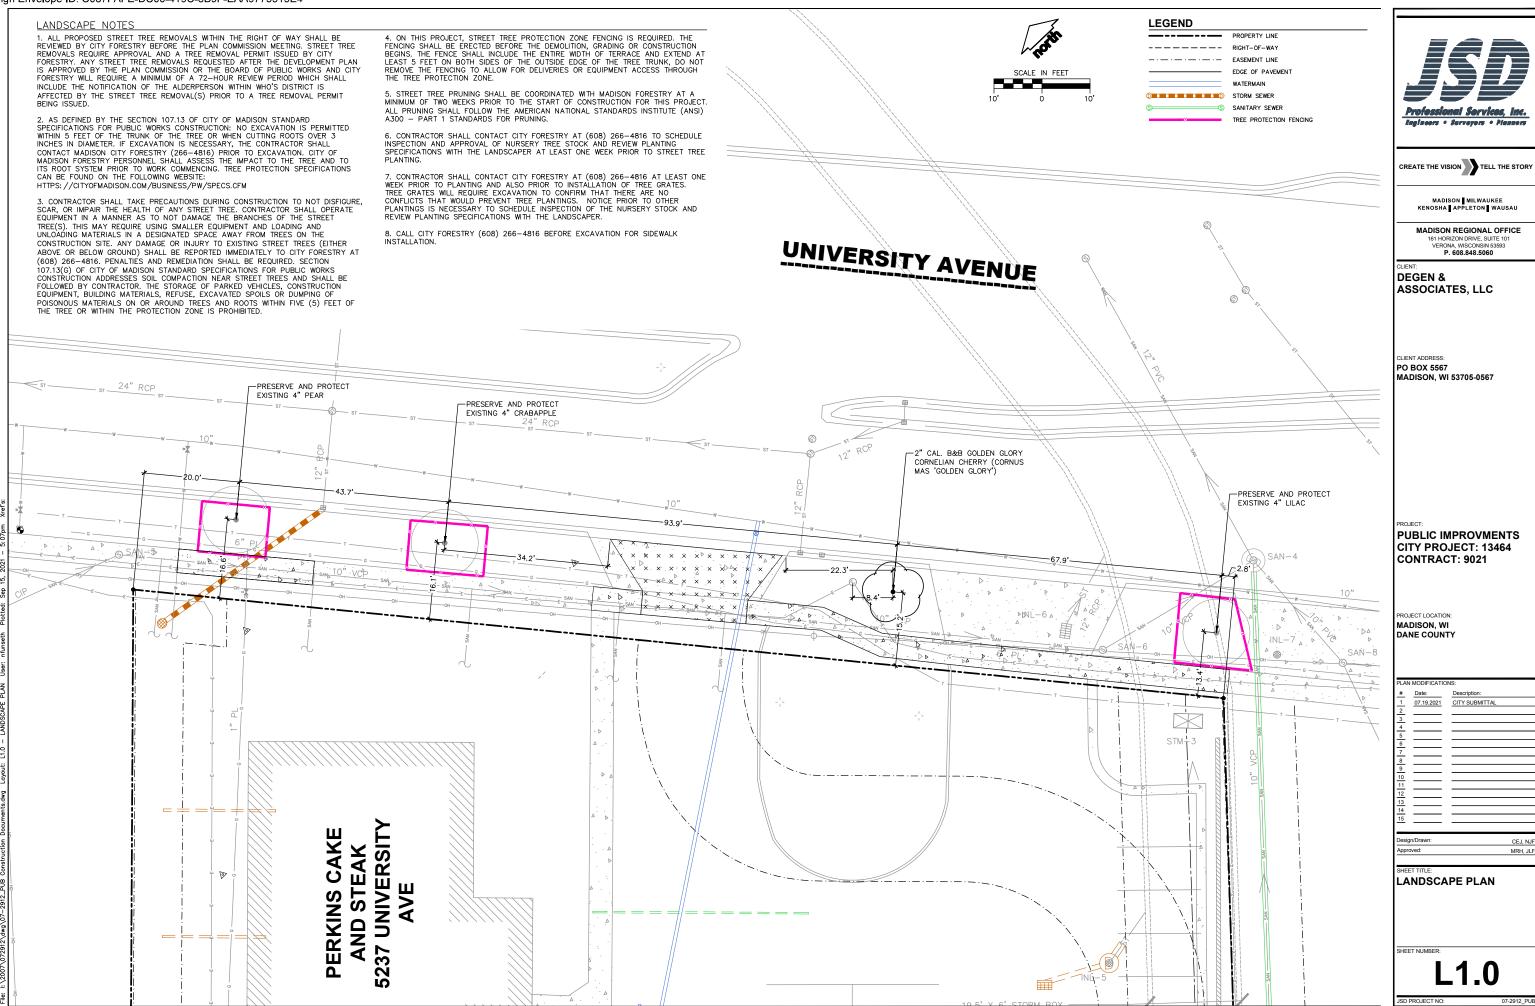

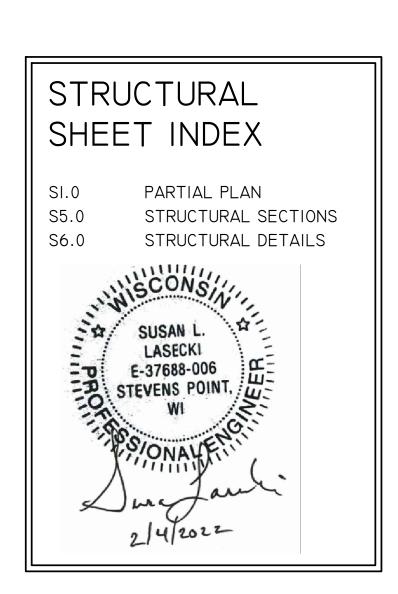

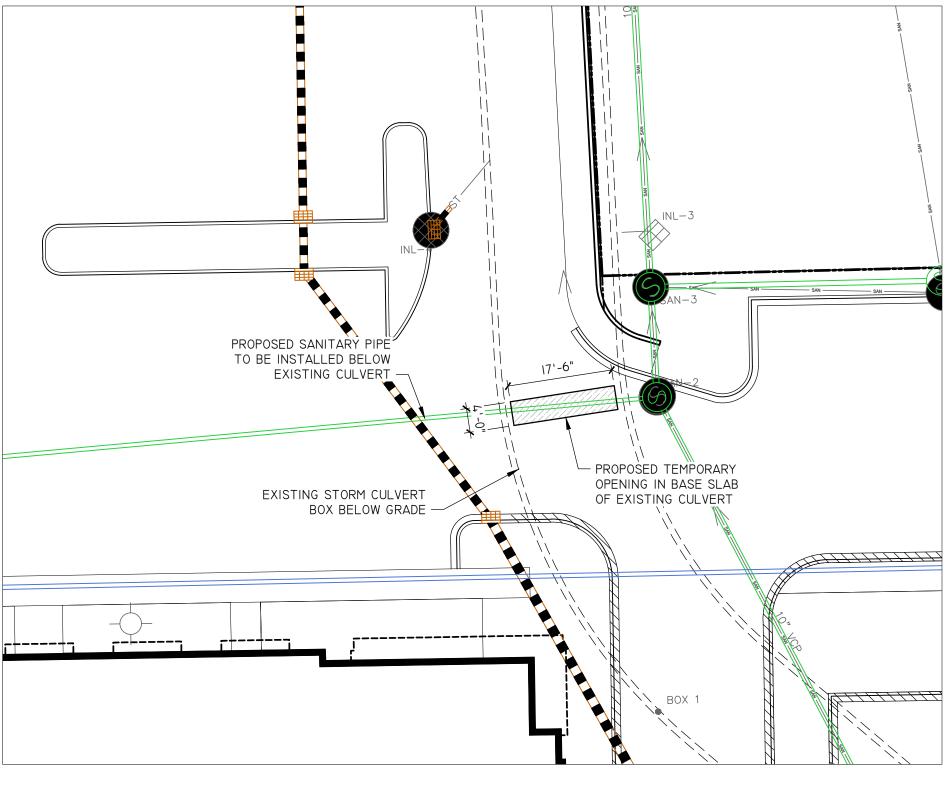

### PARTIAL PLAN

SCALE: 1/16" = 1'-0"

CAD FILE FOR SITE PLAN PROVIDED BY JSD ENGINEERING.





lonic Structures and Design, LLC P.O. Box 466 Plover, Wisconsin 54467 (414) 540-8755 Fax:(414) 921-9746 www.ionic-sd.com

CONSULTANTS

### BLIC IMPROVEMENTS Y OF MADISON TR 13464, CONTRACT 9021

DRAWING SET DESCRIPTION
PERMIT &

CONSTRUCTION	
DATE:	2/4/2021
REVISIONS	
DATE	DESCRIPTION

PROJECT No. 21-038


DESIGNED BY: SLL
DRAWN BY: SLL

SHEET TITLE

REFERENCE PLAN


SHEET No.

SI.0

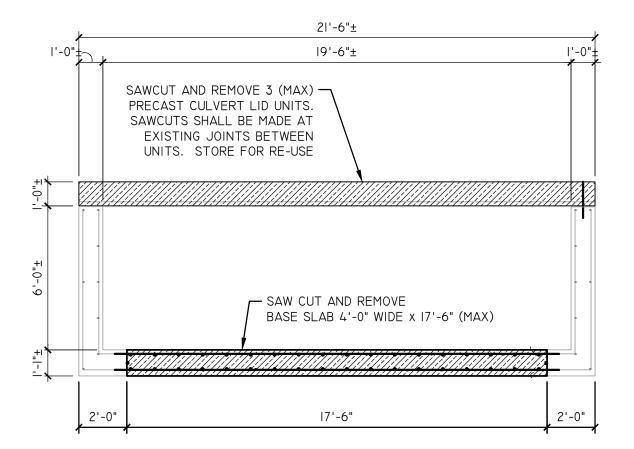

### SECTION THROUGH BOX CULVERT - DEMO

SCALE: 1/4" = 1'-0"

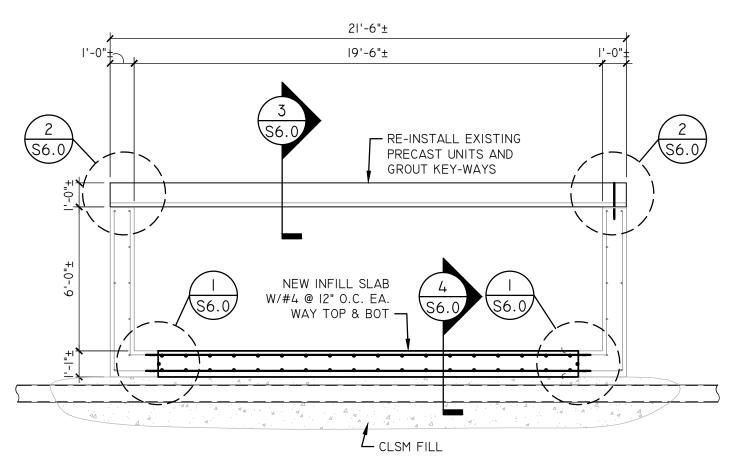

### SECTION THROUGH BOX CULVERT - NEW

SCALE: 1/4" = 1'-0"

### STRUCTURAL NOTES:

- I. ALL MATERIALS AND WORKMANSHIP SHALL CONFORM TO THE SPECIFICATIONS, UNLESS OTHERWISE NOTED.
- 2. INFORMATION REGARDING EXISTING CONDITIONS HAS BEEN OBTAINED FROM EXISTING DRAWINGS AND FIELD DIMENSIONS. THUS, INFORMATION DESIGNATED (±) ON THE DRAWINGS MUST BE FIELD



lonic Structures and Design, LLC P.O. Box 466 Plover, Wisconsin 54467 (414) 540-8755 Fax:(414) 921-9746 www.ionic-sd.com

CONSULTANTS

## PUBLIC IMPROVEMENTS CITY OF MADISON PROJECT # 134.64. CONTRACT 9021

PERMIT &
CONSTRUCTION

DATE:	2/4/2021
REVISIONS	
DATE	DESCRIPTION

PROJECT No. 21-038


DESIGNED BY: SLL
DRAWN BY: SLL


SHEET TITLE


CULVERT SECTIONS

SHEET No.

S5.0

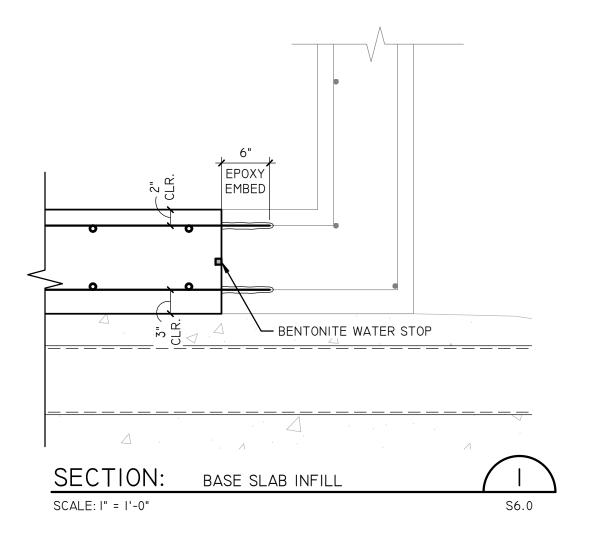

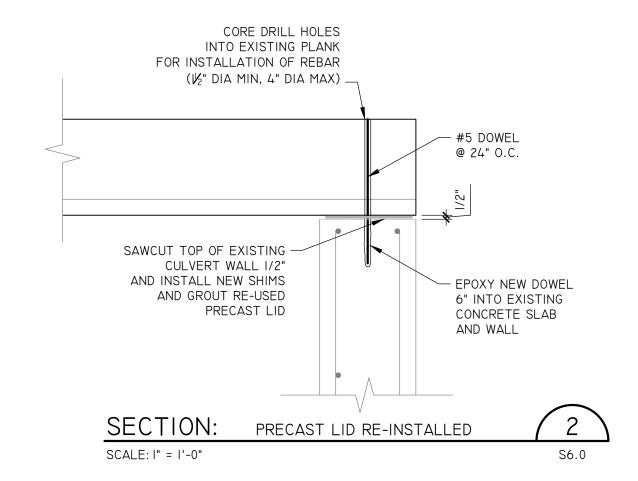


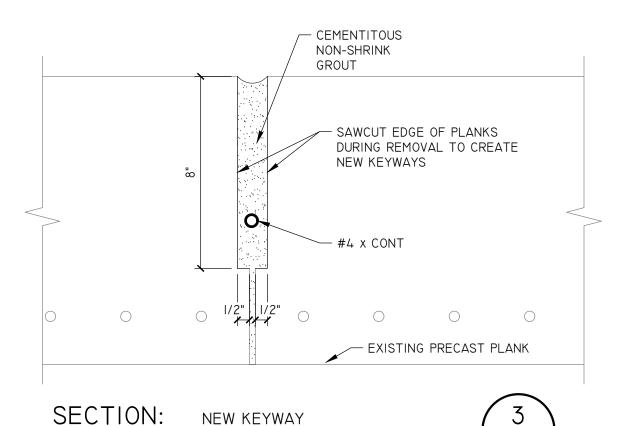

S6.0

NEW KEYWAY

SCALE: 3" = 1'-0"

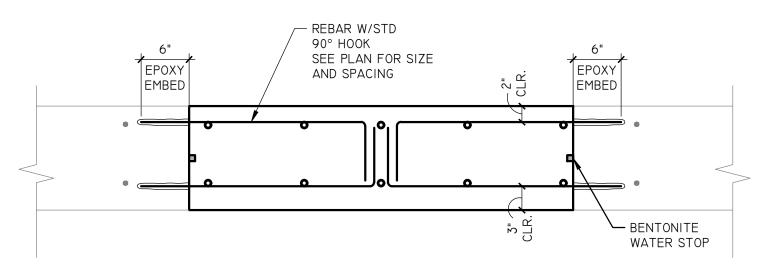

**SECTION:** BASE SLAB INFILL SCALE: I" = I'-0" S6.0



lonic Structures and Design, LLC P.O. Box 466 Plover, Wisconsin 54467 (414) 540-8755 Fax:(414) 921-9746 www.ionic-sd.com

CONSULTANTS

# PUBLIC IMPROVEMENTS CITY OF MADISON PROJECT # 13464, CONTRACT 9021 MADISON, WI

DRAWING SET DESCRIPTION
PERMIT &
CONSTRUCTION

DATE:	2/4/2021
REVISIONS	
DATE	DESCRIPTION

PROJ	JECT	Ν	٥.
21	-0	3	8

ESIGNED BY:	SLL
RAWN BY:	SLL

SHEET TITLE

### STRUCTURAL **DETAILS**

SHEET No.