

1 SITE SECTIONS - CAPITOL VIEW PIER
1"=10'-0"



Project Title and Client
MADISON PARKS
CITY OF MADISON, WI

Sasaki Project No: 48026.00
Drawn By: CZ,FS,PO,ZT
Checked By: SW,ZC
Approved By: AC
Issue Date: 07.31.2025


Seal
NOT FOR CONSTRUCTION

No.	Description	Date
1	SCHEMATIC DESIGN	10/31/2024
2	50% DESIGN DEVELOPMENT	04/30/2025
3	100% DESIGN DEVELOPMENT	07/31/2025

Drawing No.
L8-01
Drawing Title:
SKYLINE PIER SECTION

Plot Date: 7/31/2025
File: L8-00 SECTIONS.dwg

Sheet:
42
109

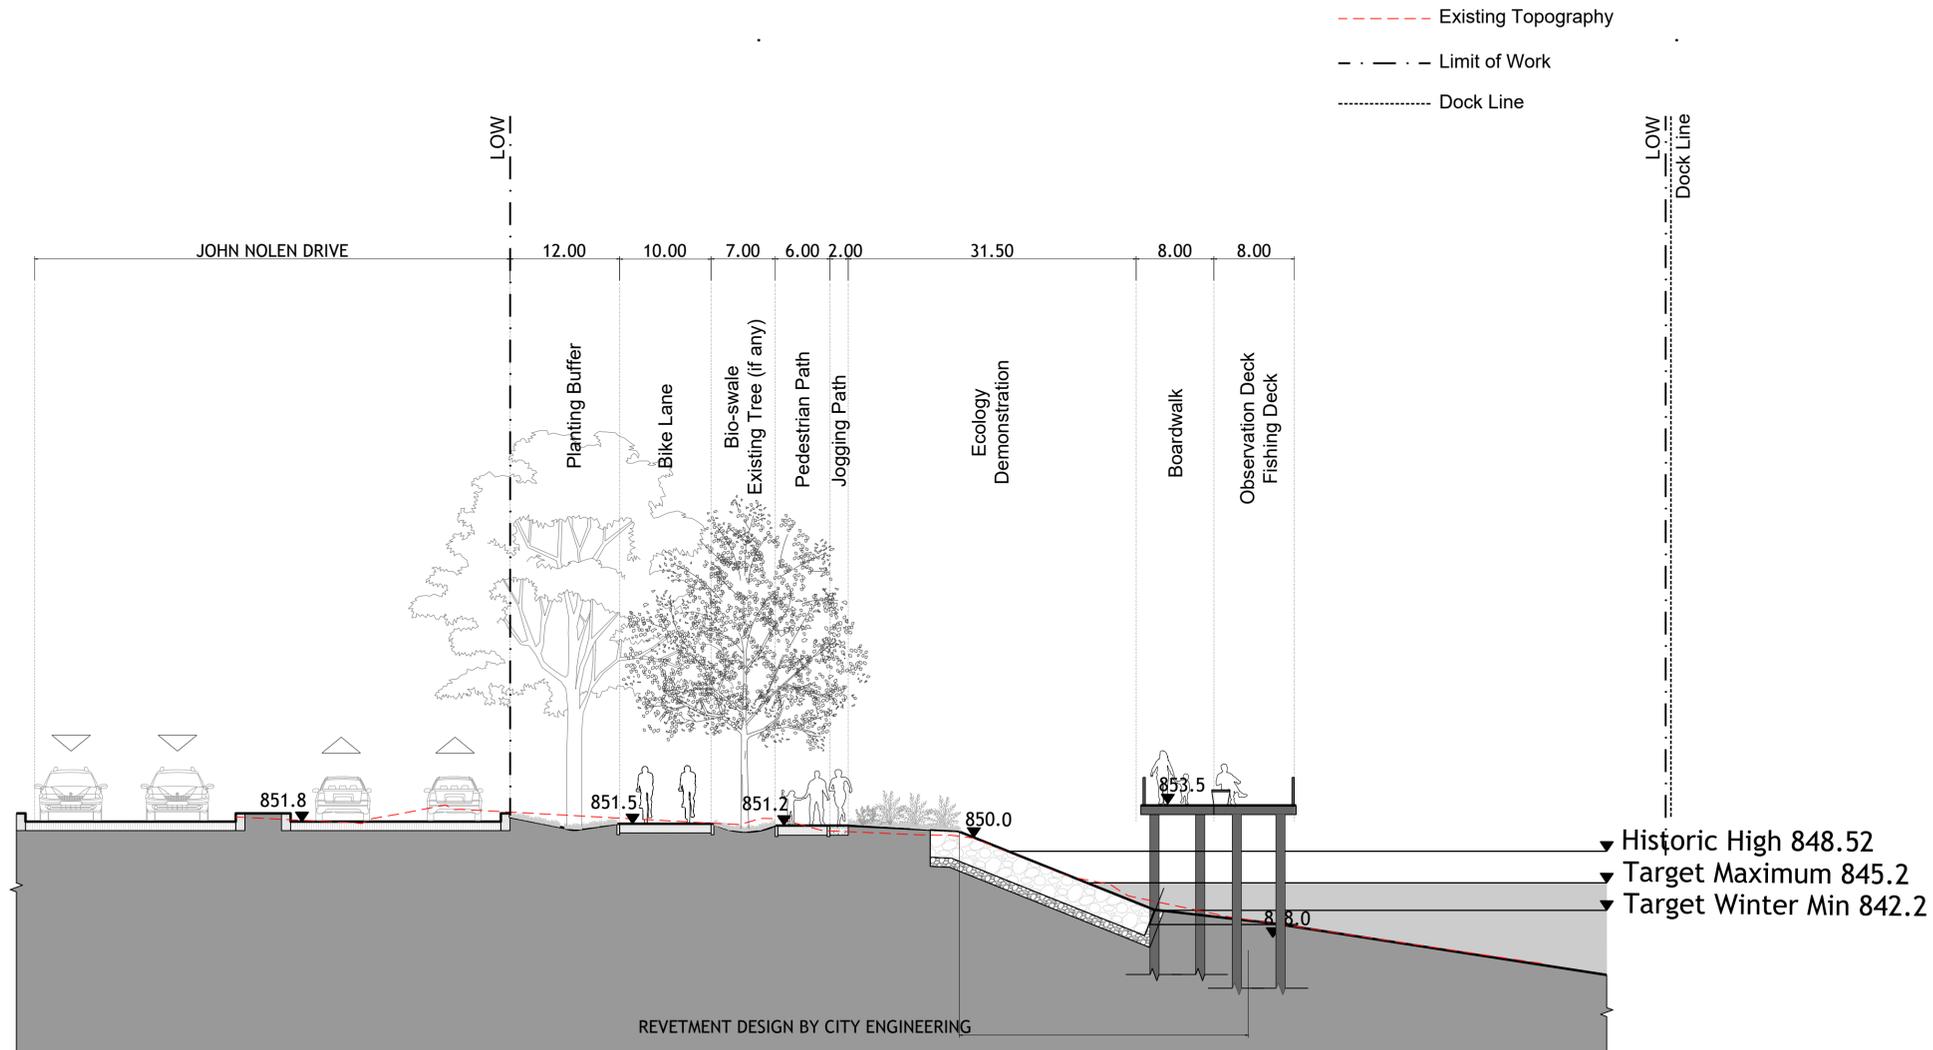

2 SITE SECTIONS - BOARDWALK
1"=10'-0"



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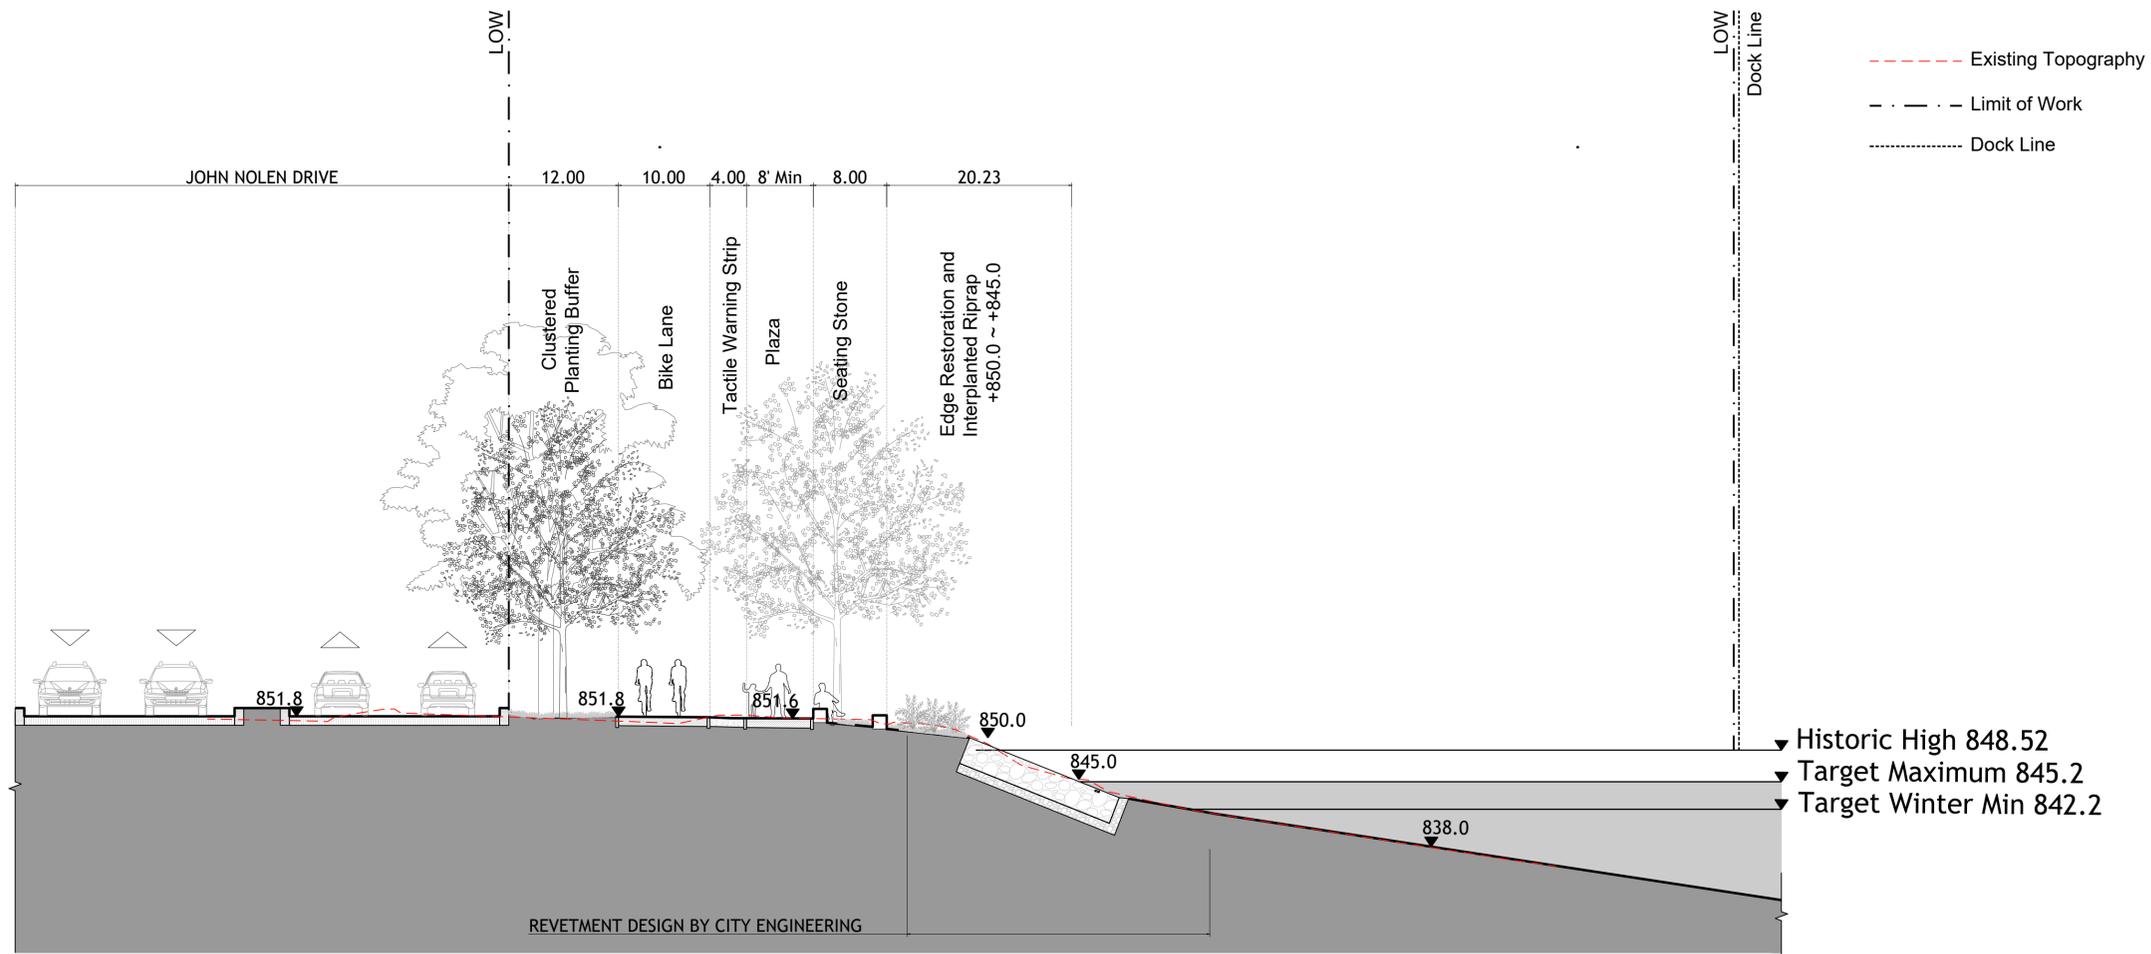
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No.	Description	Date
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2	50% DESIGN DEVELOPMENT	04/30/2025
3	100% DESIGN DEVELOPMENT	07/31/2025

Drawing No.
L8-02
Drawing Title:
BOARDWALK SECTION

Plot Date: 7/31/2025
File: L8-00 SECTIONS.dwg

Sheet:
43
109



3 SITE SECTIONS - STEP DOWN
1"=10'-0"



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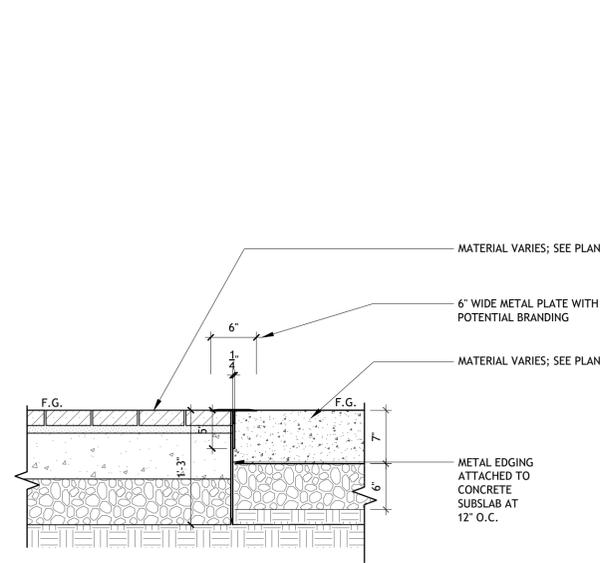
No.	Description	Date
1	SCHEMATIC DESIGN	10/31/2024
2	50% DESIGN DEVELOPMENT	04/30/2025
3	100% DESIGN DEVELOPMENT	07/31/2025

Drawing No.
L8-03


Plot Date: 7/31/2025
File: L8-00 SECTIONS.dwg

Drawing Title:
SEATING AREA SECTION


Sheet:
44
109




7 METAL PLATE - CONCRETE TO CONCRETE PA-04
1" = 1'-0" P-24-LMW-75

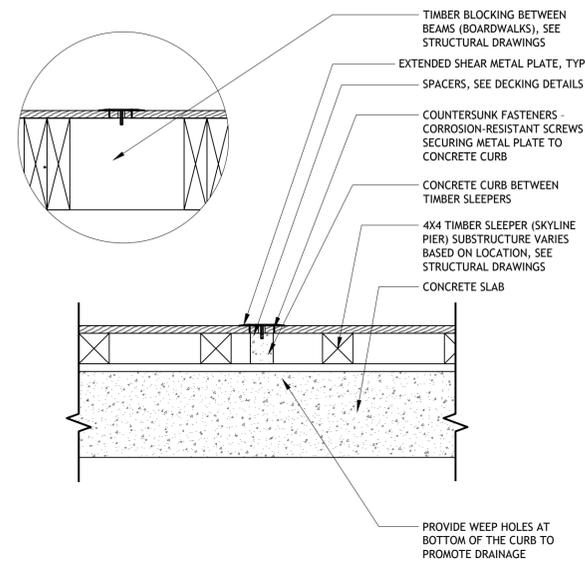

6 METAL PLATE - WOOD TO WOOD PA-03
1" = 1'-0" P-24-LMW-94

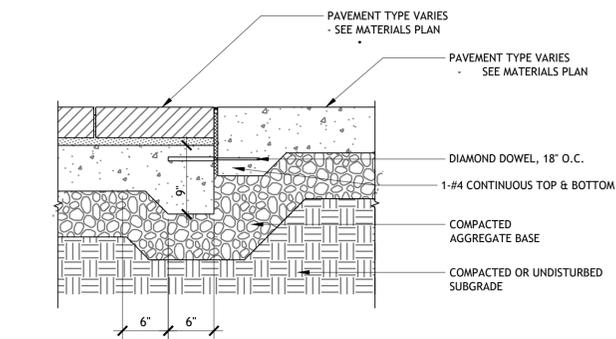


4 CONC. PAVEMENT / UNIT PAVING PA-02
1" = 1'-0" P-24-LMW-61

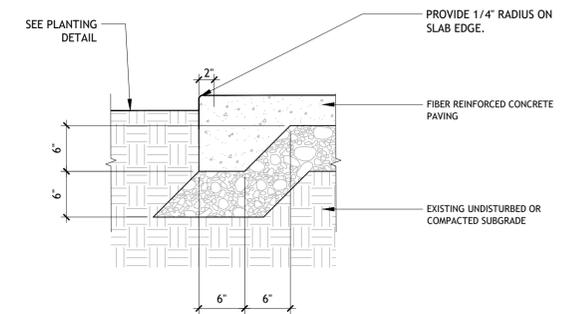


2 C.I.P CONCRETE PAVING- EDGE CONDITION P-24-LMW-67
1" = 1'-0"


NOTE:
1. TO PREVENT SMALL SLIVERS WHERE PRECAST CONCRETE PAVERS INTERSECT OPPOSITIONAL COURSING, TRIM INTERSECTING PAVERS AND ONE TO TWO PRECEDING PAVERS IN COURSE. NO PAVER SHALL HAVE AN EDGE SHORTER THAN 3".
2. THE TWO PRECEDING PAVERS SHALL BE EQUAL LENGTH.

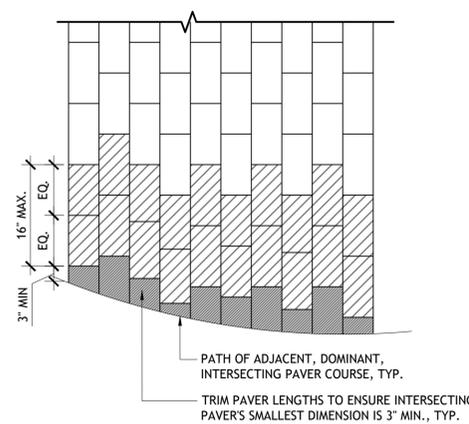


8 PRECAST CONCRETE UNIT PAVER PATTERN P-24-LMW-93
1" = 1'-0"

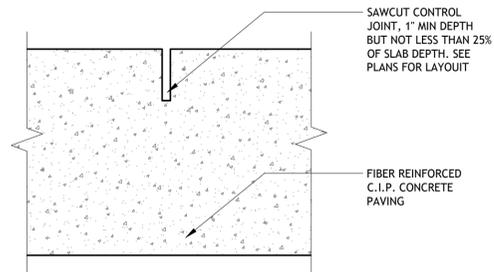

5 C.I.P. CONCRETE CONTROL JOINT JT-01
1 1/2" = 1'-0" P-24-LMW-32

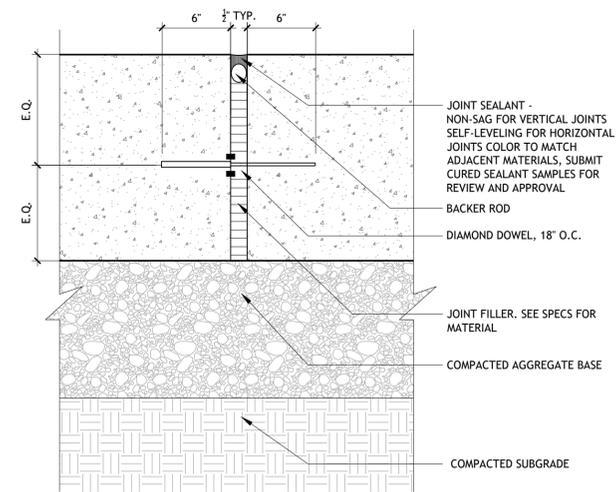

3 C.I.P. CONCRETE EXPANSION JOINT, TYP. JT-02
1 1/2" = 1'-0" P-24-LMW-60

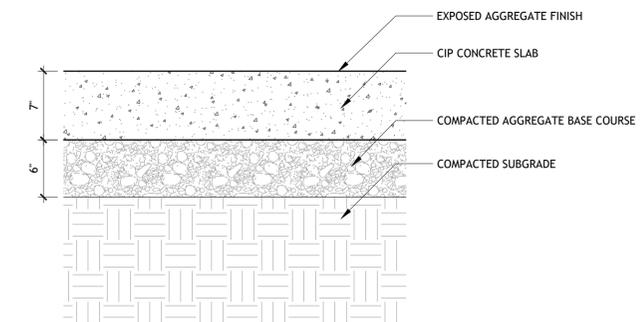


1 CONCRETE PAVING - PEDESTRIAN PA-01
1 1/2" = 1'-0" P-24-LMW-63

NOTES:
1. SEE SPECIFICATIONS FOR CONCRETE FINISH AND COLOR
2. SURFACE OF SLAB TO MEET ADA REQUIREMENTS


NOTES:
1. JOINT SEALANT COLOR SHALL MATCH COLOR OF CONCRETE AND BE APPROVED BY ARCHITECT



6 WOOD BOARDWALK - FISHING AXON 2
1" = 1'-0" P-24-LMW-08

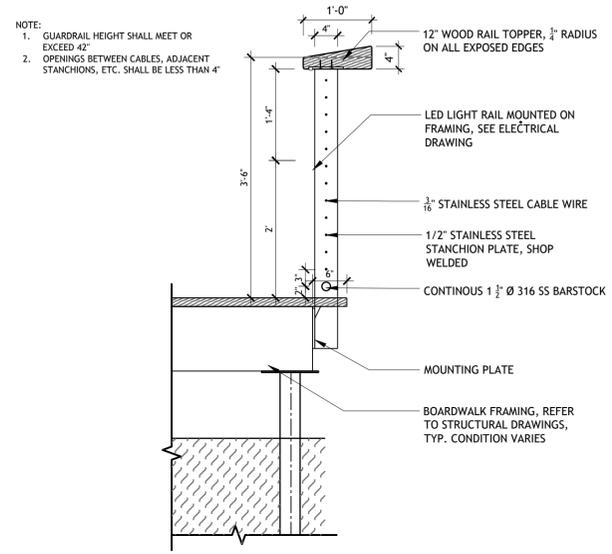


4 FISHING GUARDRAIL - HIGH
3/4" = 1'-0" P-24-LMW-65

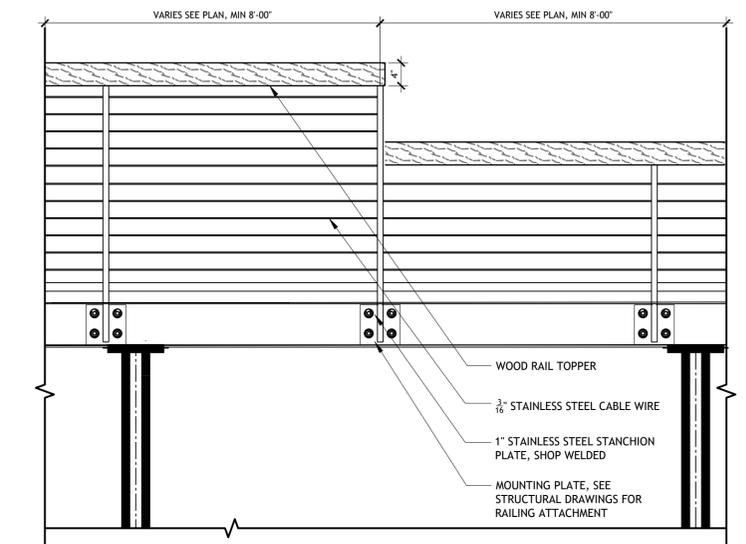


2 WOOD BOARDWALK - FISHING ELEVATION
3/4" = 1'-0" P-24-LMW-09



5 WOOD BOARDWALK - FISHING AXON 1
1" = 1'-0" P-24-LMW-07

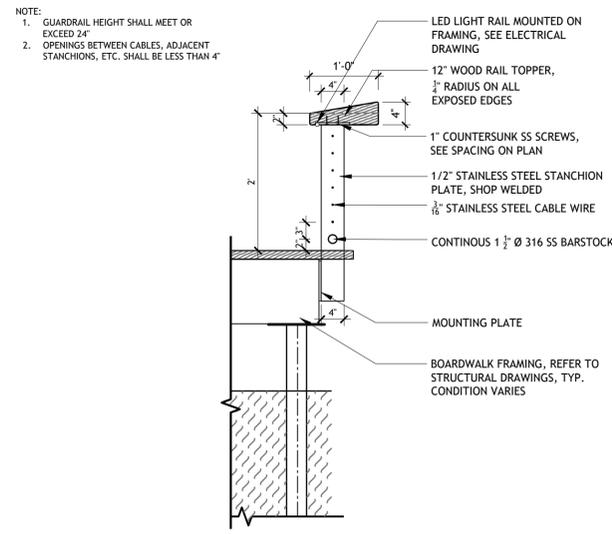

3 FISHING GUARDRAIL - LOW
3/4" = 1'-0" P-24-LMW-64

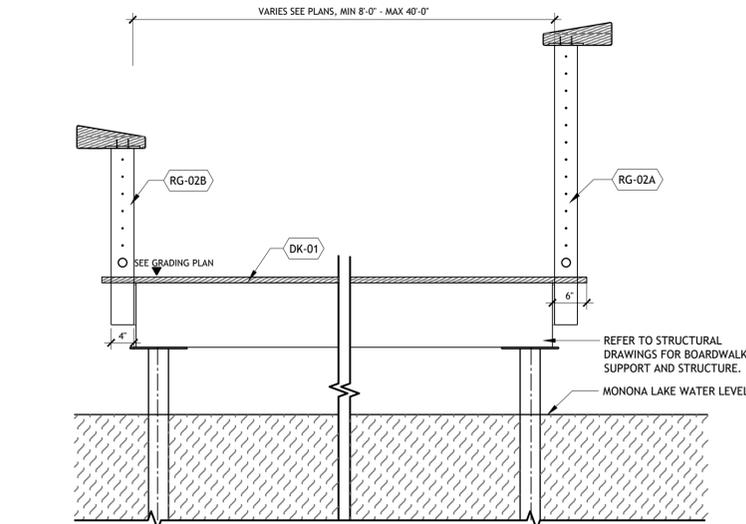

1 WOOD BOARDWALK - FISHING
3/4" = 1'-0" P-24-LMW-03




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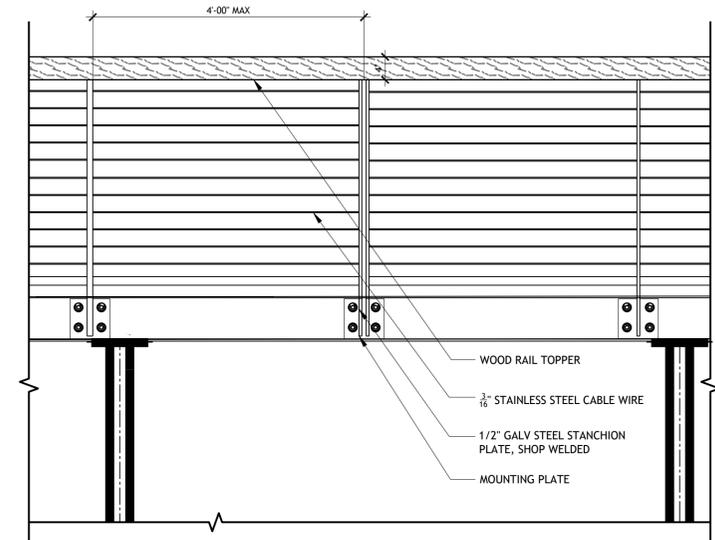
Seal
NOT FOR CONSTRUCTION

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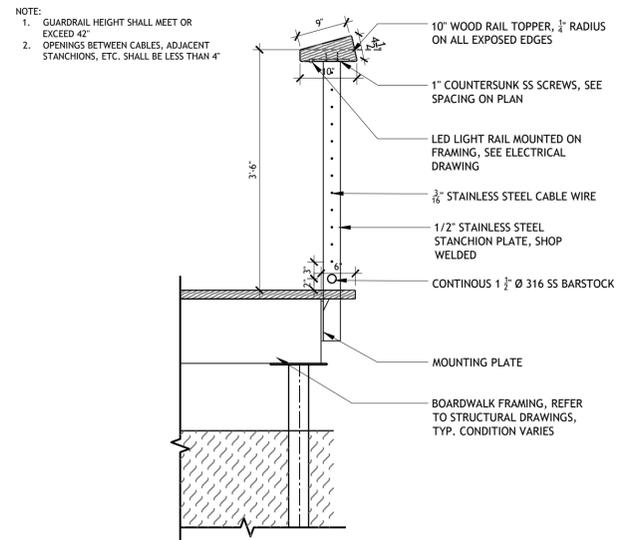
Drawing No. L9-11	Plot Date: 7/31/2025 File: L9-00 LANDSCAPE DETAILS.dwg
Drawing Title: DECK DETAILS	Sheet: 46 109



4 WOOD BOARDWALK - PEDESTIAN AXON 1
1" = 1'-0" P-24-LMW-10

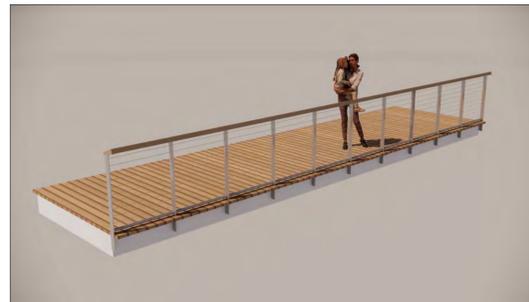

2 WOOD BOARDWALK - PEDESTRIAN ELEVATION
3/4" = 1'-0" P-24-LMW-12




NOTE:
1. GUARDRAIL HEIGHT SHALL MEET OR EXCEED 42"
2. OPENINGS BETWEEN CABLES, ADJACENT STANCHIONS, ETC. SHALL BE LESS THAN 4"


3 BOARDWALK GUARDRAIL WITH LIGHT RG-01
3/4" = 1'-0" P-24-LMW-66




5 WOOD BOARDWALK - PEDESTIAN AXON 2
1" = 1'-0" P-24-LMW-11

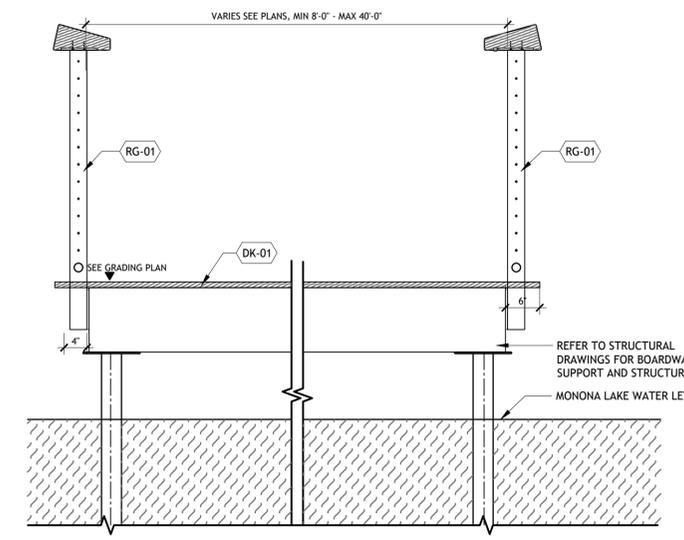


1 WOOD BOARDWALK - PEDESTRIAN
3/4" = 1'-0" P-24-LMW-06

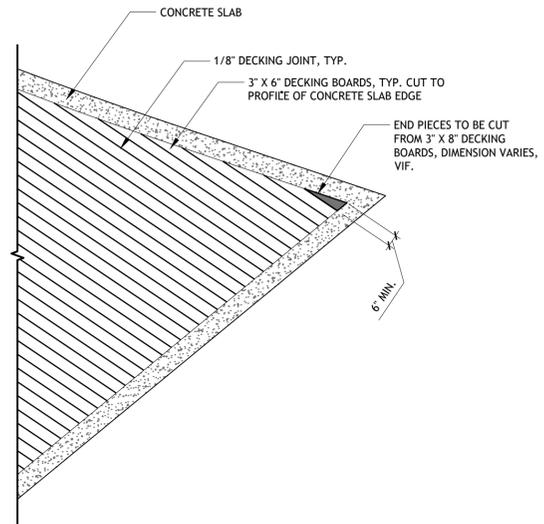


4 BOARDWALK DECKING - SKYLINE PIER **DK-03**
1/4" = 1'-0" P-24-LMW-80

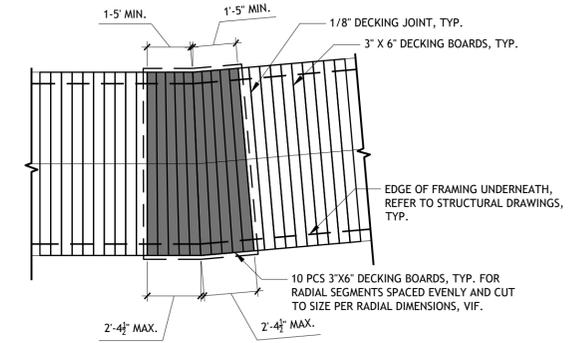

2 DECKING - PATTERN B **DK-02**
1/4" = 1'-0" P-24-LMW-74

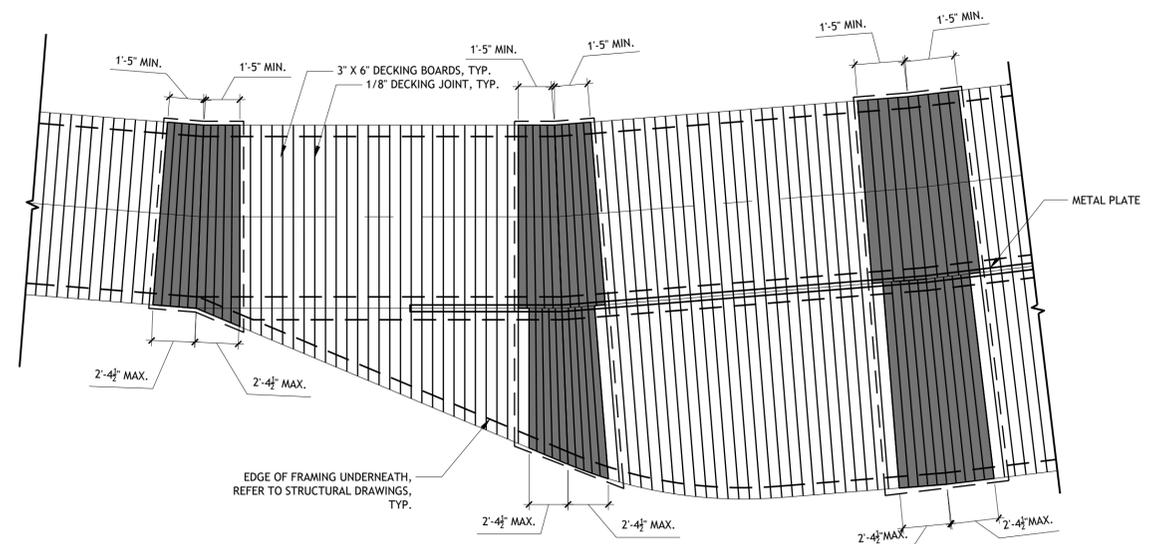

3 BOARDWALK DECKING - BUMP OUT **DK-04**
1/4" = 1'-0" P-24-LMW-79

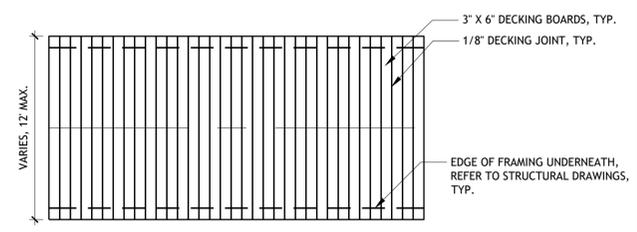

1 DECKING - PATTERN A **DK-01**
1/4" = 1'-0" P-24-LMW-71



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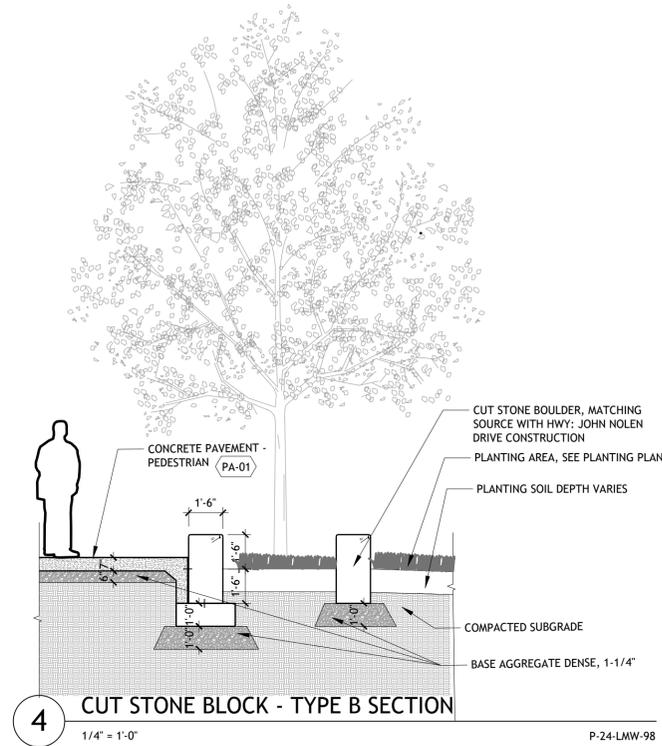
Sasaki Project No: **48026.00**
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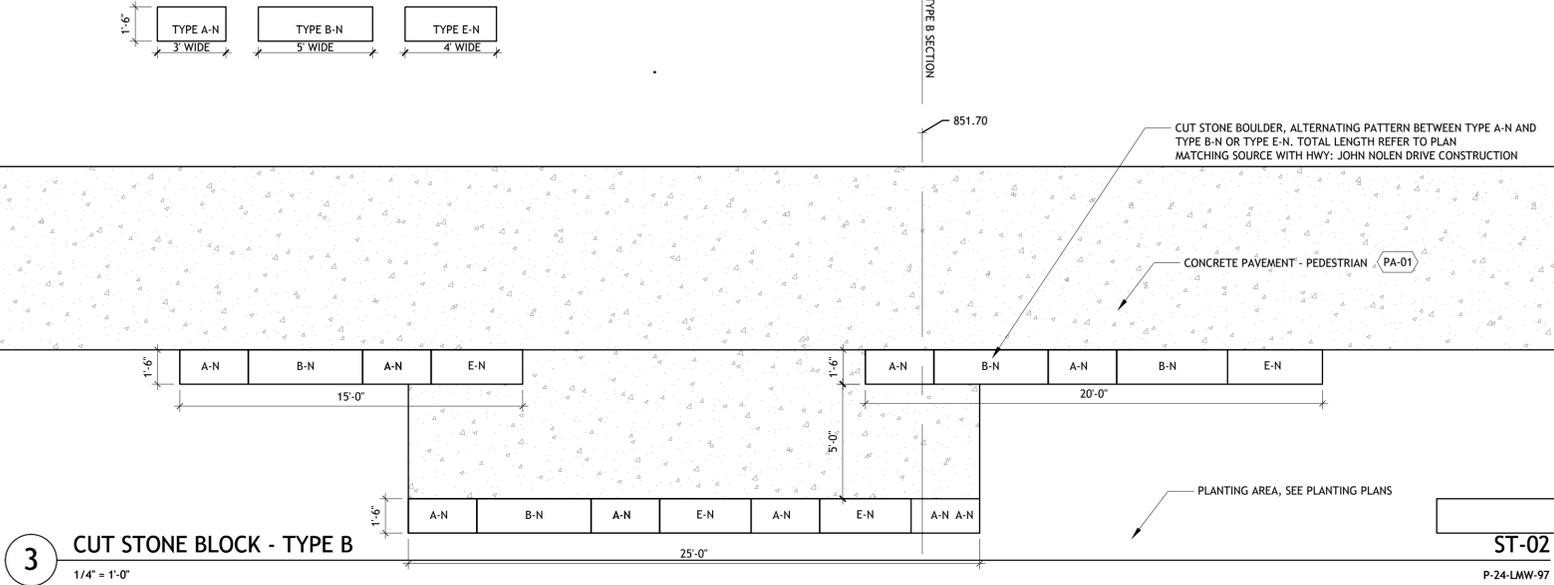
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3	100% DESIGN DEVELOPMENT	07/31/2025

Drawing No. **L9-13**
Drawing Title: **DECK DETAILS**


Plot Date: 7/31/2025
File: L9-00 LANDSCAPE DETAILS.dwg




4 CUT STONE BLOCK - TYPE B SECTION
1/4" = 1'-0"
P-24-LMW-98



3 CUT STONE BLOCK - TYPE B
1/4" = 1'-0"
P-24-LMW-97

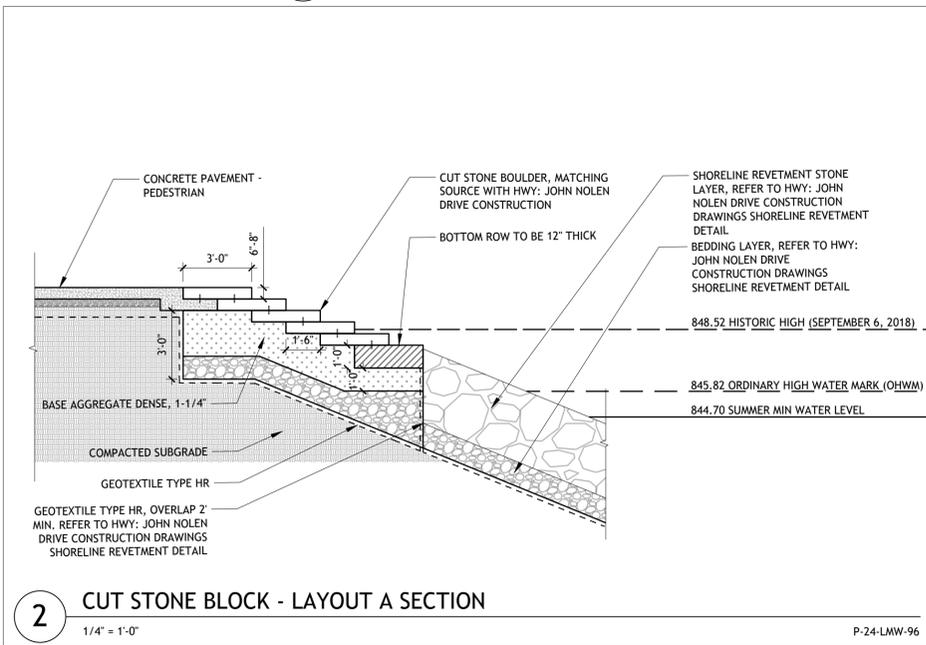

2 CUT STONE BLOCK - LAYOUT A SECTION
1/4" = 1'-0"
P-24-LMW-96

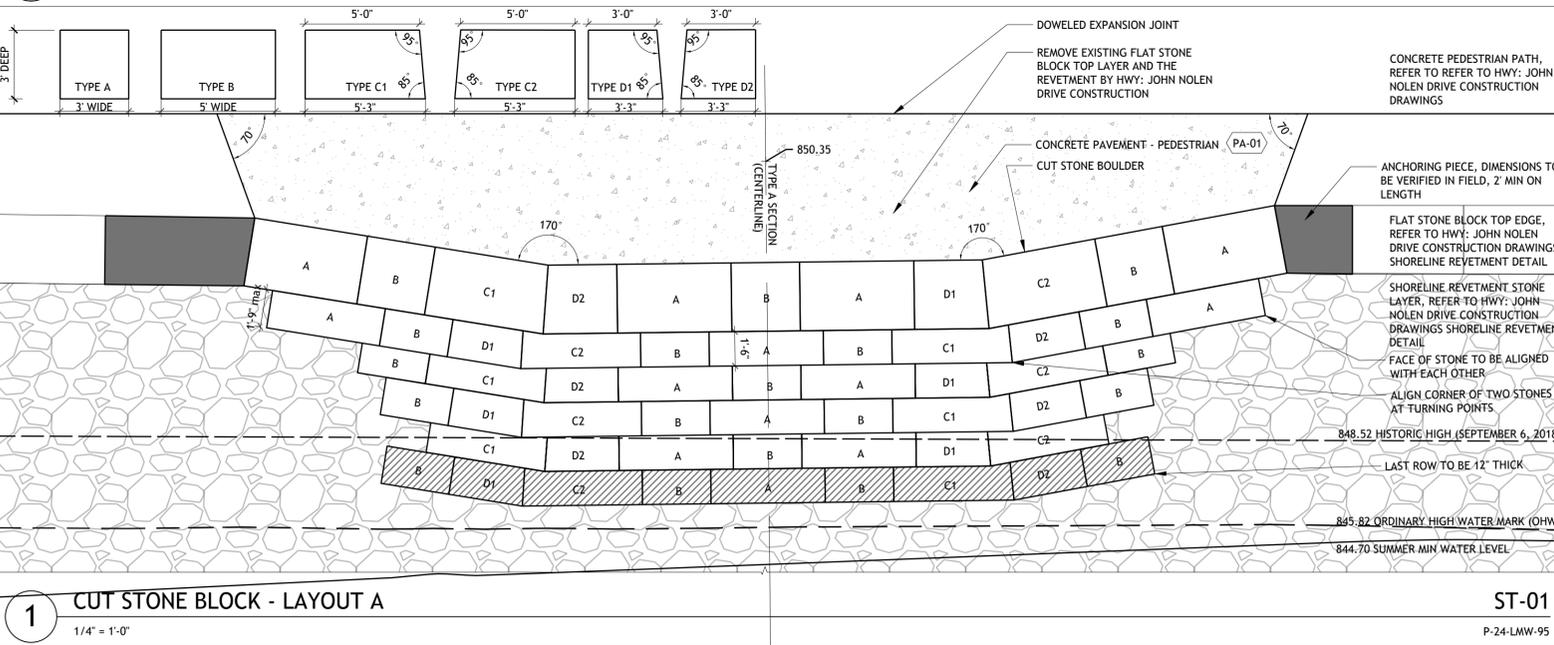

1 CUT STONE BLOCK - LAYOUT A
1/4" = 1'-0"
P-24-LMW-95




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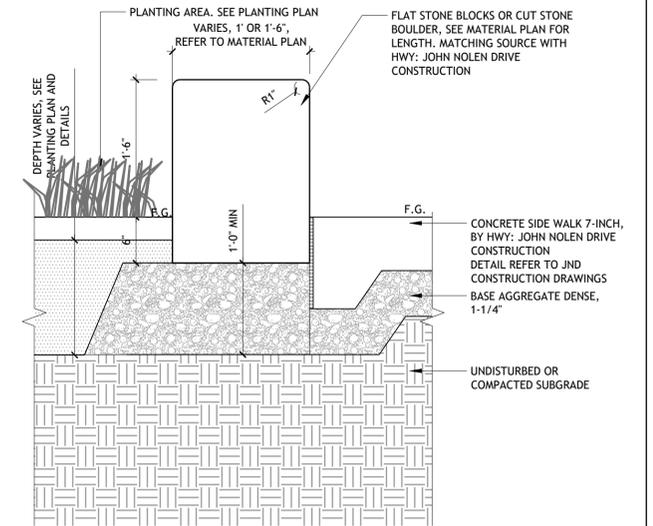
No.	Description	Date
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Drawing No. **L9-21**
Plot Date: 7/31/2025
File: L9-00 LANDSCAPE DETAILS.dwg
Drawing Title: **CUT STONE BLOCK SEATING AND STEPS DETAILS**
Sheet: **49** / **109**




2 STAIR HANDRAIL, TYP.
1" = 1'-0"

RG-03
P-24-LMW-52

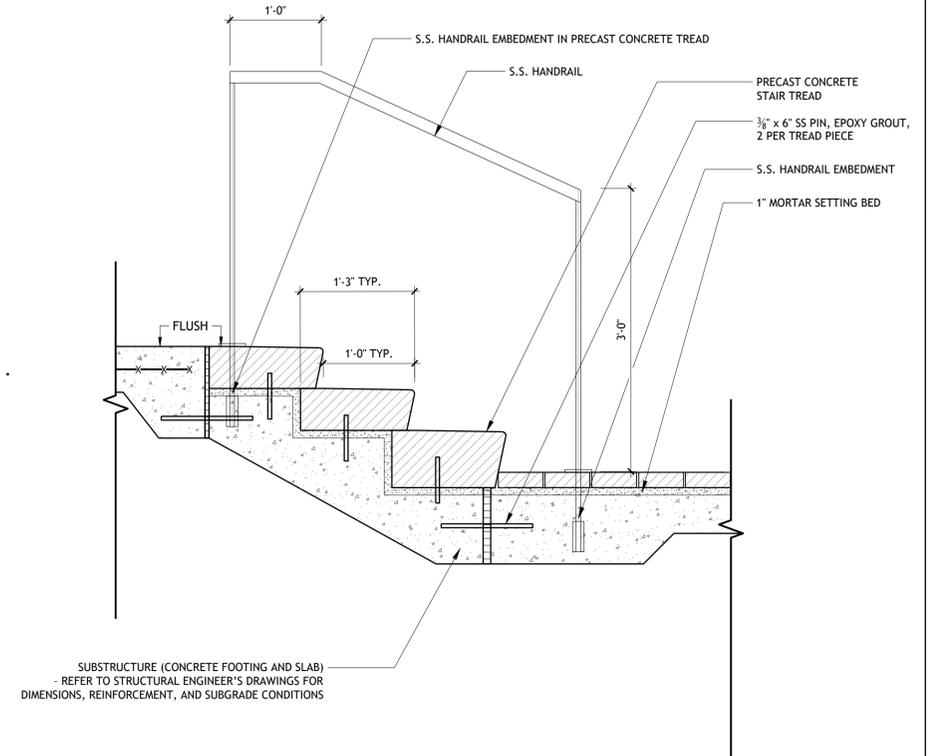


1 CUT STONE BLOCK - TYPE C
1" = 1'-0"

ST-03
P-24-LMW-53

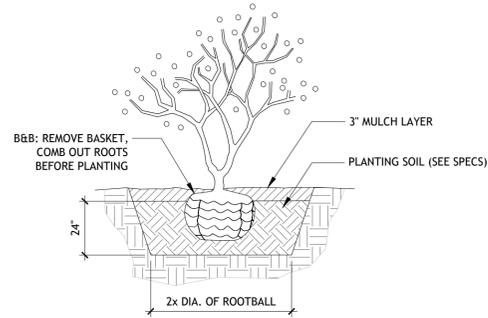


2 SHRUB
1/2" = 1'-0"

P-24-LMW-18

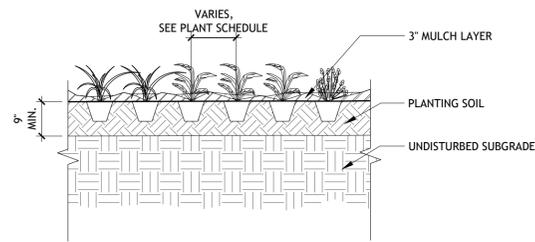

3 GROUNDCOVER
1/2" = 1'-0"

P-24-LMW-25


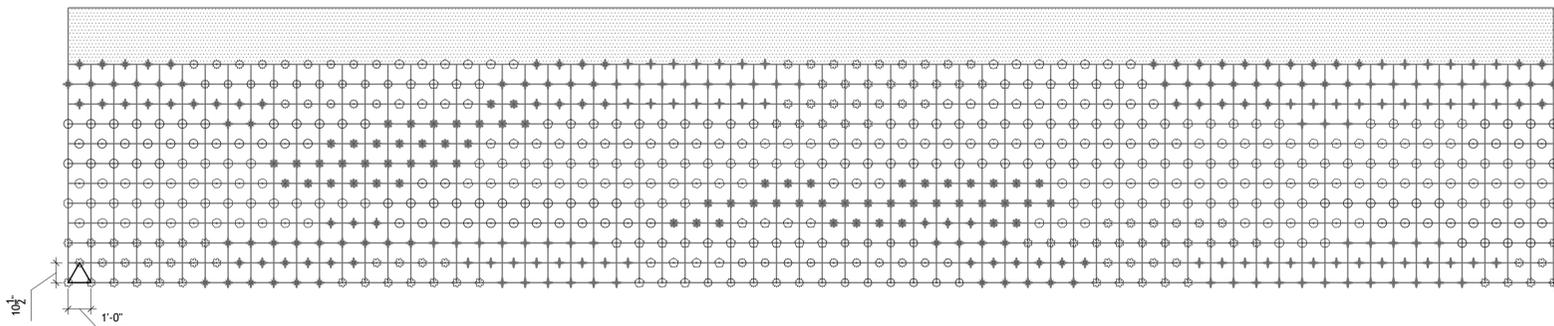


4 BIO-FILTER BASIN PLANTING LAYOUT
1/4" = 1'-0"

P-24-LMW-69


PLANT SCHEDULE			
SYMBOL	CODE	BOTANICAL NAME	COMMON NAME
BIO-FILTERED BASIN			
AC	AC	ANDROMEDEA CANADENSIS	LONGBERRY ANDROMEDEA
AM	AM	ARCTICUM TIBERIDIS	BUTTERFLY BALANIS
AV	AV	CAREX BARKANA	SEVERN STAR SEDGE
CV	CV	CAREX VULPINOSSA	FOX SEDGE
PS	PS	PRISCILLA VIRGINICA	WILD STIMMERRY
HW	HW	HELELIA MACCARTHYI	HEART JUNCEDAG
LA	LA	LACTUCA APICATA	ROCKY-BLACKING STAR
LO	LO	LORELIA SPERMATICA	SPRAT LORELIA
SP	SP	SOLEGGIO FLEORICALIS	DECAL GOLDENROD
BL	BL	THYMOPHYLLON GOLDENROD	SPY BLUE ASTER
GROUND COVER			
LD	LD	LOW-MOW FESCUE	LOW-MOW FESCUE


PATTERN REPEATS AS GRID CONTINUES
36" ENGINEERED SOIL REFER TO SPECIFICATION

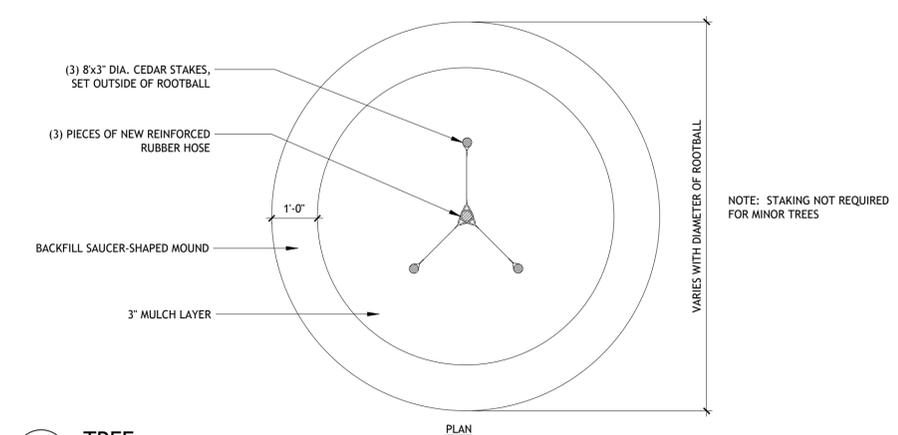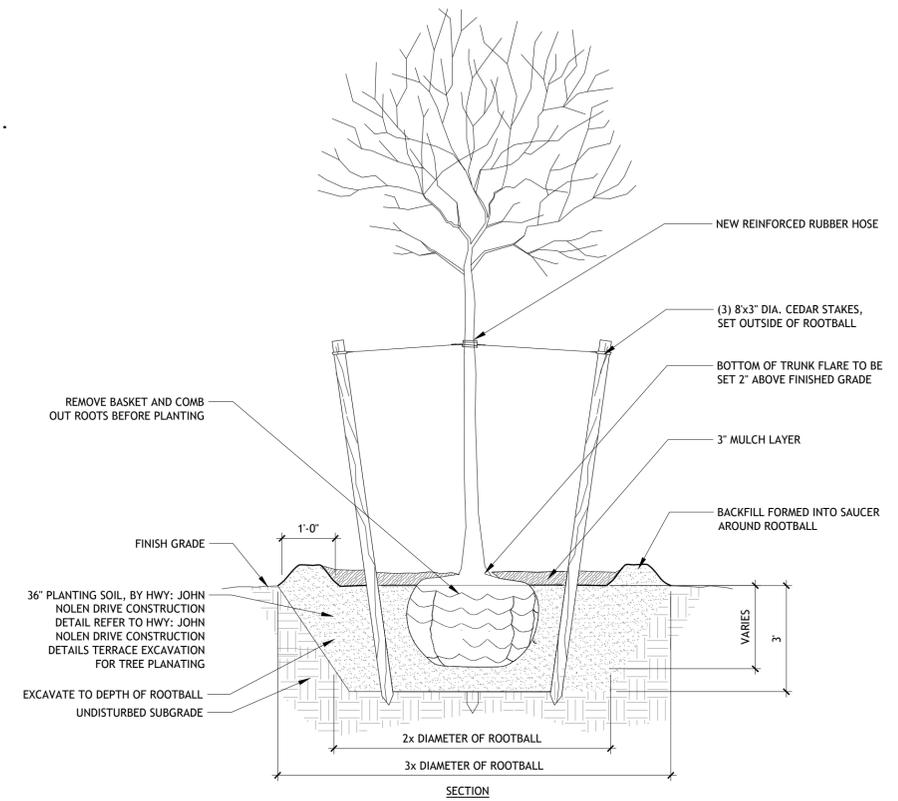


1 TREE
1/2" = 1'-0"

P-24-LMW-29

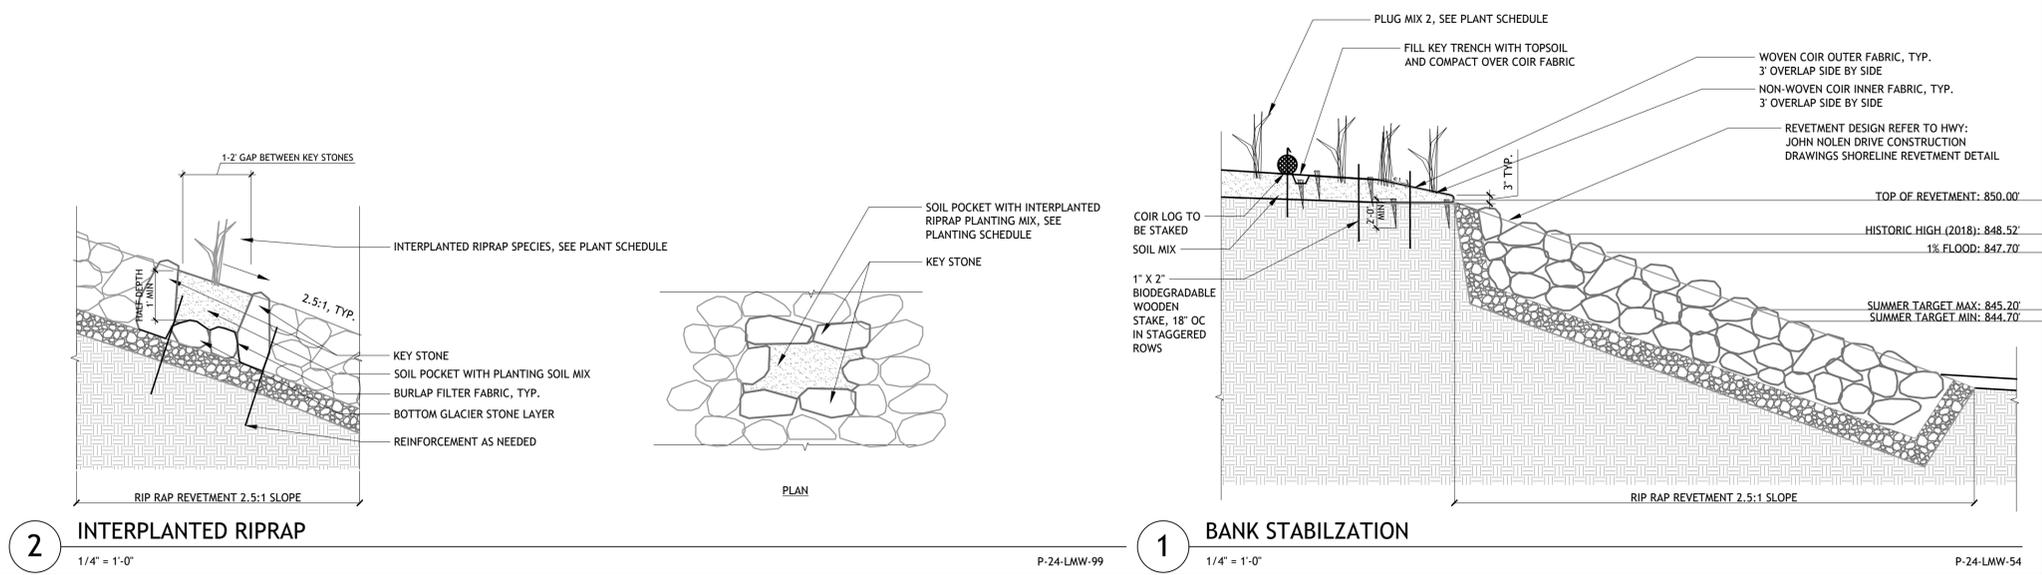


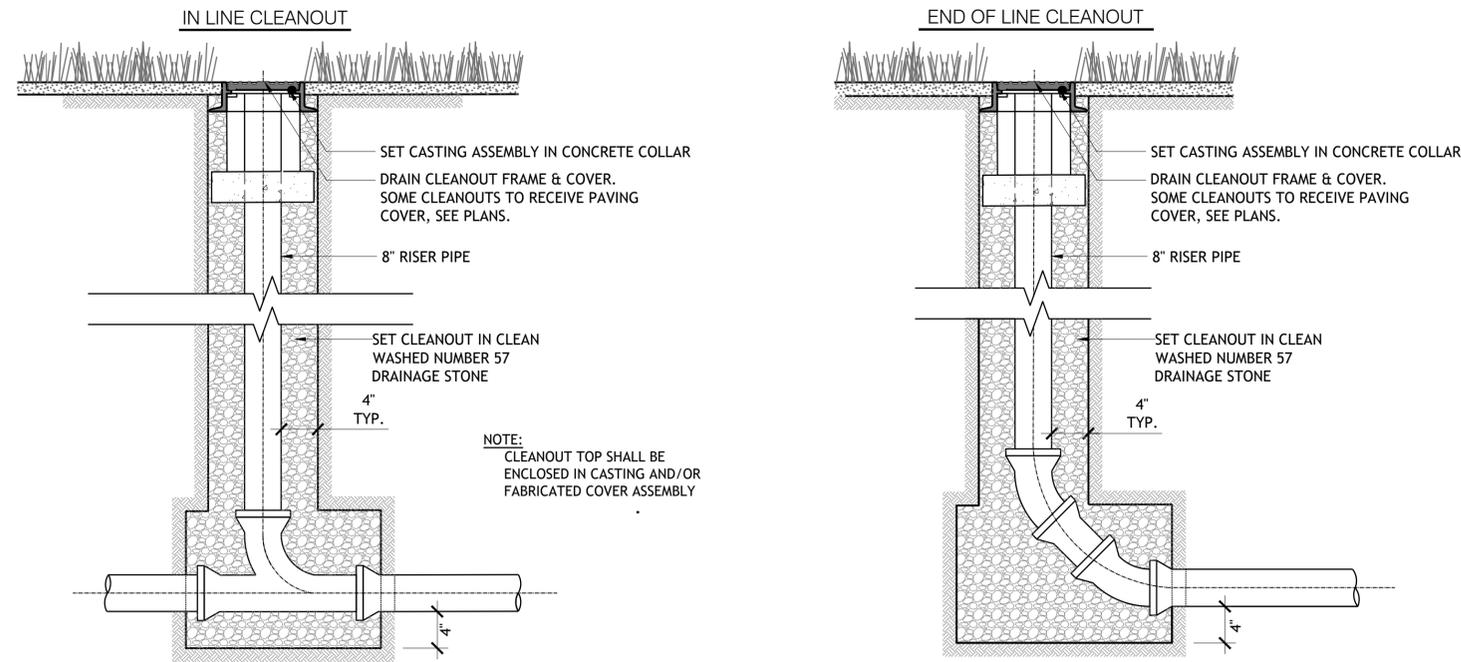


4 WYE CLEANOUT
N.T.S.

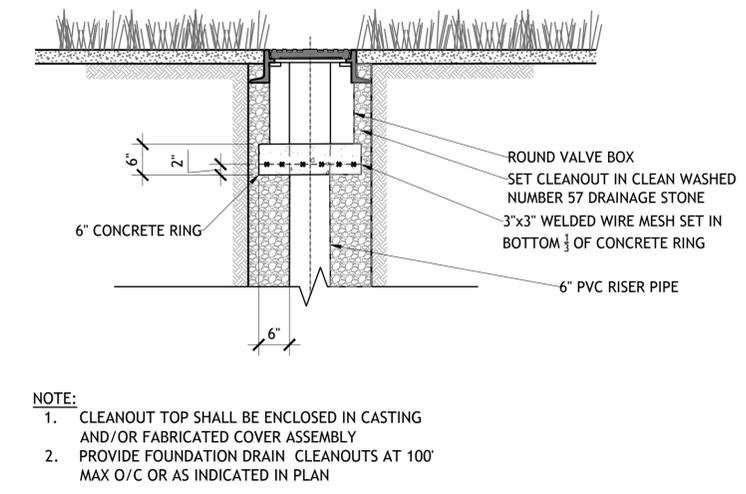

2 CLEANOUT IN PLANTING
N.T.S.

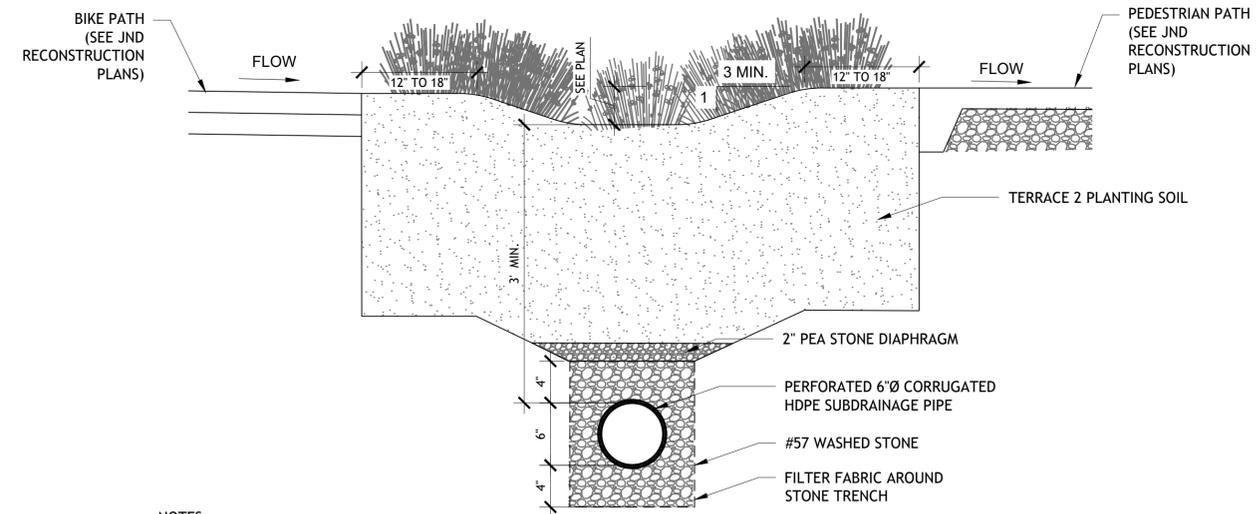

3 VEGETATED SWALE
N.T.S.

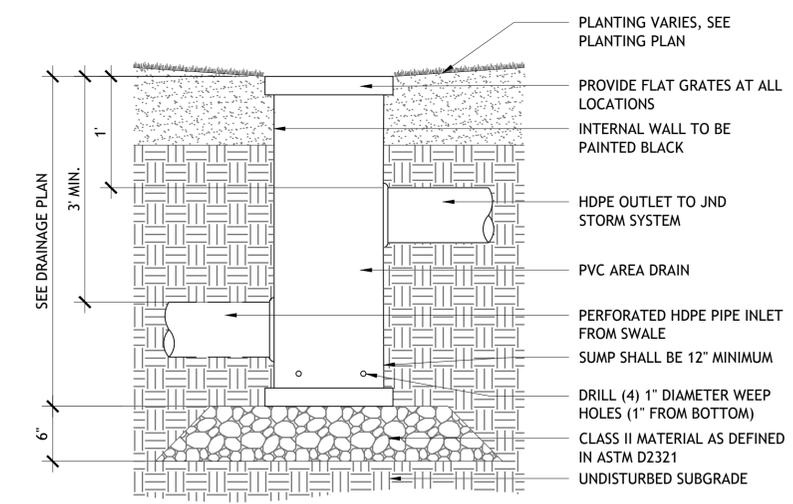

1 AREA DRAIN
N.T.S.



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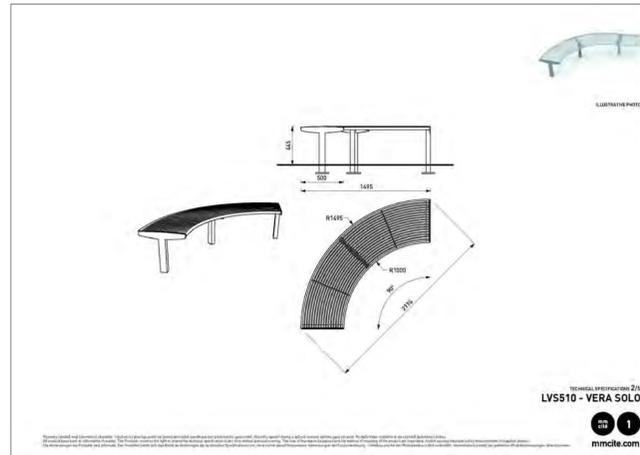
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Drawing No. **L9-33**
Drawing Title: **PLANTING DETAILS- DRAINAGE**

Plot Date: 7/31/2025
File: C0-00 CIVIL DETAILS.dwg

Sheet: **53**
109

NOTES
CURVED PARK BENCH SIMILAR TO VERA SOLO LV5510 - LV5550, MANUFACTURED BY MMCITE, OR APPROVED EQUAL



6 CURVED PARK BENCH, TYP. FS-06
NTS P-24-LMW-91

NOTES
BENCH SIMILAR TO GENERATION 50 BENCH WITH BACKREST, MANUFACTURED BY LANDSCAPEFORMS, OR APPROVED EQUAL

Generation 50 Bench

Configuration

- Quantity: 1
- Variation: Traditional
- Faceboard Style: Curved
- Arm Option: End Arms
- Support Powdercoat Color: Dusk
- Arm Style: Angled
- Mounting Option: Embedded
- Wood Type: Domestically Sourced Thermally Modified Ash (Exterior, No Finish)
- Arm Powdercoat Color: Dusk
- Back Option: Backed

4 BENCH, TYP. FS-04
NTS P-24-LMW-50

NOTES
ASH TRAY SIMILAR TO HUMO ASH URN, MANUFACTURED BY LANDSCAPEFORMS, OR APPROVED EQUAL

Humo Ash Urn
Product Data Sheet

Strong, high capacity, easy to maintain. A stainless steel urban ashtray that's stately but not ostentatious.

Style	Depth	Width	Height	Weight
Ash Urn	5"	N/A	38"	23 lb.

Ash Urn

- Capacity: 1.25 gallon
- Ash urn comes in a stainless steel brushed finish.
- Ash urn must be surface mounted.
- Base plate made of a 3/4" thick carbon steel.

Finishes


- Polished stainless steel finish.

Designed by Urbideormis

[Click here](#) for patent information related to this product.

2 ASH TRAY, TYP. FS-02
NTS P-24-LMW-49

NOTES
MODULAR EXTENDED BENCH SIMILAR TO VERA SOLO, MANUFACTURED BY MMCITE, OR APPROVED EQUAL

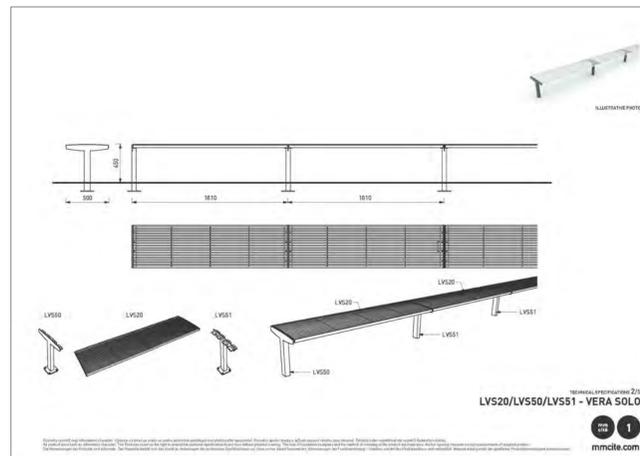

5 MODULAR EXTENDED BENCH, TYP. FS-05
NTS P-24-LMW-90

NOTES
BIKE RACK SIMILAR TO KEY, FINISH: ANTHRACITE GREY, MANUFACTURED BY LANDSCAPEFORMS, OR APPROVED EQUAL

Key Bike Rack

Date: September 8, 2016
www.landscapeforms.com P: 800-821-5546

Tools Required

- UNIT SHIPS ASSEMBLED

INSTALLATION:

1. Set bike rack in position and mark hole locations.
2. Core drill 1-1/4" diameter (minimum) holes 6" deep.
3. Prepare the holes for outdoor anchoring cement, such as Kwikset™ or Super-Pow-rak™. Follow the manufacturer's instructions for blowing out dust, filling with water, scrubbing, and removing excess water.
4. Fill the holes with anchoring cement and place the bike rack back into position.

Recommended spacing, according to Association of Pedestrian and Bicycle Professionals (APBP)

Optional bike rack spacing

HANDLE WITH CARE! Key's finish can be scratched by contact with tools, concrete, or other abrasive surfaces. Protect the finish from damage during installation. Use touch-up paint to repair any powder coat finish abrasions.

3 BIKE RACK, TYP. FS-03
NTS P-24-LMW-48

NOTES
TRASH RECEPTACLES SIMILAR TO COURTYARD TRASH CANS, MANUFACTURED BY ULINE, OR APPROVED EQUAL

COURTYARD TRASH CANS


An attractive, vandal-proof hideaway for trash.

- For parks, offices and city streets.
- Slatted steel bars deter vandalism.
- Weather and rust-resistant, powder-coat finish.
- Includes black plastic liner and anchor kit.
- H-5171 - Bonnet lid keeps out rain and snow.


MODEL NO.	DESCRIPTION	CAPACITY	SIZE DIAM. x H	WT. (LBS.)	PRICE EACH		ADD TO CART
					1	2+	
H-2865	Flat Lid	36 Gallon	28 x 36"	93	\$755	\$725	Specify Color
H-5171	Bonnet Lid	36 Gallon	28 x 36"	96	830	800	Specify Color

SHIPS ASSEMBLED VIA MOTOR FREIGHT

1 TRASH RECEPTACLES, TYP. FS-01
NTS P-24-LMW-51

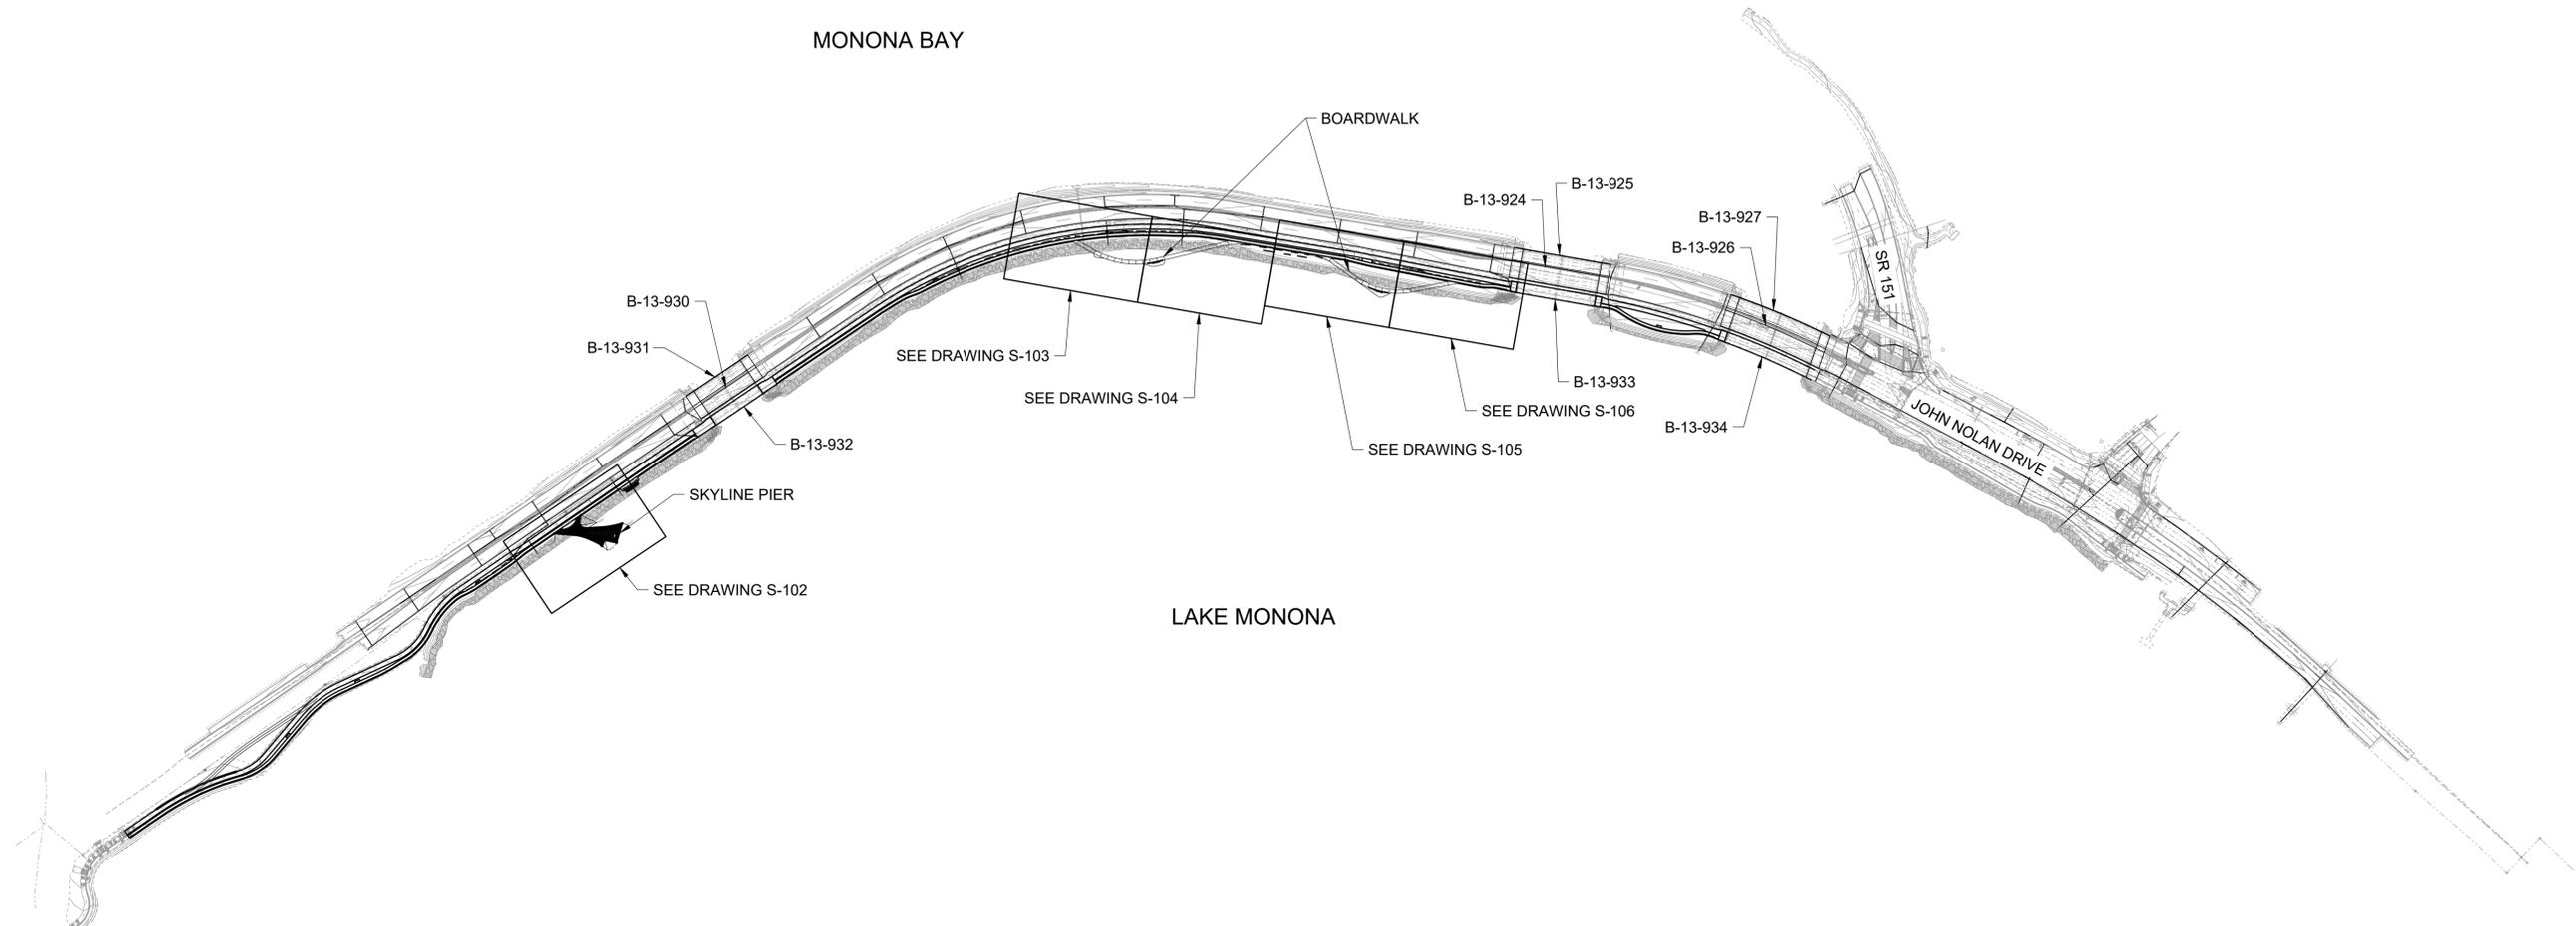

Project Title and Client
MADISON PARKS
 CITY OF MADISON, WI

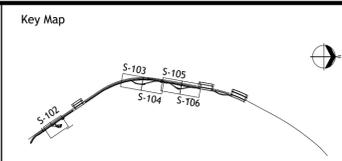

Sasaki Project No: **48026.00**
 Drawn By: **WT**
 Checked By: **JS**
 Approved By: **MW**
 Issue Date: **07.31.2025**

Seal
NOT FOR CONSTRUCTION

No.	Description	Date
1	SCHEMATIC DESIGN	10/31/2024
2	50% DESIGN DEVELOPMENT	04/30/2025
3	100% DESIGN DEVELOPMENT	07/31/2025

Drawing No. **S-100**
 Drawing Title: **OVERALL SITE PLAN**
 Plot Date: 7/31/2025
 File: 231950015-100.dwg

Sheet: **58**
109

