

Milwaukee, WI

Madison, WI

The Gallina Corporation VICINATO APARTMENTS

Intelligent Designs

nspired Results

2310 Crossroads Drive

Madison, WI 53718

TEL 608 240-9900

FAX 608 240-9690

www.prarch.com

Suite 2000



N

Location Map

The Gallina Corporation
Vicinato Apartments
PRA # 120399-01
07-31-13

PD-SIP Submittal

Vicinato Apartments 107 S. Mills Street Madison, WI 53715

Drawing Index

Title Sheet

Architectural

200 Site Plan
201 Lower Level Plan
202 Entrance Plan
203 Typical Floor Plan
204 Fourth Floor Plan
400 Elevations

Civil Engineering

C-100 Existing Conditions
C-101 Demolition Plan
C-102 Site Plan
C-103 Grading & Erosion Control Plan
C-104 Utility Plan

Landscape

L-1 Landscape Plan

Site Lighting

SL-1 Site Illumination Plan - Grade SL-1 Site Illumination Plan - Tresspass

Project Information

Applicable Codes and Zoning

Wisconsin enrolled commercial building code 2011
Residential occupancy, Group R-2
Storage occupancy, Group S-2
Zoning: City of Madison ordinances

Type of Construction

New Construction
Lower Level and 1st Floor, protected, type IA - Sprinklered - NFPA 13R
1st - 4th Floor, protected, type VA - Sprinklered - NFPA 13R

Building Area

 Garage
 16,691 SQ. FT.

 Lower Level
 6,172 SQ. FT.

 Typical Level
 15,757 SQ. FT.

 Typical Level
 15,757 SQ. FT.

 Typical Level
 15,757 SQ. FT.

 4th Floor
 10,628 SQ. FT.

 Total
 80,768 SQ. FT.

Total Unit Count

Efficiency 3
One-Bedroom 47
Two-Bedroom 24

Parking Requirements

Automobile Parking Required by Zoning

.96 per Unit = 71
Bicycle Parking Required by Zoning

1 per Unit = 74

| Parking | Wall | Regular | Accessible | Van | Total | |
|------------|-------|---------|------------|------------|--------|--|
| Provided | Racks | Stalls | Stalls | Accessible | Stalls | |
| Automobile | | 69 | 2 | 0 | 71 | |
| Bicycle | 12 | 62 | | | | |

Project Team

OWNER

The Gallina Corporation

ARCHITECT

Plunkett Raysich Architects

SITE/CIVIL


Burse Surveying and Engineering, Inc

LANDSCAPE


Bruce Company

LIGHTING

Hein Engineering

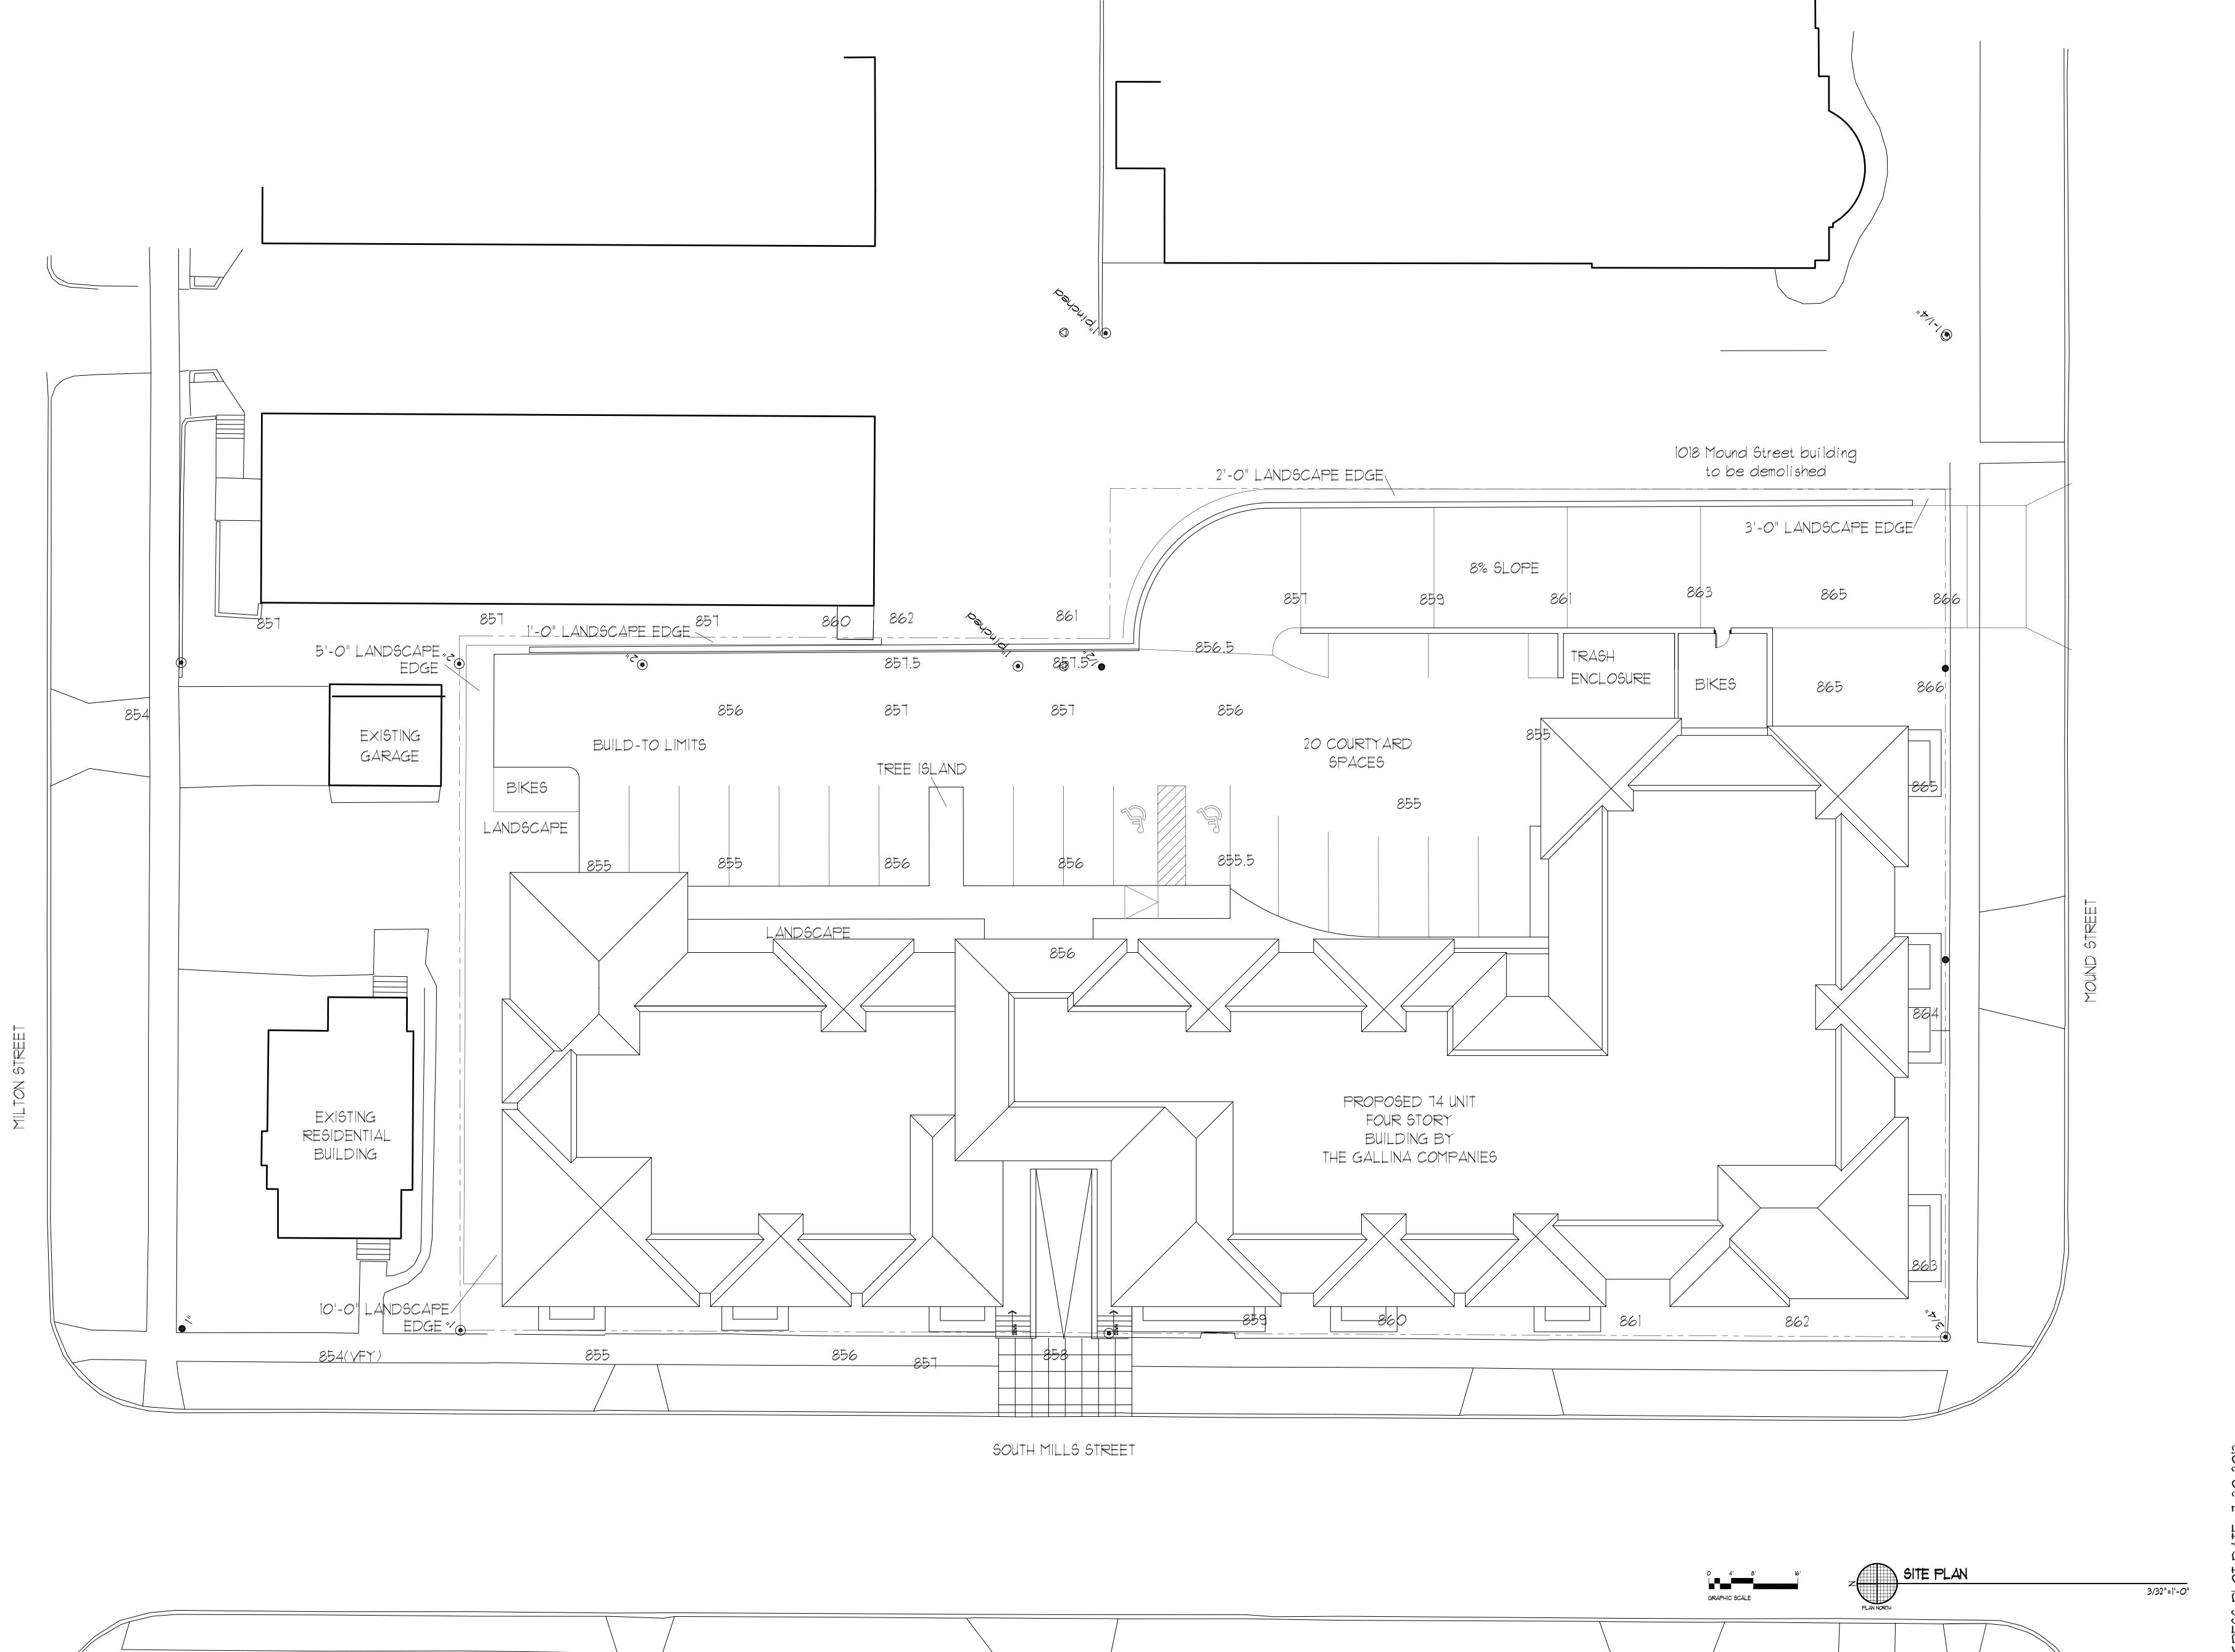


Vicinato Apartments
The Gallina Companies Drawn By:

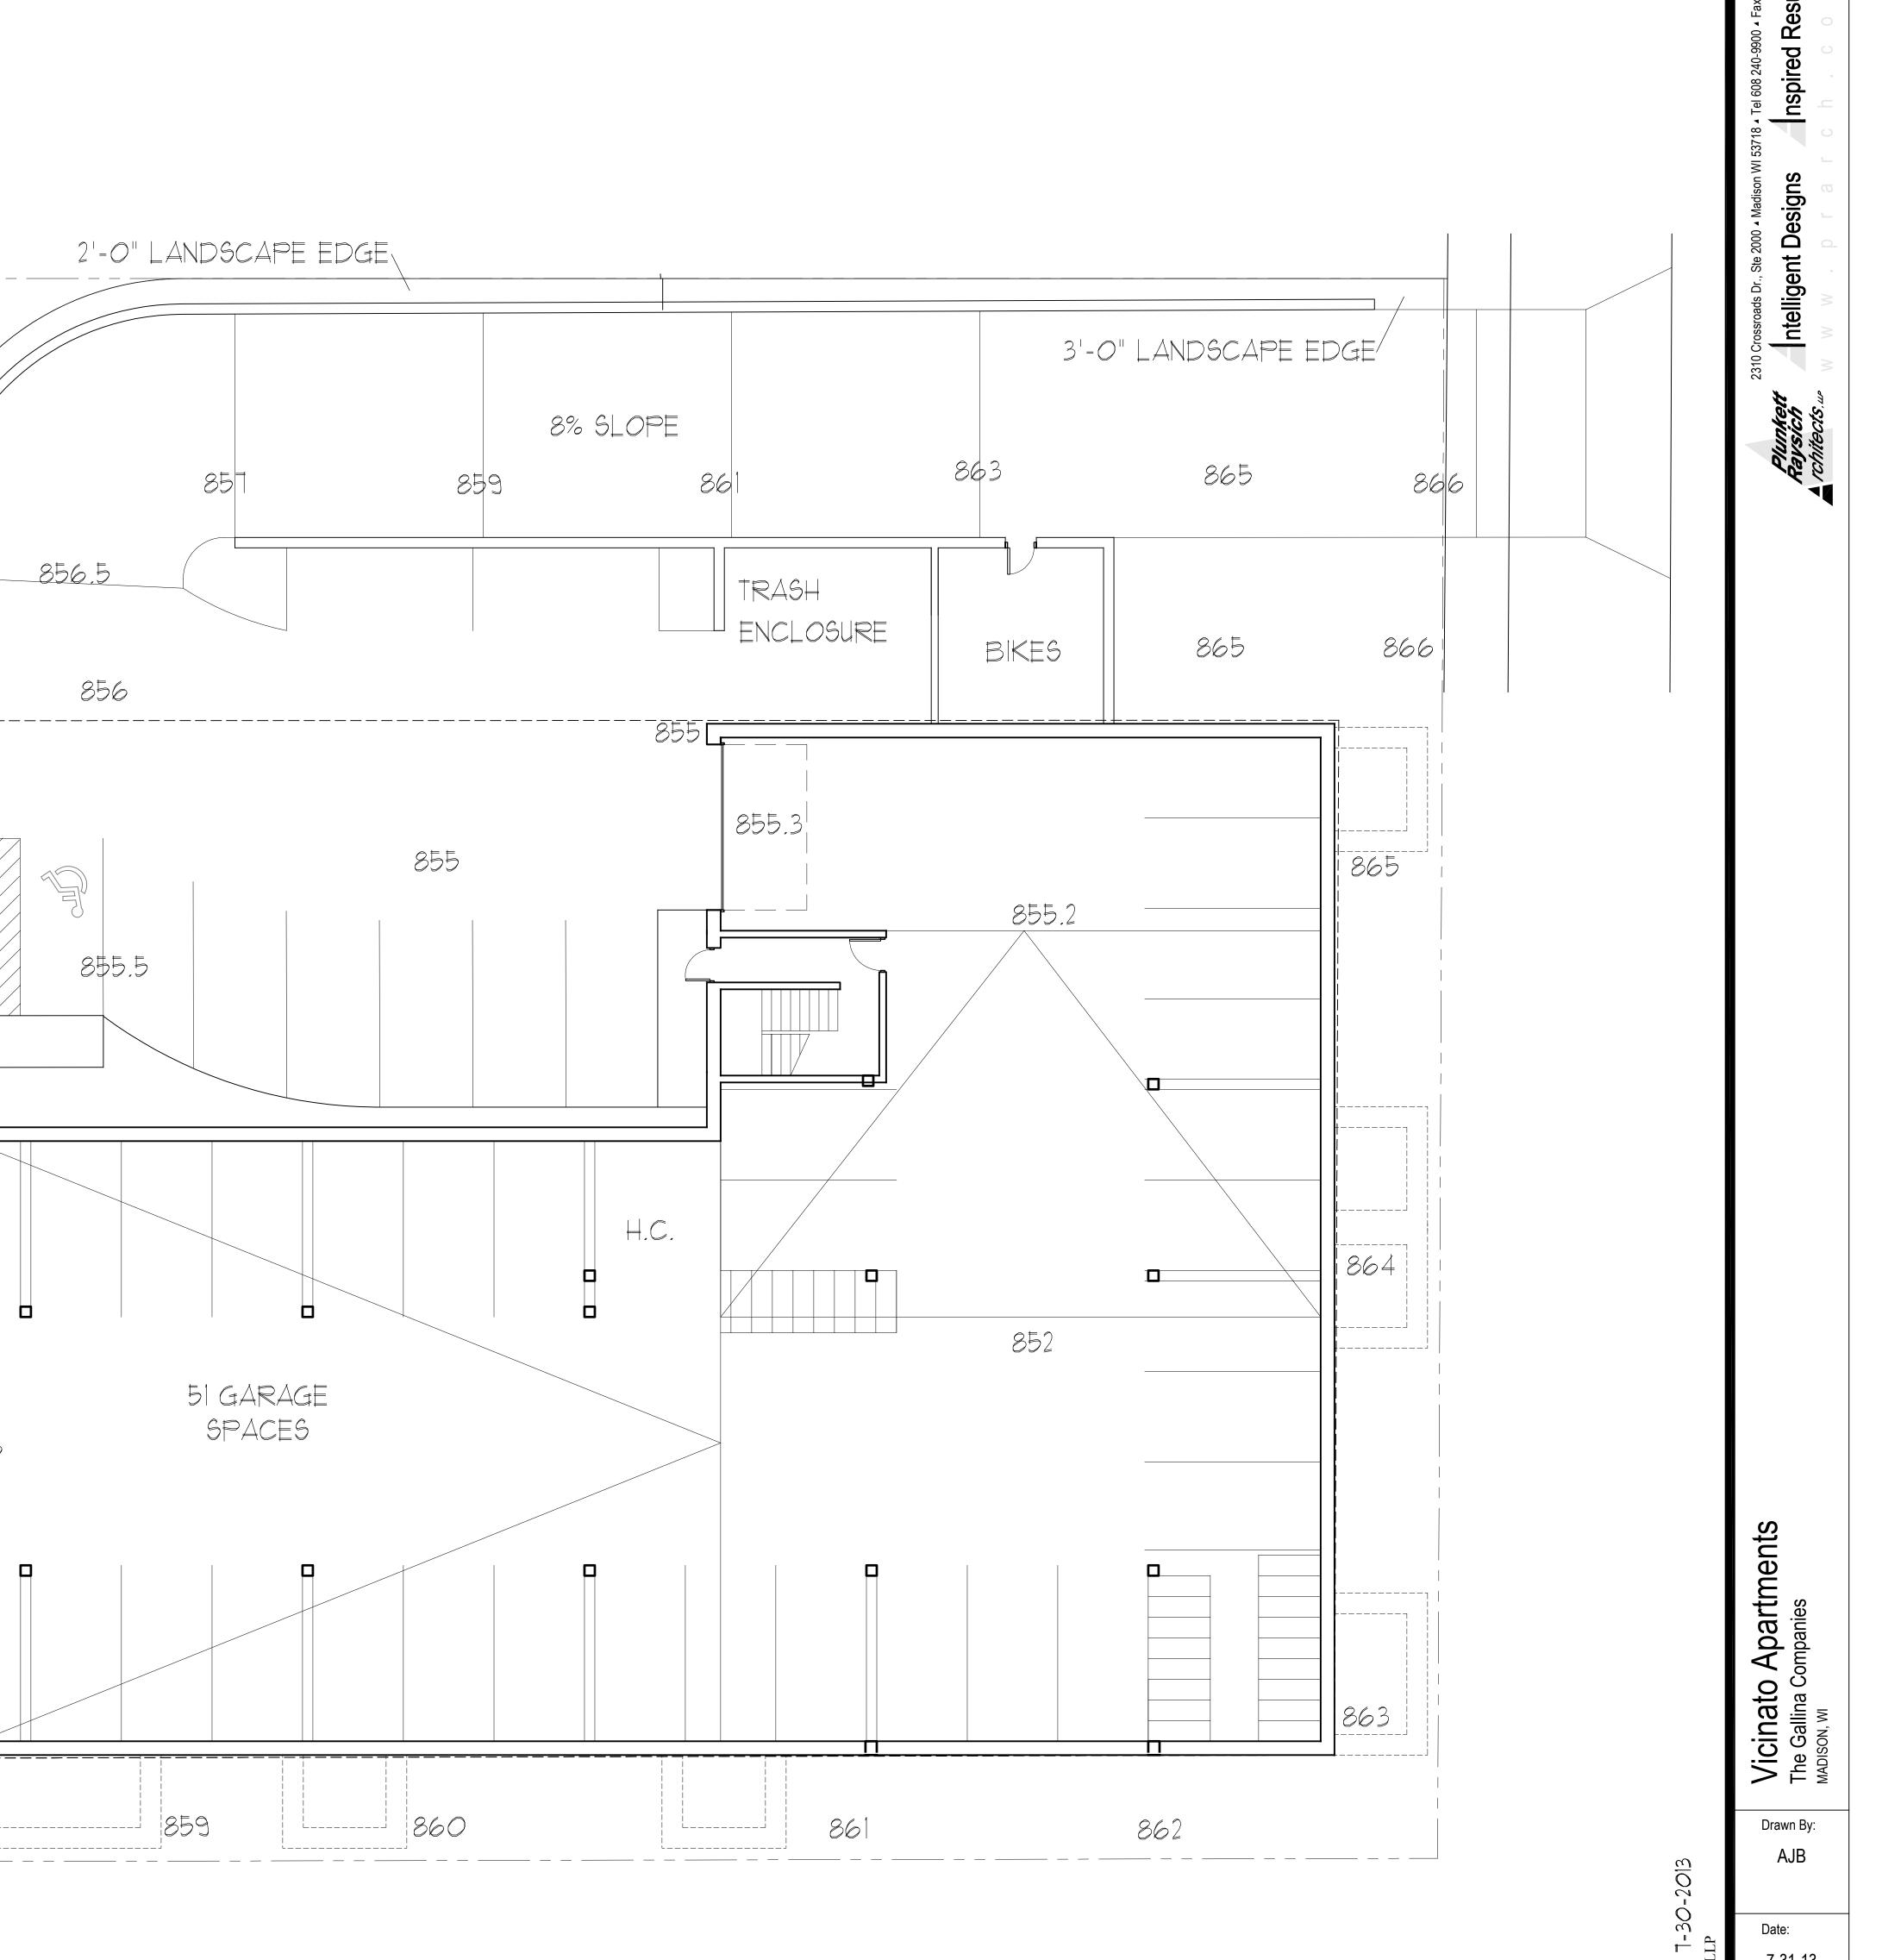

BUILD = TO LIMITS

846

LOWER LEVEL PLAN 1/8"=1'-0"

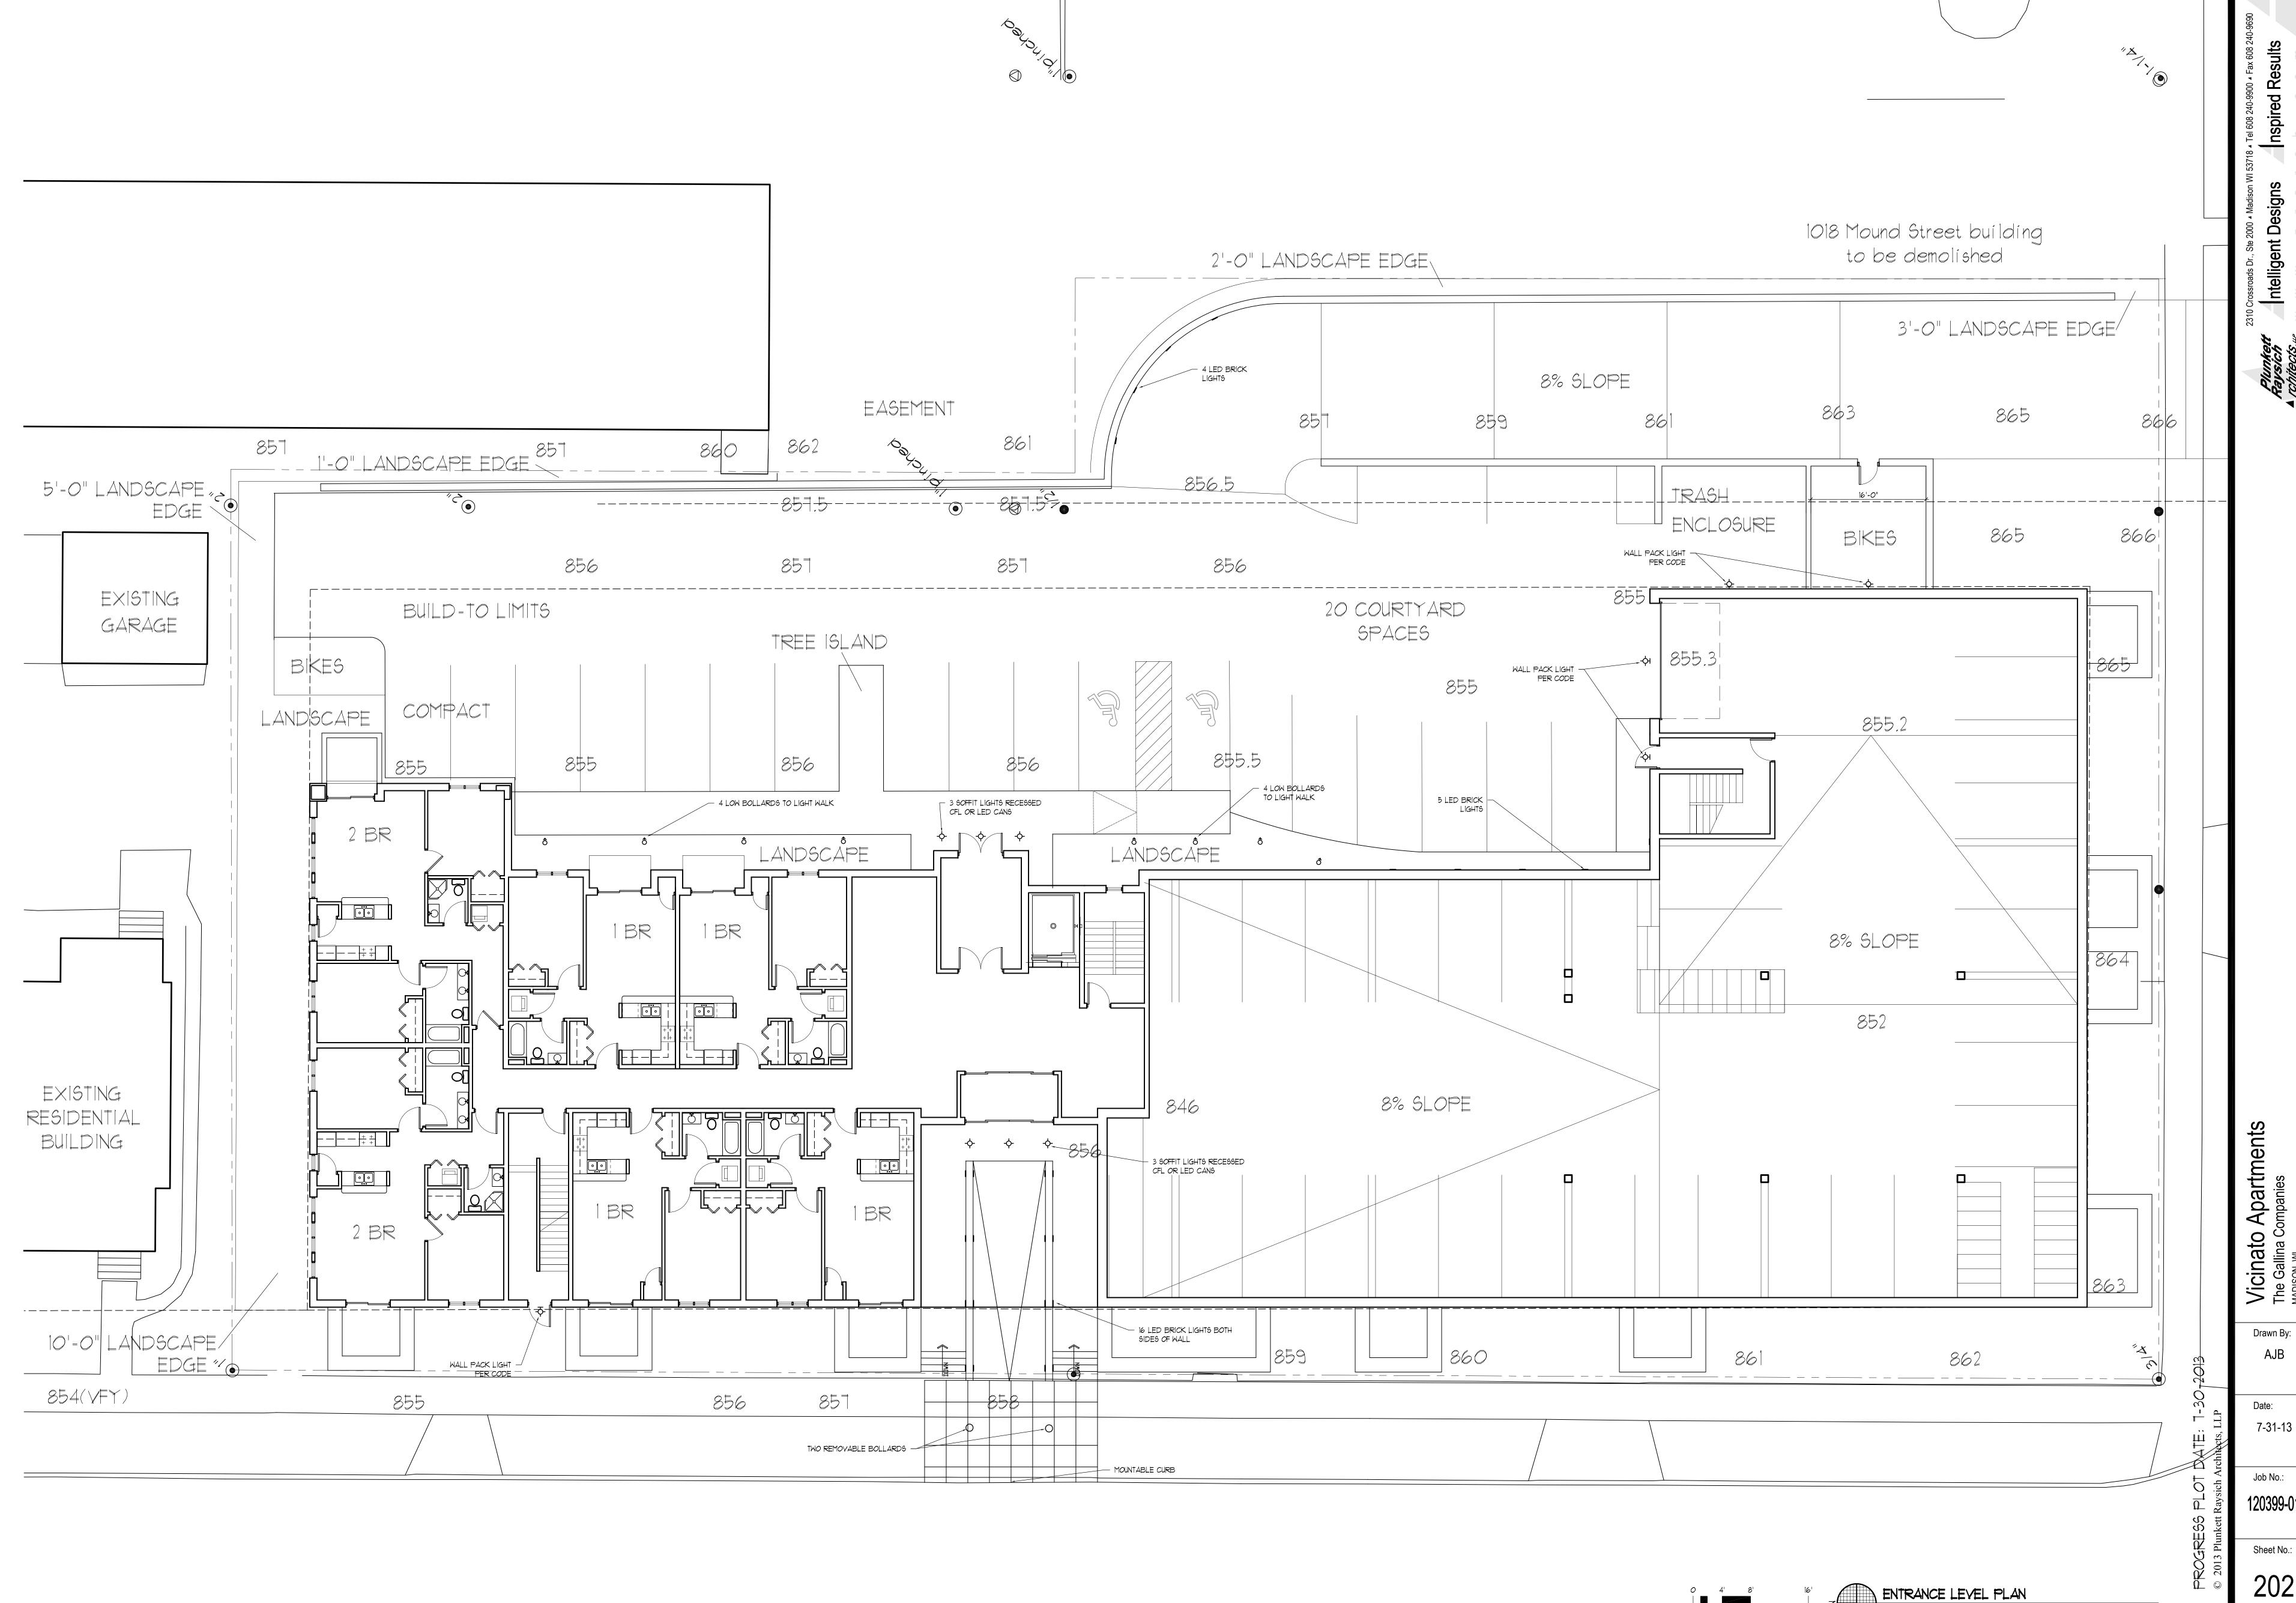

Vicinato Apartments
The Gallina Companies Drawn By:


1/8"=1'-0"

120399-01

Sheet No.: 203

1/8"=1'-0"

Z TYPICAL FLOOR

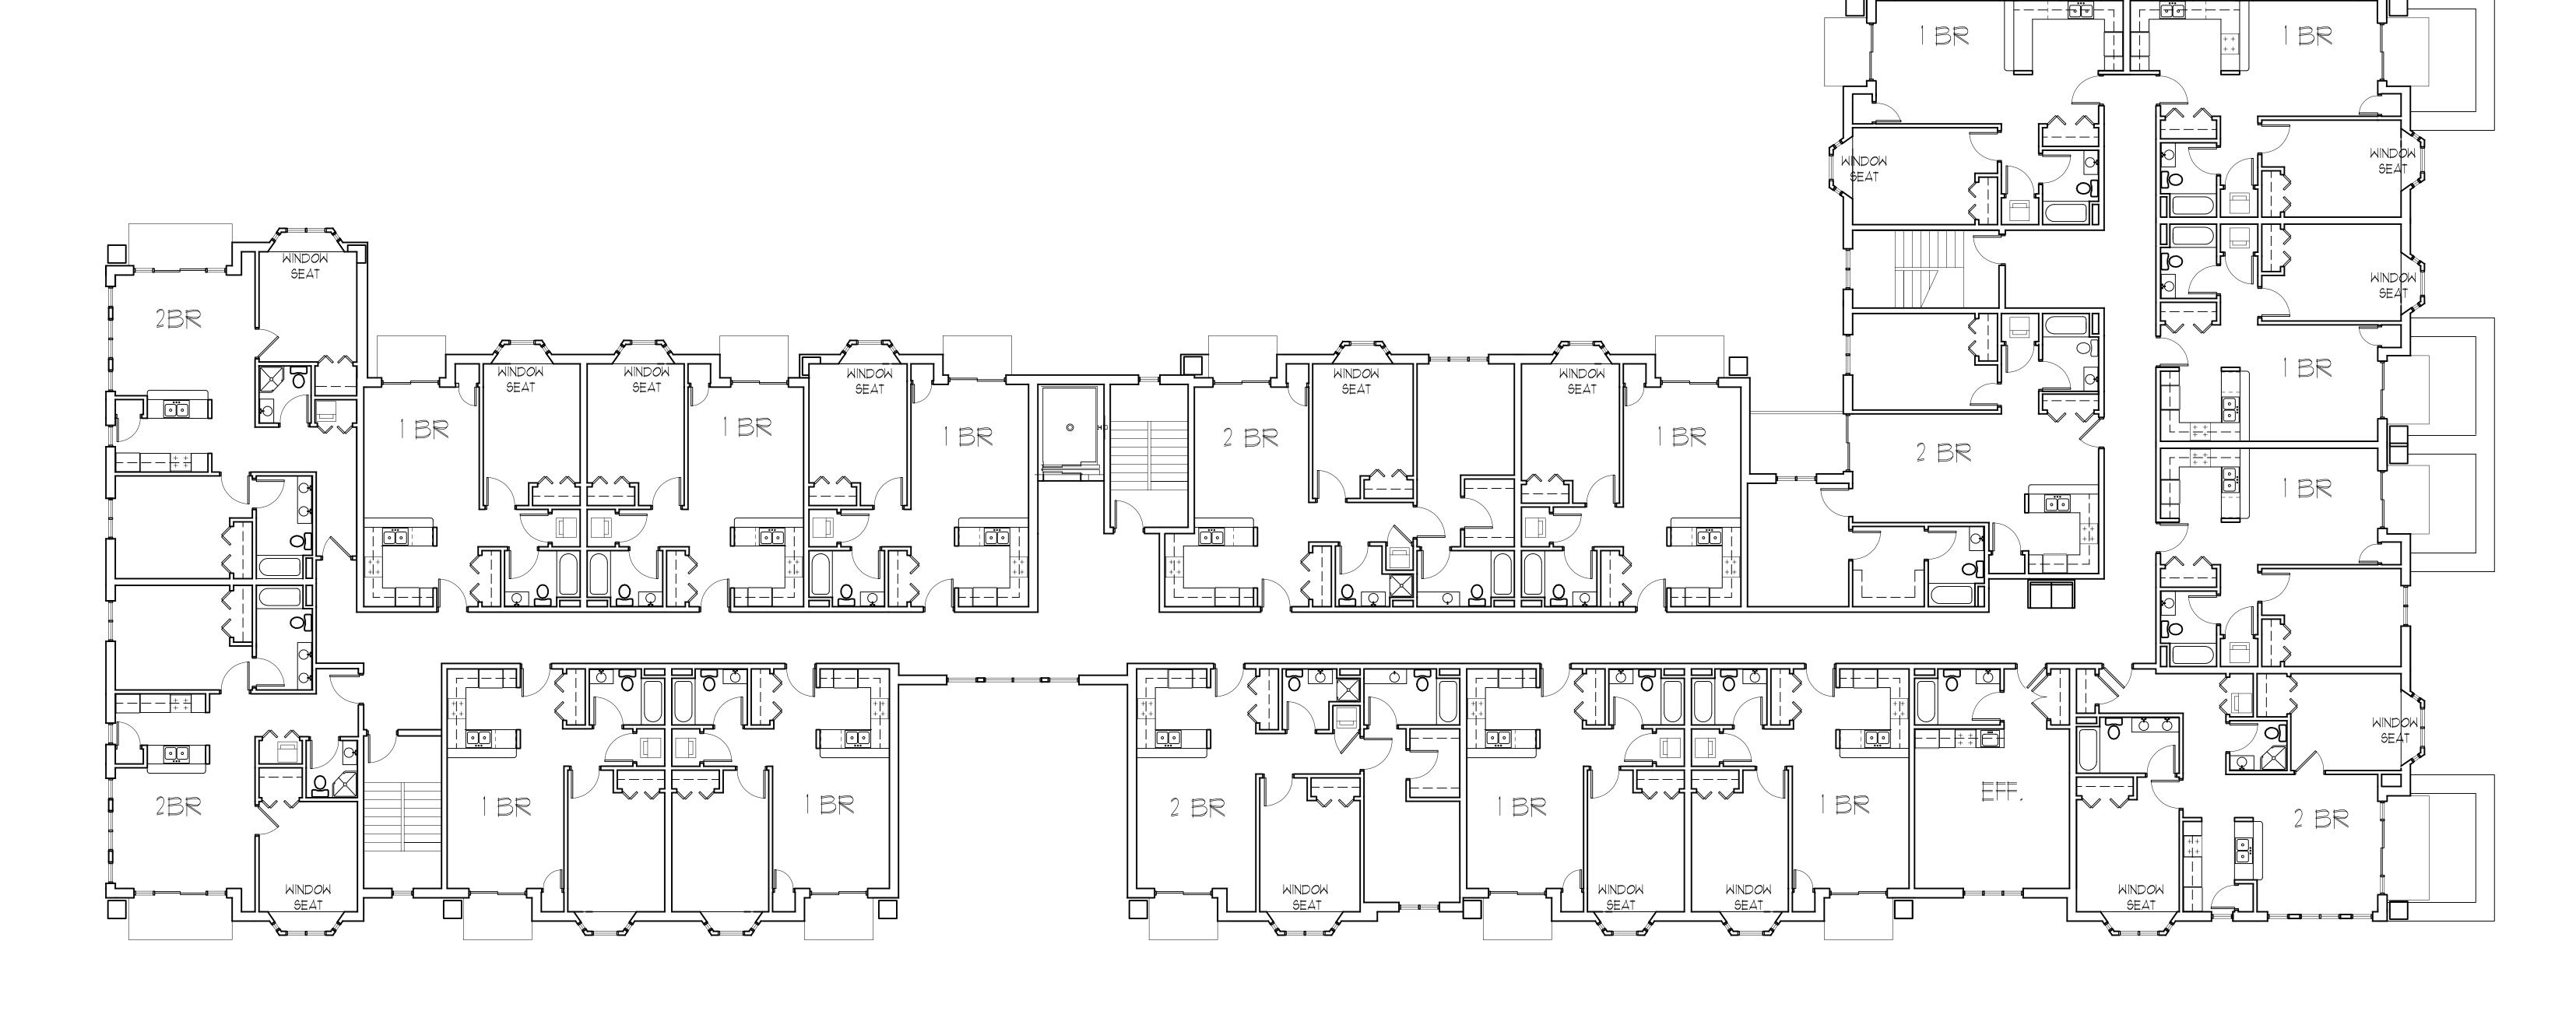

120399-01


Sheet No.: 204

1/8"=1'-0"

FOURTH FLOOR






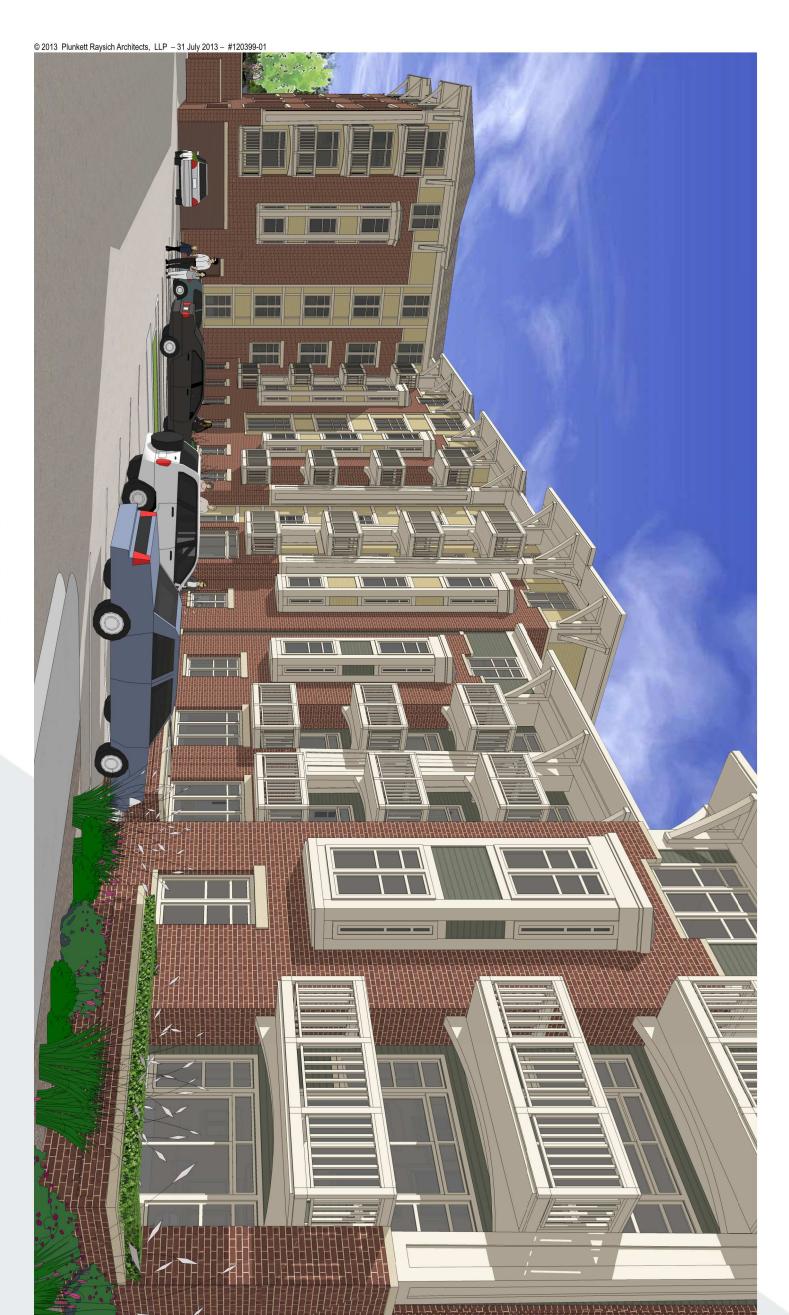


View from Northeast towards Parking Lot





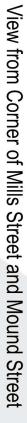



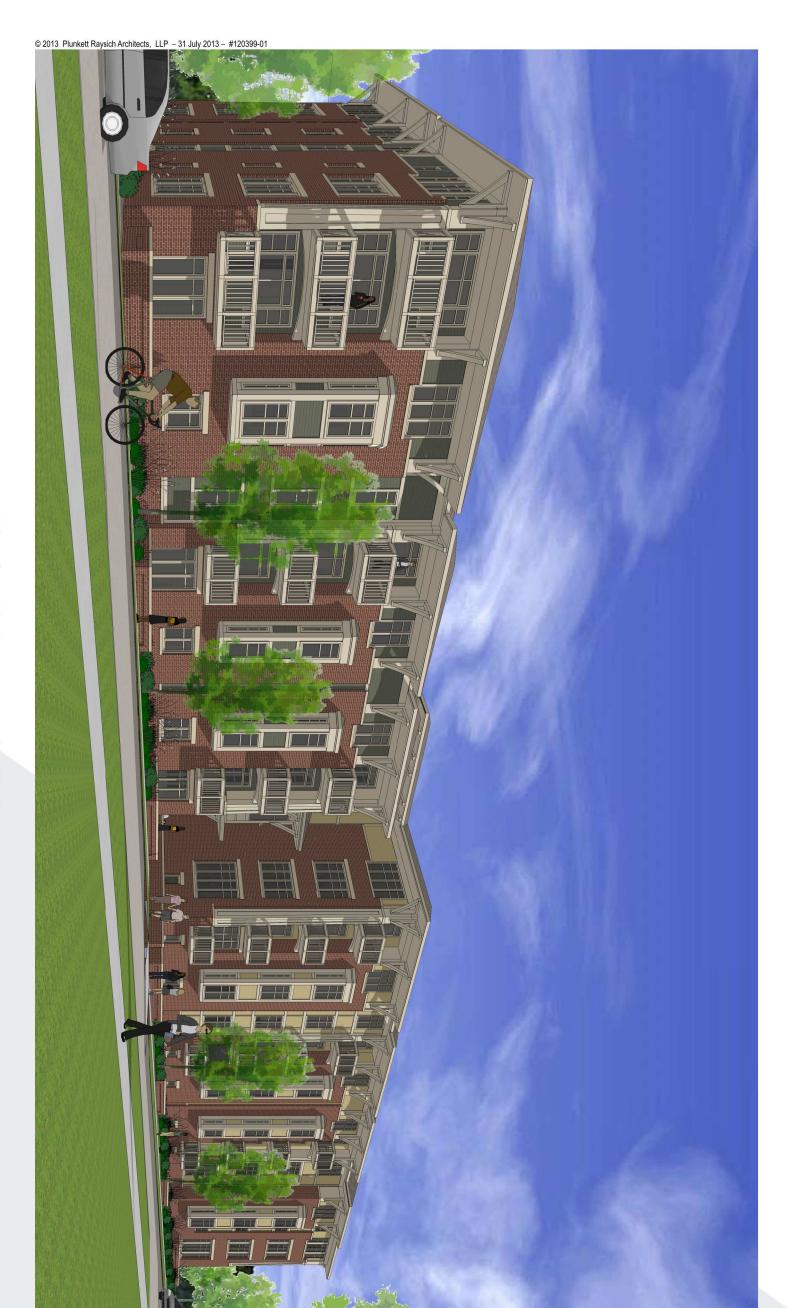


View from Northwest towards Mills Street





View from West towards Entry



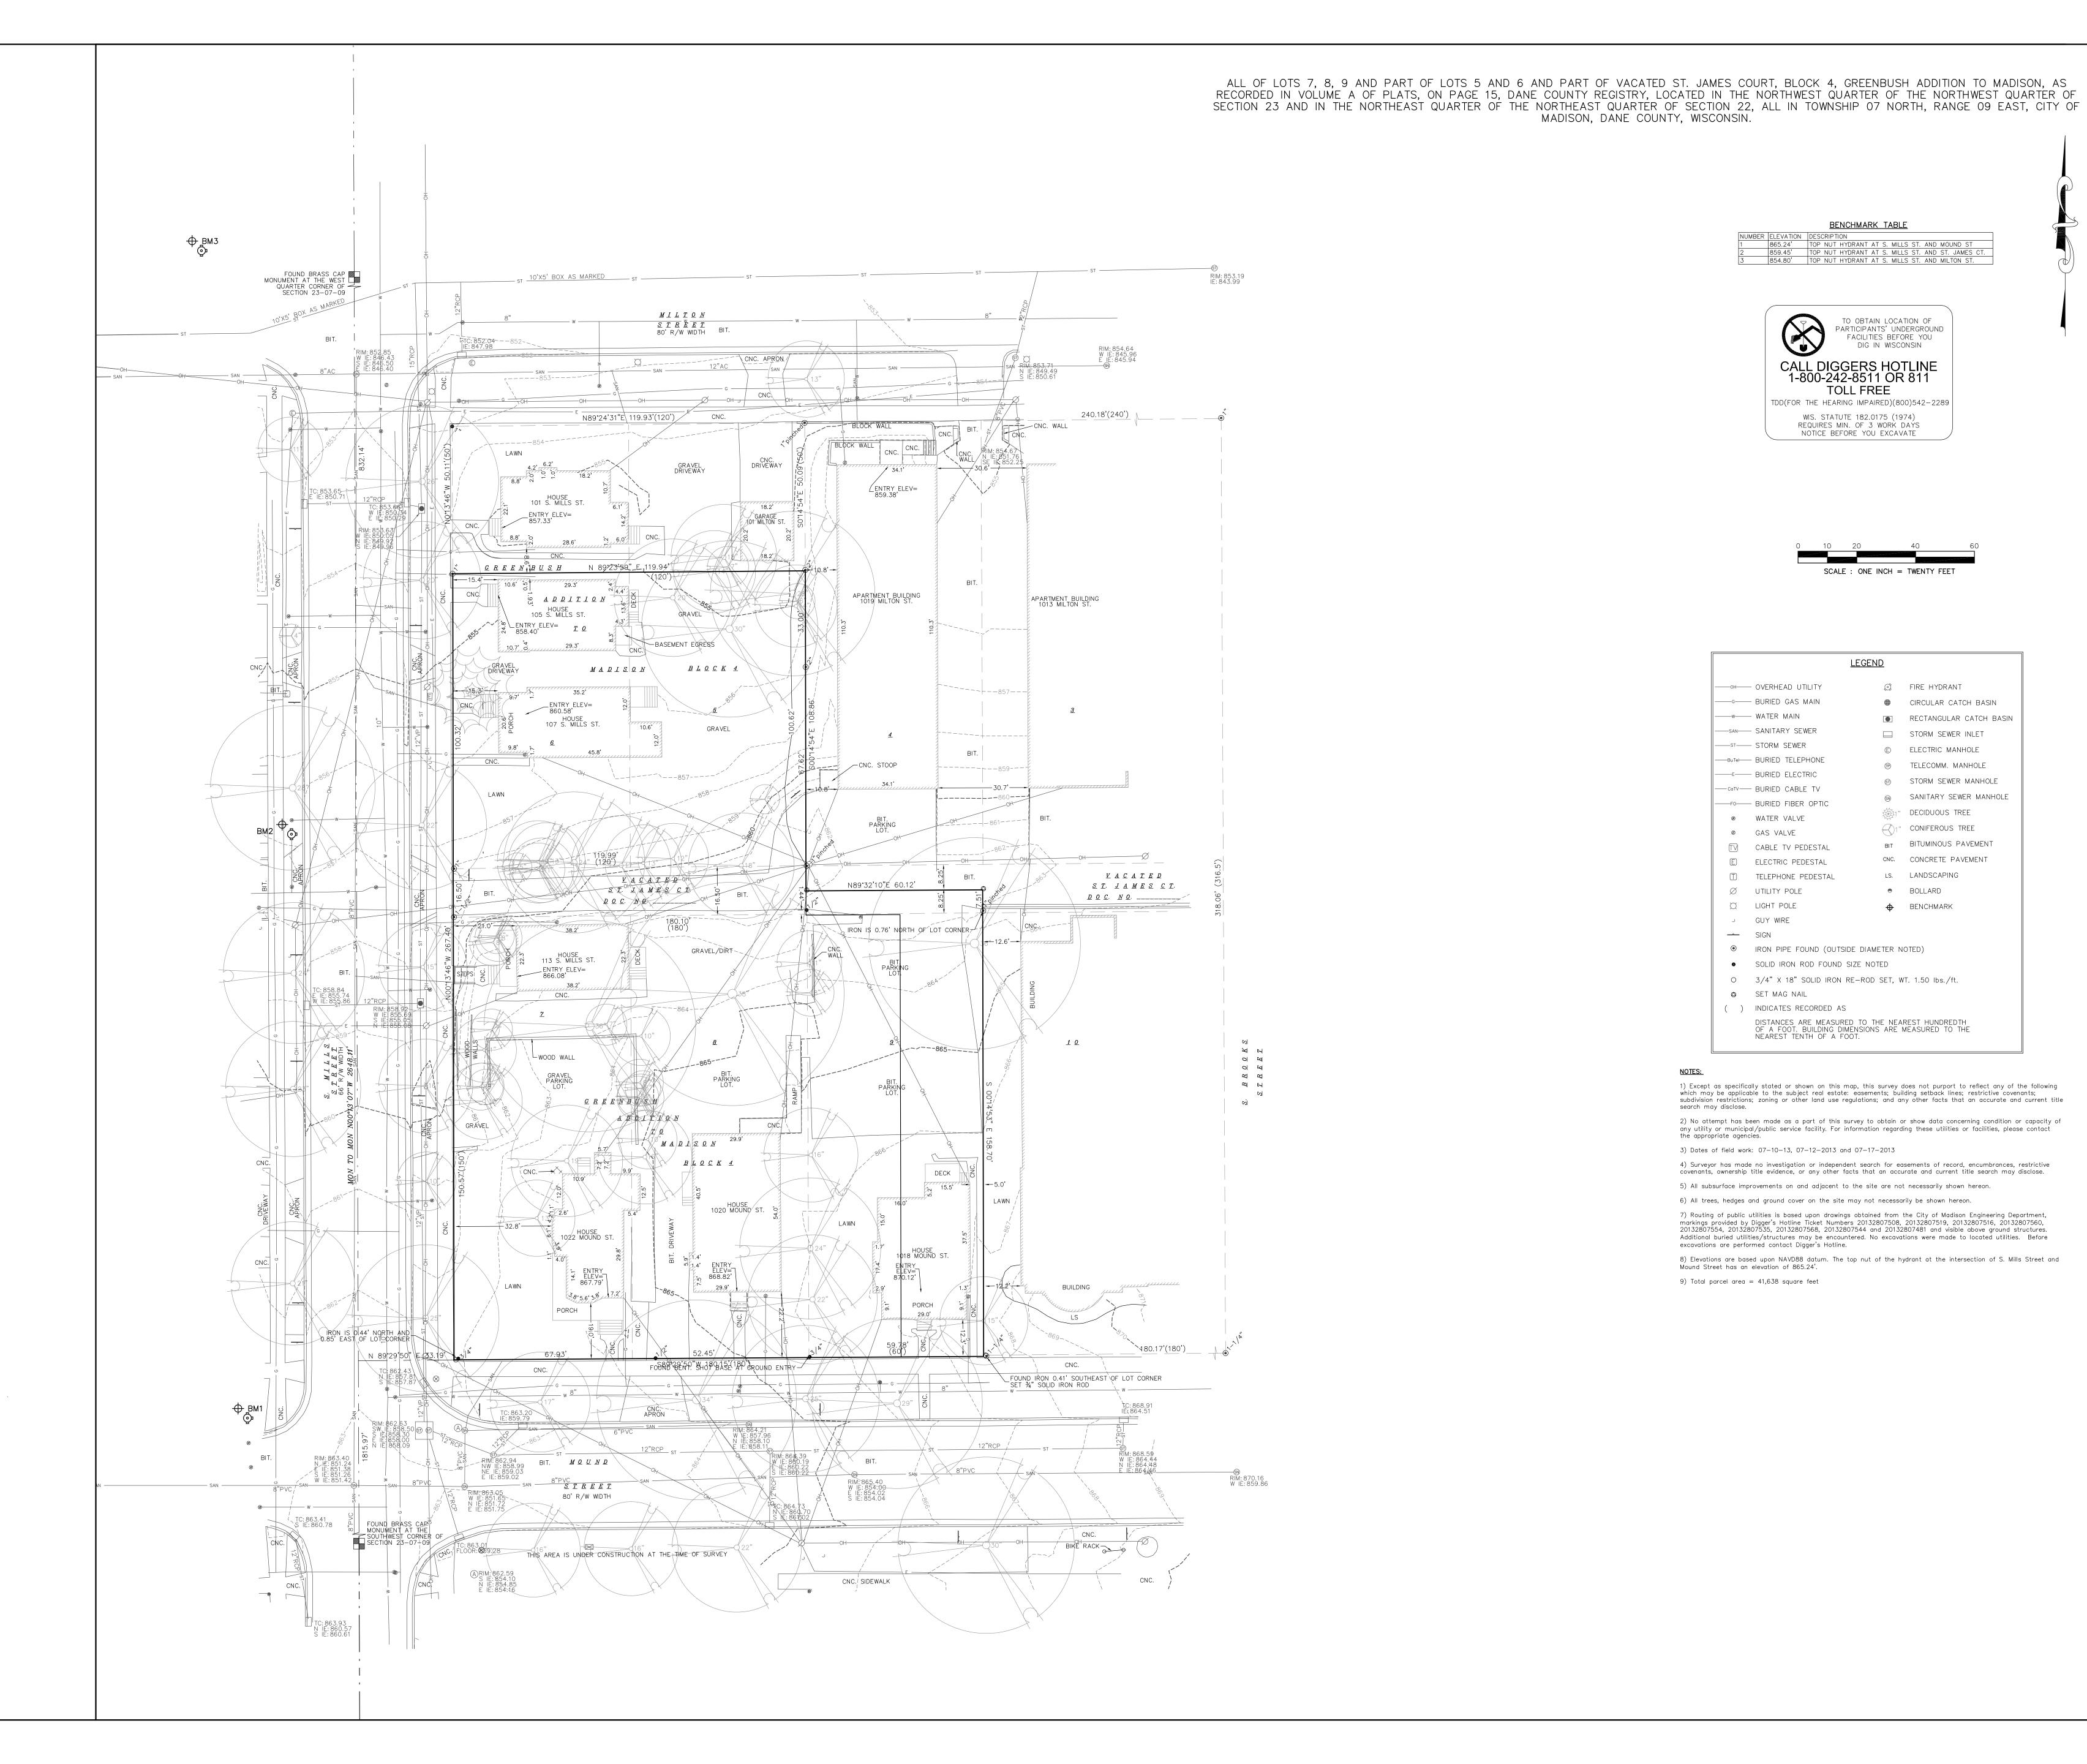



1400 E. Washington Ave, Suite 158 Madison, WI 53703 Phone: 608-250-9263 Fax: 608-250-9266 e-mail: Mburse@BSE-INC.net



PDF PDF PDF Y: PDF BY: BY: MLB

PROJECT #: BSE 1620 PLOT DATE: 07/3/2013

ISSUE DATES:

REVISION DATES:


07/31/2013

EXISTING CONDITIONS



This document contains confidential or proprietary information of Burse Surveying and Engineering, Inc. Neither the document nor the information herein is to be reproduced, distributed, used or disclosed, either in whole or in part, except as specifically authorized by Burse Surveying and Engineering, Inc.

DRAWING NUMBER

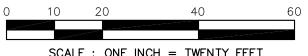

DEMOLITION NOTES:


- 1. COORDINATE EXISTING UTILITY REMOVAL WITH LOCAL AUTHORITIES AND UTILITY COMPANIES HAVING JURISDICTION. ALL PRIVATE UTILITIES (GAS, ELECTRIC, AND TELECOMMUNICATIONS) SERVING EXISTING BUILDINGS SCHEDULED FOR DEMOLITION TO BE ABANDONED OR REMOVED BY CORRESPONDING UTILITY COMPANY.
- 2. ALL SAWCUTTING SHALL BE FULL DEPTH TO PROVIDE A CLEAN EDGE TO MATCH NEW CONSTRUCTION. MATCH EXISTING ELEVATIONS AT POINTS OF CONNECTION FOR NEW AND EXISTING PAVEMENT, CURB, SIDEWALKS, ETC. ALL SAWCUT LOCATIONS SHOWN ARE APPROXIMATE AND MAY BE FIELD ADJUSTED TO ACCOMMODATE CONDITIONS, JOINTS, MATERIAL TYPE, ETC. REMOVE MINIMUM AMOUNT NECESSARY FOR INSTALLATION OF PROPOSED IMPROVEMENTS.
- 3. CONTRACTOR SHALL PROVIDE AND SHALL BE RESPONSIBLE FOR ANY NECESSARY TRAFFIC CONTROL AND SAFETY MEASURES DURING DEMOLITION AND CONSTRUCTION OPERATIONS WITHIN OR NEAR THE PUBLIC ROADWAY.
- 4. IT IS THE CONTRACTOR'S RESPONSIBILITY TO VERIFY THE LOCATION OF UNDERGROUND UTILITIES. UTILITIES WERE LOCATED BY OBSERVED EVIDENCE, MARKINGS PROVIDED BY DIGGER'S HOTLINE, AND RECORD DRAWINGS FROM THE CITY OF MADISON.

GENERAL NOTES:


- 1. THE LOCATION OF EXISTING UNDERGROUND UTILITIES AS SHOWN ON THE PLANS HAS BEEN DETERMINED FROM THE BEST AVAILABLE INFORMATION AND IS GIVEN FOR THE CONVENIENCE OF THE CONTRACTOR. THE OWNER AND THE ENGINEER DO NOT ASSUME RESPONSIBILITY IN THE EVENT THAT DURING CONSTRUCTION, UTILITIES OTHER THAN THOSE SHOWN MAY BE ENCOUNTERED, AND THAT THE ACTUAL LOCATION OF THOSE WHICH ARE SHOWN MAY BE DIFFERENT FROM THE LOCATIONS AS SHOWN ON THE PLANS.
- 2. ANY PAVEMENT ABUTTING THE PROPERTY SHALL BE REPLACED IF IT IS DAMAGED DURING CONSTRUCTION.
- 3. PRIOR TO THE USE OF THESE DRAWINGS FOR CONSTRUCTION PURPOSES, THE USER SHALL VERIFY ALL DIMENSIONS AND LOCATIONS OF BUILDINGS WITH THE ARCHITECTURAL SITE PLAN. IF CONFLICTS EXIST THE USER OF THESE DRAWINGS SHALL CONTACT THE ENGINEER IMMEDIATELY.

--OH---- OVERHEAD UTILITY


DEMO LEGEND

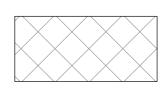

REMOVE PAVEMENT

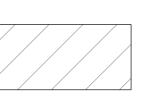


RAZE BUILDING

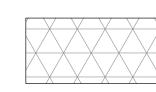

REMOVE GRAVEL

REMOVE TREE/SHRUB



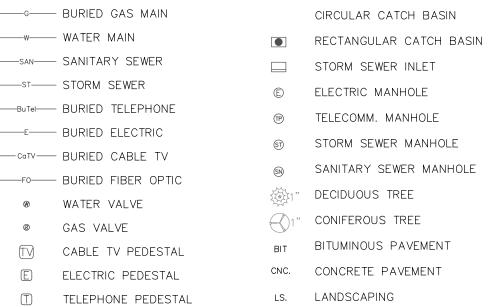

<u>LEGEND</u>

FIRE HYDRANT

■ BOLLARD

→ BENCHMARK

GUY WIRE

SIGN

∅ UTILITY POLE□ LIGHT POLE

IRON PIPE FOUND (OUTSIDE DIAMETER NOTED)
 SOLID IRON ROD FOUND SIZE NOTED

DISTANCES ARE MEASURED TO THE NEAREST HUNDREDTH OF A FOOT. BUILDING DIMENSIONS ARE MEASURED TO THE NEAREST TENTH OF A FOOT.

O 3/4" X 18" SOLID IRON RE-ROD SET, WT. 1.50 lbs./ft.

SET MAG NAIL

() INDICATES RECORDED AS

nato Aps 113 South Mills Madison, Wis

St., Suite 500

Burse

Surveying and Engineering, Inc.

1400 E. Washington Ave, Suite 158

Madison, WI 53703

Phone: 608-250-9263

Fax: 608-250-9266

e-mail: Mburse@BSE-INC.net


www.bursesurveyengr.com

REVISION DATES:

ISSUE DATES:

07/31/2013

DEMOLITION PLAN

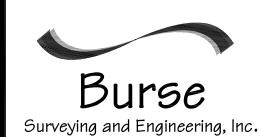

This document contains confidential or proprietary information of Burse Surveying and Engineering, Inc. Neither the document nor the information herein is to be reproduced, distributed, used or disclosed, either in whole or in part, except as specifically authorized by Burse Surveying

DRAWING NUMBER

and Engineering, Inc.

C-101

BENCHMARK TABLE


NUMBER ELEVATION DESCRIPTION


1 865.24' TOP NUT HYDRANT AT S. MILLS ST. AND MOUND ST

2 859.45' TOP NUT HYDRANT AT S. MILLS ST. AND ST. JAMES CT.


3 854.80' TOP NUT HYDRANT AT S. MILLS ST. AND MILTON ST.



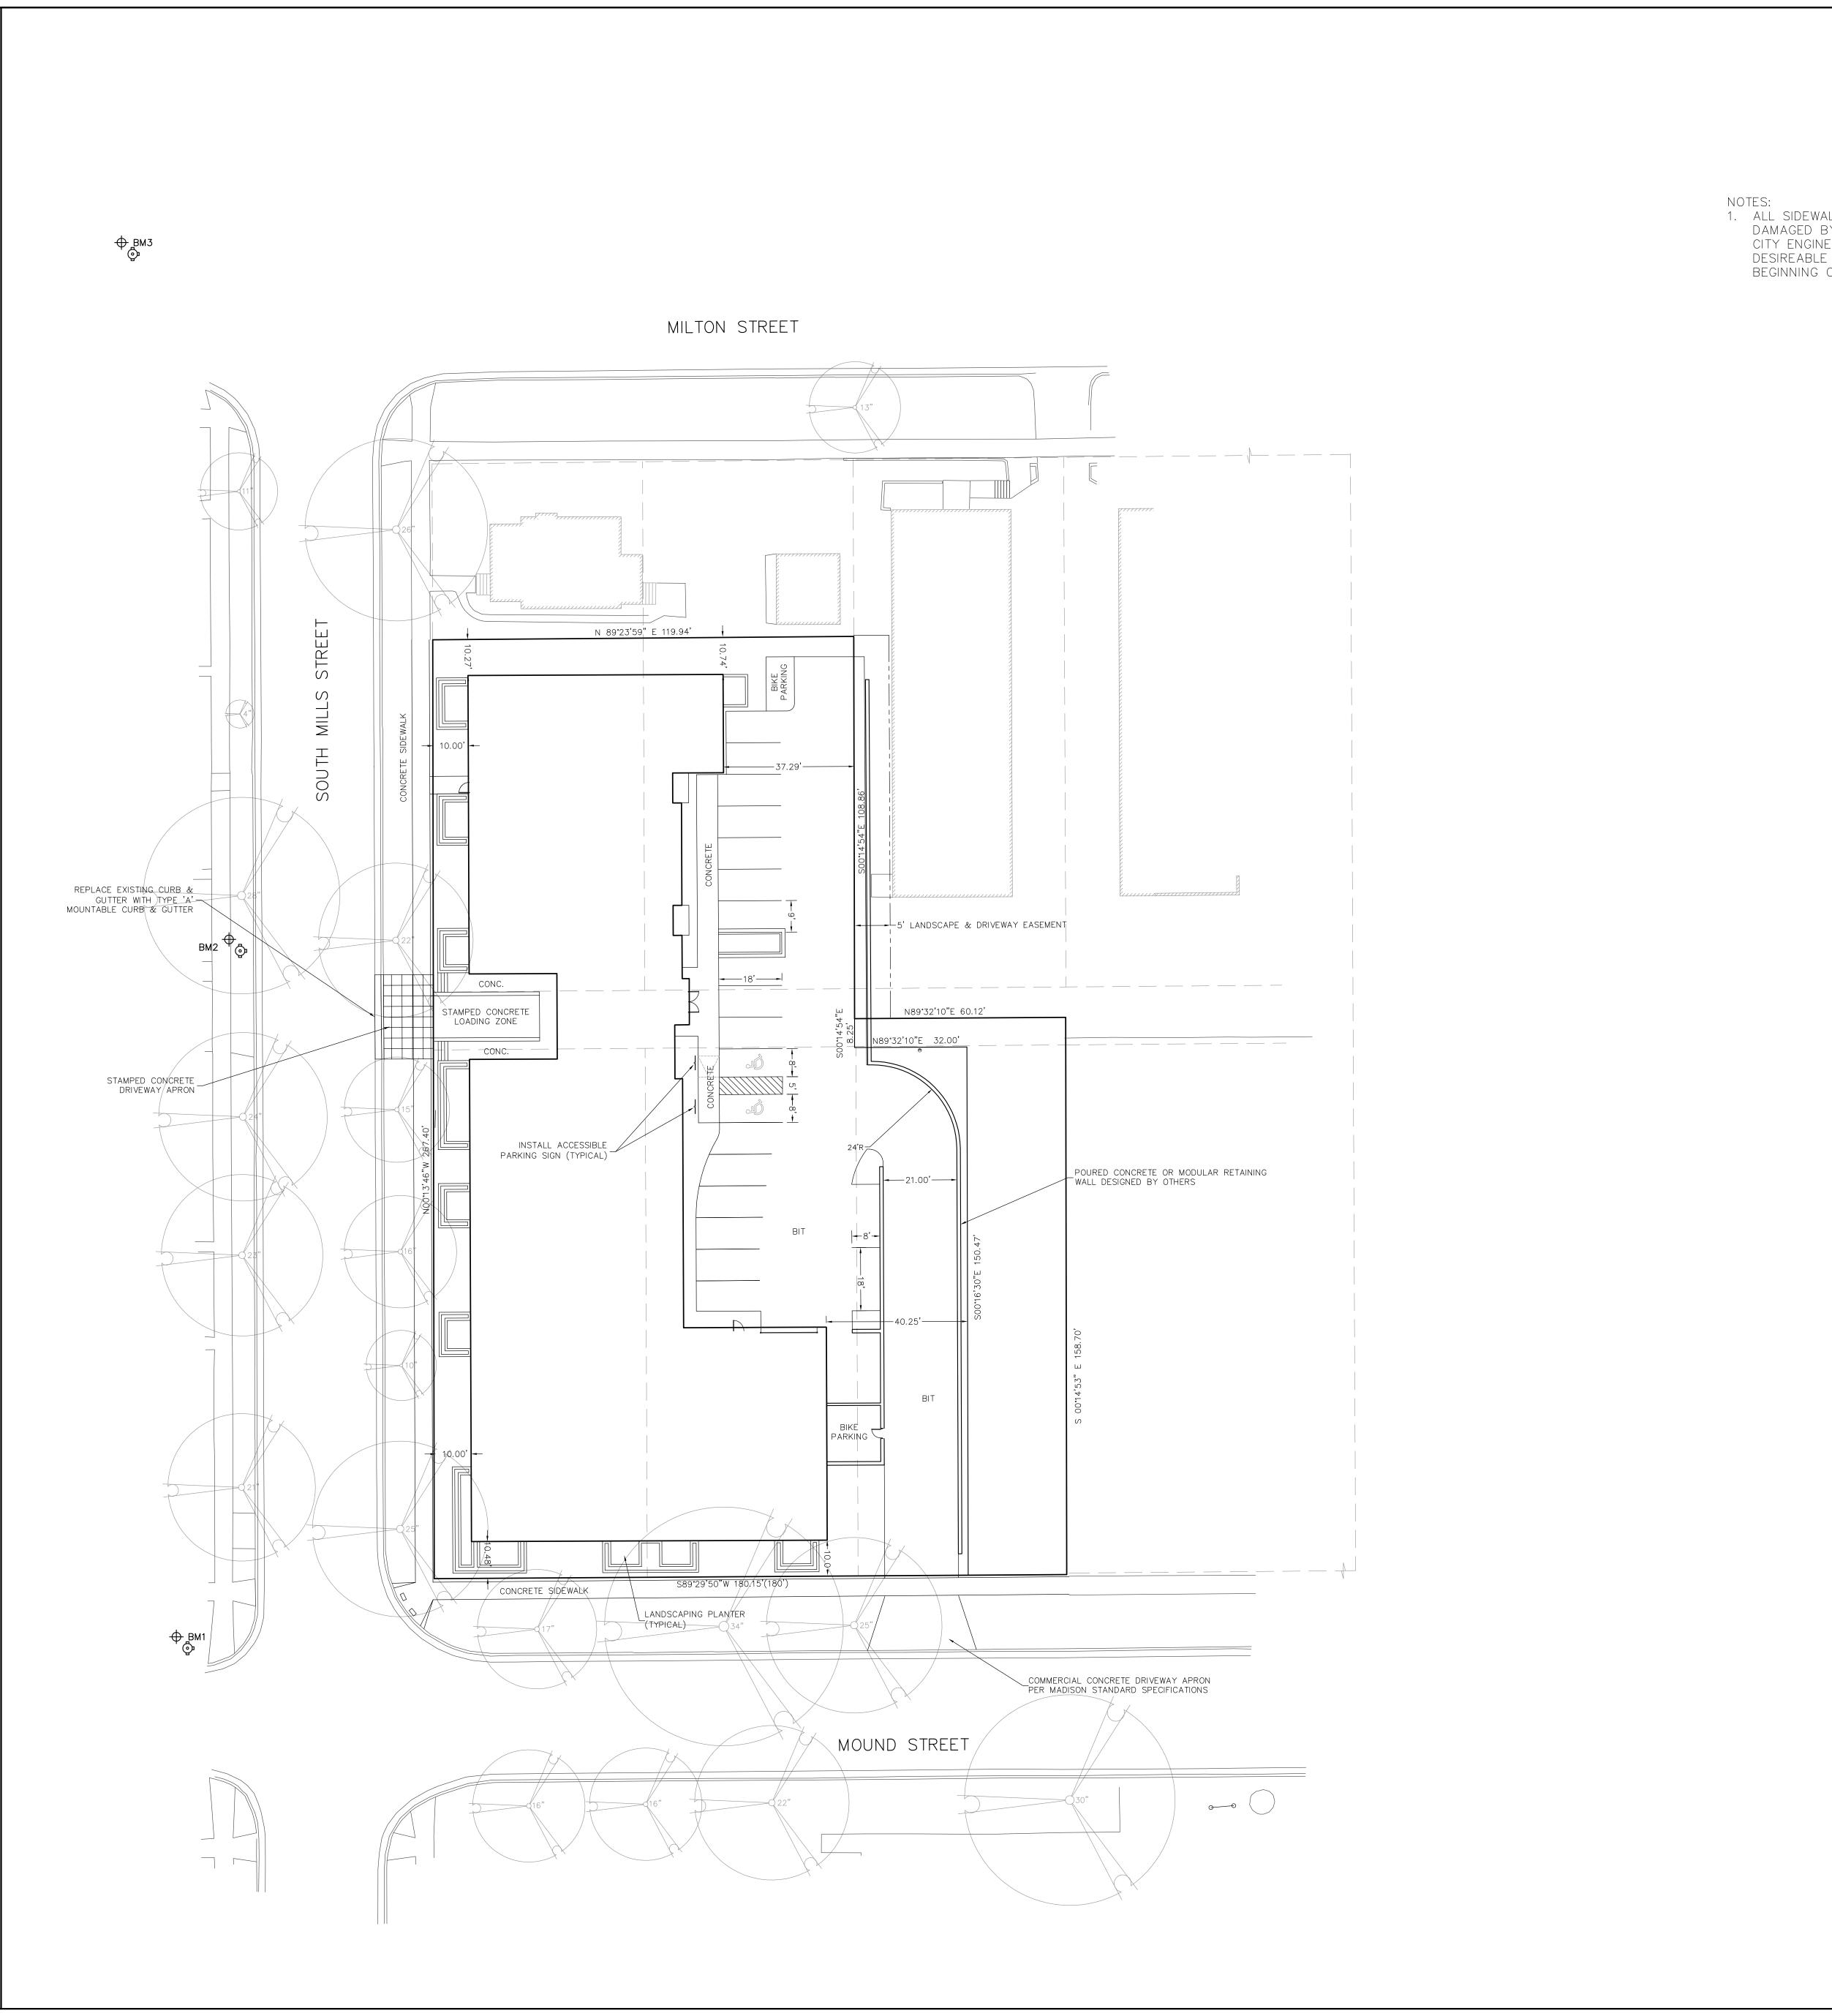

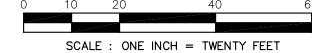


NOTES: 1. ALL SIDEWALK, PAVEMENT AND CURB & GUTTER ABUTTING THE PROPERTY, WHICH IS DAMAGED BY THE CONSTRUCTION, OR ANY SIDEWALK AND CURB & GUTTER THAT THE CITY ENGINEER DETERMINES NEEDS TO BE REPLACED BECAUSE IT IS NOT AT A DESIREABLE GRADE REGARDLESS OF WHETHER THE CONDITION EXISTED PRIOR TO BEGINNING CONSTRUCTION.

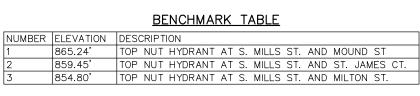



<u>LEGEND</u> S FIRE HYDRANT CIRCULAR CATCH BASIN RECTANGULAR CATCH BASIN ---san---- SANITARY SEWER STORM SEWER INLET © ELECTRIC MANHOLE ---BuTel---- BURIED TELEPHONE TELECOMM. MANHOLE ----- BURIED ELECTRIC (57) STORM SEWER MANHOLE —catv—— BURIED CABLE TV SANITARY SEWER MANHOLE -FO- BURIED FIBER OPTIC DECIDUOUS TREE WATER VALVE Oniferous Tree GAS VALVE BITUMINOUS PAVEMENT TV CABLE TV PEDESTAL CNC. CONCRETE PAVEMENT E ELECTRIC PEDESTAL LS. LANDSCAPING T TELEPHONE PEDESTAL \varnothing UTILITY POLE ■ BOLLARD → BENCHMARK C LIGHT POLE J GUY WIRE -- SIGN ● IRON PIPE FOUND (OUTSIDE DIAMETER NOTED) SOLID IRON ROD FOUND SIZE NOTED O 3/4" X 18" SOLID IRON RE-ROD SET, WT. 1.50 lbs./ft. SET MAG NAIL () INDICATES RECORDED AS DISTANCES ARE MEASURED TO THE NEAREST HUNDREDTH OF A FOOT. BUILDING DIMENSIONS ARE MEASURED TO THE NEAREST TENTH OF A FOOT.

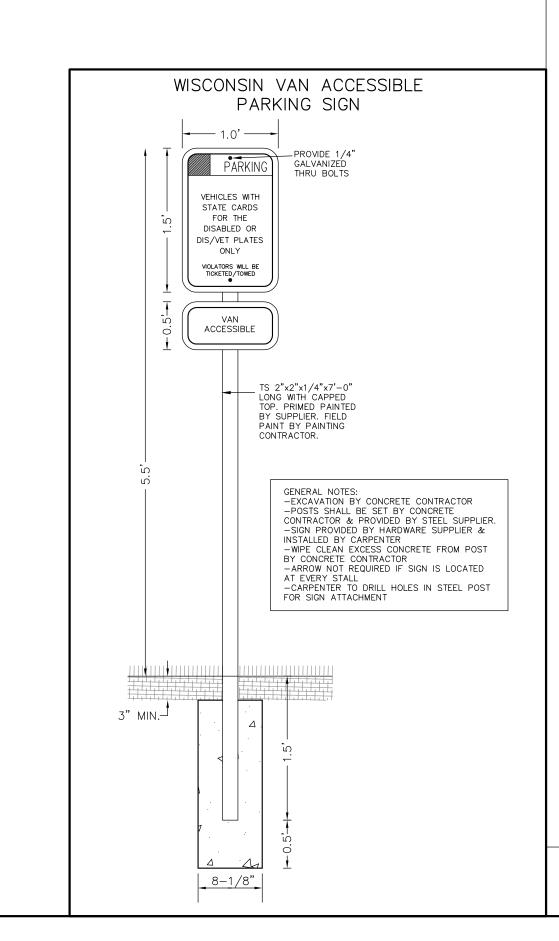

Surveying and Engineering, Inc

1400 E. Washington Ave, Suite 158 Madison, WI 53703 Phone: 608-250-9263 Fax: 608-250-9266 e-mail: Mburse@BSE-INC.net www.bursesurveyengr.com




PROJECT #: BSE 1620 PLOT DATE: 07/31/2013

| REVISION DATES: | | | | | | | |
|-----------------|--|--|--|--|--|--|--|
| | | | | | | | |
| | | | | | | | |
| | | | | | | | |


ISSUE DATES: 07/31/2013


SITE PLAN

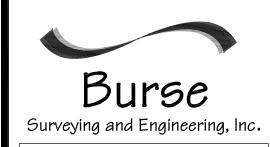

This document contains confidential or proprietary information of Burse Surveying and Engineering, Inc. Neither the document nor the information herein is to be reproduced, distributed, used or disclosed, either in whole or in part, except as specifically authorized by Burse Surveying and Engineering, Inc.

DRAWING NUMBER

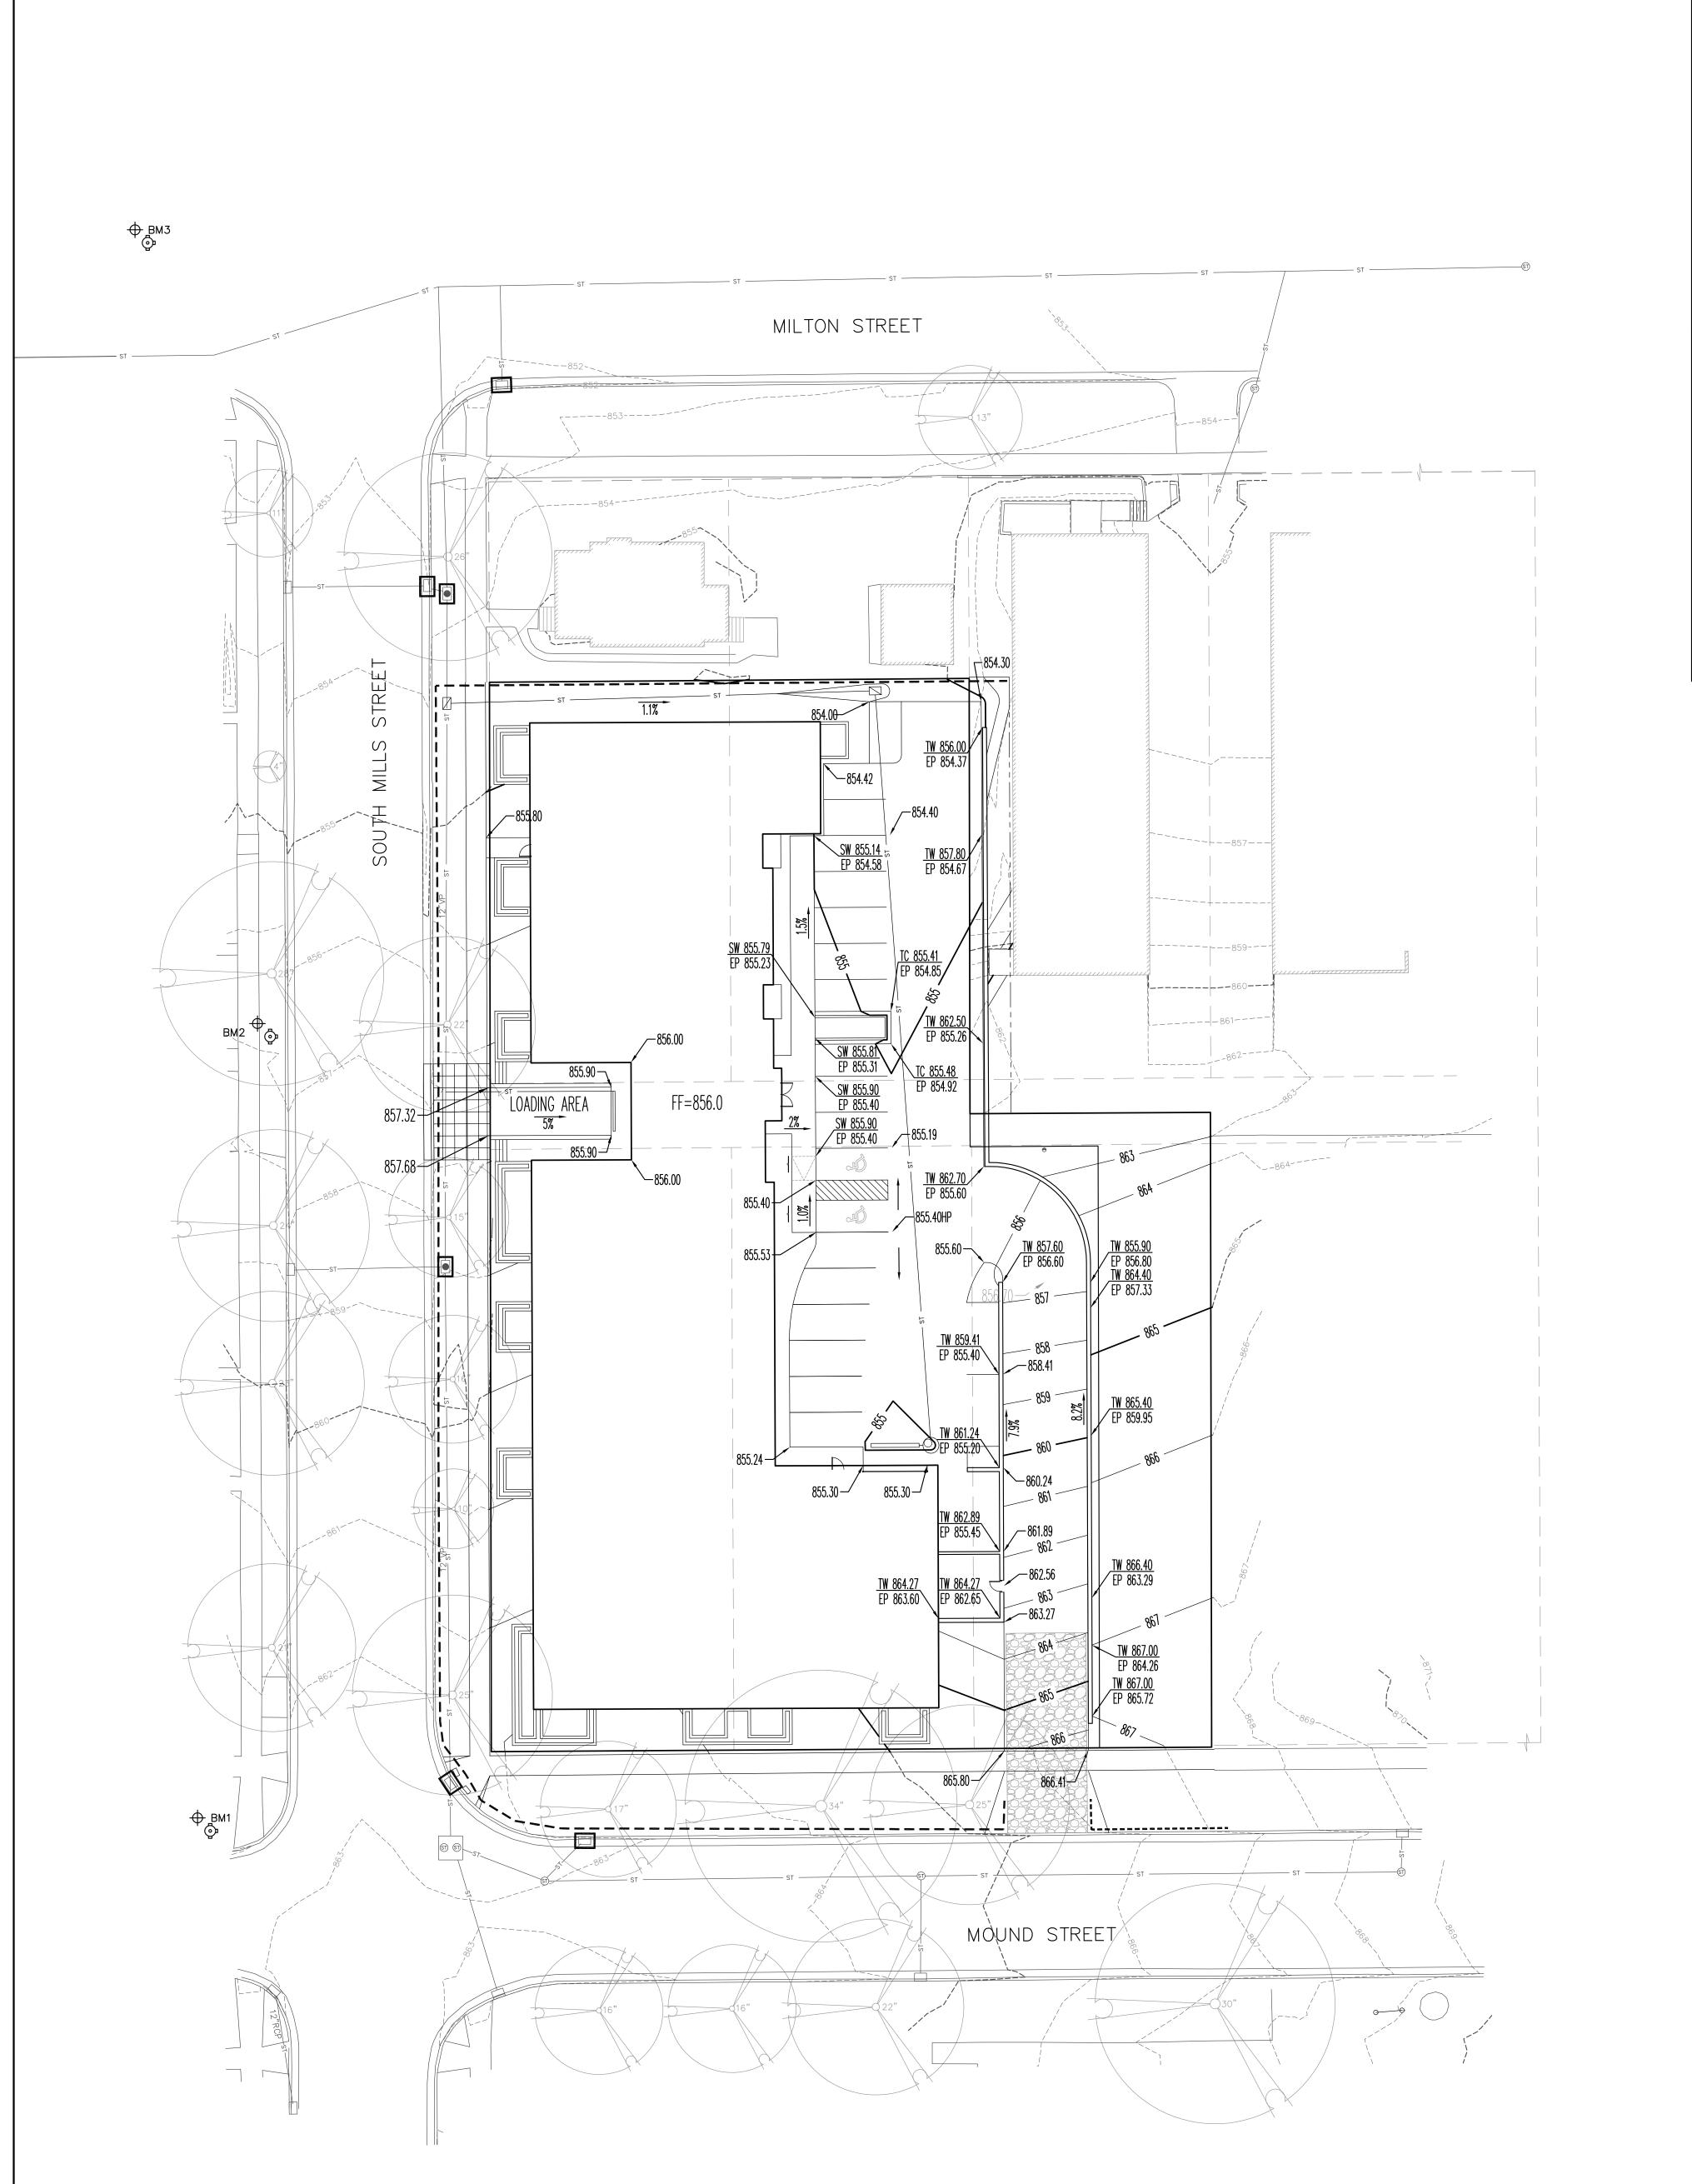

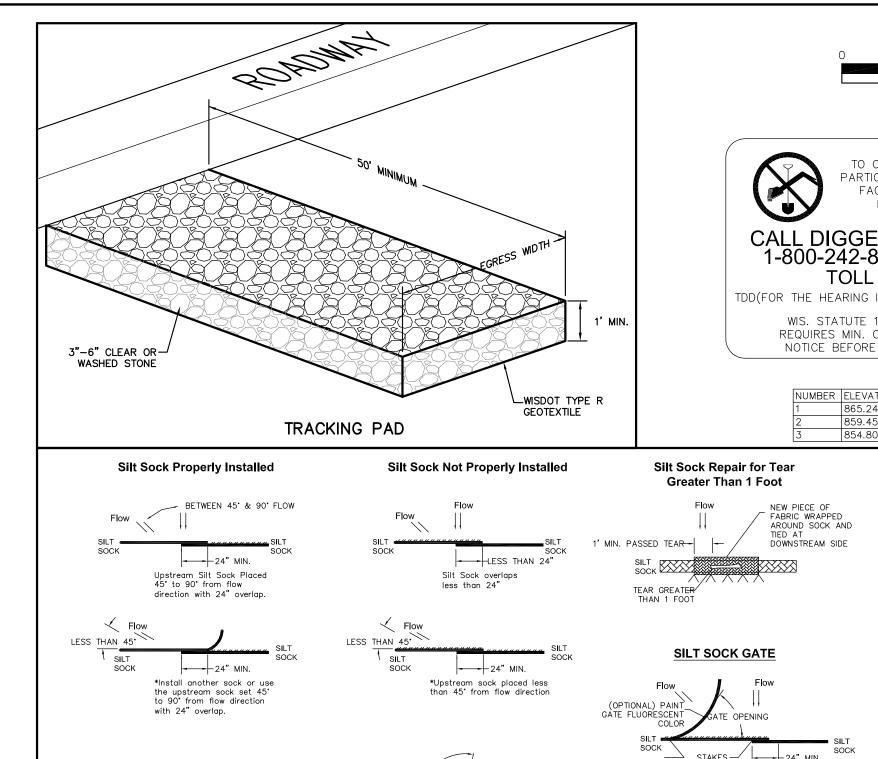

GREATER THAN 90 / Flow

Upstream sock placed Greater than 90° from flow direction

<u>Erosion Control Notes/Specifications:</u> 1. Erosion control devices and/or structures shall be installed prior

REFERENCE ANGLES

0° ______ 180°

to clearing and grubbing operations. These shall be properly maintained for maximum effectiveness until vegetation is re-established.

- 2. Erosion control is the responsibility of the contractor until acceptance of this project. Erosion control measures as shown shall be the minimum precautions that will be allowed. The contractor shall be responsible for recognizing and correcting all erosion control problems that are the result of construction activities. Additional erosion control measures, as requested in writing by the state or local inspectors, or the developer's engineer, shall be installed within 24 hours.
- 3. All erosion control measures and structures serving the site must be inspected at least weekly or within 24 hours of the time 0.5 inches of rain is produced. All maintenance will follow an inspection within 24 hours.
- 4. Construction Entrances Provide a stone tracking pad at each point of access. Install according to WDNR Standard 1057. Refer to WDNR's stormwater web page of technical standards at: http://dnr.wi.gov/runoff/stormwater/techstds.htm
- 5. Temporary stabilization using anionic polymer. After November 1, 2012, anionic polyacrylamide will be applied to all disturbed areas where City of Madison inspectors deem stabilization and/or erosion to be problematic. Application of polyacrylamide will be according to WDNR Conservation Practice standard 1050, Erosion Control Land Application of Anionic Polyacrylamide. Refer to WDNR's stormwater web page of technical standards at: http://dnr.wi.gov/runoff/stormwater/techstds.htm.
- 6. Dewatering Water pumped from the site shall be treated by using a temporary sedimentation basin, portable dewatering basin, geotextile bag, or an equivalent device. Show on the plan the anticipated locations of dewatering activity, and provide an engineering detail of the dewatering system. Devises shall comply with WDNR Technical Standard 1061 found at http://dnr.wi.gov/runoff/stormwater/techstds.htm. This water shall be discharged in a manner that does not induce erosion of the site or adjacent property.
- 7. Storm Sewer Inlets Provide WDOT Type D "CatchAll" inlet protection or equivalent. Refer to WDOT Product Acceptability List at: http://www.dot.wisconsin.gov/business/engrserv/pal.htm. Inlet protection shall be installed prior to the storm sewer system receiving site runoff. Other than for performing maintenance, these devices shall not be removed until plat—level stabilization is
- 9. Building and waste materials shall be prevented from running—off the site and entering waters of the state in conformance with NR151.12(6m).
- 10. No solid material shall be discharged or deposited into waters of the state in violation of Ch. 30 or 31 of the Wisconsin State Statutes or 33 USC 1344 permits.
- 11. Erosion control devices shall adhere to the technical standards found at: http://dnr.wi.gov/runoff/stormwater/techstds.htm and comply with all City of Madison ordinances.
- 12. All debris tracked onto public streets shall be be swept or scraped clean by the end of each workday.
- 13. All building and waste material shall be handled properly to prevent runoff of these materials off of the site.
- 14. All disturbed areas shall be seeded, sodded, or otherwise restored immediately after grading activities have been completed per the approved landscape plan.

Emergency Contact Craig Enzenroth Gallina Corporation 101 E. Main Street, Suite 500 Mount Horeb, WI 53572 (608) 437-8300

December 1, 2013 Install silt fence and construction entrance. Begin demolition and

August 1, 2014 Building construction complete. Restore all disturbed areas. October 1, 2014 Vegetation established.

SCALE : ONE INCH = TWENTY FEET TO OBTAIN LOCATION OF PARTICIPANTS' UNDERGROUND FACILITIES BEFORE YOU DIG IN WISCONSIN CALL DIGGERS HOTLINE 1-800-242-8511 OR 811 TOLL FREE TDD(FOR THE HEARING IMPAIRED)(800)542-2289 WIS. STATUTE 182.0175 (1974) REQUIRES MIN. OF 3 WORK DAYS NOTICE BEFORE YOU EXCAVATE BENCHMARK TABLE 865.24' TOP NUT HYDRANT AT S. MILLS ST. AND MOUND ST
859.45' TOP NUT HYDRANT AT S. MILLS ST. AND ST. JAMES CT.
854.80' TOP NUT HYDRANT AT S. MILLS ST. AND MILTON ST.

> Silt Sock <u>LEGEND</u> FIRE HYDRANT CIRCULAR CATCH BASIN ----w--- WATER MAIN RECTANGULAR CATCH BASIN STORM SEWER INLET © ELECTRIC MANHOLE ----BuTel----- BURIED TELEPHONE TELECOMM. MANHOLE ----- BURIED ELECTRIC —cotv— BURIED CABLE TV 谜面" DECIDUOUS TREE WATER VALVE (1)1" CONIFEROUS TREE

SANITARY SEWER MANHOLE GAS VALVE BITUMINOUS PAVEMENT TV CABLE TV PEDESTAL CNC. CONCRETE PAVEMENT E ELECTRIC PEDESTAL LS. LANDSCAPING T TELEPHONE PEDESTAL arnothing utility pole ⇒ BOLLARD ☐ LIGHT POLE → BENCHMARK → GUY WIRE

--- SIGN • IRON PIPE FOUND (OUTSIDE DIAMETER NOTED) SOLID IRON ROD FOUND SIZE NOTED

() INDICATES RECORDED AS

O 3/4" X 18" SOLID IRON RE-ROD SET, WT. 1.50 lbs./ft. SET MAG NAIL

DISTANCES ARE MEASURED TO THE NEAREST HUNDREDTH OF A FOOT. BUILDING DIMENSIONS ARE MEASURED TO THE NEAREST TENTH OF A FOOT.

GRADING & EROSION CONTROL LEGEND

----852---- EXISTING MINOR CONTOUR ----855---- EXISTING MAJOR CONTOUR ----- ST ------ PROPOSED STORM SEWER TRACKING PAD SILT SOCK

INLET PROTECTION REQUIRED



GRADING AND EROSION

CONTROL PLAN

PROJECT #: BSE 1620

REVISION DATES:

ISSUE DATES:

07/31/2013

PLOT DATE: 07/31/2013

Surveying and Engineering, Inc. This document contains confidential or proprietary information of Burse Surveying and Engineering, Inc. Neither the document nor the information herein is to be reproduced, distributed, used or disclosed, either in whole or in part, except as specifically authorized by Burse Surveying

DRAWING NUMBER

and Engineering, Inc.

Burse

Surveying and Engineering, Inc

1400 E. Washington Ave, Suite 158


Madison, WI 53703 Phone: 608-250-9263 Fax: 608-250-9266

e-mail: Mburse@BSE-INC.net

www.bursesurveyengr.com

ompanies

-

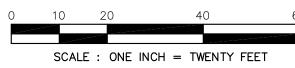

- 1. ALL PRIVATE UTILITIES (GAS, ELECTRIC, AND TELECOMMUNICATIONS) SERVING EXISTING BUILDINGS SCHEDULED FOR DEMOLITION TO BE ABANDONED OR REMOVED BY CORRESPONDING UTILITY COMPANY.
- 2. IT IS THE CONTRACTOR'S RESPONSIBILITY TO VERIFY THE LOCATION OF UNDERGROUND UTILITIES. UTILITIES WERE LOCATED BY OBSERVED EVIDENCE, MARKINGS PROVIDED BY DIGGER'S HOTLINE, AND RECORD DRAWINGS FROM THE CITY OF MADISON.
- 3. ALL ITEMS DENOTED WITH "**" ARE SUBJECT TO THE DESIGN OF STREET IMPROVEMENTS PREPARED BY THE CITY OF MADISON ENGINEERING DEPARTMENT PROJECT NO. 53B2321 AND SHALL BE INSTALLED PER THESE PLANS. CONTRACTOR SHALL COORDINATE WITH THE DESIGN ENGINEER TO VERIFY PROPOSED SIZES INVERTS, AND GRADES.

BENCHMARK TABLE

NUMBER ELEVATION DESCRIPTION

1 865.24' TOP NUT HYDRANT AT S. MILLS ST. AND MOUND ST

2 859.45' TOP NUT HYDRANT AT S. MILLS ST. AND ST. JAMES CT.

3 854.80' TOP NUT HYDRANT AT S. MILLS ST. AND MILTON ST.



FIRE HYDRANT

CIRCULAR CATCH BASIN

STORM SEWER INLET

© ELECTRIC MANHOLE

磁灯" DECIDUOUS TREE

1" CONIFEROUS TREE

BITUMINOUS PAVEMENT

CNC. CONCRETE PAVEMENT

LS. LANDSCAPING

■ BOLLARD → BENCHMARK

TELECOMM. MANHOLE

STORM SEWER MANHOLE

SANITARY SEWER MANHOLE

RECTANGULAR CATCH BASIN

<u>LEGEND</u>

- —san—— SANITARY SEWER —ST—— STORM SEWER
- ---BuTel---- BURIED TELEPHONE ----- BURIED ELECTRIC
- —catv—— BURIED CABLE TV -FO- BURIED FIBER OPTIC WATER VALVE GAS VALVE
- TV CABLE TV PEDESTAL E ELECTRIC PEDESTAL TELEPHONE PEDESTAL \varnothing UTILITY POLE
- C LIGHT POLE J GUY WIRE -- SIGN
- IRON PIPE FOUND (OUTSIDE DIAMETER NOTED)
- SOLID IRON ROD FOUND SIZE NOTED
- O 3/4" X 18" SOLID IRON RE-ROD SET, WT. 1.50 lbs./ft.
- SET MAG NAIL () INDICATES RECORDED AS
 - DISTANCES ARE MEASURED TO THE NEAREST HUNDREDTH OF A FOOT. BUILDING DIMENSIONS ARE MEASURED TO THE NEAREST TENTH OF A FOOT.



1400 E. Washington Ave, Suite 158 Madison, WI 53703 Phone: 608-250-9263 Fax: 608-250-9266 e-mail: Mburse@BSE-INC.net www.bursesurveyengr.com



companies St., Suite 500

PROJECT #: BSE 1620

| PLOT DATE: 07/31/2013 **REVISION DATES:**


ISSUE DATES: 07/31/2013

UTILITY PLAN



Surveying and Engineering, Inc. This document contains confidential or proprietary information of Burse Surveying and Engineering, Inc. Neither the document nor the information herein is to be reproduced, distributed, used or disclosed, either in whole or in part, except as specifically authorized by Burse Surveying and Engineering, Inc.

DRAWING NUMBER

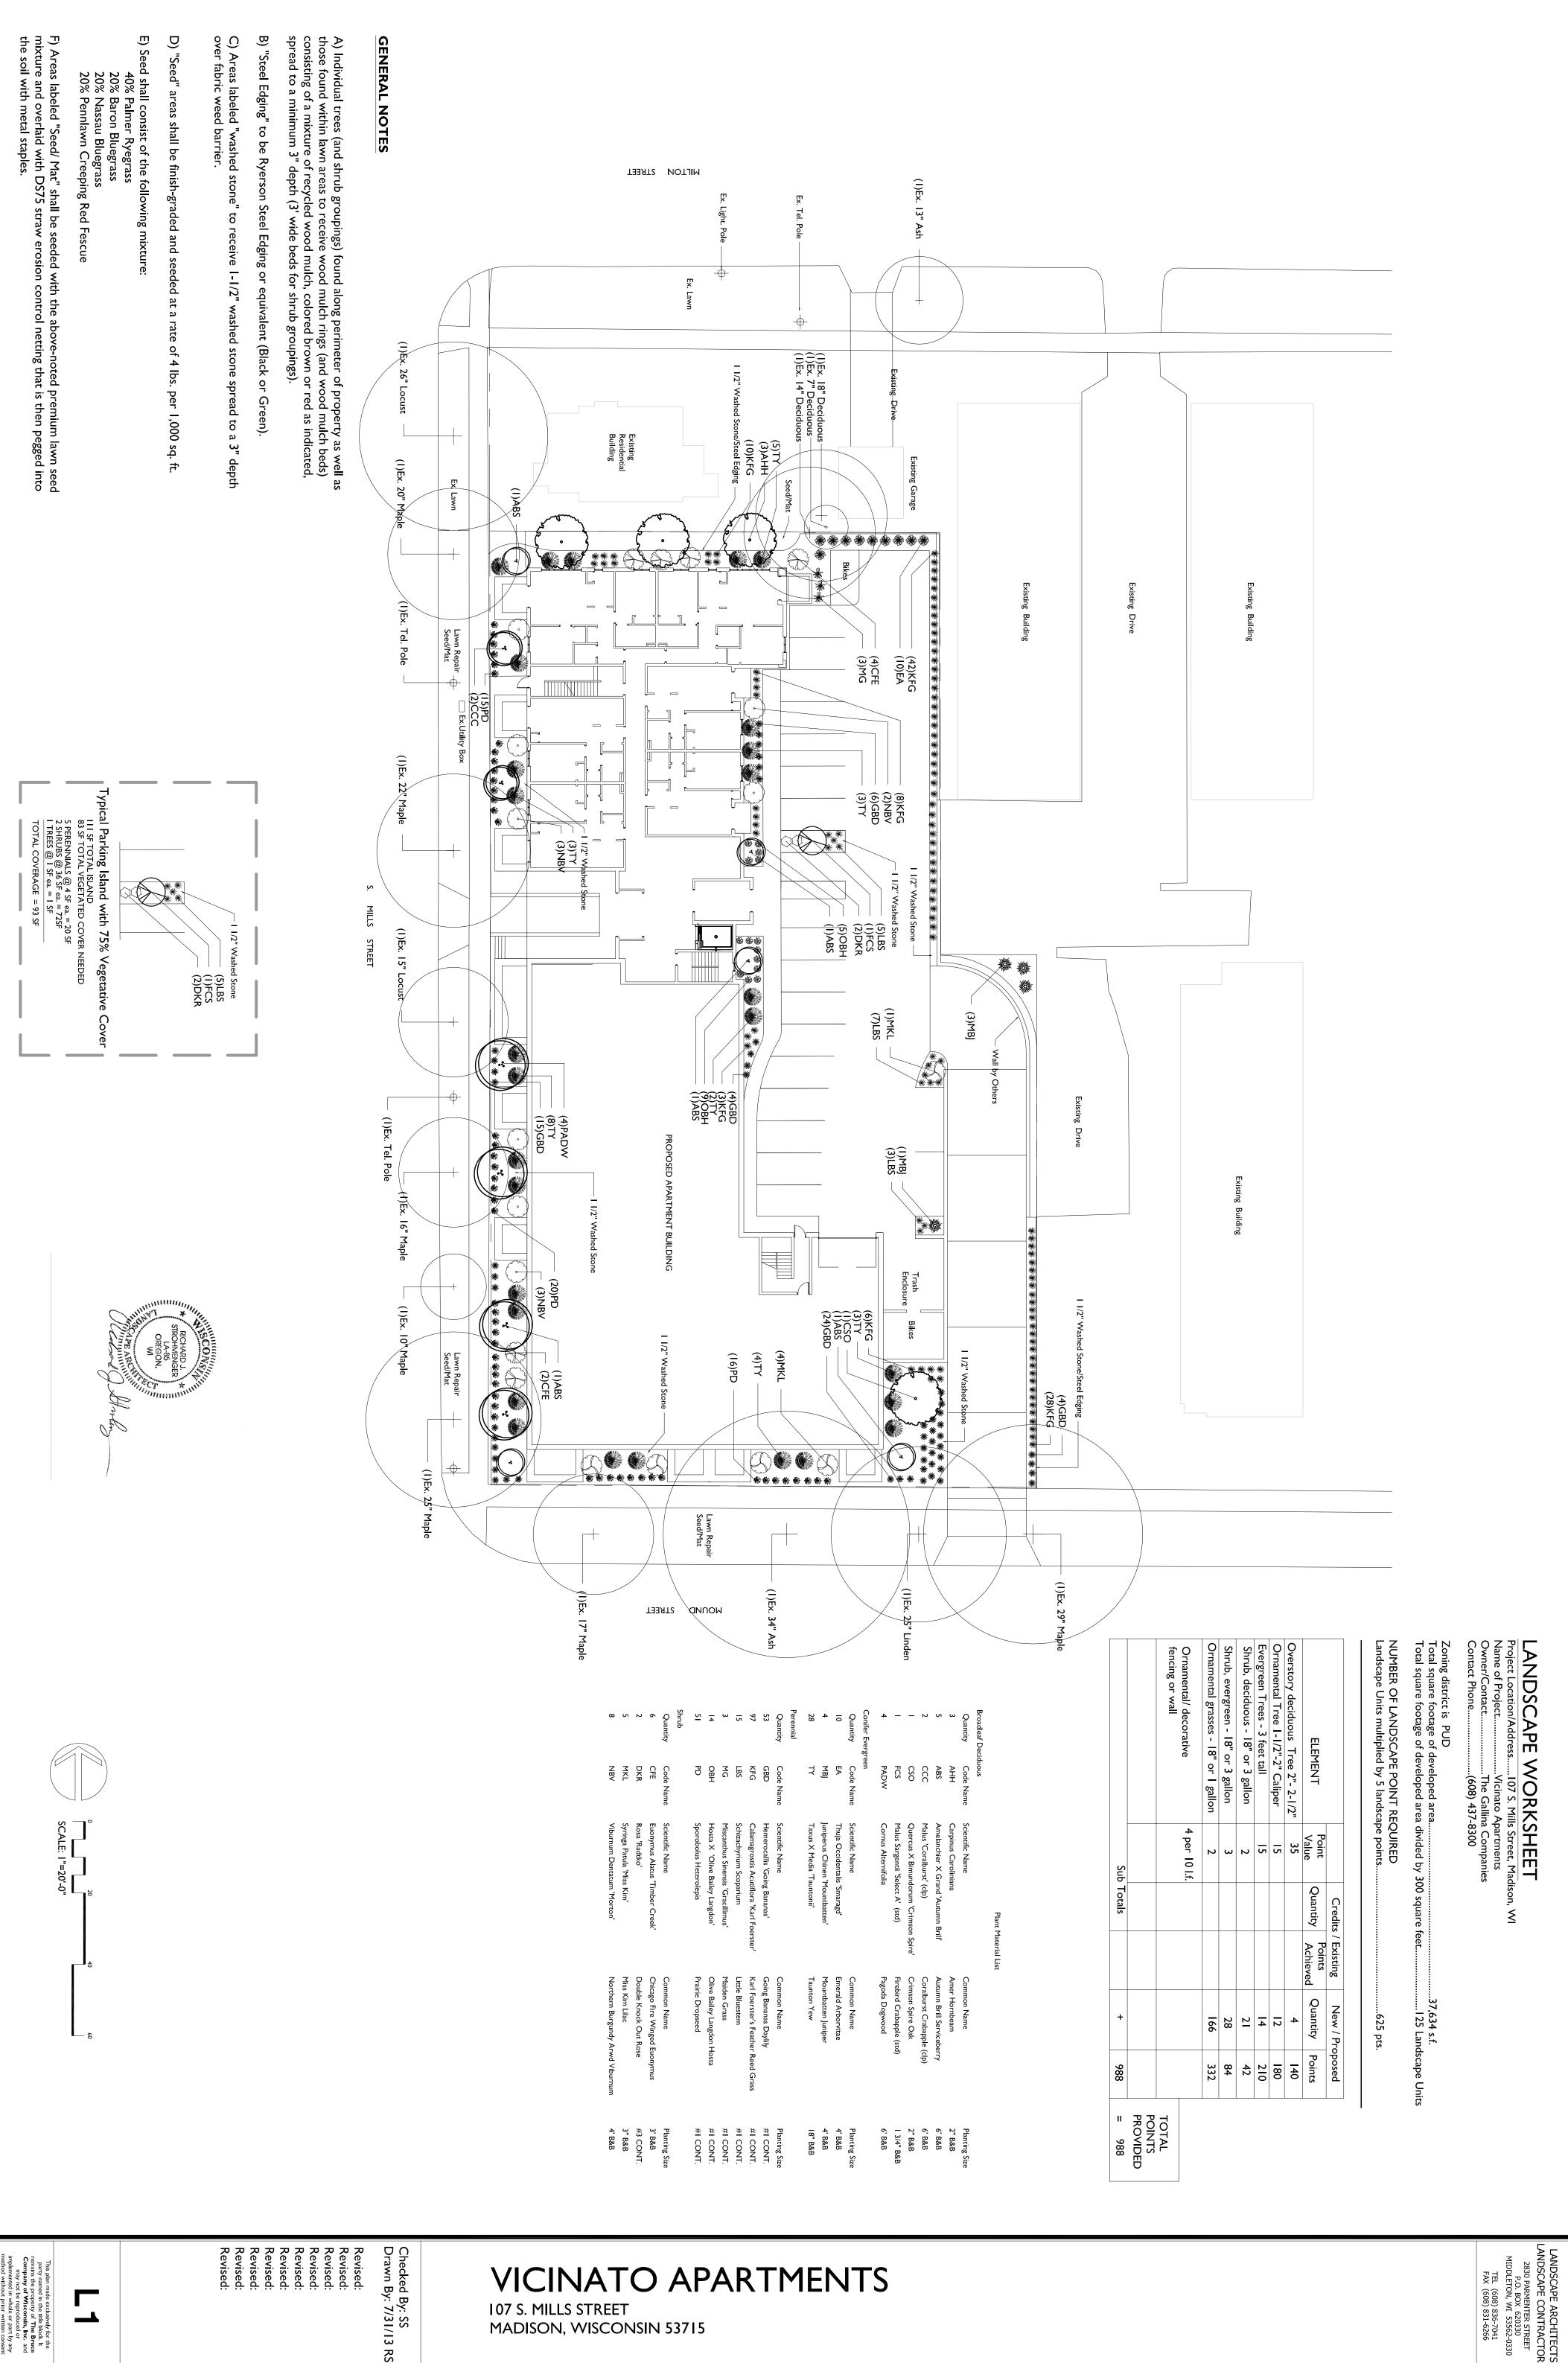



Revised:
Revised:
VICINATO APARTMENTS

107 S. MILLS STREET MADISON, WISCONSIN 53715

