




11 DOUBLE LOADED BIKE RACK DETAIL

SCALE: 1/4" = 1'-0" -02775.402

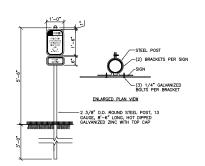

WISCONSIN 10 VAN ACCESSIBLE PARKING SIGN
A101 SCALE: 1/2" = 1"-0" 02890.101

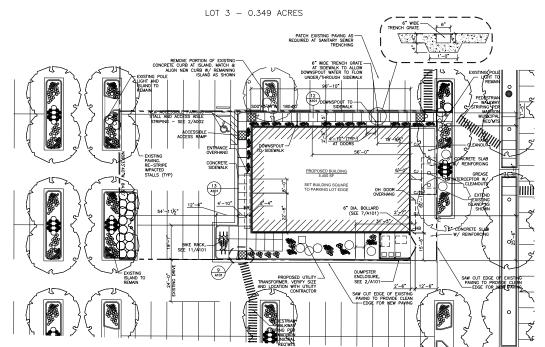

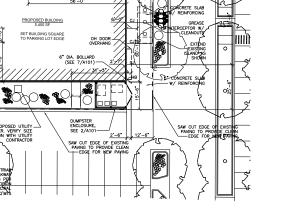



LEGEND

CONCRETE FLATWORK:
6" CONCRETE SLAB W/ 6x6 - W2.9xW2.9 WWF
ON 6" COMPACTED SUBBASE SIDEWALK RAMP: (STAMPED DETECTABLE WARNING GRID)


*ALL PAVEMENT MARKINGS TO BE WHITE


PAVEMENT DESIGN:
3" BITUMINOUS PAVING (1½" SURFACE
COURSE, 1½" BASE COURSE) OVER 8" THICK
LAYERED BASE COURSE (14" OF BREAKER
RUN STONE BELOW ±4" OF COMPACTED BASE
COURSE)

CONCRETE SIDEWALK:

4° CONCRETE — NO MESH



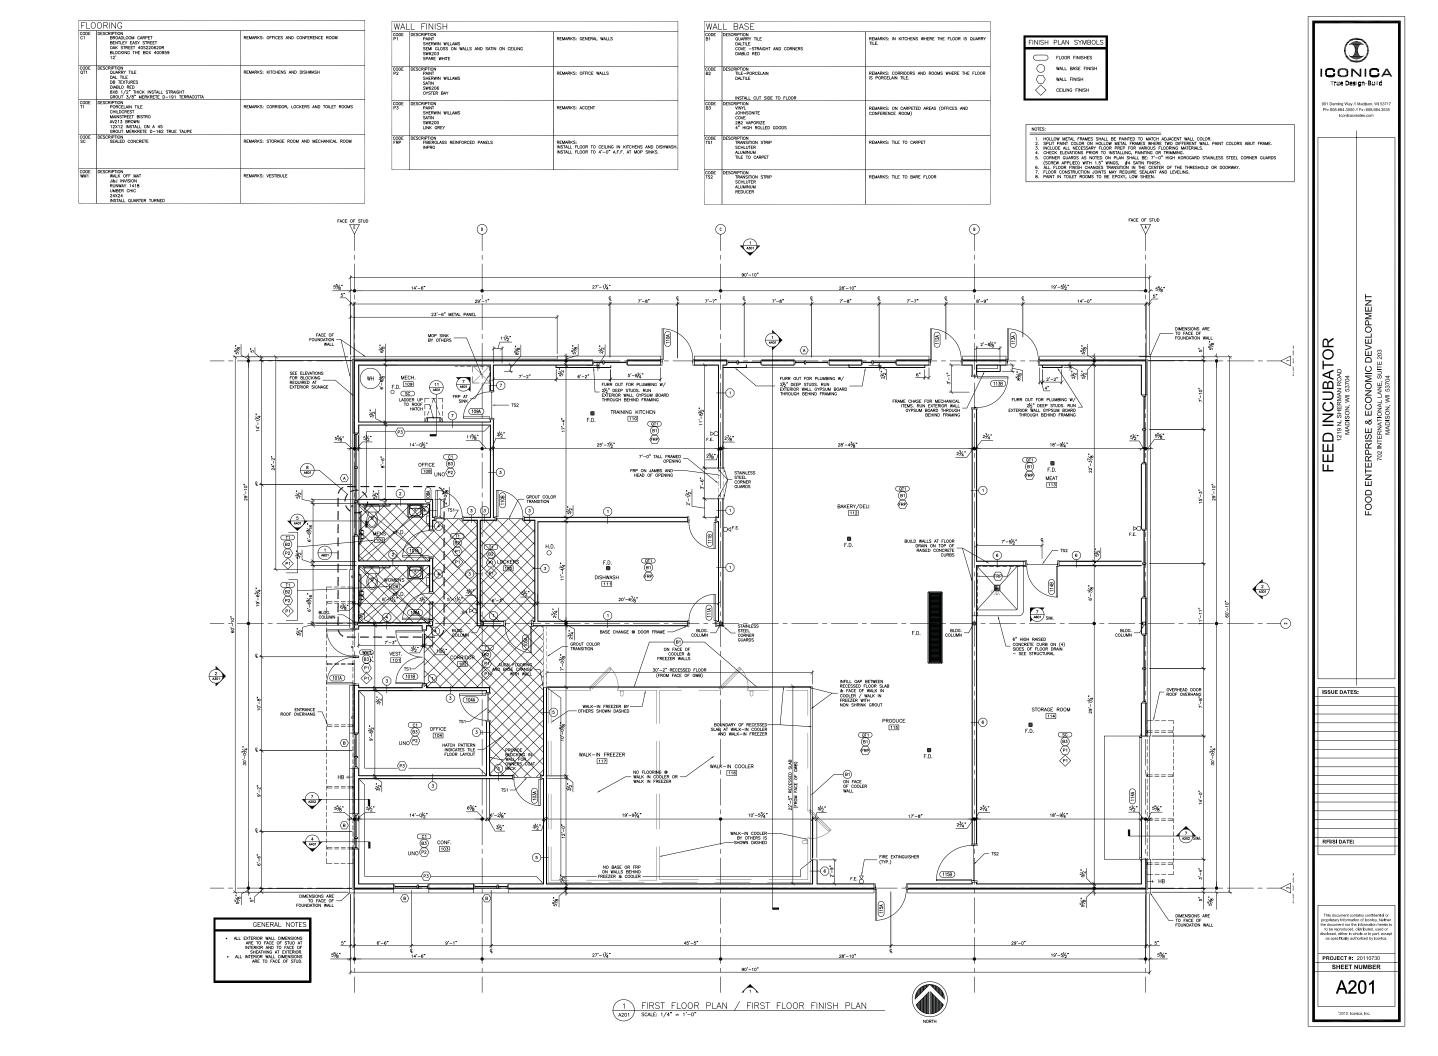

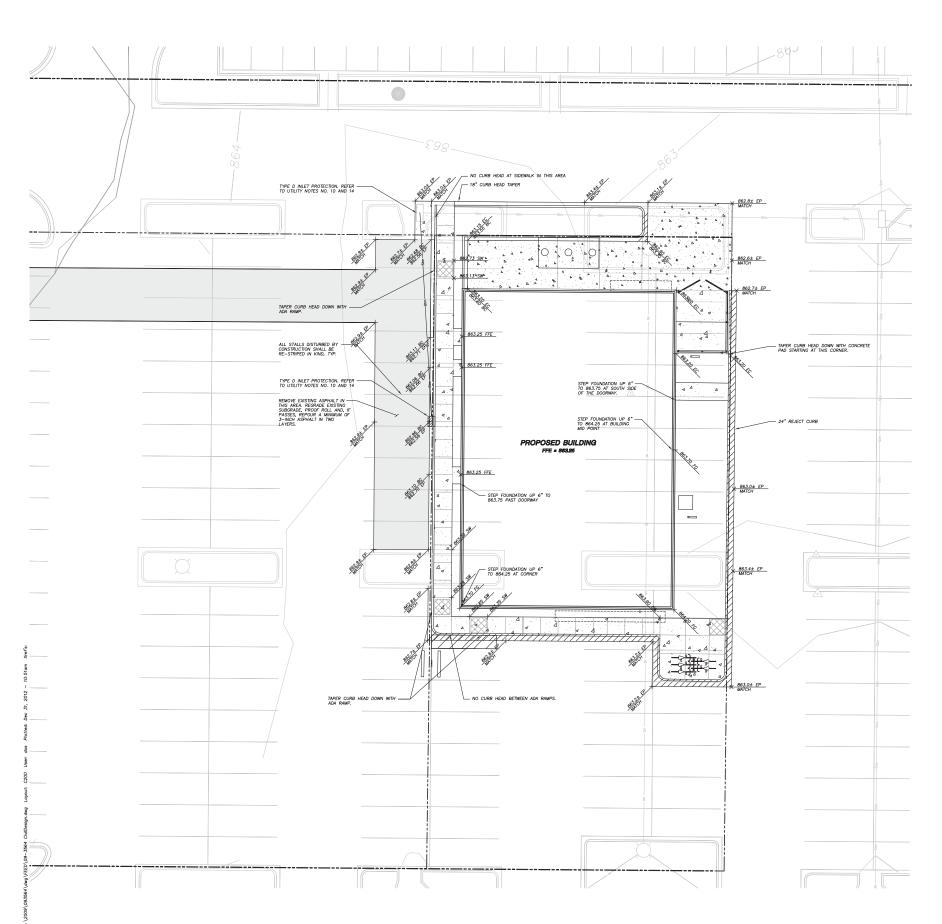



PROPERTY LINE
STORM SEWER
SUM STORM SEWER
CURB AND GUTTER
REJECT CURB AND GUTTER
REJECT CURB AND GUTTER
RESCH PATCH LIMITS
ASPHALIC PAREMENT
CONCRETE PAREMENT



- GENERAL NOTES

 1. SURVEY DATA BASED UPON AS-BUILT SURVEY COMPLETED ON 5-28-2009 AND 06-09-2009 ALONG WITH ADDITIONAL INFORMATION PROVIDED BY OTHERS.
- ALL WORK IN THE ROW SHALL BE IN ACCORDANCE WITH THE CITY OF MADISON STANDARD SPECIFICATIONS FOR PUBLIC WORKS CONSTRUCTION.
- JSD SHALL BE HELD HARMLESS AND DOES NOT WARRANT ANY DEVIATIONS BY THE OWNER/CONTRACTOR FROM THE APPROVED CONSTRUCTION PLANS THAT MAY RESULT IN DISCIPLINARY ACTIONS BY ANY OR ALL REGULATORY AGENCIES.

CONSTRUCTION SITE EROSION CONTROL REQUIREMENTS

- 2. NOTALL ERISSION CONTROL MEASURES PROPE TO ANY STE MORE INCLUDING CRADING OF INSTURBANCE OF COSTONIC SPRINGE METHOD. IS SHOWN ON FAM. MODIFICATIONS TO SENDANT CONTROL OF SOME MAY BE CONDUCTED TO MEET UNFORESEEN FIELD CONDITIONS IF MODIFICATIONS CONFORM TO WORK TECHNICAL STANDARDS.
- INSPECT EROSION CONTROL MEASURES AFTER EACH 1/2" OR GREATER RAINFALL. REPAIR ANY DAMAGE OBSERVED DURING THE INSPECTION.
- EROSION CONTROL MEASURES SHALL BE REMOVED ONLY AFTER SITE CONSTRUCTION IS COMPLETE WITH ALL SOIL SURFACES HAVING AN ESTABLISHED VEGETATIVE COVER.
- INSTALL EROSION CONTROLS ON THE DOWNSTREAM SIDE OF STOCKPILES AND PROVIDE TEMPORARY SEEDING ON STOCKPILES WHICH ARE TO REMAIN IN PLACE FOR MORE THAN 7 DAYS.
- 8. EROSION CONTROL FOR UTILITY CONSTRUCTION (STOPM SEERS, SWIMARY SEERS, WATER MAIN, ETC.):

 8. BACKFILL, COMMOD REVIEW, WATERN ON THE RIGH SEE OF THE TREWS,

 8. BACKFILL, COMMOT AND STRENGE THE TREWSH MANDONERY METER PIPE CONSTRUCTION.

 C. DISCHARGE TEBUCH MAREE MITO A SEDIMENTATION BASIN OR FUTERING TANK IN ACCORDANCE WITH


 THE DEWINTERNIC TECHNICAL STANLARD NO. 1061 PRIOR TO RELEASE INTO THE STORM SEWER,

 RECEIVED STEAM, OR DOWNINGE DITCH.
- INSTALL TYPE D INLET PROTECTION AROUND ALL STORM SEWER INLETS AND CATCH BASINS THAT MAY RECEIVE RUNDET FROM AREAS UNDER CONSTRUCTION. REFER TO CITY OF MADISON STANDARD DETAIL DRAWING FOR PESPECTURE DETAIL


- CONTRACTOR SHALL TAKE ALL NECESSARY STEPS TO CONTROL DUST ARISING FROM CONSTRUCTION OPERATIONS. REFER TO WDNR TECHNICAL STANDARD 1068.
- CONTRACTOR TO PROVIDE SOLID LID OR METAL PLATE ON ALL OPEN MANHOLES DURING CONSTRUCTION TO MINIMIZE SEDIMENT FROM ENTERING THE STORM SEWER SYSTEM.

GRADING AND SEEDING NOTES

- . ALL DISTURBED AREAS SHALL BE SEEDED AND MULCHED IMMEDIATELY FOLLOWING GRADING ACTIVITIES. SEED MIX TO BE IN ACCORDANCE WITH LANDSCAPE PLAN.
- ALL PROPOSED GRADES SHOWN ARE FINISHED GRADES. CONTRACTOR SHALL VERIFY ALL GRADES, MAKE SURE ALL AREAS DRAIN PROPERLY AND SHALL REPORT ANY DISCREPANCIES TO THE ENGINEER PRIOR TO CONSTRUCTION.
- CONTRACTOR SHALL WATER ALL NEWLY SEEDED AREAS DURING THE SUMMER MONTHS WHENEVER THERE
 IS A 7 DAY LAPSE WITH NO SIGNIFICANT RAINFALL.
- 4. THE CONTRACTOR SHALL NOTIFY THE CITY OF MADISON A MINIMUM OF TWO (2) WORKING DAYS IN ADVANCE OF ANY SOIL DISTURBING ACTIVITY.

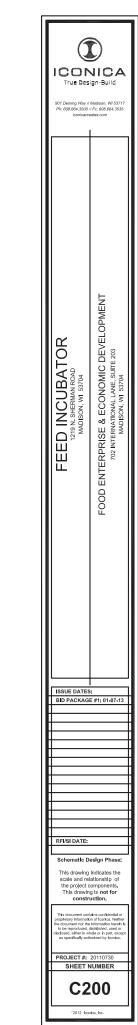

1 GRADING & EROSION CONTROL PLAN
C200 SCALE: 1" = 10'-0"

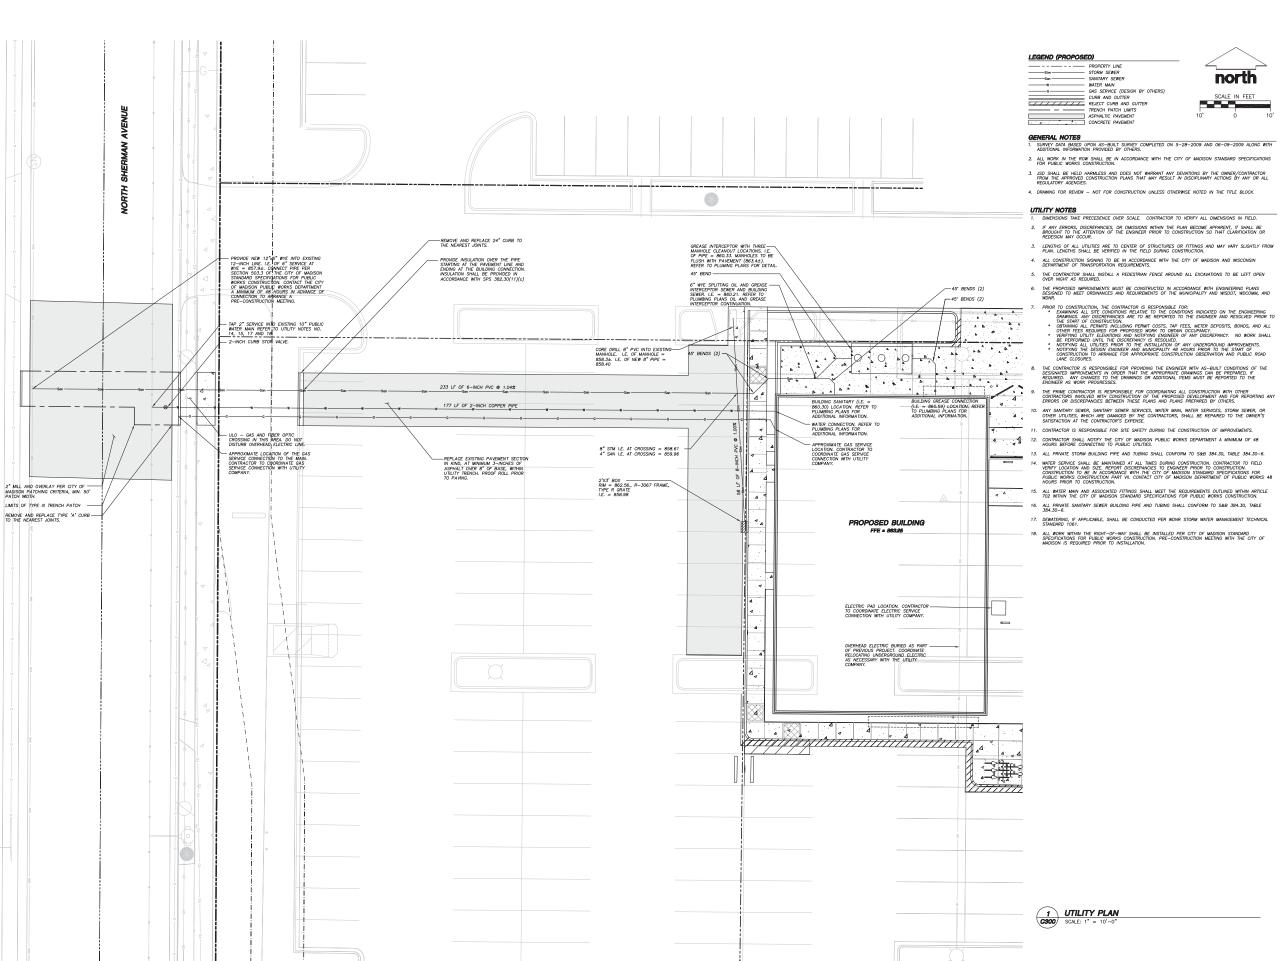

ICONICA ENTERPRISE & ECONOMIC DEVELOPMENT 702 INTERNATIONAL LANE, SUITE 203 INCUBATO 19 N. SHERMAN ROAD MADISON, WI 53704 ED 22 FOOD I ISSUE DATES: BID PACKAGE #1: 01-07-13


RFI/SI DATE:


This drawing indicates the

SHEET NUMBER C300

north

SCALE IN FEET

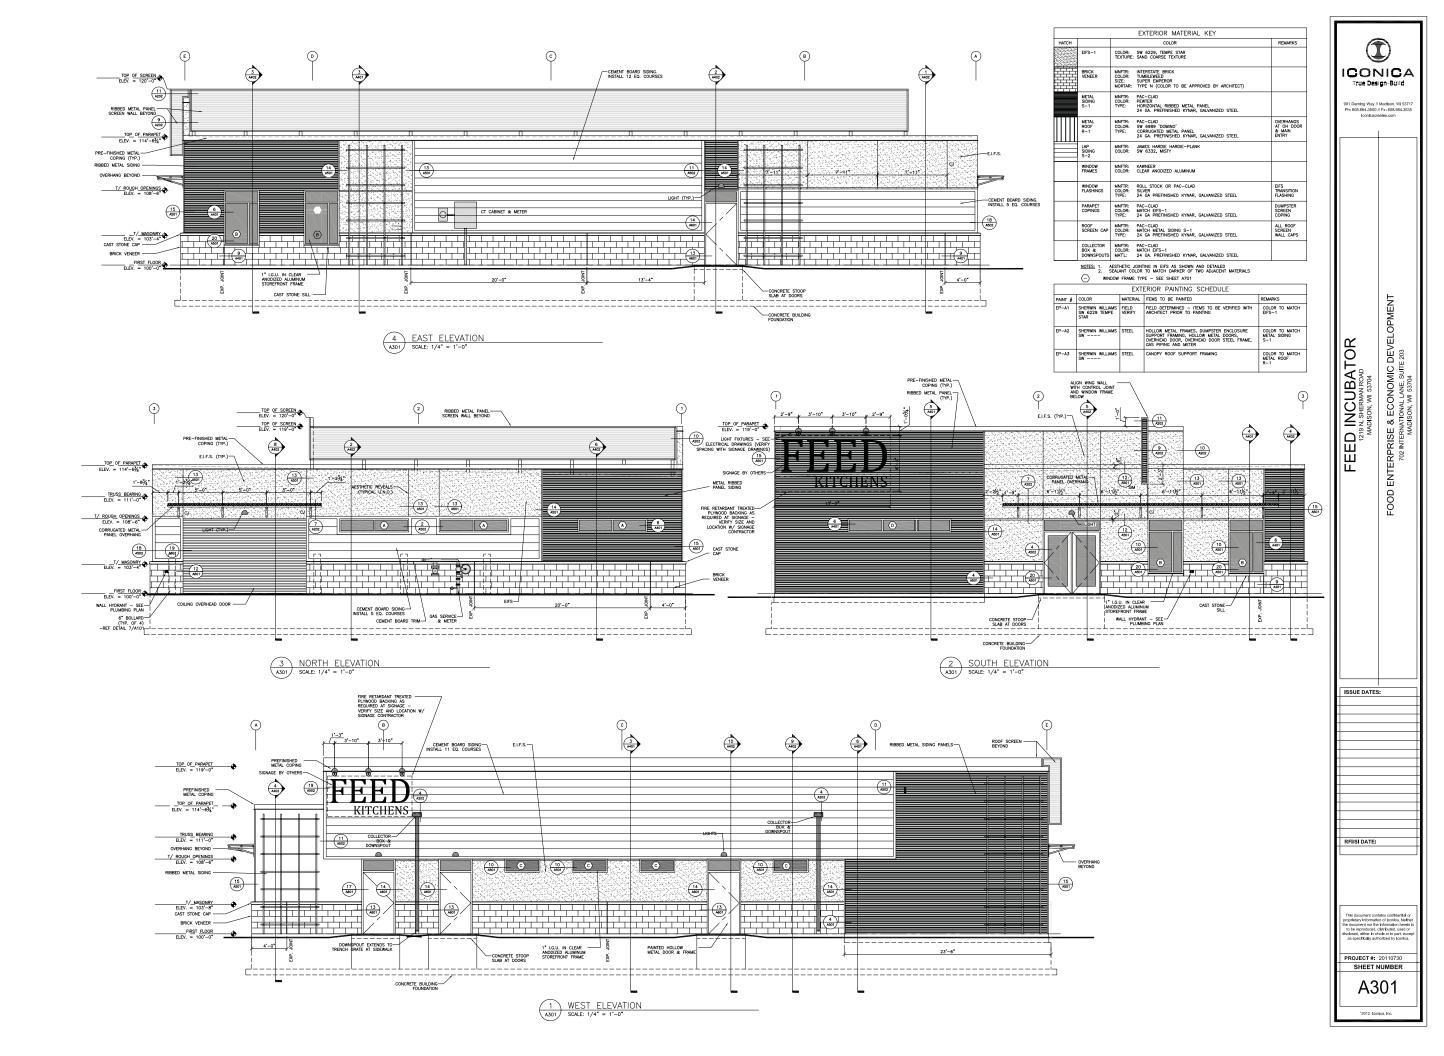

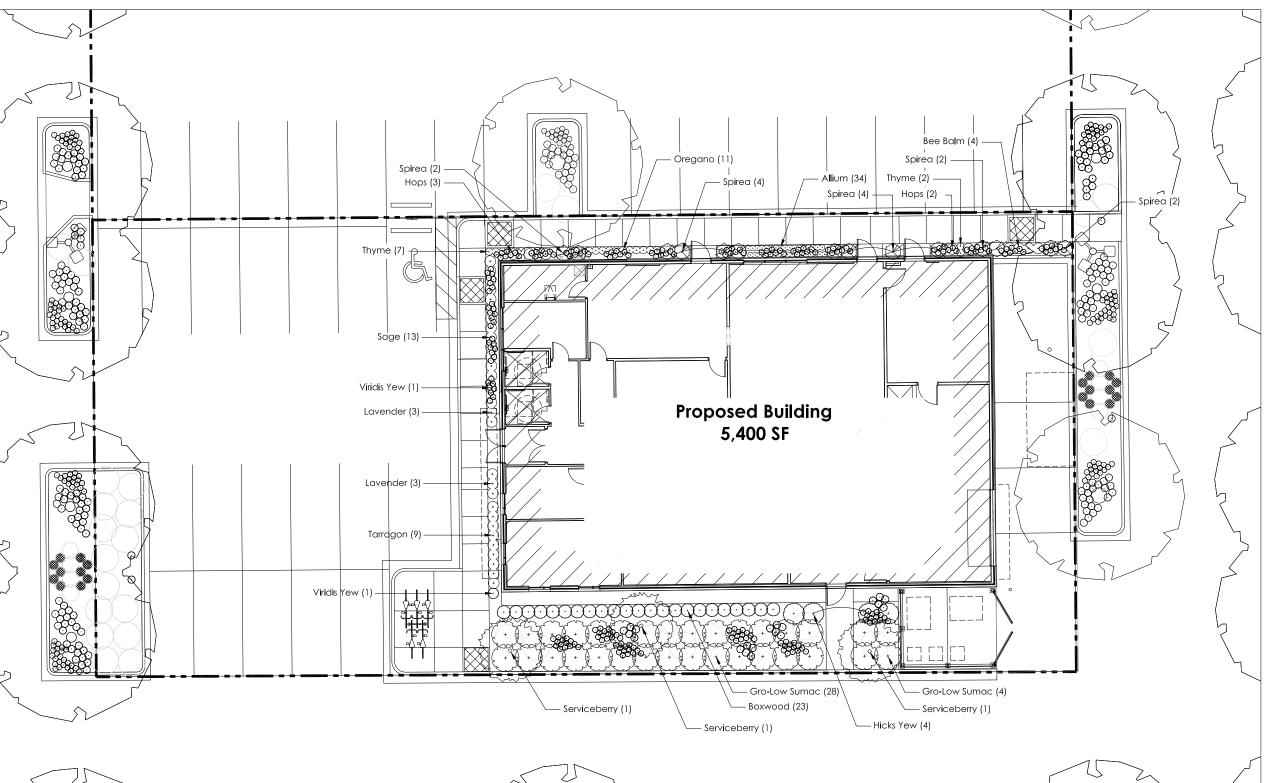

City of Madison Landscape Requirements: Required Landscape Units: 1 Unit/300 sf of developed area 15158 sf/300=50.5 units = 252.6 points Development Frontage Landscaping: N/A (no frontage)
Interior Parking Lot Landscaping: N/A (not over 20 stalls)
Foundation Plantings:
Ornamental Trees: 15 points x 3 = 45 points
Shrub, Deciduous: 2 points x 46 = 92 points


Shrub, Evergreen: 3 points x 29 = 87 points Ornamental Grasses (Perennials): 2 points x 86 = 172

Total Points Provided: 396 Points

All plantings shall conform to quality requirements as per ANSI Z60.1.
 All planting beds to be mulched with naturally colored brown shredded hardwood bark

mulch to 3" depth min.

		PLANT L I ST		
qty	botanical name	common name	mature size (h x w)	notes
	-	Deciduous Trees		
3	Amelanchier laevis	Allegheny Serviceberry	25' x 15'	WI native; edible fruit
		Evergreen Shrubs		
23	Buxus x 'Green Mountain'	Green Mountain Boxwood	5' x 3'	
4	Taxus x media 'Hicksii'	Hicks Yew	10' x 5'	
2	Taxus x media "Viridis"	Viridis Yew	10' x 2'	
		Deciduous Shrubs		
32	Rhus aromatica 'Gro-Low'	Gro-low Sumac	30" x 6"	
14	Spiraea betulifolia 'Tor'	Tor Birchleaf Spirea	3' x 3'	
		Perennials/Herbs		
34	Allium species	Ornamental/Edible Onion	18-24" x 8-12"	Edible
9	Artemisia dracunculus	Tarragon	30" x 30"	Edible herb
5	Humulus lupulus	Perennial Hops	20' x 8'	Cones used for brewing beer
6	Lavandula species	Perennial Lavender	24" x 24"	Edible/Fragrant herb
4	Monarda didyma 'Marshall's Delight'	Marshall's Delight Bee Balm	36" x 24"	
11	Oregano	Perennial Oregano	12-24" x 18"	Edible herb
13	Salvia officinalis	Common/Garden Sage	18" x 24"	Edible herb
9	Thymus species	Perennial Thyme	8-10" x 12-18"	Edible herb

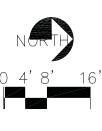



vierbicher Vierbicher

ICONICA True Design-Build

ENTERPRISE & ECONOMIC DEVELOPMENT 702 INTERNATIONAL LANE, SUITE 203 MADISON, WI 33704 FEED INCUBATOR NORTHGATE MADISON, WISCONSIN

ISSUE DATES:

RFI/SI DATE:

This drawing indicates the scale and relationship of the project components. This drawing is **not for**

PROJECT #: 20110730 SHEET NUMBER

L100