


Northwest elevation (Willy Street) 1/16" = 1'-0"

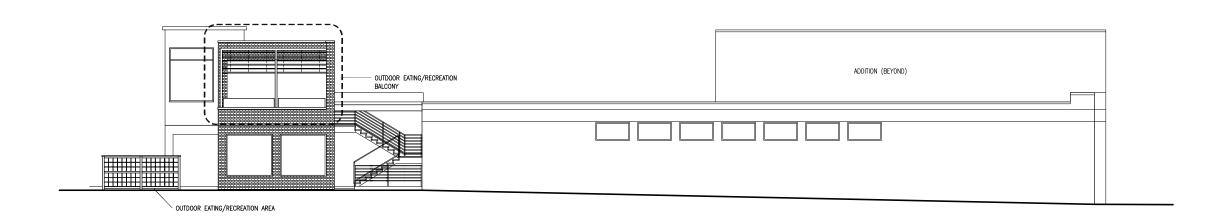

Southwest elevation 1/16" = 1'-0"

ARD EBERLE ARCHITECTS

116 King Street Madison, WI 53703 (608) 204-7464


Willy Street Co-op

1221 Williamson St Madison, WI

Building Elevations

11/26/2012

A2

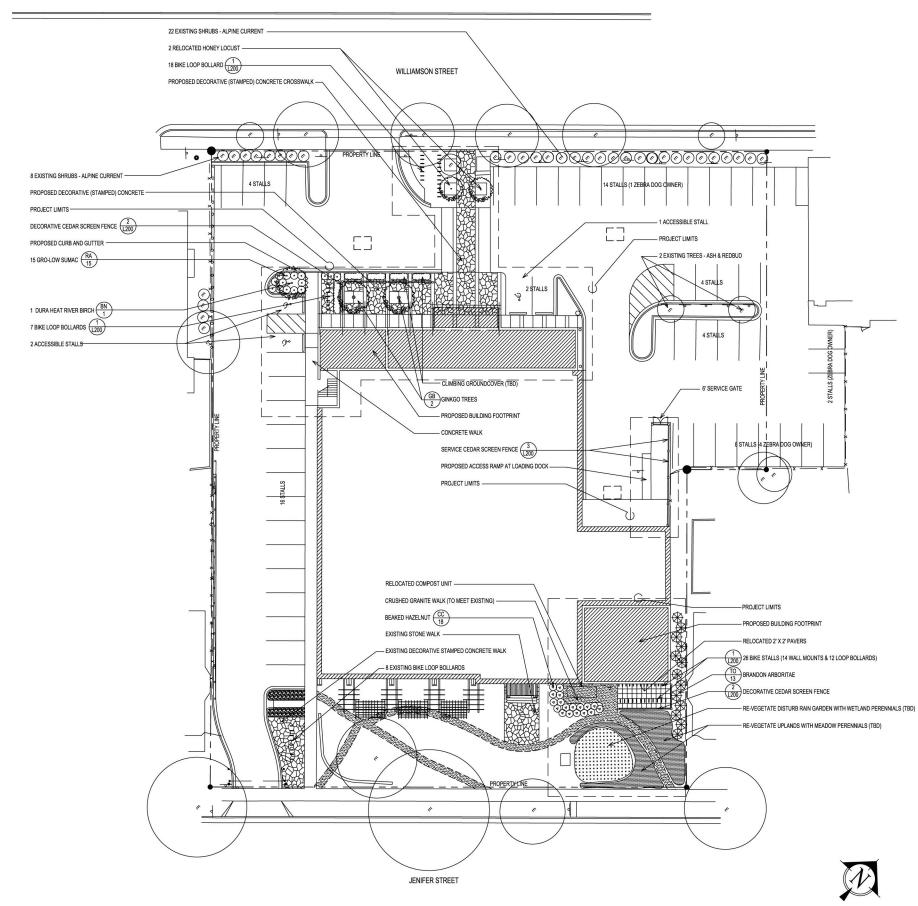

### LANDSCAPE WORKSHEET

Parking Lots, Storage Areas and Loading Areas (Section 28.04 Madison General Ordinance)

Project Location/Address:	1221 WILLIAMSON STREET	
Name of Project:	WILLY STREET CO-OP	
Owner/Contact:	WILLY STREET CO-OP	
Address:	1221 WILLIAMSON STREET	

#### FOR PARKING LOTS WITH GREATER THAN 20 STALLS, LANDSCAPE PLANS MUST BE STAMPED BY A REGISTERED LANDSCAPE ARCHITECT

Number of Trees Required
 The number of trees required for a parking lot is based on the number of parking stalls. Using the Schedule for Required Trees on the reverse side of this worksheet, determine the number of trees required. (Example: One tree is required for 10 parking stalls).

Landscape requirements for storage areas are determined by dividing the total square footage of the storage area by (300) square feet. This converts <u>area</u> to <u>stalls</u>. [Example: 10,000 square feet is equivalent to (33) stalls or (3) trees and (160) points].

Number of Parking Stalls -55

Total Square Footage of the Storage Area Divided by Three Hundred (300) Square Feet N/A

Number of Canopy Shade Trees Required (2" - 2 1/2" Caliper) (See Schedule on reverse side)

II. Number of Landscape Points Required

The number of points required is also based on the number of parking stalls. Using the Point
Schedule for Landscape Elements on the reverse side of this worksheet, determine the number of points required. (Example: 49.5 points are required for 10 stalls). A point fraction of
(.5) or less may be disregarded, while a fraction in excess of (.5) must be counted as one
point. Thus: 49.5 points would be rounded down to 49.0 points required.

The number of points required for <u>loading areas</u> is (75) points for each loading berth. — (See Schedule on reverse side) 75

Number of Points Required (See Schedule on reverse side)-346

Tabulation of Points and Credits
Indicate below the quantity and points for all pertinent landscape elements. Also, credit information for boundary screening and any existing elements to be retained.

				CREDITS		
ELEMENT	POINT VALUE	QUANTITY	POINTS ACHIEVED	QUANTITY	Points	
Canopy Tree: 2" - 2 1/2*	35	3	105	6	210	
Deciduous Shrub	2	15	30	30	60	
Evergreen Shrub	3					
Decorative Wall or Fence (per 10 L.F.)	5	8	40			
Earth Berm (per 10 L.F.) Avg. Height 30" Avg. Height 15"	5 2					
Evergreen Trees 3' height minimum	15					
Canopy Tree or Small Tree 1 ½" – 2" Caliper (i.e., Crab, Hawthorn)	15					
		Sub Totals	175	_	270	

\*Trees required in Part I above, are not to be included in the point count.



TOTAL

445

261

LA-92 MADISON WI

Date: 12 18 12

00	
Canopy	Trees

Key	Quantity	antity Scientific Name Common Name		Size Root		Spacing
BN	1	Betula nigra 'BNMTF'	Dura Heat River Birch	.2 1/2"	Cal.	See Plan
GB	2	Ginkgo biloba 'Autumn Gold'	Autumn Gold Ginkgo	.2 1/2"	Cal.	See Plan

## Conifer

20 00 10						
Key	Quantity	Scientific Name	Common Name	Size	Root	Spacing
TO	13	Thuja occidentalis 'Brandon'	Brandon's Arborvitae	5'	Height	See Plan

## Shrubs

Siliubs						
Key	Quantity	Scientific Name	Common Name	Size	Root	Spacing
CC	18	Corylus cornuta	Beaked Hazelnut	#3	Cont.	See Plan
RA	15	Rhus aromatica 'Gro-low'	Gro-low Sumac	12-18"	Height	See Plan

## Site Plan Submittal

# WILLY STREET CO-OP

Madison, Wisconsin



Willy Street Co-op 1221 Williamson Street Madison, WI 53703



ISSUED FOR: SITE PLAN SUBMITTAL DRAWING TITLE:

# LANDSCAPE PLAN

SCALE:	0	10'	20'	30'	40'
PROJECT	NUMBE	R:			
5.51 1.53	9				1209.0
DRAWING	NUMBE	R:			100
					- 100