



NORTH ELEVATION

EAST ELEVATION

1/4'=1'-0'

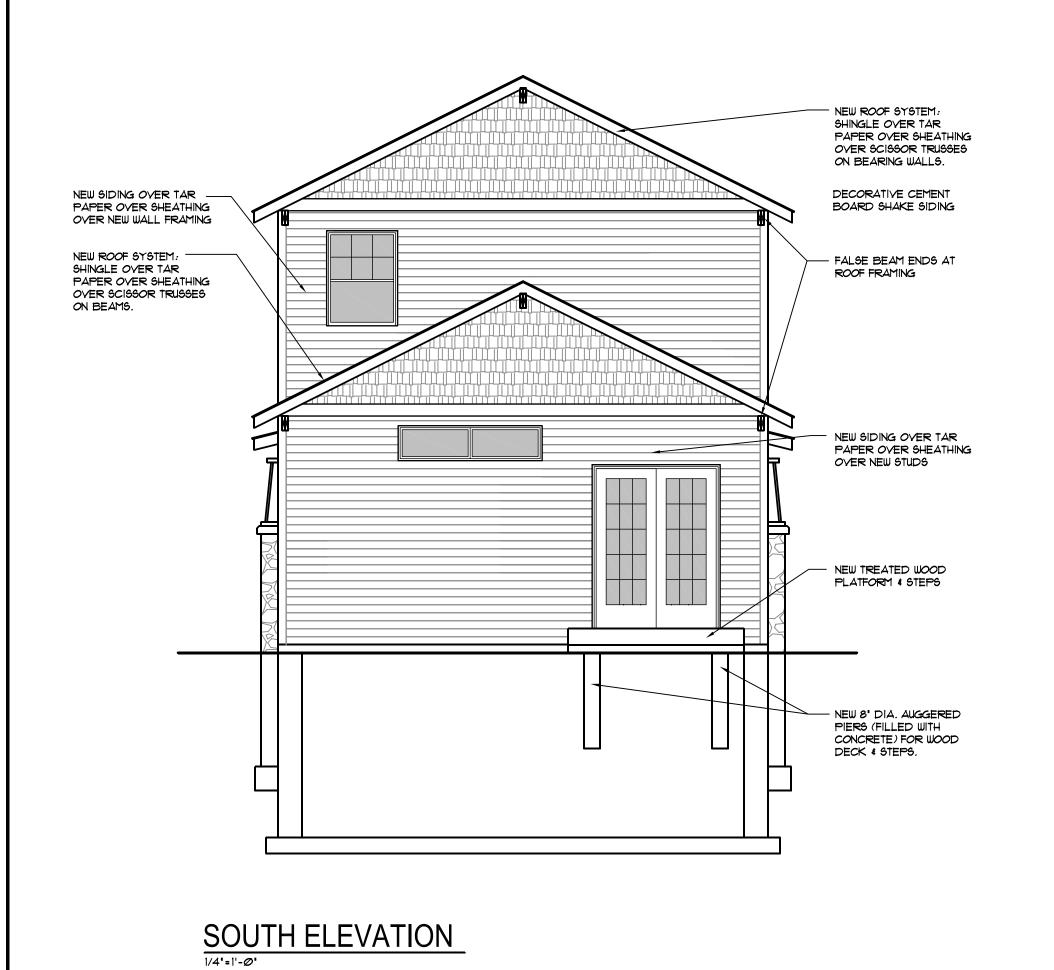

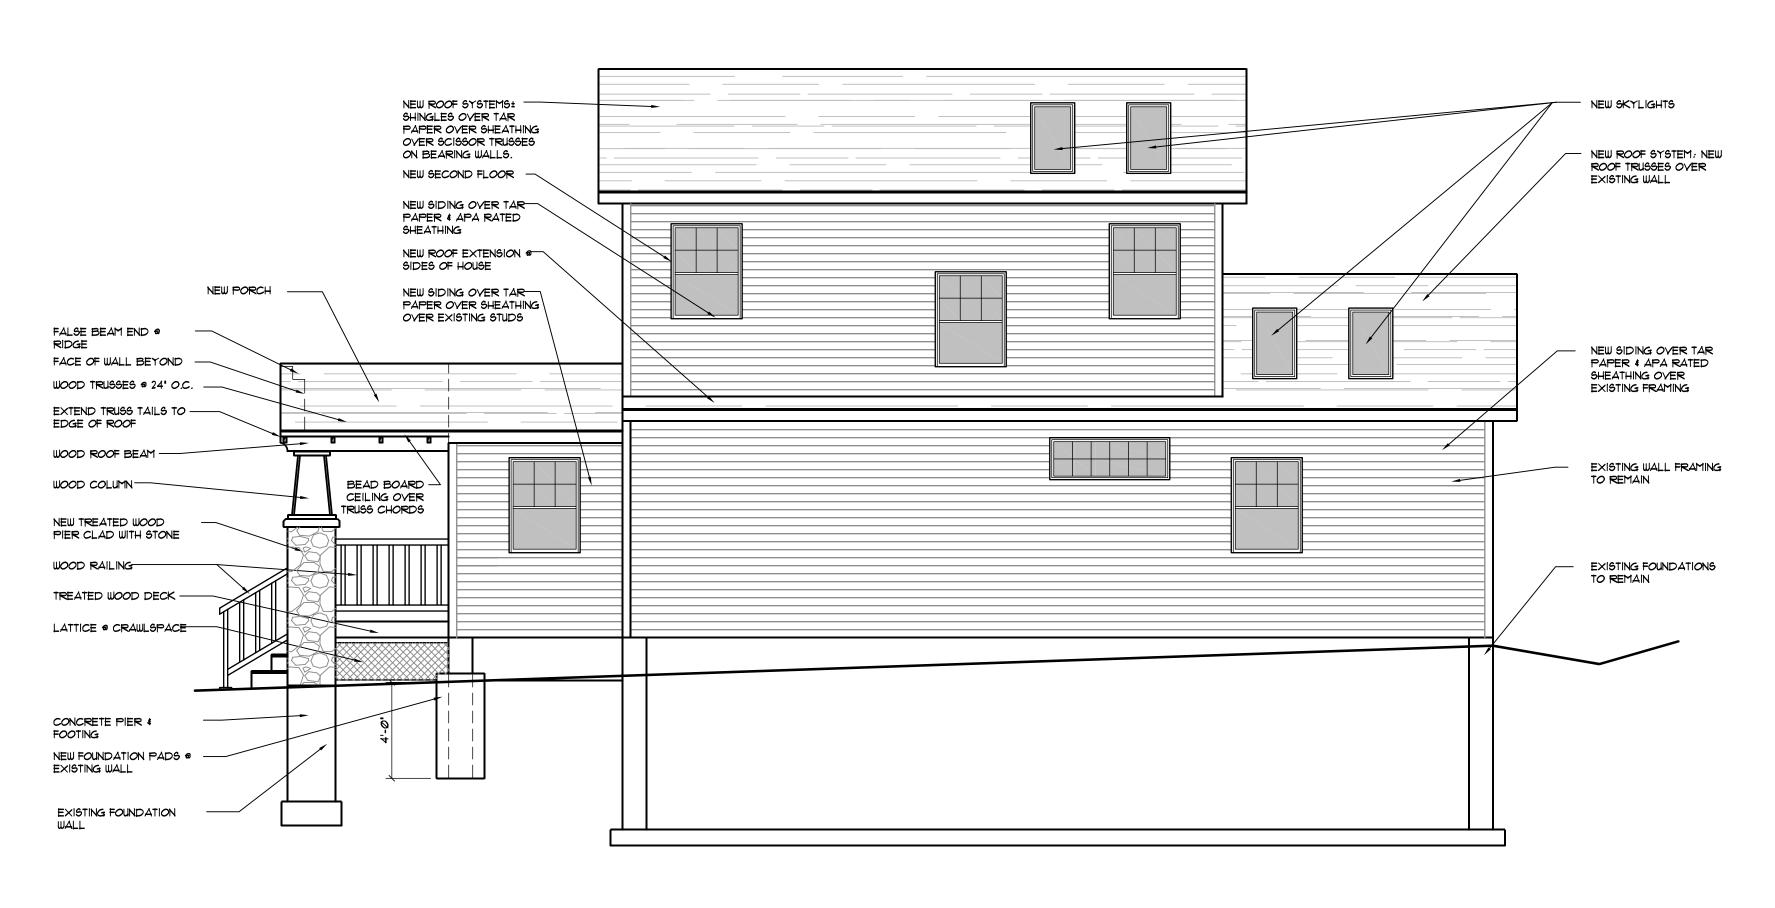

WEST ELEVATION

STRUCTURAL

INC.

7702 Terrace Ave. Suite 1

Middleton, WI 53562

phone 608.833.8830

This work was prepared by me or under my supervision, and construction of this project will be under my supervision. Supervision of construction is defined in Section 1.2(h) of the Rules & Regulations of the Board of Professional Engineers, Architects and Surveyors of the State of Wisconsin.

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331 EAST WILSON STREE

No.: 2006121

Sheet Title

Scale: 1/4"=1'-0"

Drawn By: AMN

Date: 02-05-07

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#### ROOF LIVE LOAD IMPORTANCE FACTOR (I) 1.0 EXPOSURE FACTOR (CE) 1.0 THERMAL FACTOR (CT) 1.0 FLOOR LIVE LOADS RESIDENTIAL MATERIAL STRENGTHS CONCRETE (F'C @ 28 DAYS) FOOTINGS FOUNDATION WALLS 3,500 PSI SLAB ON GRADE REINFORCING STEEL (FY) 60,000 PSI WELDED WIRE FABRIC 65,000 PSI STRUCTURAL STEEL ALL STEEL SHAPES HOLLOW STRUCTURAL STEEL SHAPES 46,000 PSI HIGH STRENGTH BOLTS ASTM A325-N ASTM F1554, GR36 THREADED ANCHOR RODS WELDING ELECTRODES ETØXX WOOD FRAMING S-P-F, STUD GRADE STUDS: JOISTS, BEAMS, HEADERS 5-P-F, \*2 LYL LUMBER E=2,000,000 PSI LSL LUMBER FB=2,25Ø PSI E=1500,000 PSI 2 5/16 FLANGES, HIGH STRENGTH. 1-J015T L/480 DEFLECTION CRITERIA. APA RATED SHEATHING STRUCTURAL II EXTERIOR

### **GENERAL NOTES**

SOIL BEARING PRESSURE 2,000 PSF

(TO BE VERIFIED IN FIELD BY THE CONTRACTOR)

**DESIGN LOADS** 

\* DESIGN AND CONSTRUCTION SHALL BE IN ACCORDANCE WITH PROVISIONS OF THE LATEST EDITION OF THE WISCONSIN UNIFORM DWELLING CODE.

\* ALL CONTRACTORS SHALL VERIFY AND COORDINATE ALL DIMENSIONS AND DETAILS AS

\* ALL CONTRACTORS SHALL VERIFY AND COORDINATE ALL DIMENSIONS AND DETAILS AS SHOWN ON THE DRAWINGS. WHEN DISCREPANCIES OR QUESTIONS ARISE, THE ARCHITECT SHALL BE NOTIFIED.

### FOUNDATIONS AND EARTHWORK

st CENTER COLUMN FOOTINGS ON COLUMN CENTERLINES UNLESS OTHERWISE NOTED.

\* WALL FOOTINGS ARE CENTERED ON FOUNDATION WALL UNLESS OTHERWISE NOTED.

\* WALL FOOTINGS ARE 12 INCHES THICK AND 8 INCHES WIDER THAN THE WALL ABOVE (FOOTINGS PROJECT 4 INCHES BEYOND WALL FACE) UNLESS OTHERWISE NOTED.

\* BOTTOM OF FOOTINGS SHALL BE 4" MINIMUM BELOW EXTERIOR FINISH GRADE.

\* COLUMN AND WALL FOOTINGS SHALL BEAR ON ORIGINAL, UNDISTURBED SOIL OR COMPACTED FILL AS DEFINED IN SOIL REPORT, BUT NOT HIGHER THAN THE MINIMUM DEPTH SHOULD ON DRAWINGS

 $\ast$  SLAB ON GRADE SHALL BE UNDERLAIN BY A VAPOR BARRIER AND SIX INCHES MINIMUM OF COARSE GRANULAR (COMPACTED) FILL MATERIAL.

 $\ast$  MAINTAIN GRAVEL THICKNESS, SLAB DEPTH, REINFORCEMENT, AND REINFORCEMENT POSITION AT DROPPED OR THICKENED SLAB ON GRADE.

\* REINFORCE ALL SLABS ON GRADE WITH WELDED WIRE FABRIC AS DEFINED ON THE PLANS, POSITIONED OR SUPPORTED TO BE IN THE TOP THIRD OF THE SLAB UNLESS NOTED

\* BACKFILL AROUND THE EXTERIOR FOUNDATION WALLS WITH (A FREE DRAINING GRANULAR MATERIAL TO THE ELEVATION OF THE ROUGH GRADE).

\* CONTRACTOR TO KEEP EXCAVATIONS DRY AND PROTECTED FROM FROST AT ALL TIMES

DURING THE FOUNDATION CONSTRUCTION.

 $\ast$  NOTIFY ARCHITECT IF NATURE OF SOIL AT DEPTHS SHOWN IS NOT SUITABLE FOR FOUNDATIONS.

### CONCRETE (CAST-IN-PLACE, NON-PRESTRESSED)

CONCRETE REINFORCING SHALL HAVE THE FOLLOWING MINIMUM PROTECTIVE COVER. CONCRETE POURED TO EARTH OR GROUND 3' CONCRETE EXPOSED TO EARTH OR WEATHER \*5 BAR AND SMALLER  $1\frac{1}{2}$ ' CONCRETE WITH INTERIOR EXPOSURE \*11 BAR AND SMALLER  $\frac{3}{4}$ '

CONCRETE PIERS
PRIMARY REINFORCEMENT, TIES, AND SPIRALS 11/2"

2. ELEVATION TOP OF ANCHOR BOLTS PLUS I' OR MINUS  $\frac{3}{6}$ , 3. OUT OF POSITION OF ANCHOR BOLTS PLUS OR MINUS  $\frac{1}{6}$ .

\* CLEAR SPACING BETWEEN REBARS (UNLESS SHOWN TO BE CONTACT LAP SPLICED) SHALL BE A MINIMUM OF  $1\frac{1}{2}$  BAR DIAMETER,  $1\frac{1}{2}$ , OR  $\frac{1}{3}$  TIMES THE DIAMETER OF THE AGGREGATE, WHICHEVER IS GREATER.

\* CONTROL AND CONSTRUCTION JOINTS FOR SLAB ON GRADE MUST BE REVIEWED BY THE ENGINEER PRIOR TO THE PLACING OF CONCRETE.

\* CONCRETE PIERS SHALL BE POURED MONOLITHICALLY WITH CONCRETE WALLS.

\* ALLOW AT LEAST 24 HOURS BETWEEN POURING ADJACENT WALL SECTIONS BETWEEN CONSTRUCTION JOINTS.

\* HORIZONTAL WALL REINFORCEMENT SHALL BE MADE CONTINUOUS AT ALL CORNERS OR CORNER BARS PROVIDED.

\* ANCHOR BOLTS SHALL BE SET AND CONCRETE BEARING SURFACE FOR COLUMNS SHALL BE FINISHED TO THE FOLLOWING TOLERANCE:

1. ELEVATION OF CONCRETE SURFACE PLUS OR MINUS 3/8",

STRUCTURAL STEEL

\* USE CONNECTIONS AS DETAILED ON PLANS OR THE STANDARD GUIDE DETAILS PROVIDED WITH THE CONTRACT DOCUMENTS. WHENEVER CONNECTIONS ARE NOT COVERED, THE FABRICATOR SHALL REQUEST THE ENGINEER TO SUPPLY A CONNECTION

 $\ast$  PROVIDE CONNECTIONS REQUIRED FOR ATTACHMENT OF WOOD TO STEEL MEMBERS. ALSO, PROVIDE HOLES FOR LAGS.

\* COLUMN CAP PLATES ARE 1/2" THICK UNLESS NOTED. SLOPE TO MATCH BEAM SLOPE.

\* PRIOR TO GROUTING, COLUMNS SHALL BE ERECTED AND ALIGNED AS TO PLUMBNESS AND ELEVATION BY MEANS OF STEEL SHIMS OR LEVELING NUTS UNDER THE BASE PLATES. SETTING PLATES SHALL ONLY BE USED AS TEMPLATES TO LOCATE ANCHOR BOLTS

# DURING CONCRETE PLACEMENT. WOOD FRAMING

\* SILLS AND MEMBERS EXPOSED DIRECTLY TO MOISTURE OR IN DIRECT CONTACT WITH CONCRETE OR MASONRY SHALL BE PRESSURE TREATED.

\* SHEATHING SHALL CONFORM TO THE LATEST EDITION OF U.S. PRODUCT STANDARD PS-1.

INSTALL IN STAGGERED PATTERN.

\* FRAMING CONNECTIONS SHALL BE SIMPSON COMPANY OR EQUAL, OF THE CATALOG DESIGNATIONS INDICATED. INSTALL MANUFACTURES STANDARD NAILS IN ALL HOLES PROVIDED UNLESS OTHERWISE NOTED.

\* NAILS SHALL BE STRONGHOLD, GALVANIZED COMMON NAILS OF THE SIZES INDICATED, EXCEPT THAT GALVANIZED SIDING NAILS SHALL BE USED FOR THE ATTACHMENT OF EXTERIOR PLYWOOD SIDING.

\* WHERE NOT NOTED SPECIFICALLY OTHERWISE, NAILING SHALL BE ACCORDING TO FASTENING SCHEDULE FOUND IN THE WISCONSIN ENROLLED BUILDING CODE, TABLE 2304.9.1.

\* ALL BOLTS AND LAG SCREWS SHALL BE AMERICAN STANDARD MANUFACTURE.

\* PROVIDE WASHERS UNDER ALL NUTS AND HEADS OF BOLTS AND LAG SCREWS.


WASHERS SHALL BE EITHER ROUND MALLEABLE IRON OR SQUARE CUT STEEL WASHERS 1/4"

THICK AND THREE FASTENER DIAMETERS WIDE.

\* PROVIDE SOLID BLOCKING AT MID-HEIGHT OF ALL WALLS.


\* DESIGN, FABRICATION, AND CONSTRUCTION SHALL CONFORM TO THE "NATIONAL DESIGN SPECIFICATION FOR WOOD CONSTRUCTION", AND ITS SUPPLEMENT, CURRENT EDITION AS RECOMMENDED BY THE NATIONAL LUMBER MANUFACTURER'S ASSOCIATION.

\* ROOF SHEATHING SHALL BE NAILED WITH 8D NAILS AT 6' ON CENTER AROUND THE EDGE SUPPORTS, AND 12' ON CENTER FOR INTERIOR SUPPORTS.

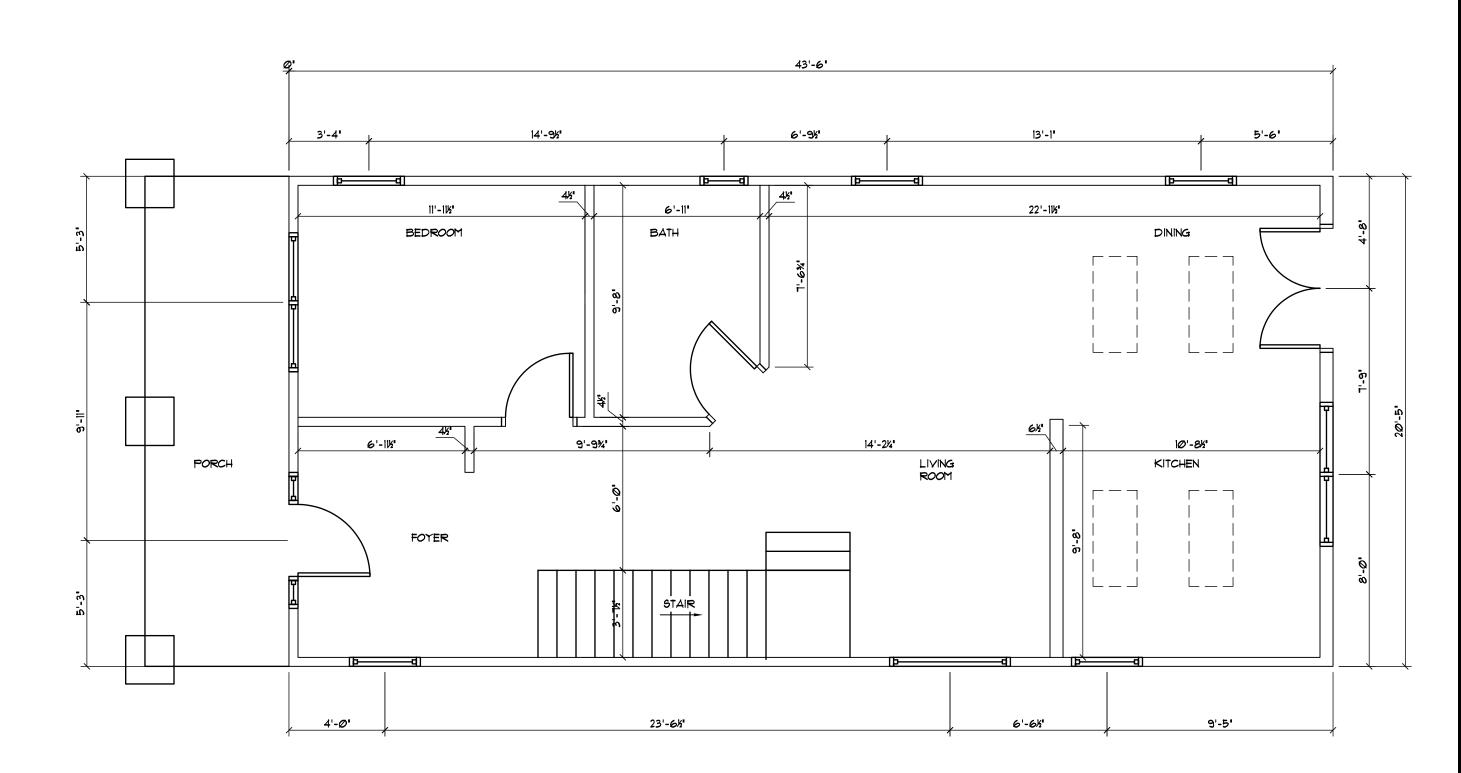

## FIRST FLOOR PLAN

FIELD VERIFY ALL DIMENSIONS

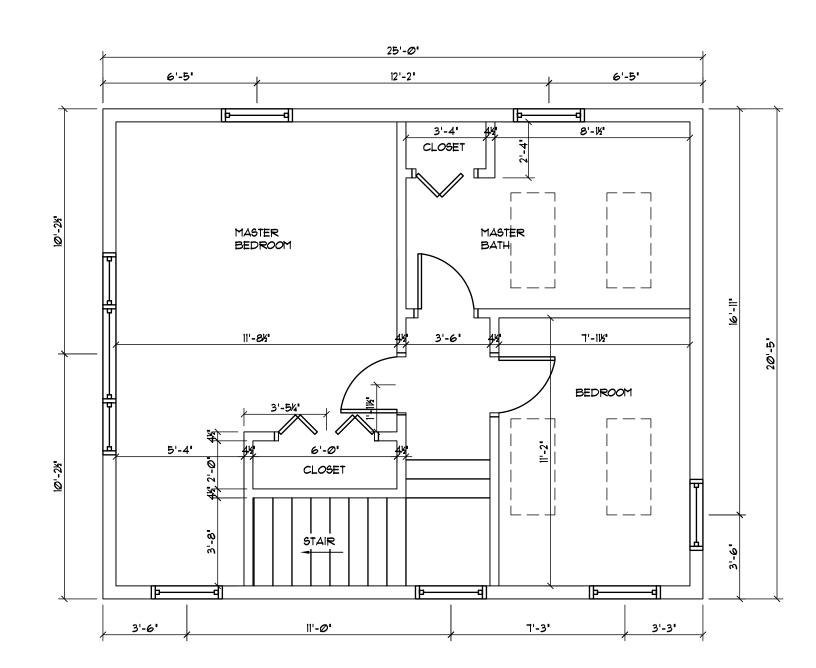

# SECOND FLOOR PLAN

FIELD VERIFY ALL DIMENSIONS



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