

ADVANCE AUTO PARTS

1902 NORTHPORT DRIVE CITY OF MADISON DANE COUNTY, WISCONSIN

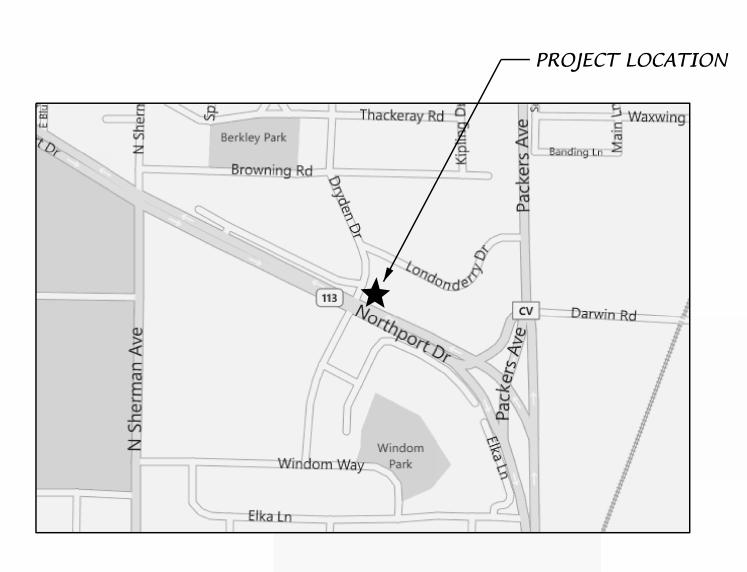

PROJECT LOCATION

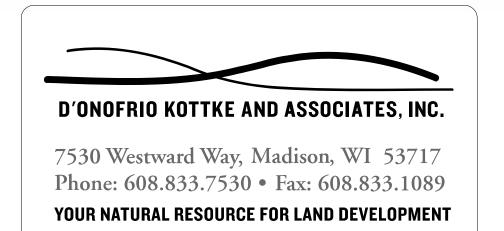

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- 1 COVER SHEE
- 2 EXISTING SITE CONDITONS
- 3 SITE PLAI
- 4 SITE GRADING AND EROSION CONTROL PLAN
- SITE UTILITY PLAN
- 6 LANDSCAPE PLAN
- 7 BUILDING ELEVATION PLAN
- 8 BUILDING FLOOR PLAN
- 9 DETAILS

ISSUE DATE: 02-22-12 SHEET 1 OF 9

E AUTO PARTS
ORTHPORT DRIVE

1902 NORTH CITY OF MADISON, DAN


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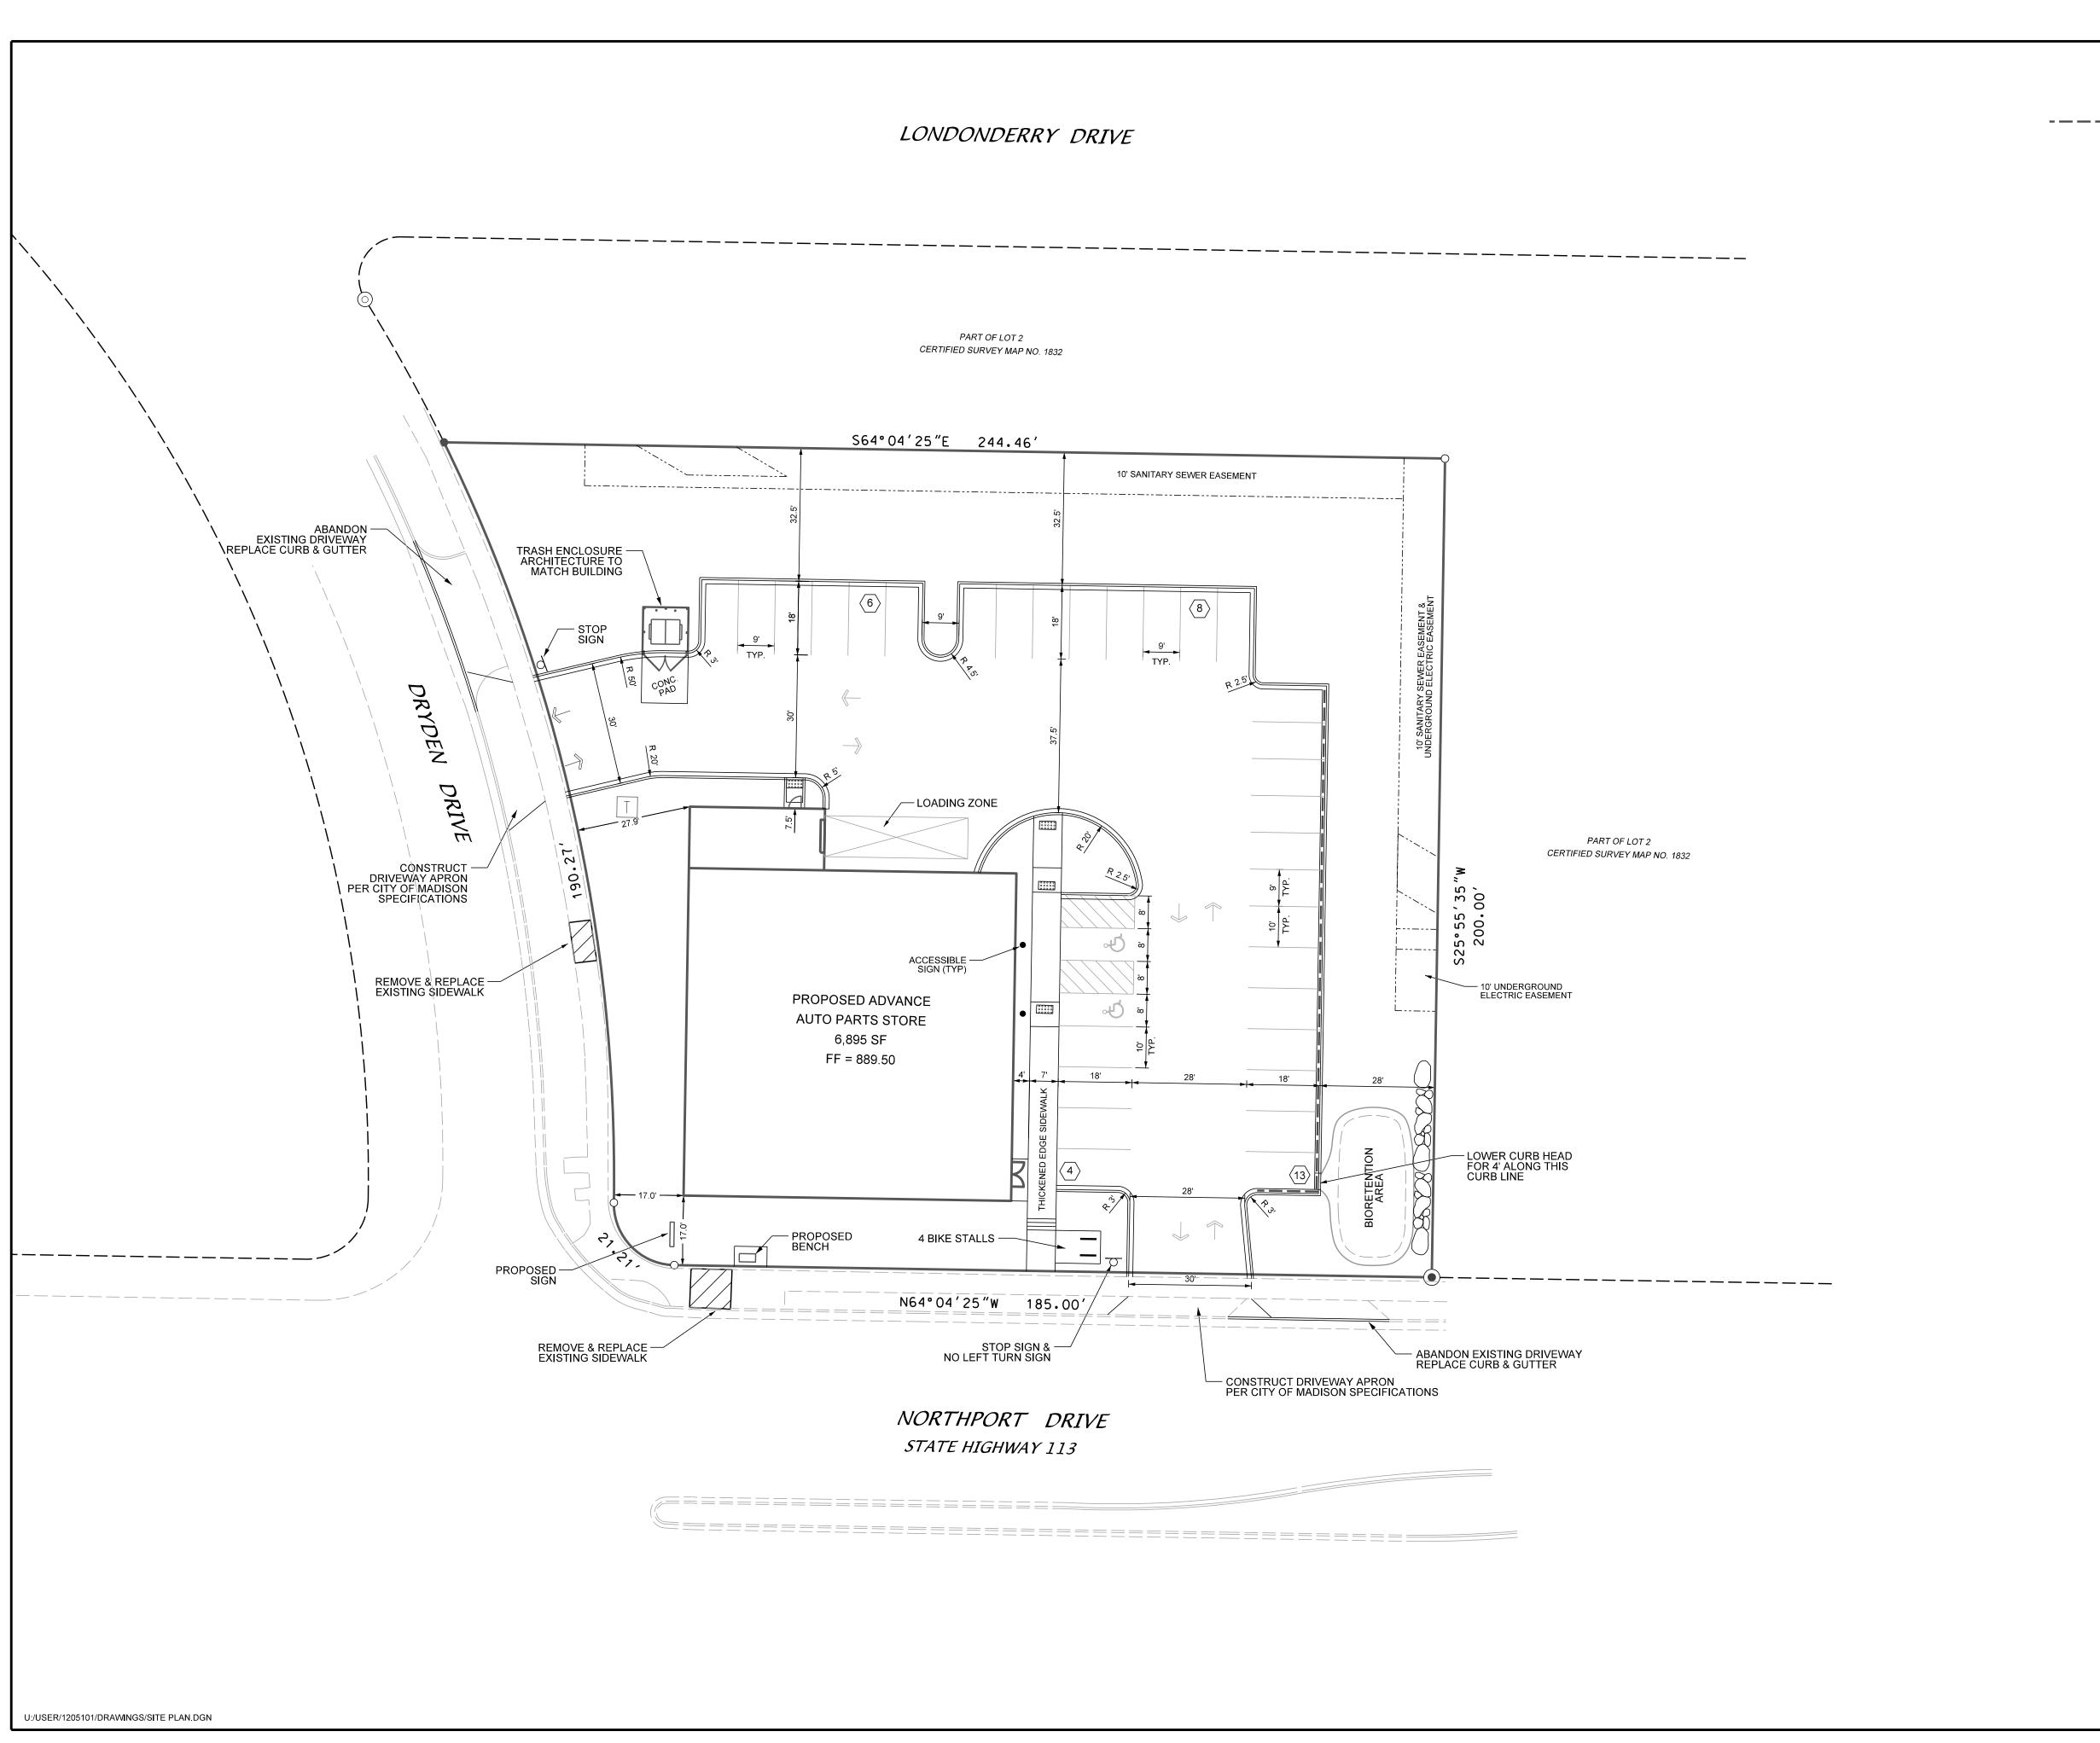
REVISED:

FN: 12-05-101

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LEGEND

- — — TYPE G CURB AND GUTTER
-ALL OTHER CURB AND GUTTER TO BE TYPE D

SITE SUMMARY

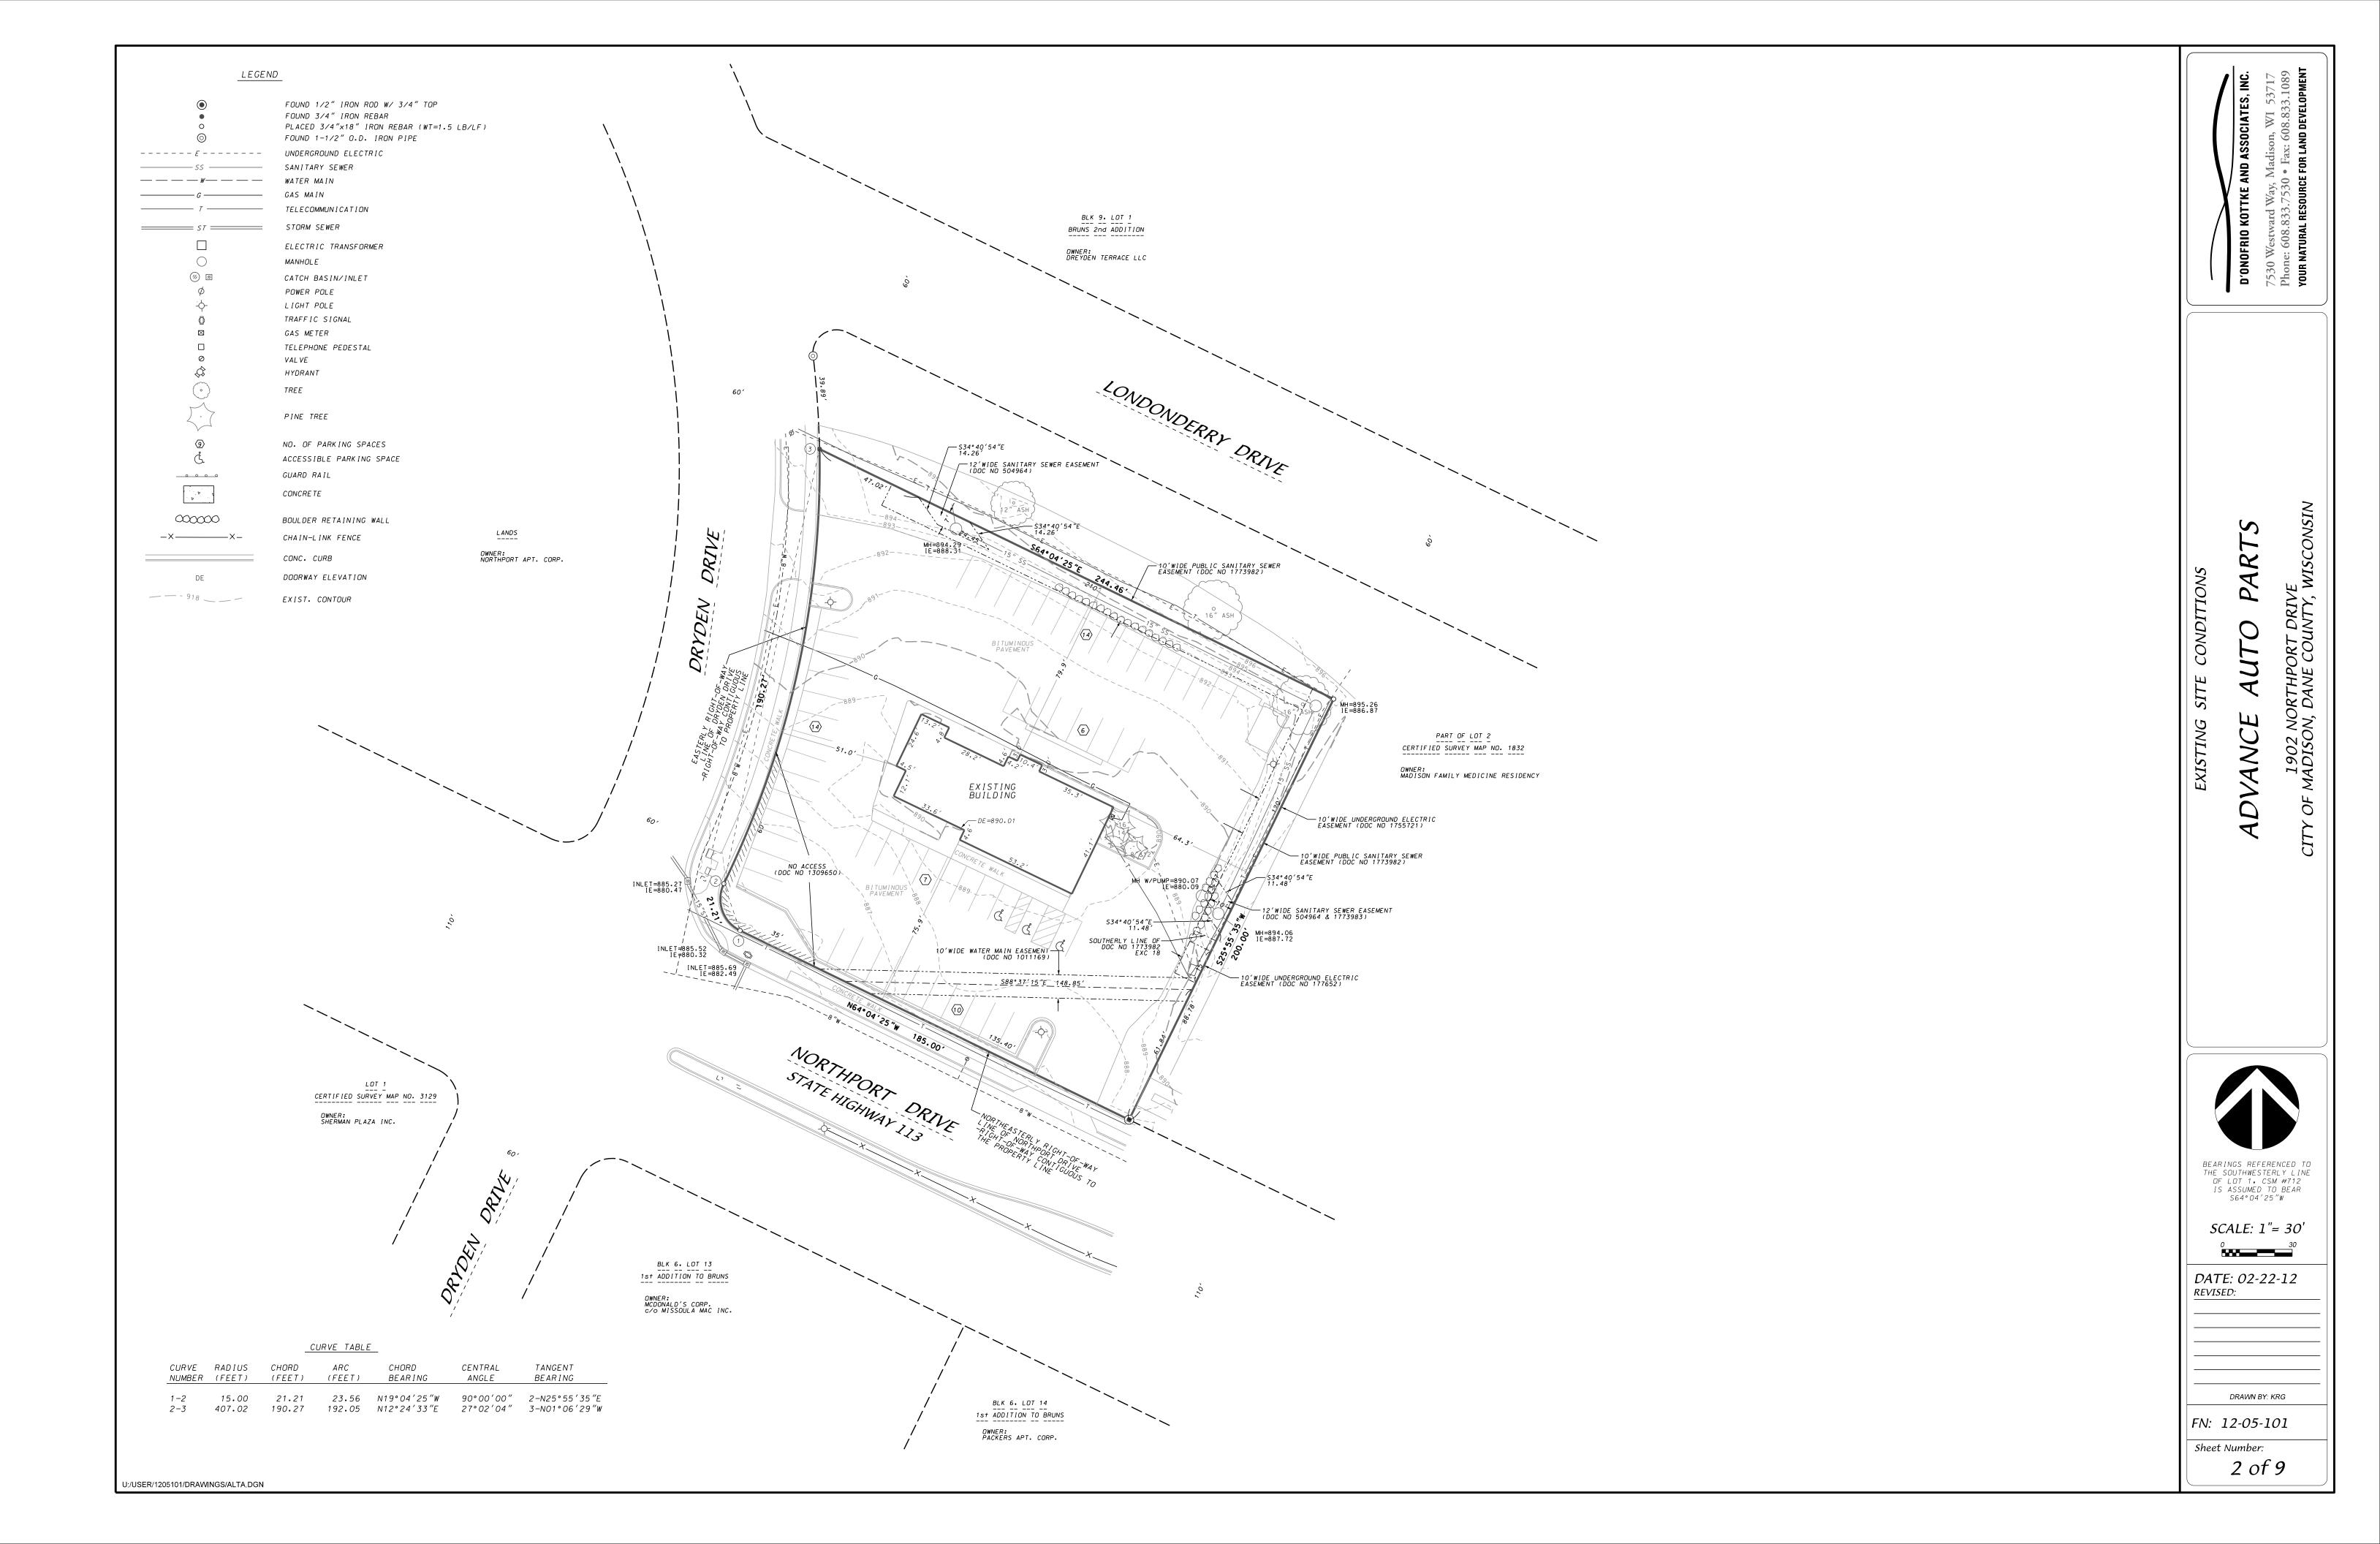LOT AREA = 42,630 SF (0.98 AC)

FLOOR AREA = 6,895 SF (1 STORY)

FLOOR AREA RATIO = 0.16

IMPERVIOUS AREA = 24,245 SF IMPERVIOUS AREA RATIO = 0.57

PARKING STALLS = 31 REGULAR, 2 ACCESSIBLE

SCALE: 1"= 20'
(PAGE SIZE: 22x34)

DATE: 02-22-12 REVISED:

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DRAWN BY: DND

Sheet Number:

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U:/USER/1205101/DRAWINGS/SITE GRADING AND EC PLAN.DGN

PROPOSED FINISHED PAVEMENT GRADE PROPOSED INDEX CONTOUR PROPOSED INTERMEDIATE CONTOUR EXISTING INDEX CONTOUR

INLET FILTER REQUIRED LIMITS OF DISTURBANCE

EXISTING INTERMEDIATE CONTOUR

SCALE: 1"= 20' (PAGE SIZE: 22x34)

DATE: 02-22-12

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FN: 12-05-101

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1. EROSION CONTROL PRACTICES SHALL BE PLACED AT THE COMMENCEMENT OF CONSTRUCTION. ALL PRACTICES SHALL BE INSPECTED AFTER A RAINFALL EVENT OF 0.5" OR GREATER AND/OR WEEKLY AND REPAIRED AS NECESSARY.

2. THE CONTRACTOR SHALL INSPECT STREETS ADJACENT TO THE SITE A MINIMUM OF ONCE DAILY AND CLEAN AS NECESSARY. CLEANING SHALL BE BY SWEEPING AND NOT HYDRAULIC FLUSHING. MUD AND DEBRIS TRACKED ONTO CITY STREETS SHALL BE IMMEDIATELY CLEANED UP.

3. INLET FILTERS FOR EXISTING INLETS SHALL BE INSTALLED AT THE COMMENCEMENT OF CONSTRUCTION. INLET FILTERS FOR NEW INLETS TO BE INSTALLED BY THE UTILITY CONTRACTOR AS SOON AS THE STRUCTURE IS SET. INLET FILTERS SHALL BE MAINTAINED BY THE CONTRACTOR UNTIL A SATISFACTORY STAND OF GRASS HAS BEEN ACHIEVED AROUND THE BUILDINGS, THEN REMOVED.


4. ALL SLOPES 4:1 OR GREATER SHALL BE PROTECTED WITH EROSION MATTING AS SOON AS FINAL GRADE IS ESTABLISHED.

5. EROSION MAT SHALL BE WDOT CLASS I, TYPE A, UNLESS OTHERWISE SPECIFIED.

6. ALL DISTURBED AREAS SHALL BE RESTORED WITH TOPSOIL, FERTILIZER, SEED, AND MULCH. SEED SHALL BE WOOT MIXTURE 40 APPLIED AT 2 POUNDS PER 1,000 SQUARE FEET. FERTILIZER SHALL BE WDOT TYPE A APPLIED AT 6 POUNDS PER 1000 SQUARE FEET. MULCH SHALL BE HAY OR STRAW APPLIED AT 1.5 TO 3 TONS PER ACRE AND CRIMPED. CHANGES TO ABOVE TYPES SHALL BE APPROVED BY ENGINEER. EROSION CONTROL IS THE RESPONSIBILITY OF THE CONTRACTOR.

7. UNTIL ACCEPTANCE OF THIS PROJECT. EROSION CONTROL MEASURES AS SHOWN ON THE APPROVED PLAN SHALL BE THE MINIMUM ALLOWED. THE CONTRACTOR SHALL BE RESPONSIBLE FOR RECOGNIZING AND CORRECTING EROSION CONTROL PROBLEMS THAT ARE A RESULT OF CONSTRUCTION ACTIVITIES. ADDITIONAL EROSION CONTROL MEASURES, AS REQUESTED IN WRITING BY THE CITY ENGINEER OR THE DEVELOPER'S ENGINEER, SHALL BE INSTALLED WITHIN 24 HOURS.

8. CHANGES TO THE APPROVED EROSION CONTROL PLAN SUBMITTED SHALL BE APPROVED BY THE CITY PRIOR TO IMPLEMENTATION.

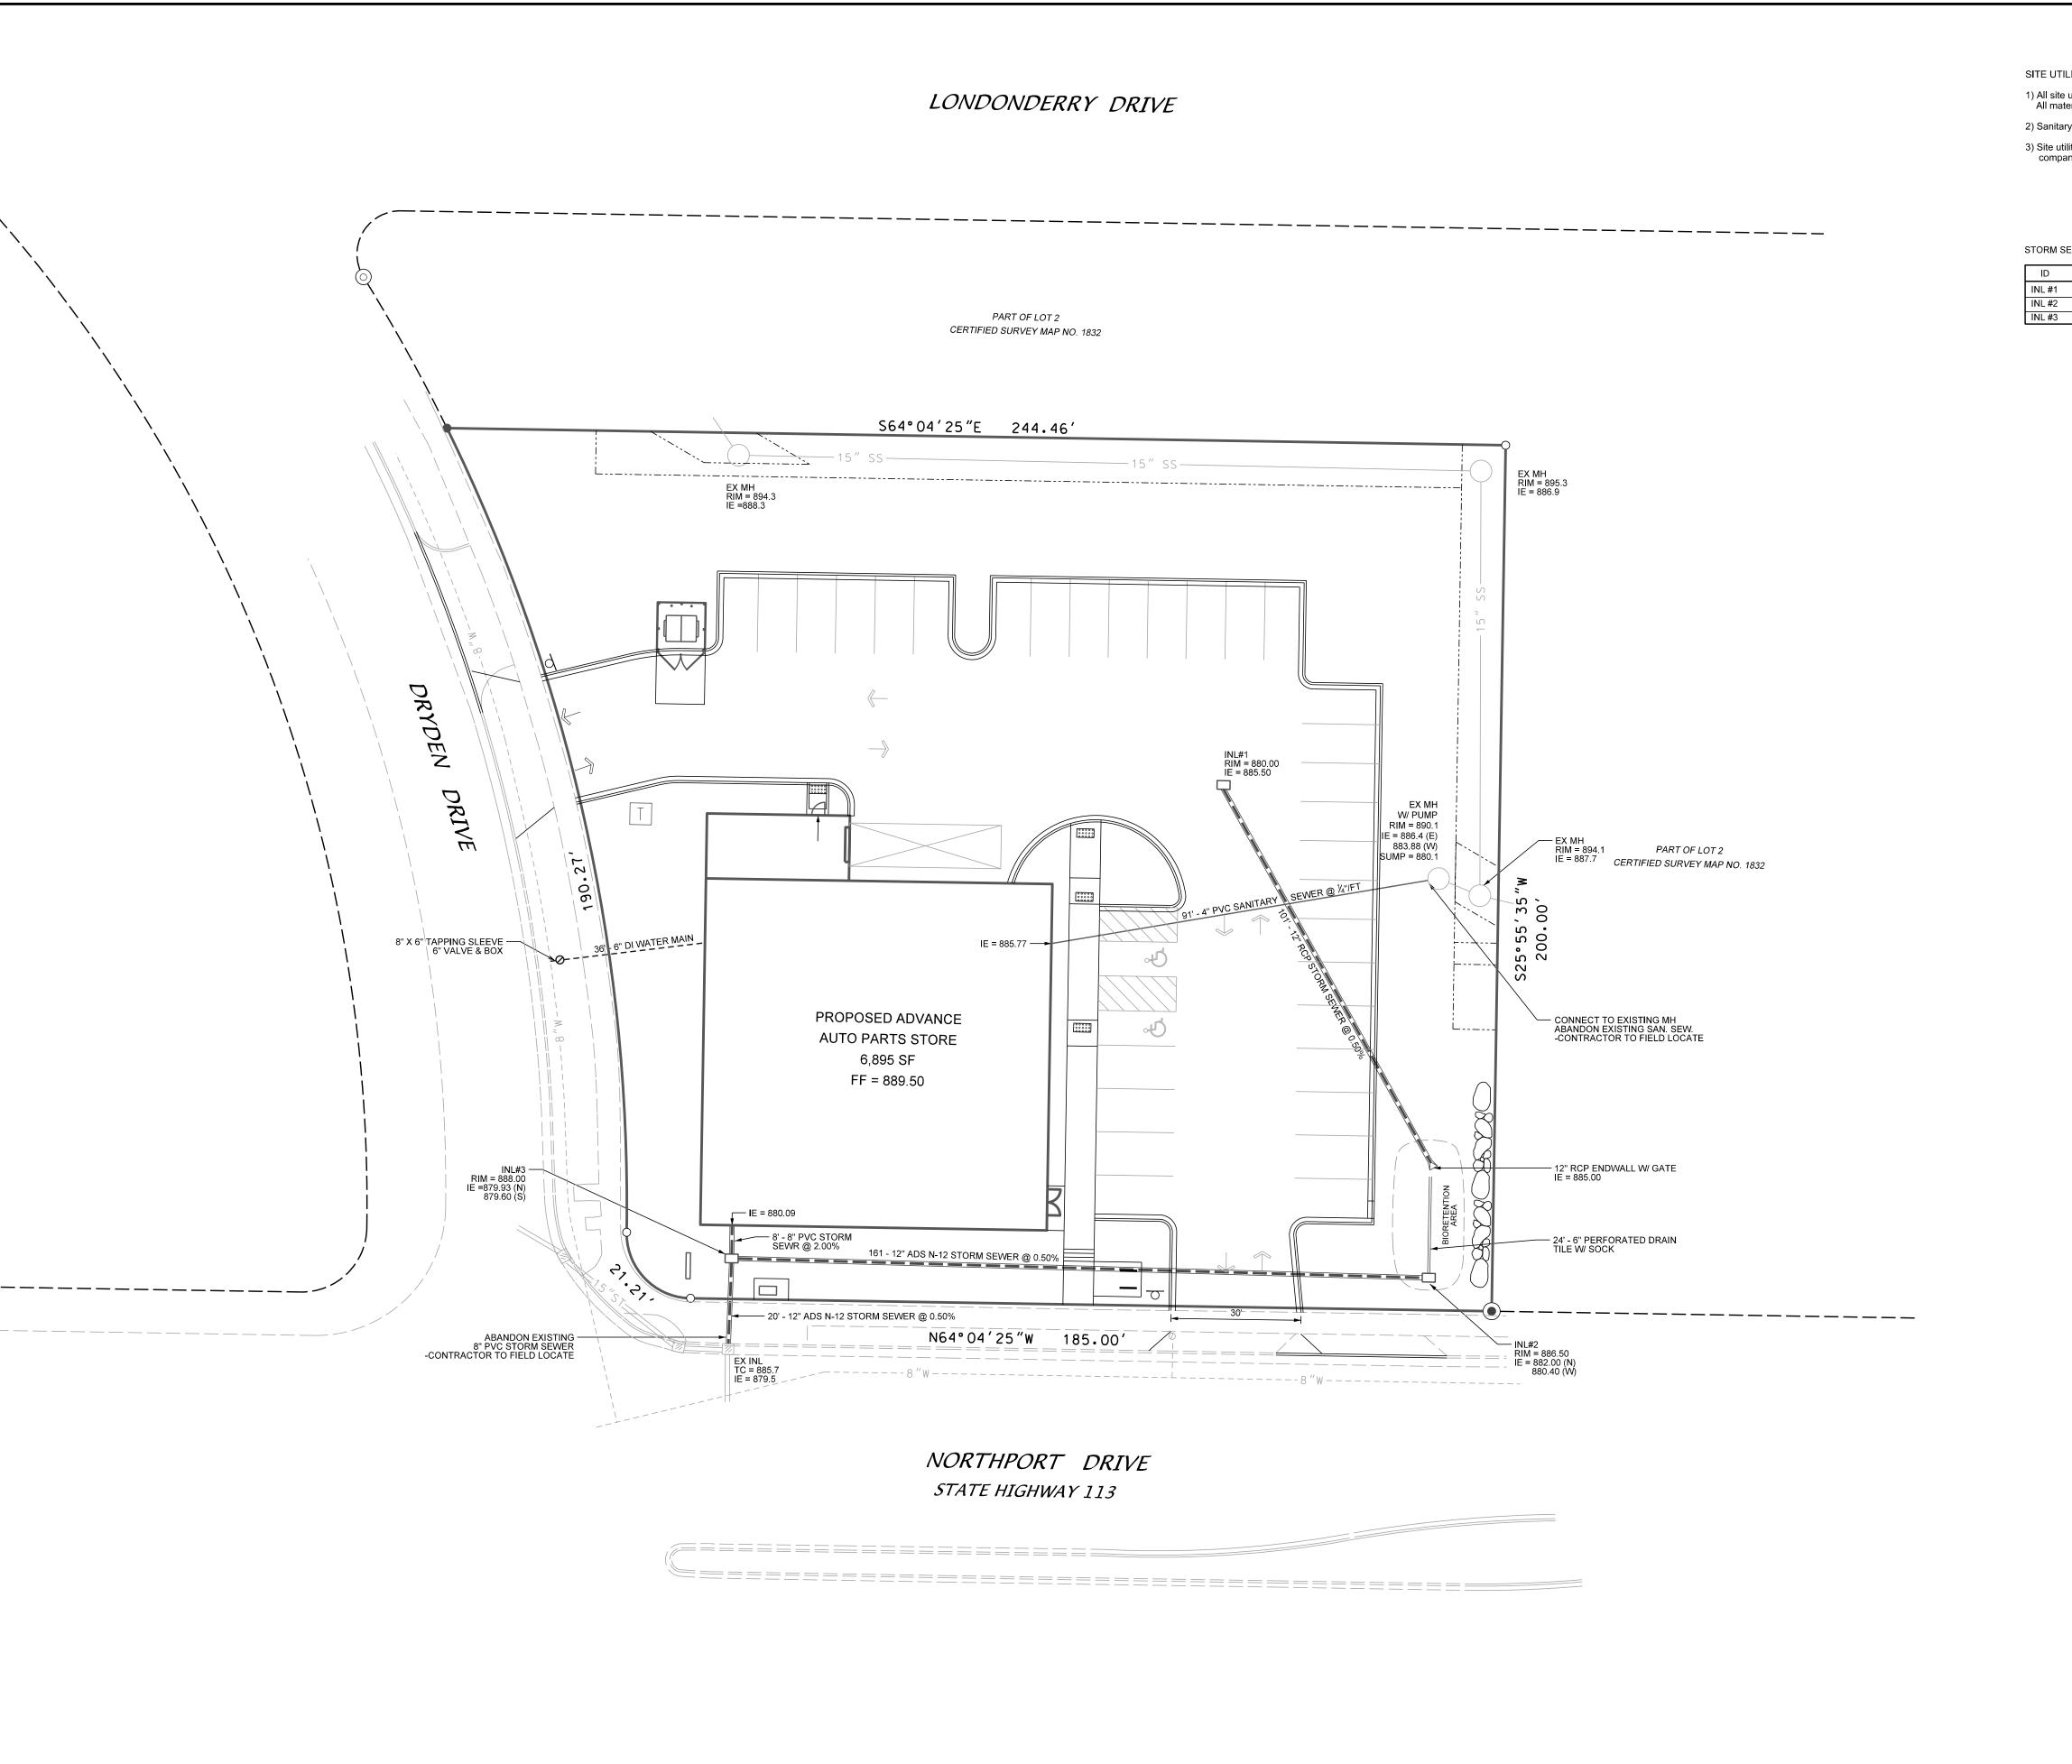

U:/USER/1205101/DRAWINGS/SITE PLAN.DGN

SITE UTILITY NOTES

1) All site utility work shall comply with the City of Madison Code of Ordinances. All materials shall be in compliance with the City's Material Standards.

2) Sanitary sewer shall be SDR 35 PVC.

Site utility contractor shall coordinate work efforts involving any other utilities with their respective companies: MG&E, Charter, TDS, etc.

STORM SEWER STRUCTURE TABLE

ID	STRUCTURE TYPE	NEENAH CASTING
INL #1	2' X 3' PRECAST BOX	R-1878-B7G
INL #2	2' X 3' PRECAST BOX	R-1878-B7G
INL #3	2' X 3' PRECAST BOX	R-1878-B7L

DATE: 02-22-12


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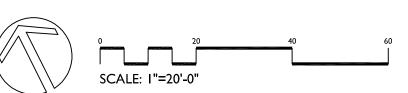
Sheet Number: 5 of 9

LONDONDERRY DRIVE



NORTHPORT DRIVE STATE HIGHWAY II3



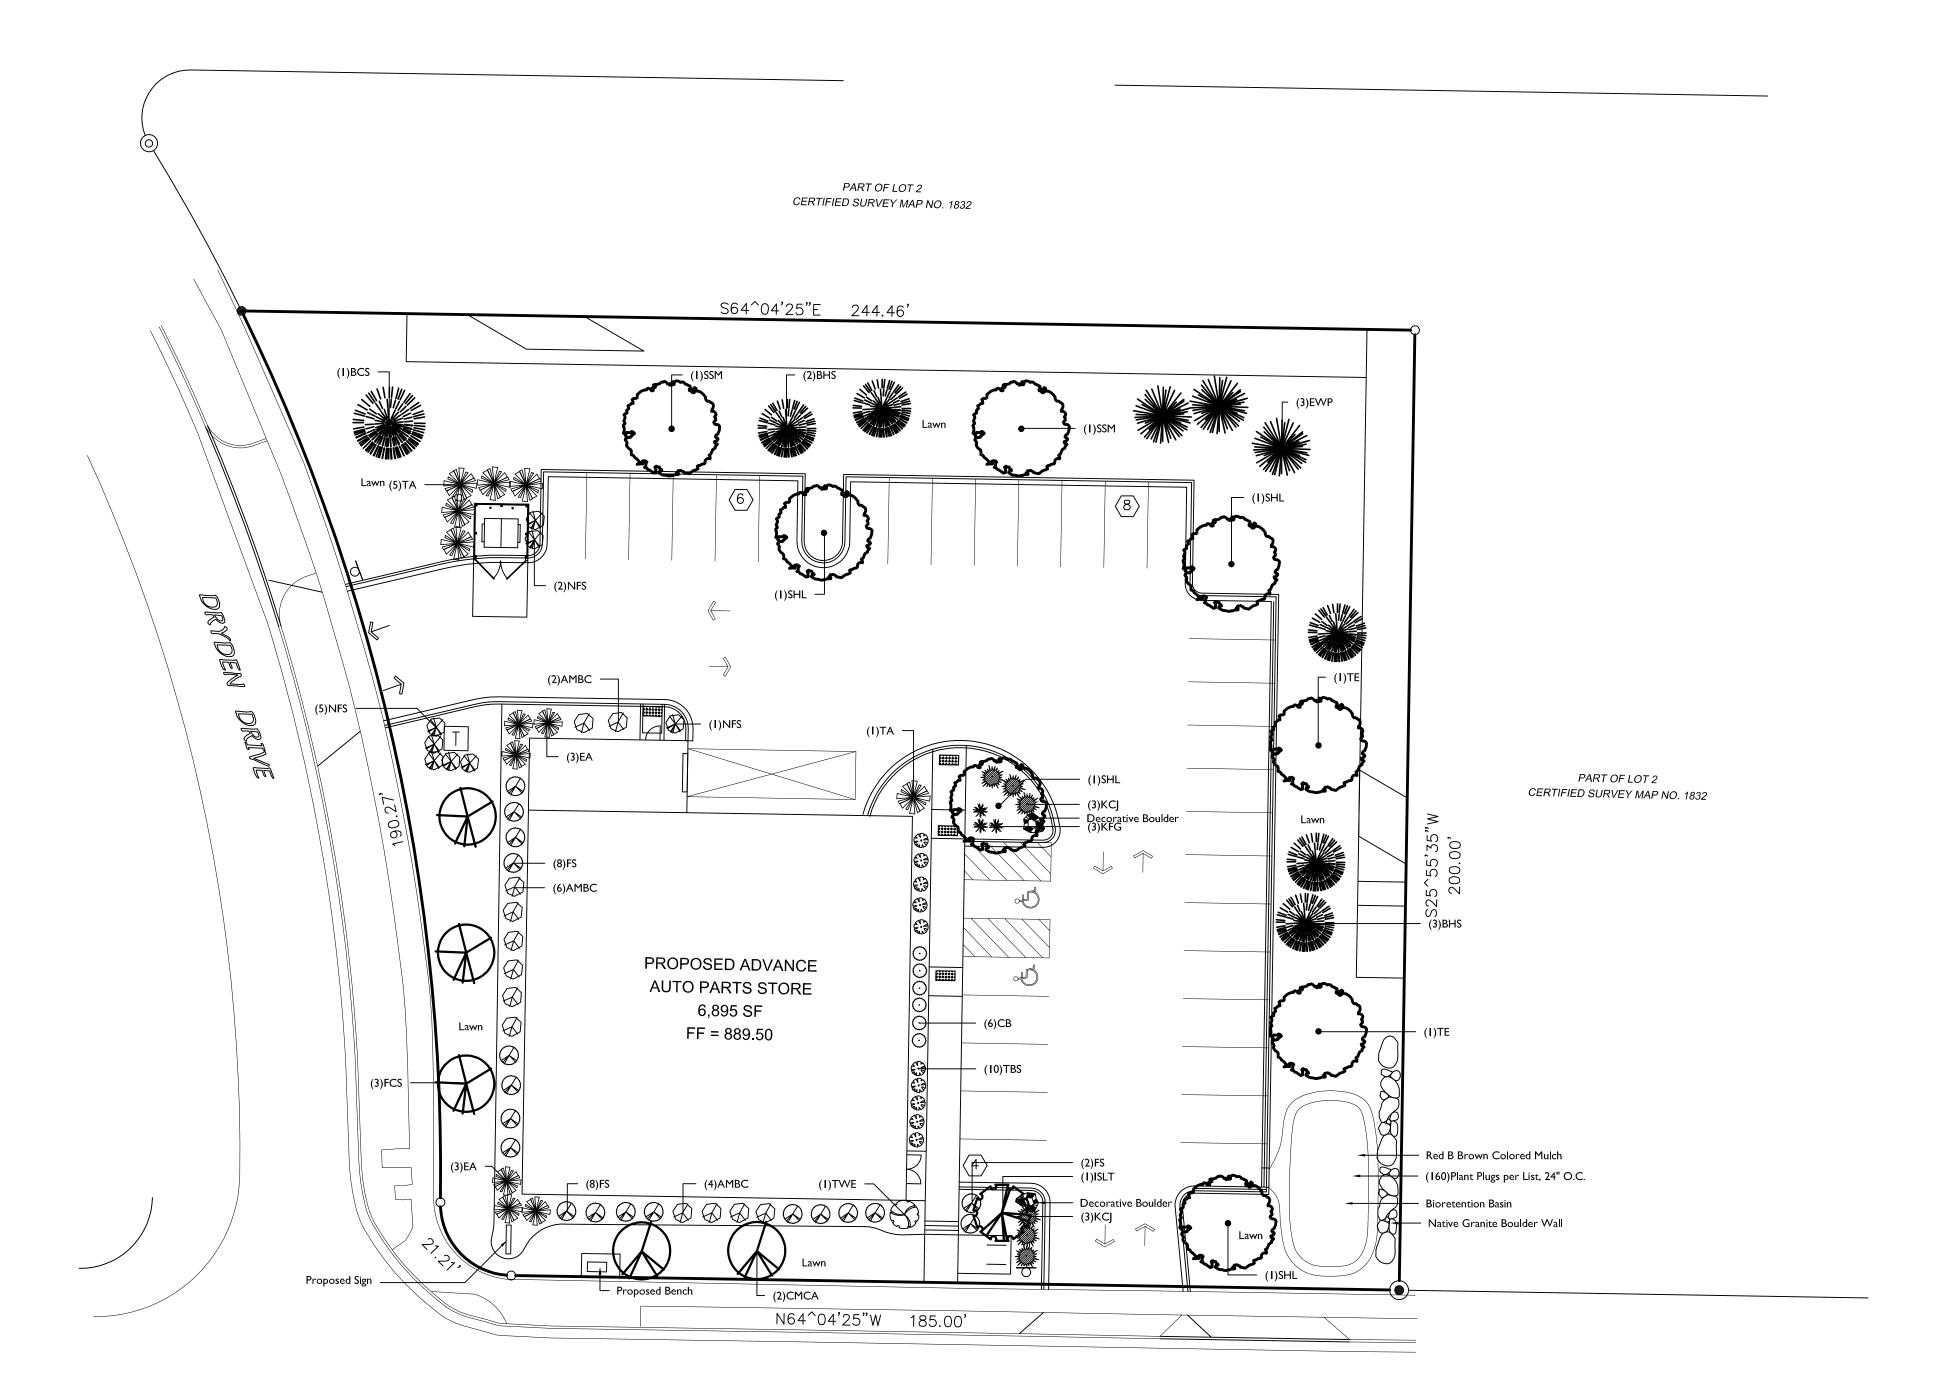



GENERAL NOTES

A) Individual trees (and shrub groupings) found along perimeter of property as well as those found within lawn areas to receive wood mulch rings (and wood mulch beds) consisting of a mixture of recycled wood mulch, colored brown, spread to a minimum 3" depth (3' wide beds for shrub groupings).

B) Plant beds adjacent to building to be mulched with 1-1/2" diameter washed stone mulch spread to a 3" depth over fabric weed barrier and to be edged with Valley View Black Diamond Vinyl Edging or equivalent.

C) Lawn areas shall be finish-graded and seeded at a rate of 4 lbs. per 1,000 sq. ft.


H) Seed shall consist of the following mixture: 40% Palmer Ryegrass 20% Baron Bluegrass 20% Nassau Bluegrass 20% Pennlawn Creeping Red Fescue

CITY OF MADISON			
LANDSCAPE POINTS REQUIREMENTS			
NUMBER OF	NUMBER OF PARKING STALLS NUMBER OF 2" MIN. CAL. TREES REQUIRED		
NUMBER OF 2			
NUMBER OF	LANDSCAPE POINTS REQUIRED	<u> 159.7</u>	
NUMBER OF I	LOADING DOCKS		
NUMBER OF I	75		
TOTAL NUMI	234.7		
SOLUTION			
5	CANOPY TREES (2"-2 1/2") @ 35 PTS.	<u> 175</u>	
9	EVERGREEN TREES (3' HT.) @ 15 PTS.	135	

Plant Material List

Broadleaf E	Deciduous		
Quantity	Code Name	Common Name	Planting Size
2	CMCA	Candymint Crabapple	I 3/4" B&B
3	FCS	Firebird Crabapple (std)	I 3/4" B&B
4	SHL	Skyline Thnls Honeylocust	2" B&B
2	SSM	State Street Miyabe Maple	2" B&B
2	TE	Triumph Elm	2" B&B
Conifer Eve	ergreen		
Quantity	Code Name	Common Name	Planting Size
5	BHS	Black Hills Spruce	4' B&B
I	BCS	Blue Colorado Spruce	4' B&B
3	EWP	Eastern White Pine	4' B&B
6	EA	Emerald Arborvitae	4' B&B
6	KCJ	Kallay Compact Juniper	#5 CONT.
6	TA	Techny/mission Arborvitae	4' B&B
Perennial			
Quantity	Code Name	Common Name	Planting Size
3	KFG	Karl Foerster's Feather Reed Grass	#I CONT.
Shrub			
Quantity	Code Name	Common Name	Planting Size
12	AMBC	Autumn Magic Black Chokeberry	#5 CONT.
6	СВ	Cabernet Barberry	#2 CONT.
18	FS	Froebel Spirea	#2 CONT.
I	ISLT	Ivory Silk Japanese Tree Lilac (tf)	2" B&B
8	NFS	Neon Flash Spirea	#2 CONT.
10	TBS	Tor Birchleaf Spirea	#2 CONT.
I	TWE	Tures Winged Euonymus	#3 CONT.

iorention Plant Plug List					
2	Marsh Milkweed	Asclepias incarnata			
2	New England Aster	Aster novae-angliae			
2	Joe Pye Weed	Eupatorium maculatum			
2	Ox Eye Sunflower	Heliopsis helianthoides			
)	Riddell's Goldenrod	Solidago riddellii			

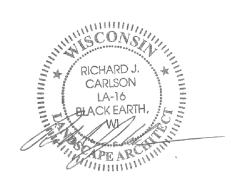

ADVANCE AUTO F 1902 NORTHPORT DRIVE MADISON, WISCONSIN


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Checked By: RC Drawn By: MN 2/20/12 Revised: 2/21/12


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> Sheet 6 of 9

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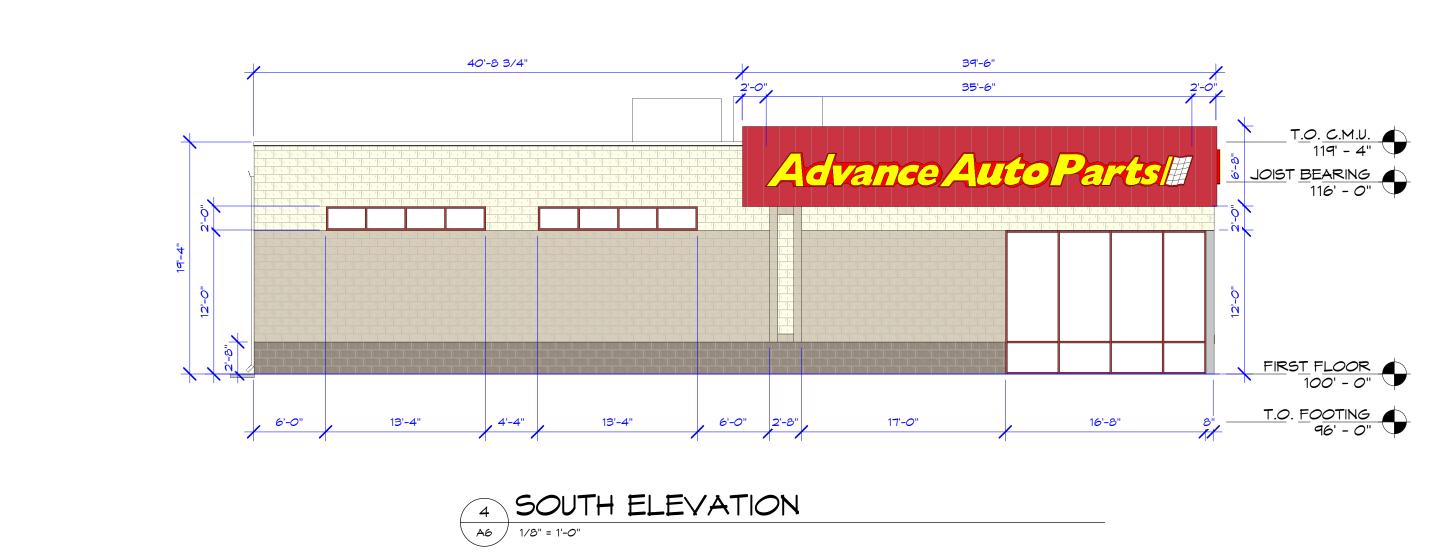
PRELIMINARY PERSPECTIVE NORTHEAST





6 PRELIMINARY PERSPECTIVE SOUTHWEST

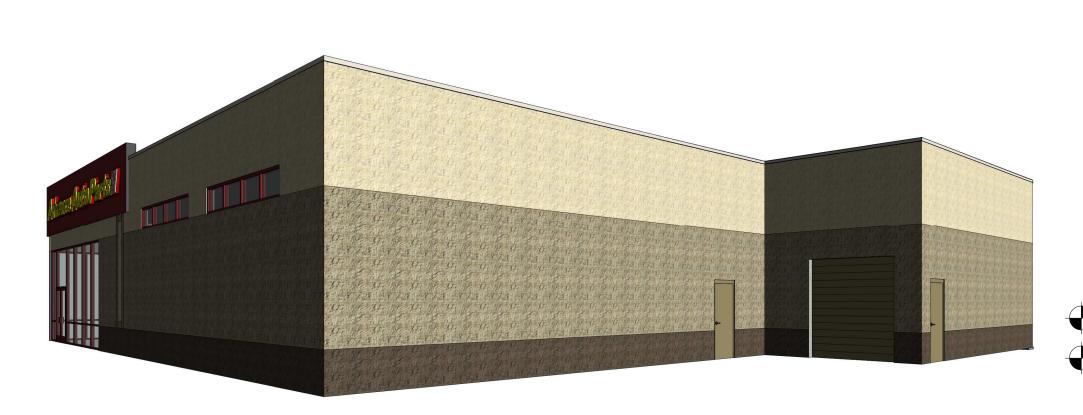


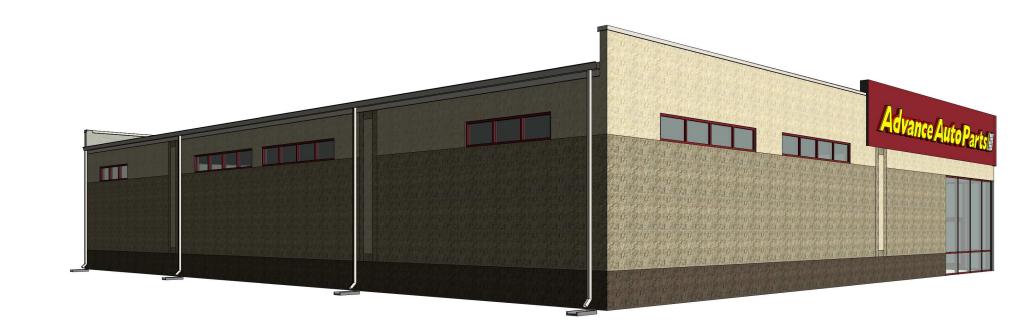PRELIMINARY PERSPECTIVE SOUTHEAST



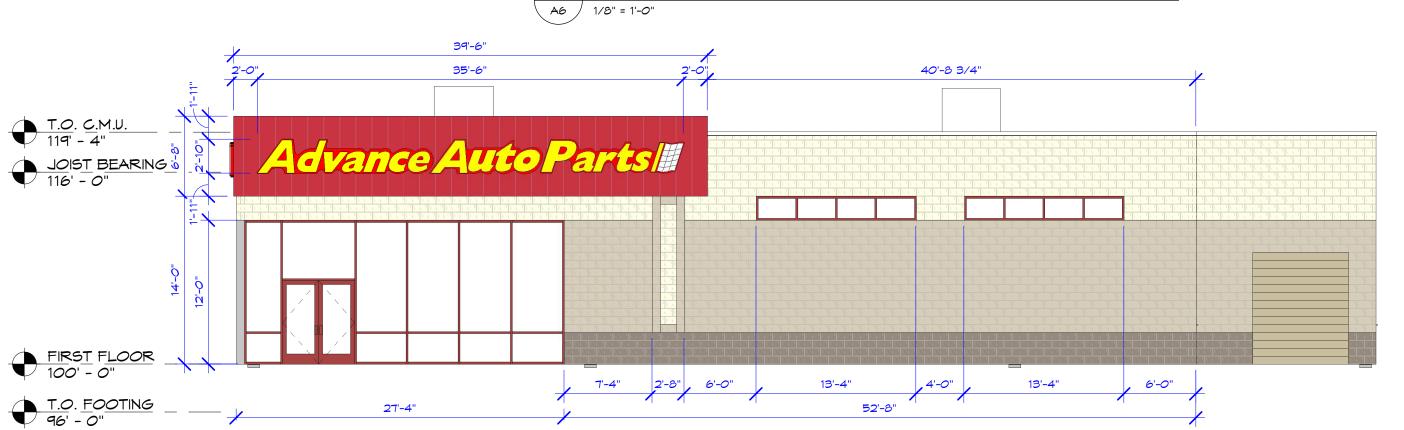

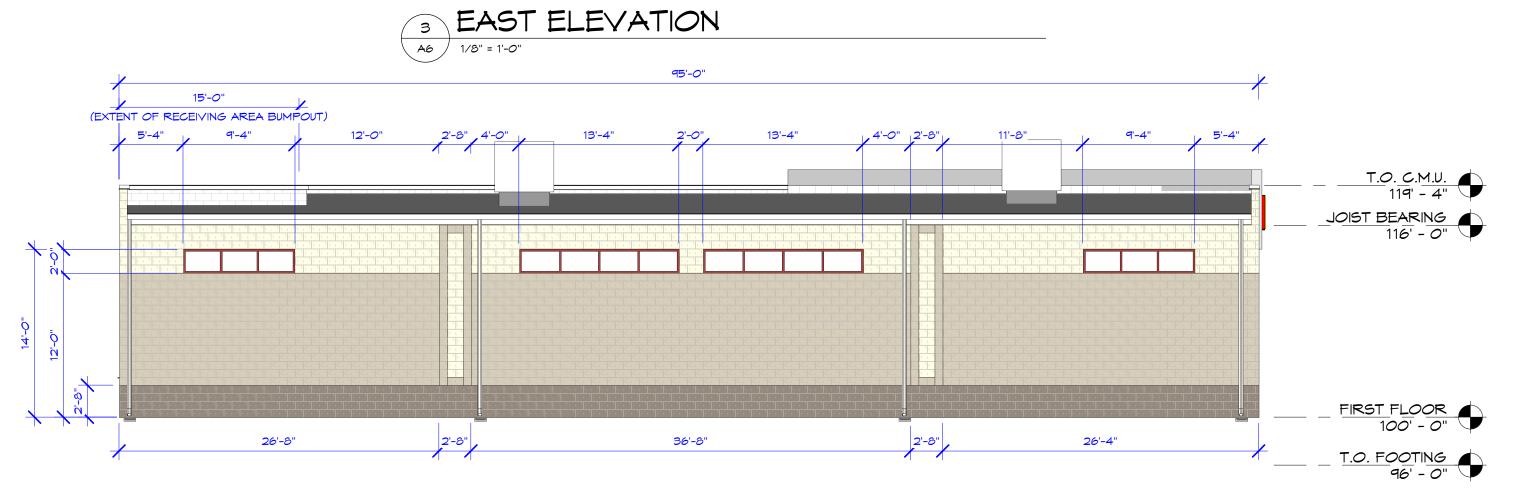

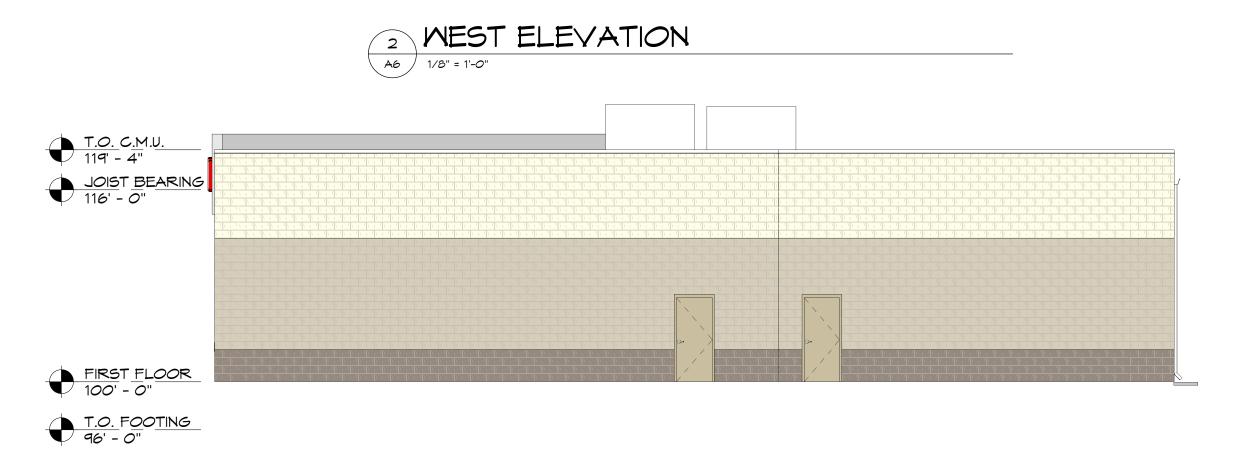

1 NORTH ELEVATION
A6 1/8" = 1'-0"

Gries Architectural Group Inc.

Soo North Commercial Street
Neenah, Wisconsin 54956
Phone: 920-722-2445 Fax: 920-722-6605
www.griesarchitectural.com

ATE DESCRIPTION

2/11 REVTO SS PLAN - CORNER ENTRY PER CITY RESTRICTIONS

SIT

DATE: GROSS BLD. SIZE:

O2/17/12


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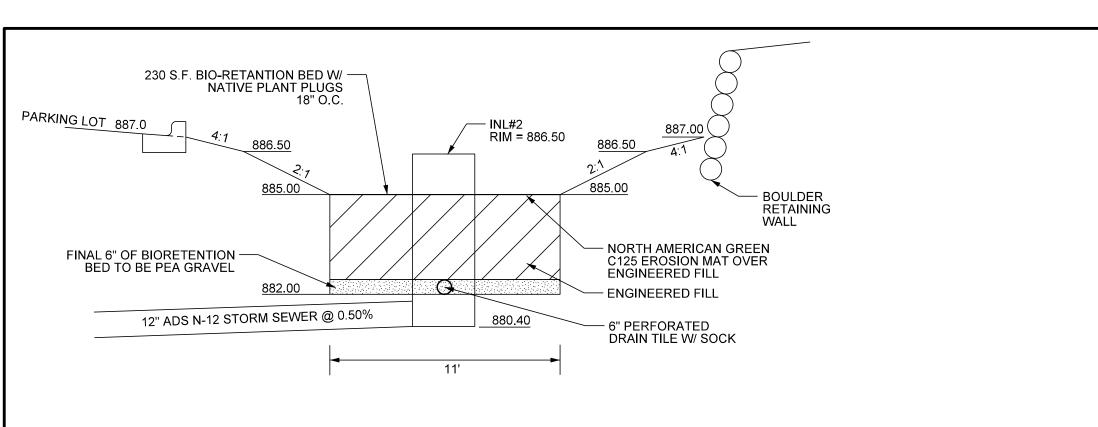
12-O11 SJT --
80' X 80'

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ALL REPORTS, PLANES, SPECIFICATIONS, FIRED DATA AND NOTES AND OTHER DOCUMENTS, INCLUDING ALL DOCUMENTS ON ELECTRONIC MEDIA, PREPARED BY THE DESIGN PROFESSIONAL AS INSTRUMENTS OF SERVICE SHALL REMAIN THE PROPERTY OF THE DESIGN PROFESSIONAL, DISSEMINATION MAY NOT BE MADE WITHOUT PRIOR CONSENT OF THE DESIGN PROFESSIONAL, ALL COMMON LAW RIGHTS OF COPYRIGHT AND OTHERWISE, ARE HEREBY SPECIFICALLY RESERVED.

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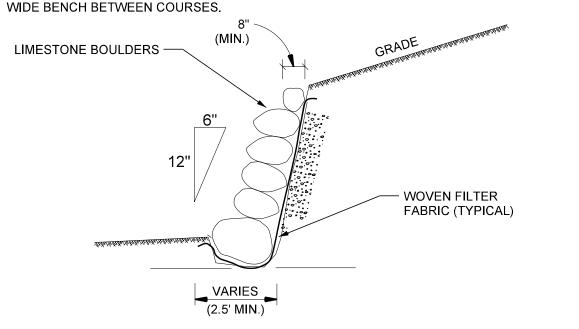


BIO-RETENTION DETAIL A-A

BIORETENTION NOTES

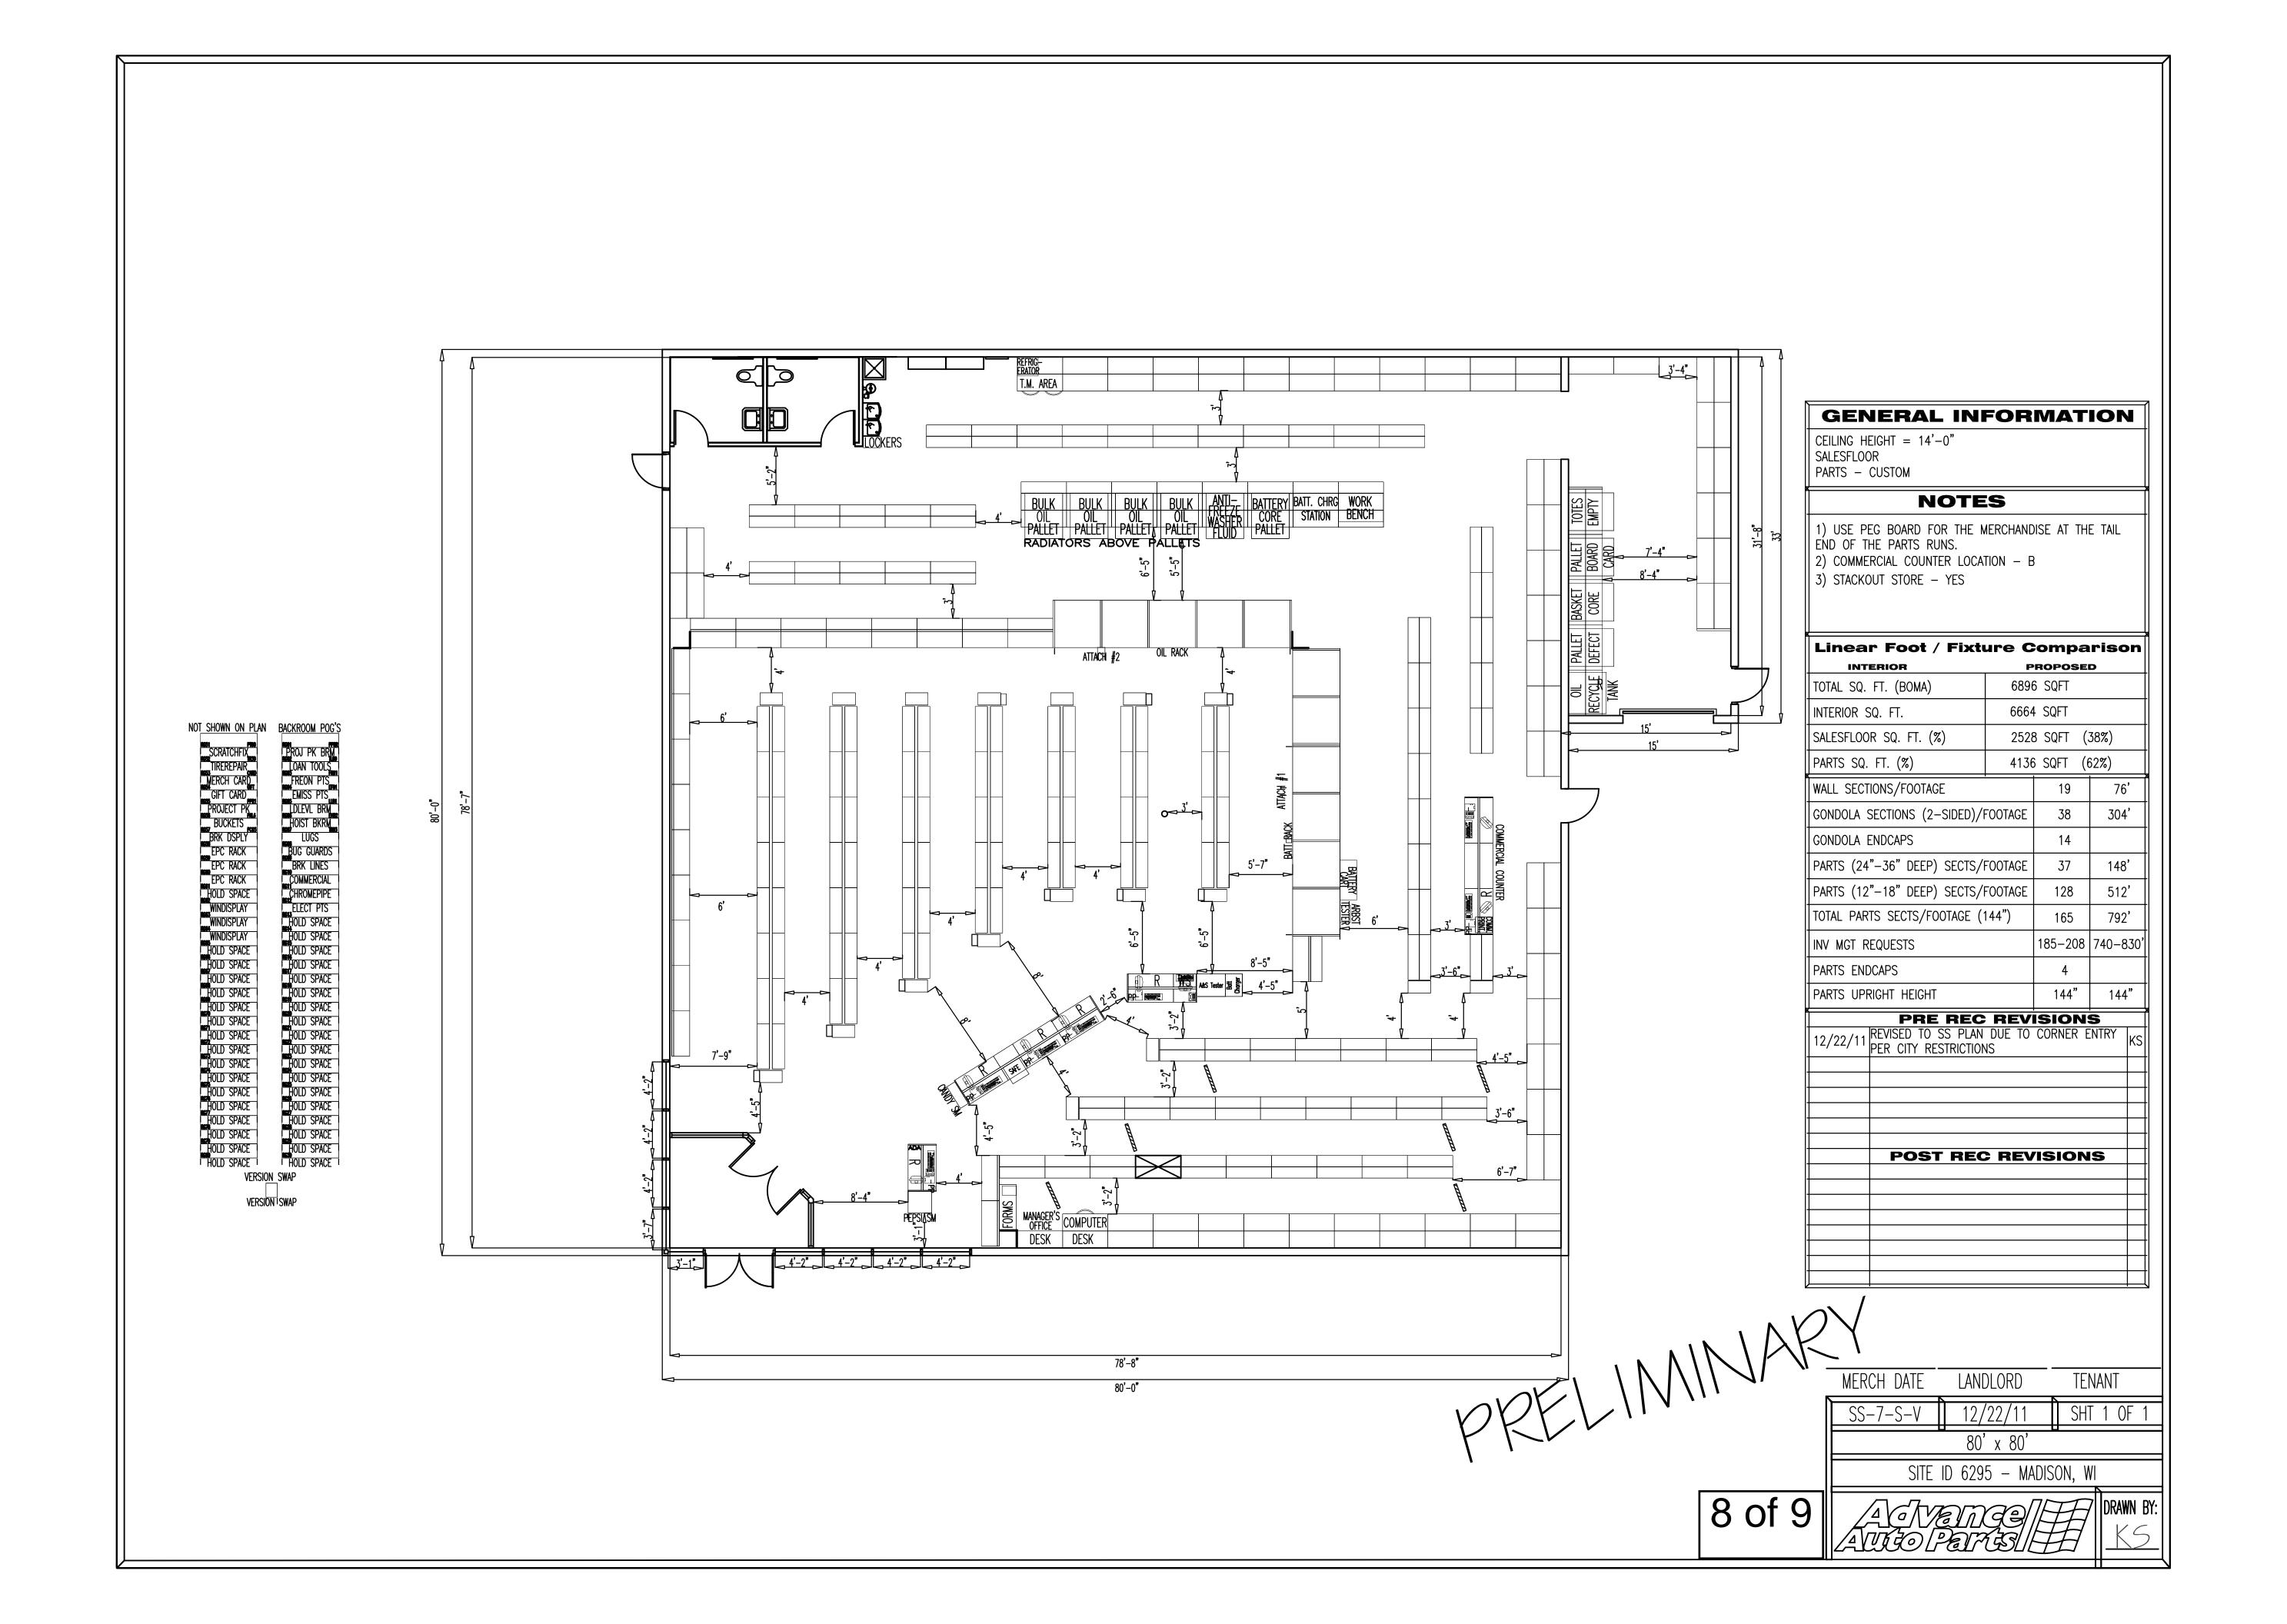
- A) The basin shall be constructed per the Wisconsin DNR Technical Standard 1004.
- B) Basin shall be installed after the parking lots and drives are paved and concurrent with final landscaping and resotration
- C) The basin shall be excavated to within 1-foot of final grade at the time the site is rough graded to allow sediment to be captured during site work. Once the site is paved and being restored, the basin shall be excavated to finished grade and the engineered soil placed at that time.
- D) During construction, basin area shall be kept free of compaction by heavy equipment and materials.
- E) The engineered fill shall be a mixture of 70-85% coarse sand and 15-30% compost meeting the following requirements:
 - Sand USDA coarse sand 0.02 to 0.04 inch diameter pre-washed and well drained or dry prior to mixing Compost - shall meet the requirements of Wisconsin DNR S100
- F) The engineered soil mix shall be free of rock, roots, and debris over 1" in diameter.
- G) Contractor shall excavate for engineered soil and place engineered fill in a manner that minimizes compaction of fill and subgrade.







RETAINING WALL DETAIL


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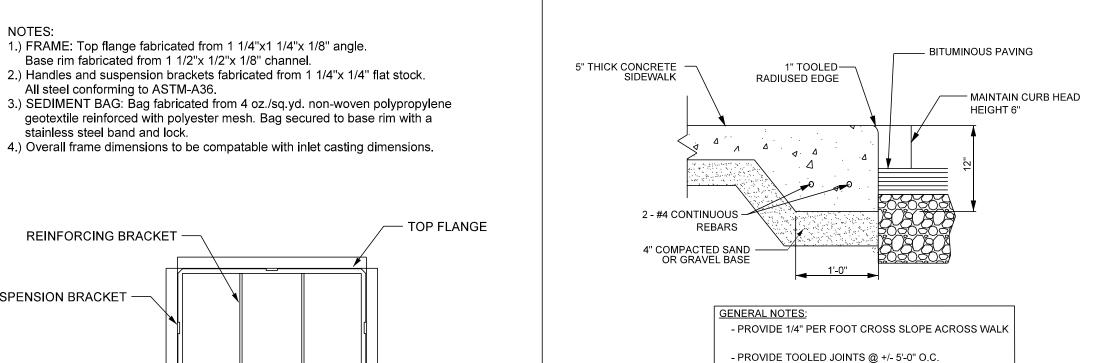


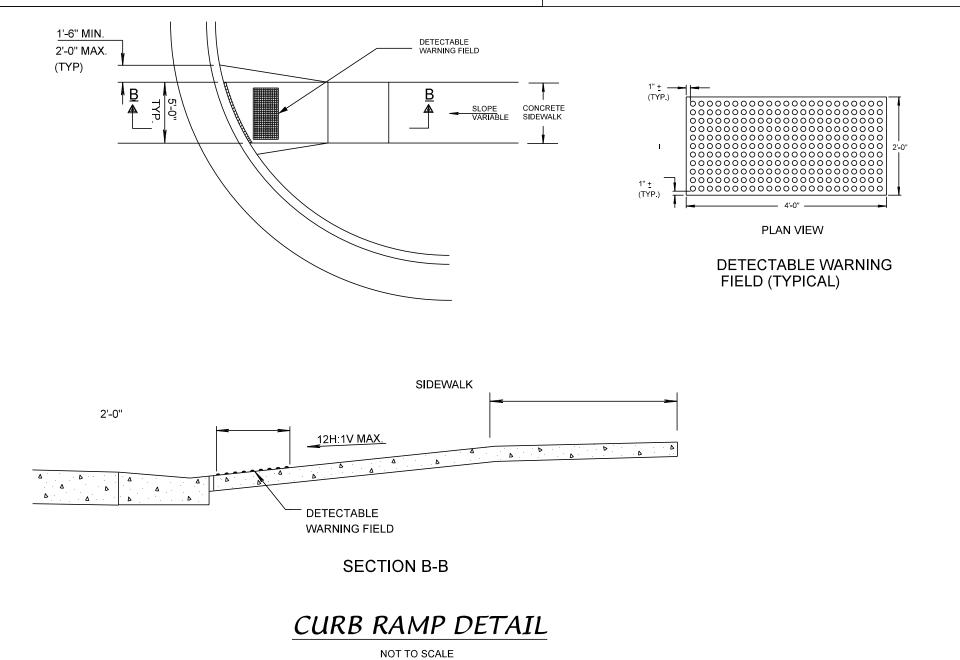

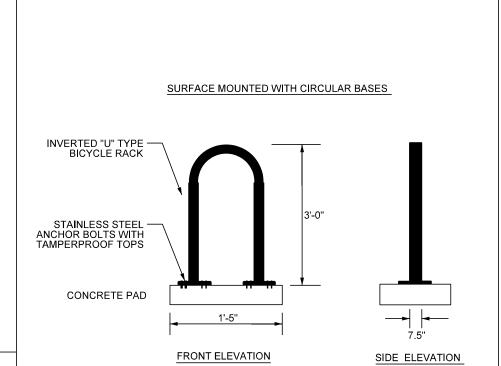


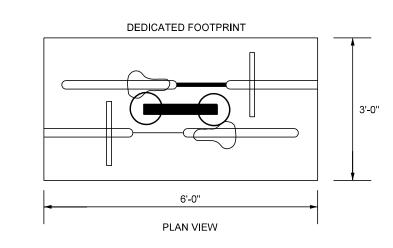BIKE RACK DETAIL NOT TO SCALE



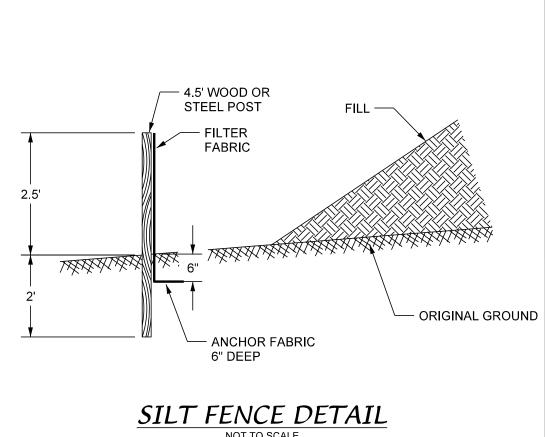


THICKENED EDGE WALK DETAIL

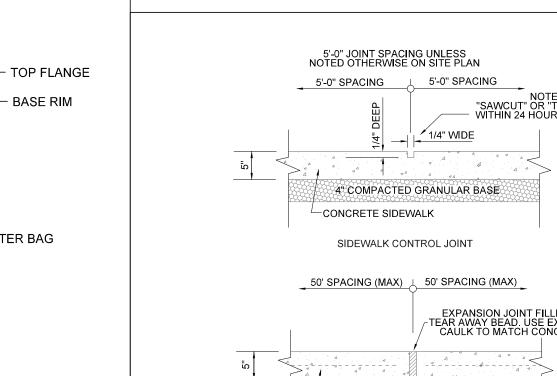

RECTANGULAR FRAME CATCH-ALL®

— FILTER BAG

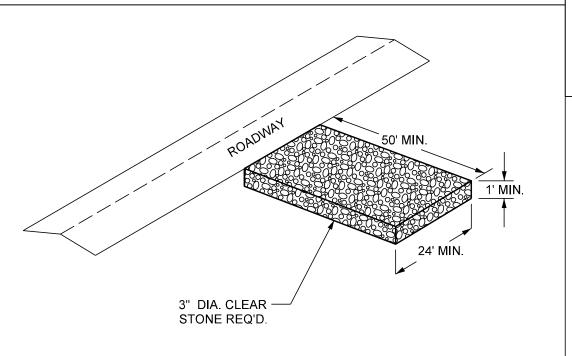

PROFILE VIEW

TOP VIEW


OVERFLOW SPACE -


SUSPENSION BRACKET -

SUSPENSION BRACKET


REINFORCING BRACKET

STONE TRACKING PAD DETAIL

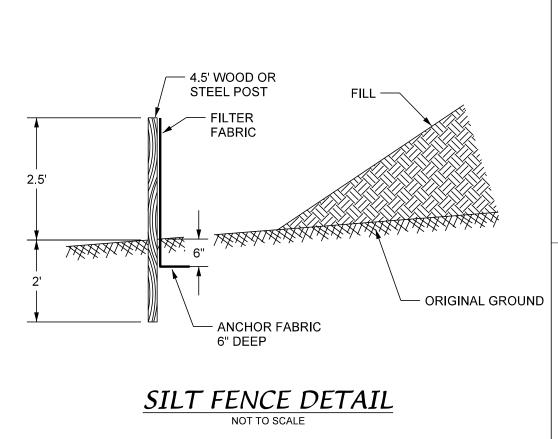


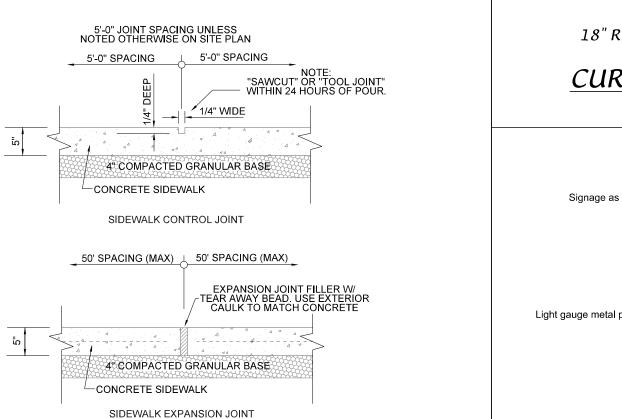


SIDEWALK DETAIL

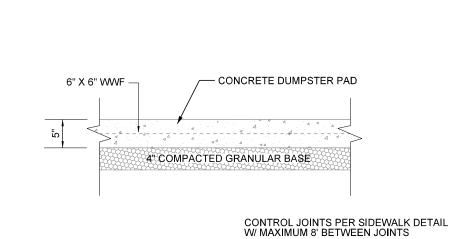

DUMPSTER PAD DETAIL

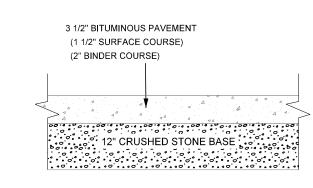


PARKING LOT PAVEMENT

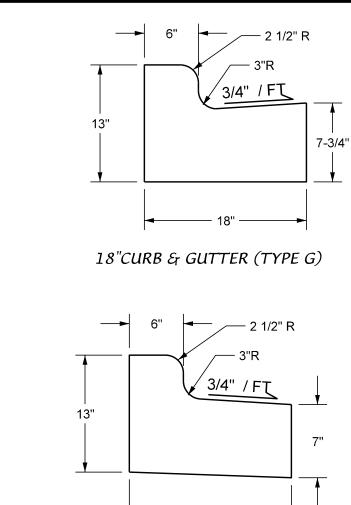


18" REJECT CURB & GUTTER (TYPE D)

CURB & GUTTER DETAIL

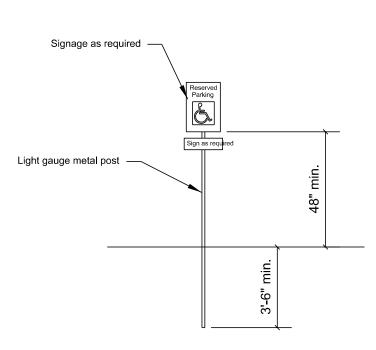

ACCESSIBLE PARKING SIGN DETAIL

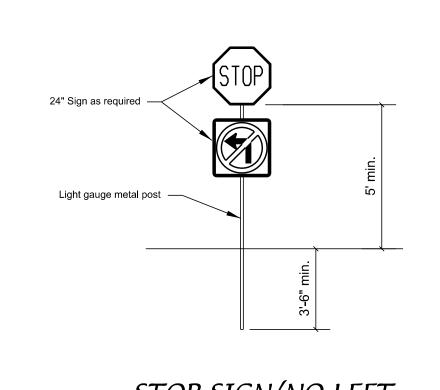

STOP SIGN/NO LEFT TURN SIGN DETAIL

DATE: 02-22-12 REVISED:

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