JOHN FISH McKENZIE PLACE, LLC

2107-2249 Sherman Avenue, Madison WI (Final address to be determined by City of Madison)



209 south water street milwaukee, wisconsin 53204 2310 crossroads drive suite 2000 imadison, wisconsin 53718 1613 fruitville road suite 3 sarasota, florida 34236

intelligent designs. inspired results. | www.prarch.com

Sheet Index

Architectural

Civil

Project Information

Bid Package Number:

Project Date: 07-22-15 PRA Project Number: 130139-03 Owner Project Number:

Applicable Codes and Zoning

Type of Construction

New Construction
Lower Level, protected, type IA, sprinklered, NFPA 13
First Floor and Above, protected, type VA, sprinklered, NFPA 13

Bicycles

Building Area

 Lower Level Parking:
 24,543 SQ FT

 Level One:
 19,642 SQ FT
 Level Two: Level Three: 25,510 SQ FT 18,560 SQ FT 18,560 SQ FT 776 SQ FT Level Four: Mezzanine Level: 107,591 SQ FT


Dwelling Unit Count

					UNIT TYPES						
FLOOR	STUDIO	1 BED	1 BED ADA	1 BED + DEN	2 BED	2 BED ADA	2 BED + DEN	3 BED	LOFT 1 BED	LOFT 2 BED	TOTAL/ FLOOR
1	3	4		1	2						10
2	5	11		1	2		2				21
3	2	7		1	2	1	1	1			15
4/LOFT		1	1	1	3			2	4	2	14
TOTAL	10	23	1	4	9	1	3	3	4	2	60

Dwelling Unit Design Count

	UNIT DESIGN TYPES															
			UNIT B		UNIT D	UNITE		UNIT F			UNIT I			UNIT L	UNIT M	
	UNIT A	UNIT B	1 BED	UNIT C	1 BED	1 BED	UNIT F	2 BED	UNIT G	UNIT H	2 BED	UNIT J	UNIT K	LOFT	LOFT	TOTAL/
FLOOR	STUDIO	1 BED	ADA	1 BED	+ DEN	+ DEN	2 BED	ADA	2 BED	2 BED	+ DEN	3 BED	3 BED	1 BED	2 BED	FLOOR
1	3	4				1				2						10
2	5	11				1				2	2					21
3	2	5		2	1		1	1	1		1		1			15
4/LOFT			1	1	1		2		1			1	1	4	2	14
TOTAL	10	20	1	3	2	2	3	1	2	4	3	1	2	4	2	60

Project Location

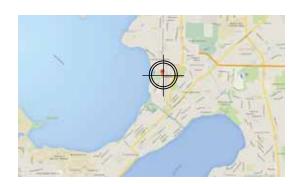

Project Team


Owner John Fish 315 Lakewood Blvd. Madison, WI 53704

Tel 608 219-7766


Tel 608 826-0532

Civil Brian Barritt Vierbicher Associates, Inc. 999 Fourier Drive #201 Madison, WI 53717

(Under direct contract to Owner)

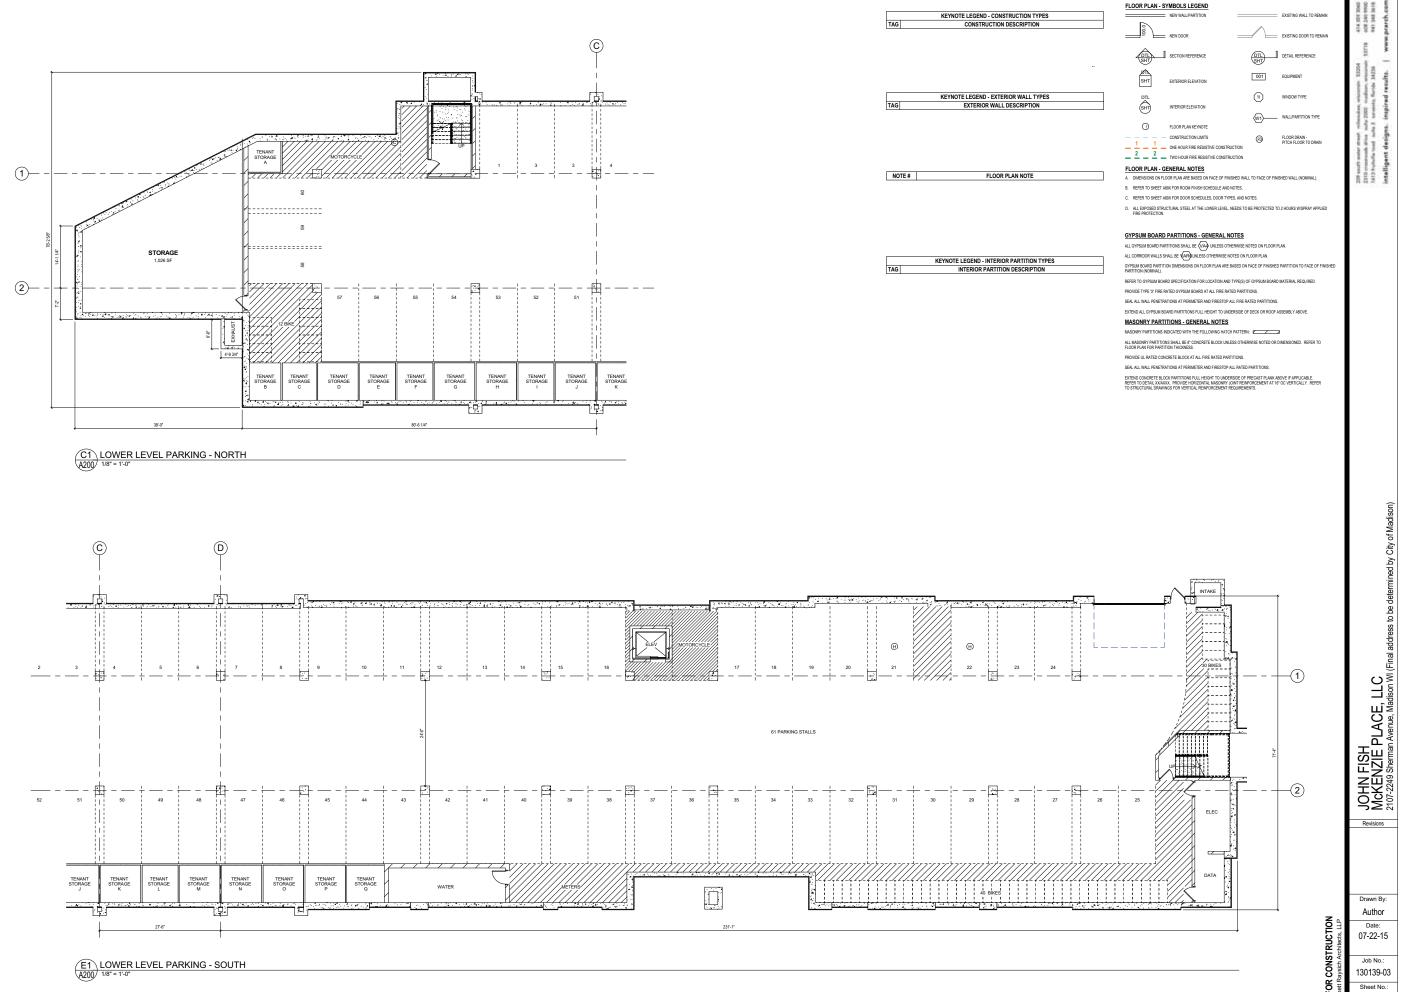

A200

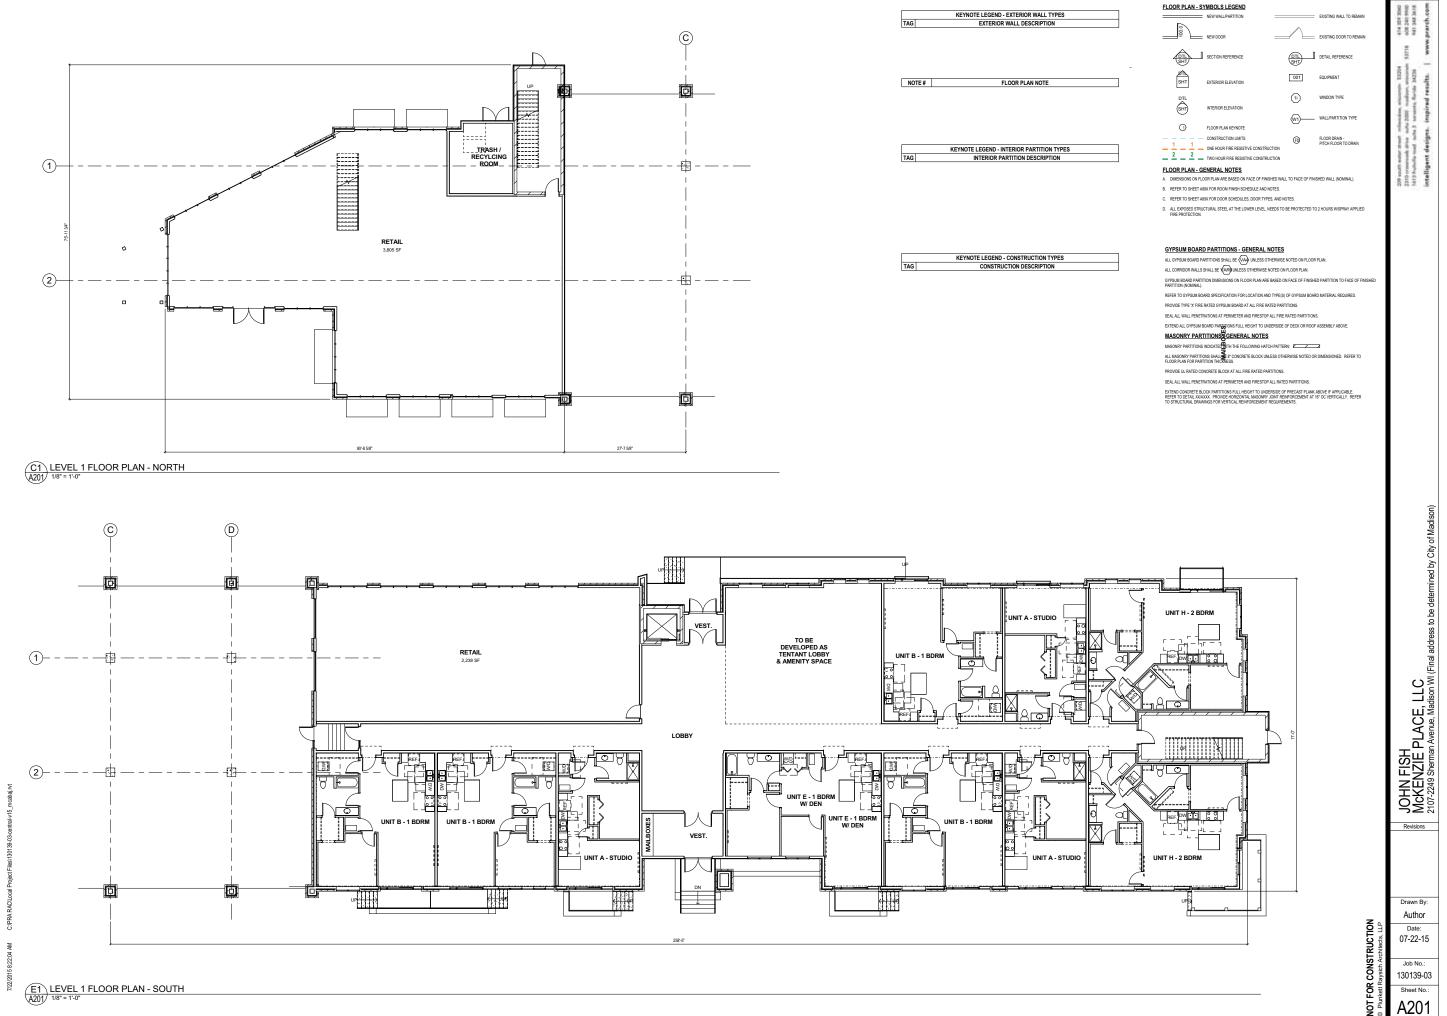

E1 LEVEL 2 FLOOR PLAN - SOUTH


Ç

07-22-15 Job No.: 130139-03 Sheet No.:

Author

JOHN FISH McKENZIE PLACE, LLC 2107-2249 Sherman Avenue, Madison WI (Final address to be determined by City of Madison)

A202

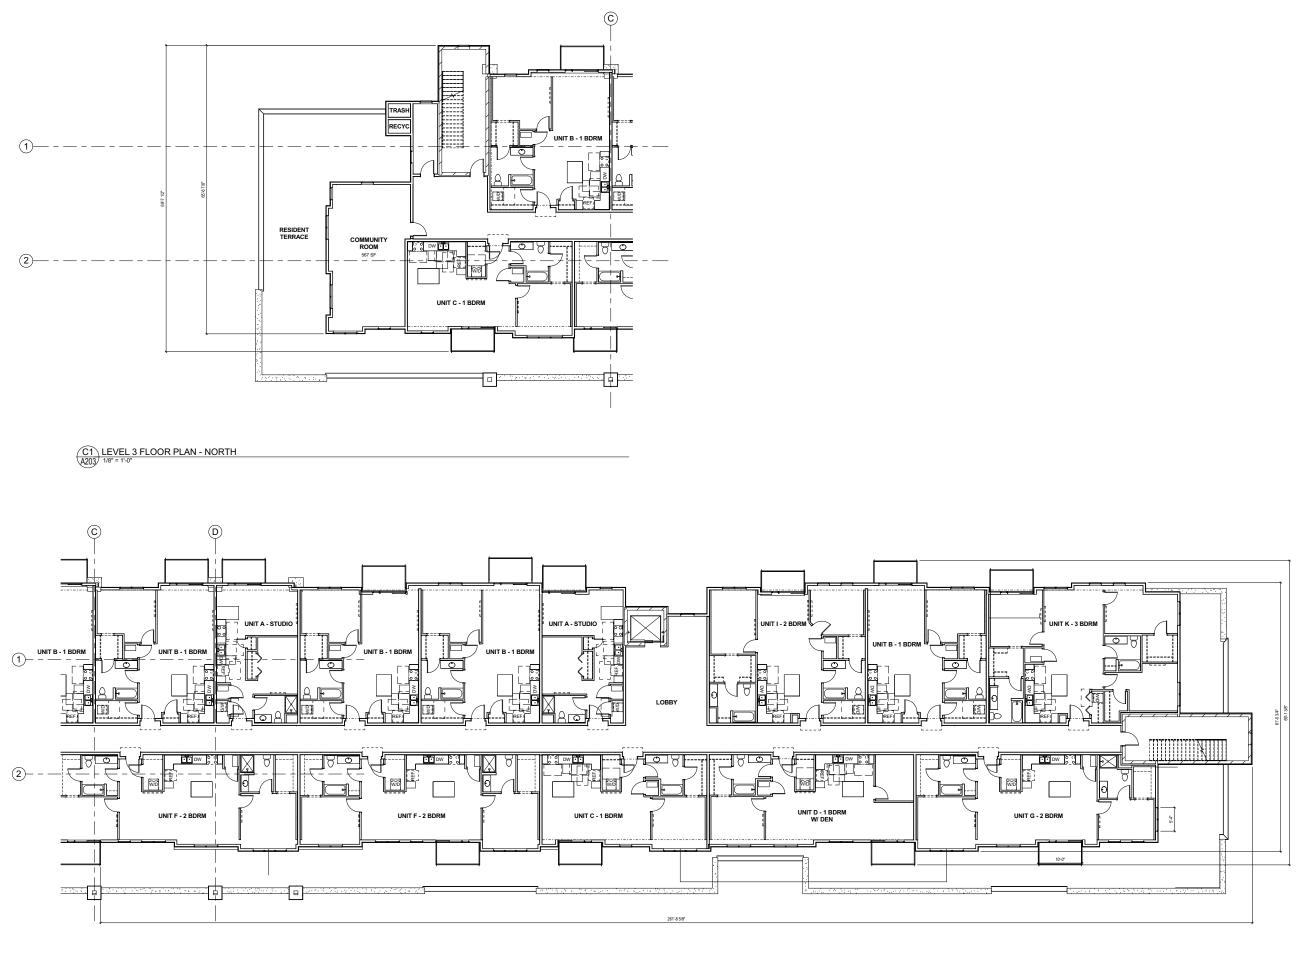

Job No.: 130139-03

Author 07-22-15

JOHN FISH
MCKENZIE PLACE, LLC
2107-2249 Sherman Avenue, Madison WI (Final address to be determined by City of Madison)

Sheet No.: A203

E1 LEVEL 3 FLOOR PLAN - SOUTH

Ç

07-22-15


Job No.: 130139-03

JOHN FISH
McKENZIE PLACE, LLC
2107-2249 Sherman Avenue, Madison WI (Final address to be determined by City of Madison)

Revisions

Drawn By: Author

Sheet No.: A204

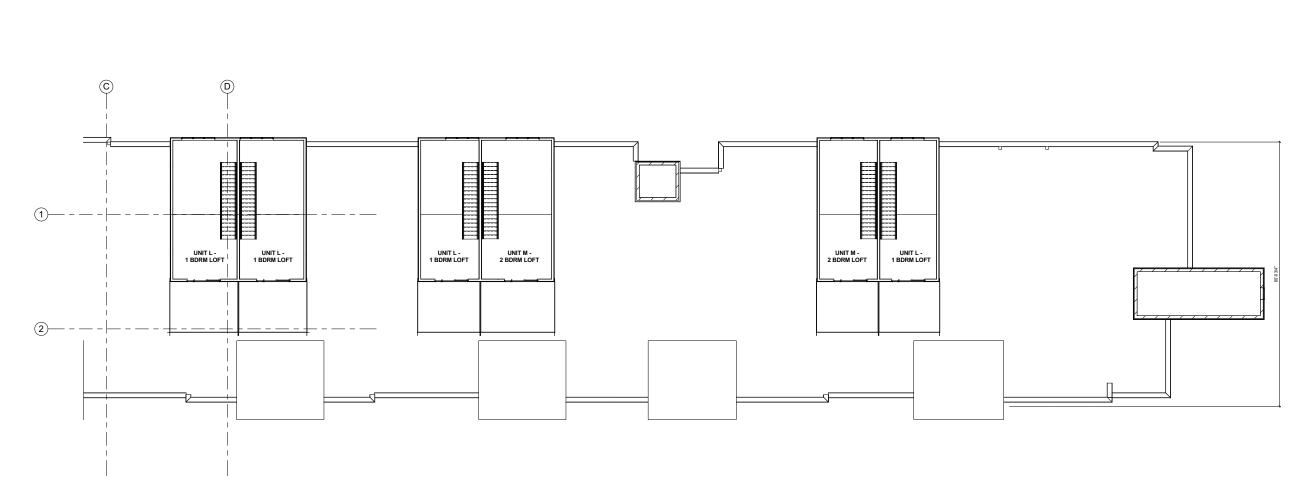

Job No.: 130139-03 Sheet No.: A205

Drawn By:
Author
Date:
07-22-15

JOHN FISH
MCKENZIE PLACE, LLC
2107-2249 Sherman Avenue, Madison WI (Final address to be determined by City of Madison)

E1 LEVEL 5 FLOOR PLAN - LOFTS
A205 1/8" = 1'-0"







C2 VIEW OF RETAIL ALONG SHERMAN
3/32" = 1'-0"

A221


Job No.: 130139-03

Author Date: 07-22-15


JOHN FISH
MCKENZIE PLACE, LLC
2107-2249 Sherman Avenue, Madison WI (Final address to be determined by City of Madison)



EXTERIOR FINISH PATTERNS EXTERIOR ELEVATIONS - GENERAL NOTES

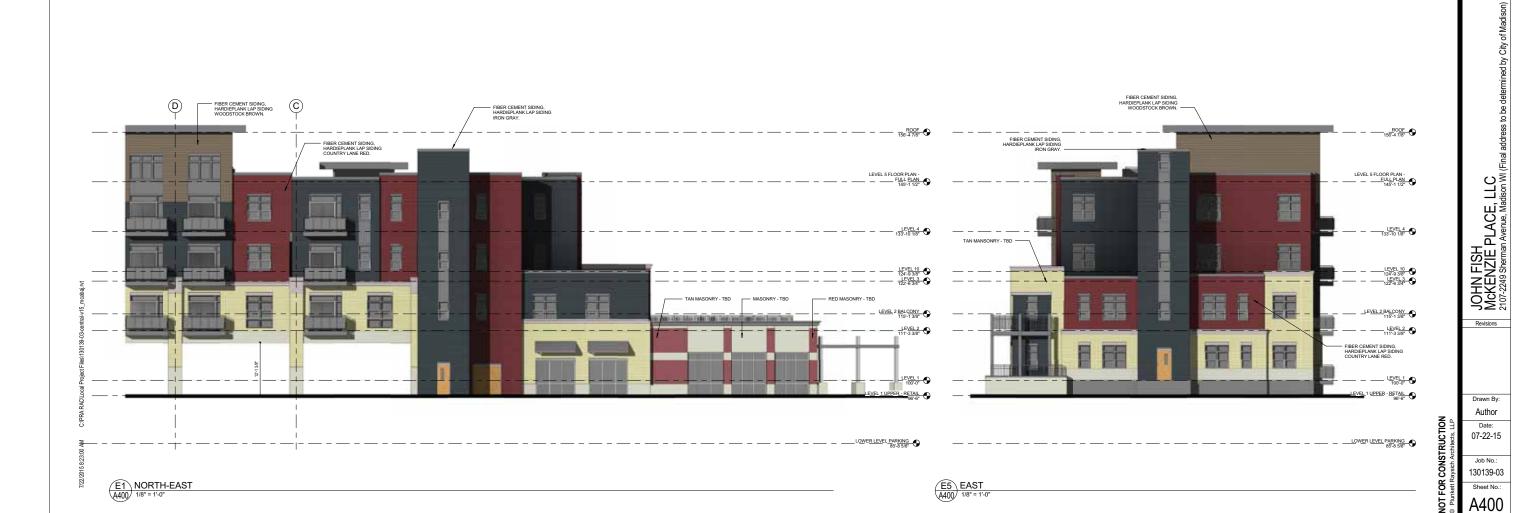



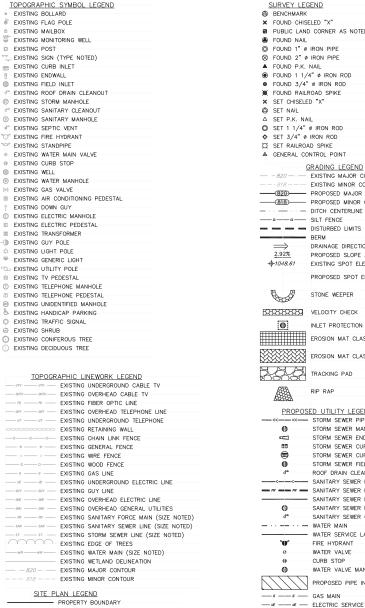

CURB AND GUTTER (REVERSE CURB HATCHED)

PROPOSED LIGHT-DUTY ASPHALT

PROPOSED HEAVY-DUTY ASPHALT

PROPOSED ADA DETECTABLE WARNING FIELD

- PROPOSED WOOD FENCE


PROPOSED SIGN


PROPOSED LIGHT POLE PROPOSED BOLLARD

PROPOSED HANDICAP PARKING

PROPOSED CONCRETE

** \$

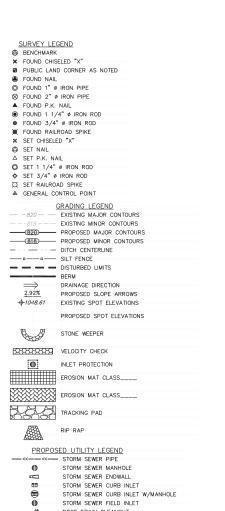

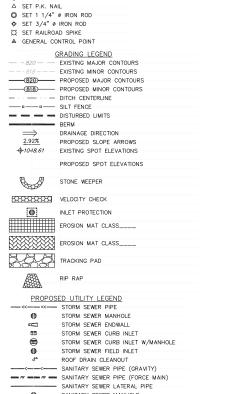

0 SANITARY SEWER MANHOLE SANITARY SEWER CLEANOUT

- · · -- · · - WATER MAIN WATER SERVICE LATERAL PIPE 100 FIRE HYDRANT WATER VALVE CURB STOP WATER VALVE MANHOLE

ABBREVIATIONS STMH - STORM MANHOLE FI - FIELD INLET CI - CURB INLET CB - CATCH BASIN EW - ENDWALL SMH - SANITARY MANHOL

PROPOSED PIPE INSULATION



Dial ar (800) 242-851

CONSTRUCTION AND GENERAL NOTES:

1. INSTALL A 50'L X 20'W X 1.5'D TRACKING PAD AT THE SITE ENTRANCE. THE TRACKING PAD SHALL BE MAINTAINED/REPAIRED AS NECESSARY TO ACCOMMODATE CONSTRUCTION.

2. THE CONTRACTOR IS REQUIRED TO MAKE EROSION CONTROL INSPECTIONS AT THE END OF EACH WEEK AND WHEN 0.5 INCHES OF RAIN FALLS WITHIN 24 HOURS. INSPECTION REPORTS SHALL BE PREPARED AND FILED AS REQUIRED BY THE DNR. ALL MAINTENANCE/REPAIR WILL FOLLOW AN INSPECTION WITHIN 24 HOURS. REPORTS SHALL BE SUBMITTED TO CITY ENGINEER

3. UTILITY STRUCTURE RIM AND TOP OF CURB ELEVATIONS ON PLANS ARE APPROXIMATE. UTILITY STRUCTURES SHALL BE SET TO FINAL ELEVATIONS AFTER THE CURB & GUTTER AND BASE COURSE HAVE BEEN INSTALLED.

4. THE CONTRACTOR IS RESPONSIBLE FOR ANY DAMAGE CAUSED DURING CONSTRUCTION TO PUBLIC PROPERTY, PRIVATE PROPERTY OR UTILITIES.

5. THE CONTRACTOR SHALL SUBMIT SHOP DRAWINGS FOR REVIEW BY THE ENGINEER, PRIOR TO PLACING AN ORDER OF ANY SUCH ITEM.

6. EXISTING TOPOGRAPHIC INFORMATION IS BASED ON FIELD OBSERVATIONS AND/OR PLAN OF RECORD DRAWINGS. CONTRACTOR SHALL VERIFY TOPOGRAPHIC INFORMATION PRIOR TO STARTING CONSTRUCTION.

7. THE LOCATIONS OF EXISTING UTILITY INSTALLATIONS AS SHOWN ON THE PLAN ARE APPROXIMATE. THERE MAY BE OTHER UTILITY INSTALLATIONS WITHIN THE PROJECT AREA THAT ARE NOT SHOWN. CONTRACTOR SHALL BE RESPONSIBLE FOR CONTACTING DIGGERS HOTLINE AND LOCATING ALL EXISTING UTILITIES AND ENSURE PROPER CLEARANCE OF NEW UTILITIES.

8. THE CONTRACTOR SHALL REMOVE ANY SEDIMENT TRACKED ONTO ADJACENT ROADS BY MEANS OF STREET SWEEPING (NOT FLUSHING) AT A MINIMUM OF THE END OF EACH WORK DAY.

9. RIGHT OF WAY (ROW) AND PROPERTY LINES ARE APPROXIMATE. CONTRACTOR SHALL BE RESPONSIBLE FOR PROTECTING EXISTING PROPERTY CORNER MONUMENTATION. ANY MONUMENTS DISTURBED BY CONTRACTOR SHALL BE REPLACED AT THE CONTRACTORS EXPENSE.

10. CONTRACTOR SHALL COORDINATE WITH DRY UTILITY COMPANY'S REGARDING ANY POTENTIAL CONFLICTS AND COORDINATE RELOCATIONS AS MAY BE REQUIRED. CONTRACTOR SHALL ALSO COORDINATE THE PROPOSED INSTALLATION OF NEW FACILITIES

11. INSTALL WATER MAIN AT ADEQUATE DEPTH (MIN 6.5' OF COVER) TO AVOID CONFLICT WITH PROPOSED SANITARY SEWER AND STORM SEWER PER DNR STANDARDS EXCEPT WHERE NOTED ON THE PLANS. MAINTAIN MINIMUM 1.5' CLEAR SEPARATION IF WATER CROSSES BELOW SEWER AND MINIMUM 0.5' IF WATER CROSSES ABOVE.

12. SANITARY MANHOLES WITH SEWER MAIN CONNECTIONS GREATER THAN 2' ABOVE THE LOWEST INVERT SHALL BE CONSTRUCTED WITH AN EXTERNAL DROP. MANHOLES WITH SEWER LATERAL CONNECTIONS GREATER THAT 2' ABOVE THE LOWEST INVERT SHALL BE CONSTRUCTED WITH AN INTERNAL DROP PER CONSTRUCTION DETAIL.

13. INSTALL 1 SHEET OF 4'x8'x4'' HIGH DENSITY STYROFOAM INSULATION AT ALL LOCATIONS WHERE STORM SEWER CROSSES WATER MAIN OR WATER LATERALS.

14. DIMENSIONS RELATING TO CURB ARE TO FACE OF CURB.

15. CROSS-SLOPE OF SIDEWALKS SHALL BE 2% UNLESS OTHERWISE NOTED.

16. LONGITUDINAL GRADE OF SIDEWALK RAMPS SHALL NOT EXCEED 8.33% (1:12) AND SHALL BE IN ACCORDANCE WITH ADA REQUIREMENTS.

17. LONGITUDINAL GRADE OF SIDEWALK SHALL NOT EXCEED 5.0% OR THE ADJACENT STREET GRADE WHICHEVER IS GREATER.

18. ADJUST ALL EXISTING MANHOLE AND VALVE RIMS TO FINAL GRADE.

19. SANITARY SEWER MAIN AT BURY DEPTHS GREATER THAN 15' SHALL BE SDR 21. ALL OTHER SANITARY SEWER MAIN SHALL BE SDR 26.

AGENCIES:

EMERGENCY - FIRE, RESCUE, AMBULANCE, POLICE

UNITED STATES POST OFFICE 3902 MILWAUKEE ST MADISON, WI 53714-9998 PHONE: 608-831-5501

MADISON POLICE DEPARTMENT 211 S. CARROL ST MADISON, WI 53703 PHONE: 608-255-2345 NON-EMERGENCY

MADISON FIRE DEPARTMENT 30 W. MIFFLIN ST. MADISON, WI 53703

PHONE: 608-266-4420 NON-EMERGENCY

MADISON METRO 1245 E. WASHINGTON AVE. SUITE 201 MADISON, WI 53703 TIM SOBOTA PHONE: 608-261-4289

UTILITIES:

MG&E (GAS) PO BOX 1231 SHAUN ENDRES PHONE: 608-252-7224 (0) 608-516-7913 (C)

MG&E (ELECTRIC) PO BOX 1231 MADISON, WI 53701 CHRIS ERICKSON PHONE: 608-252-5670

CHARTER COMMUNICATIONS (CABLE TV) 2701 DANIELS STREET MADISON, WI 53718 JON MARSCHKE PHONE: 608-225-2479

TDS (TELEPHONE + FIBER) 1912 PARMENTER ST MIDDLETON, WI 53562 JERRY MYERS PHONE: 608-664-4404

CITY OF MADISON - CITY ENGINEER CITY-COUNTY BUILDING, ROOM 115 210 MARTIN LUTHER KING JR. BOULEVARD MADISON, WI 53703 PHONE: 608-266-4090

CITY OF MADISON - SANITARY AND STORM SEWER ENGINEER CITY-COUNTY BUILDING, ROOM 115 210 MARTIN LUTHER KING JR. BOULEVARD MADISON, WI 53703 GREG FRIES PHONE: 608-267-1199

CITY OF MADISON - WATER UTILITY 119 FAST OLIN AVE TOM HEIKKINEN, GENERAL MANAGER PHONE: 608-266-4651


MADISON GAS & ELECTRIC (GAS) 133 S. BLAIR STREET MADISON, WI 53703 ATTN: JOHN WICHERN (608) 252-7224


AND NOTES EGENDS Ŷ. AS SHOWN 7/17/15 DEHL/MKRI


Vierbicher


NOT FOR CONSTRUCTION

OJECT NO. 50109.00

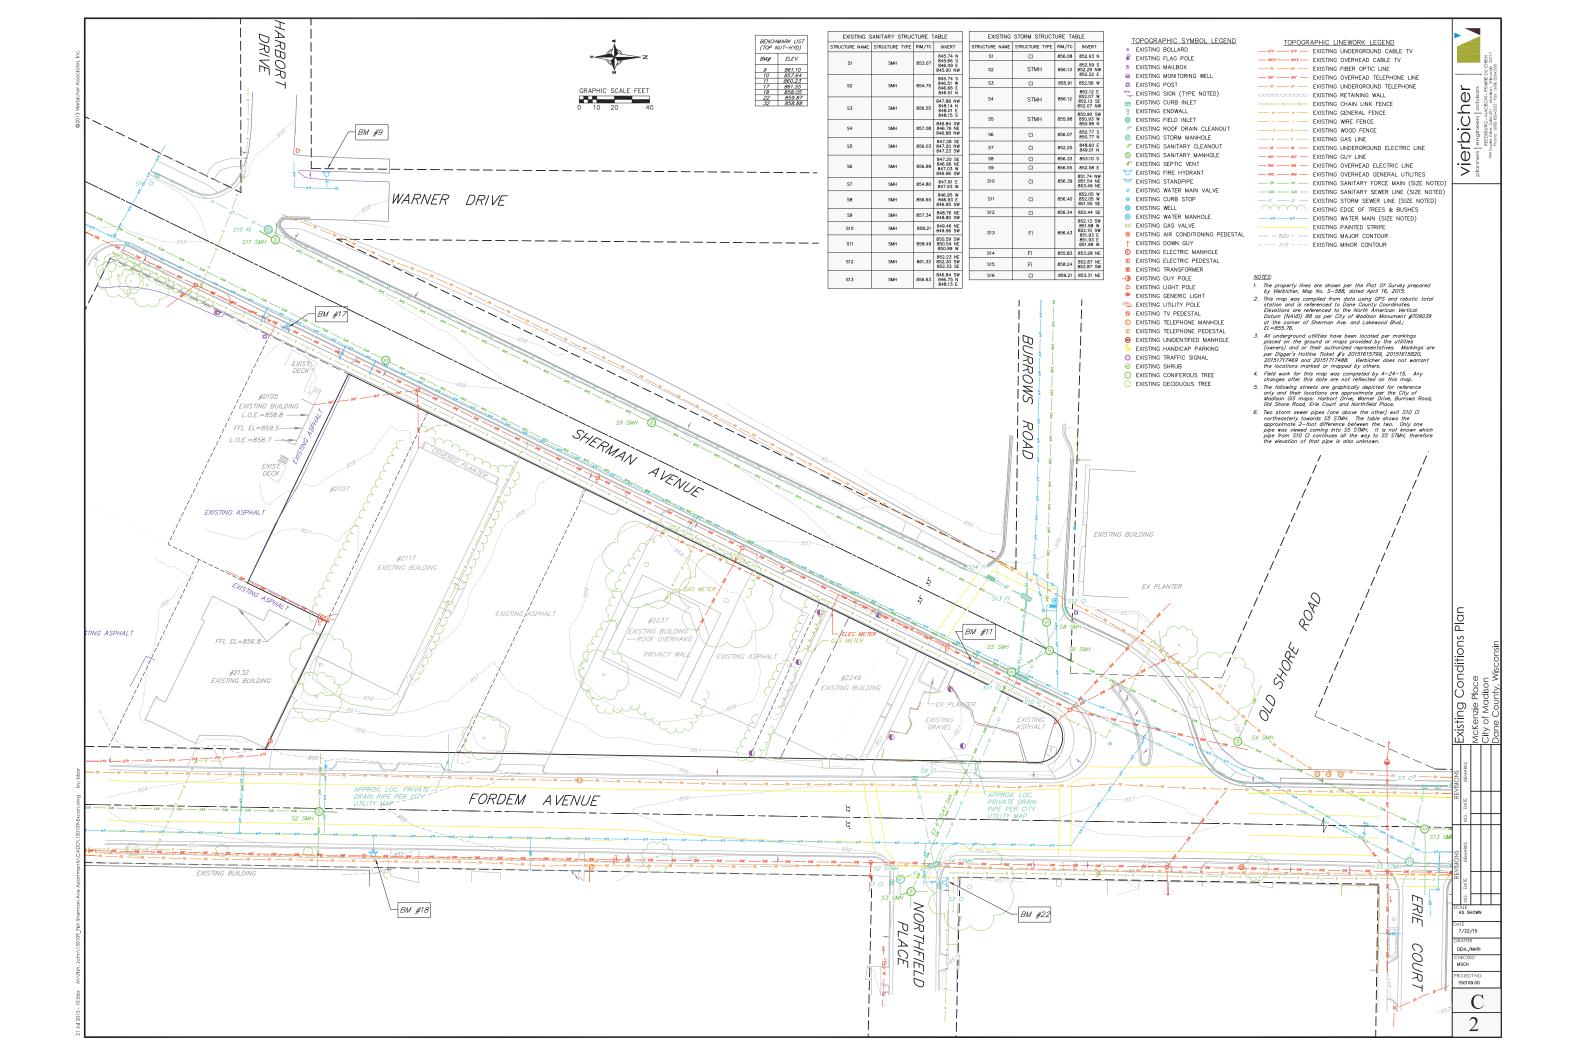

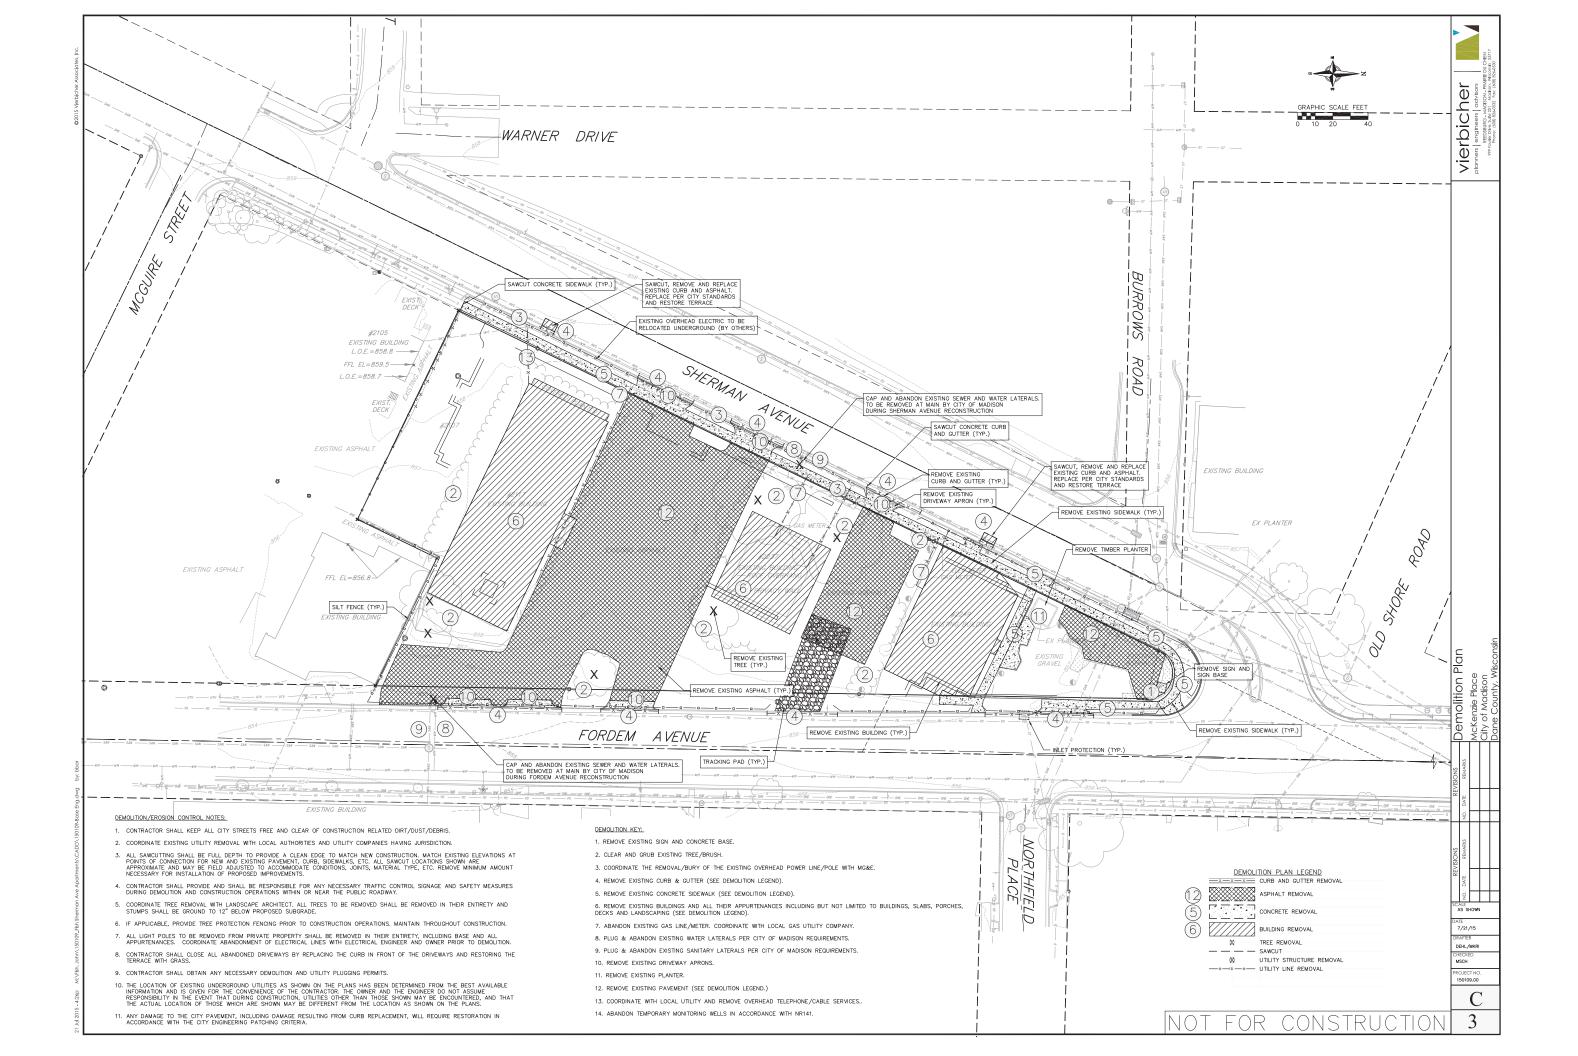

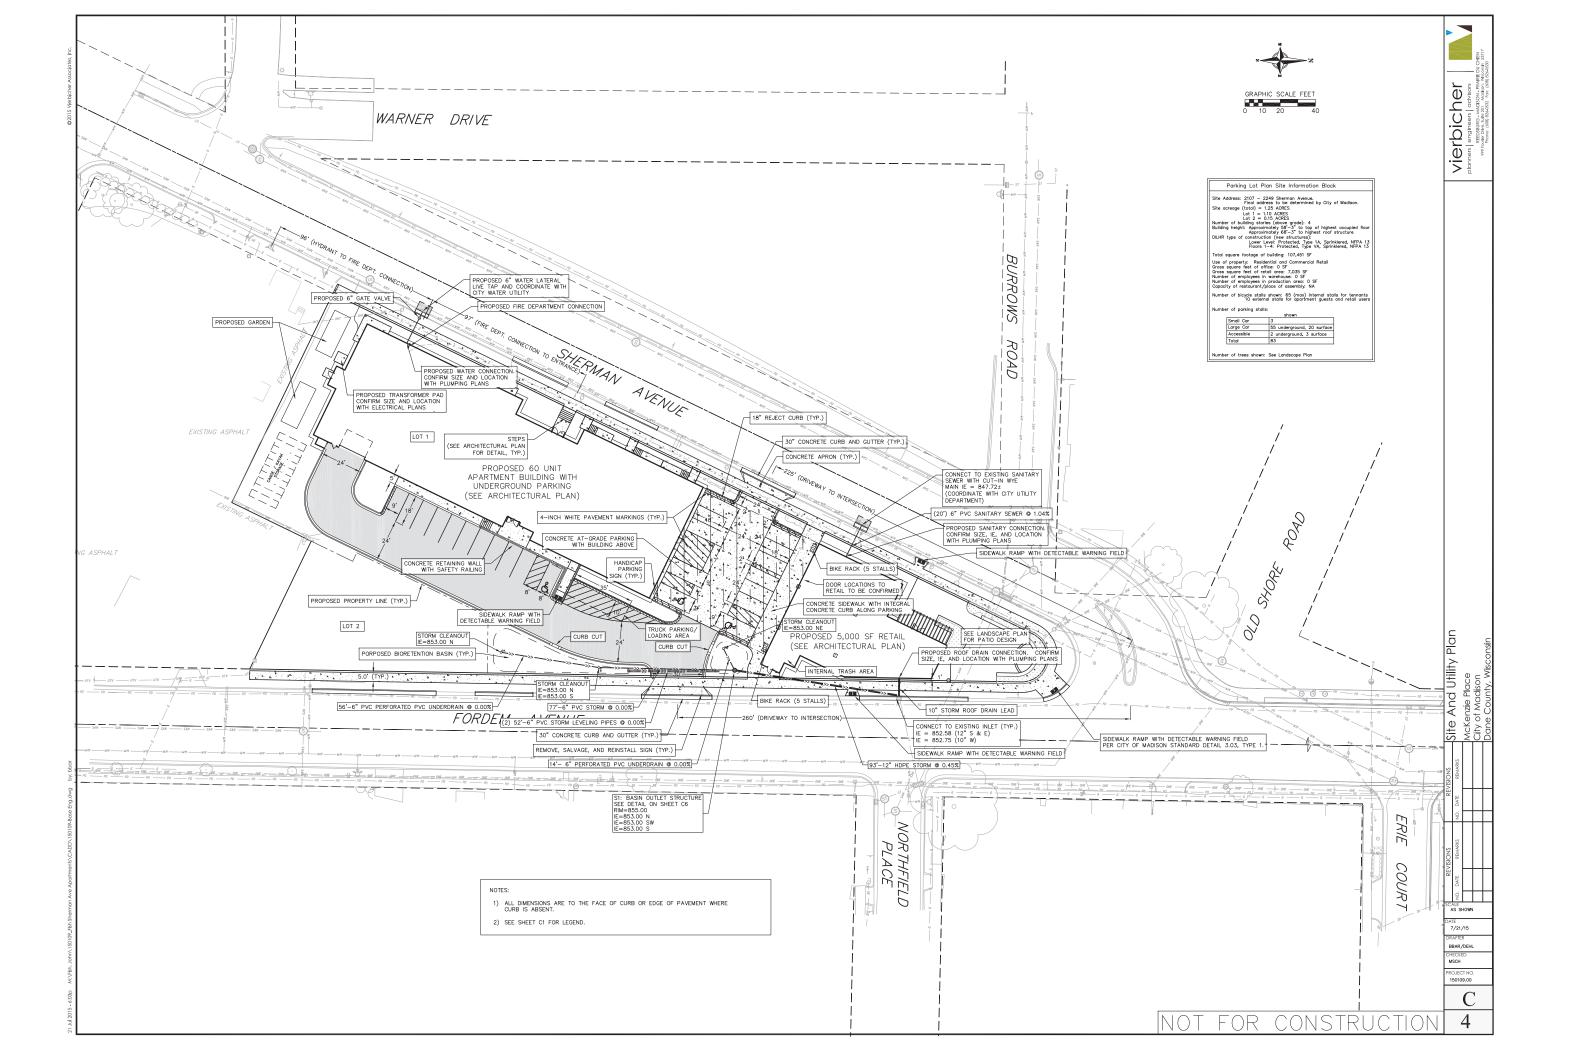

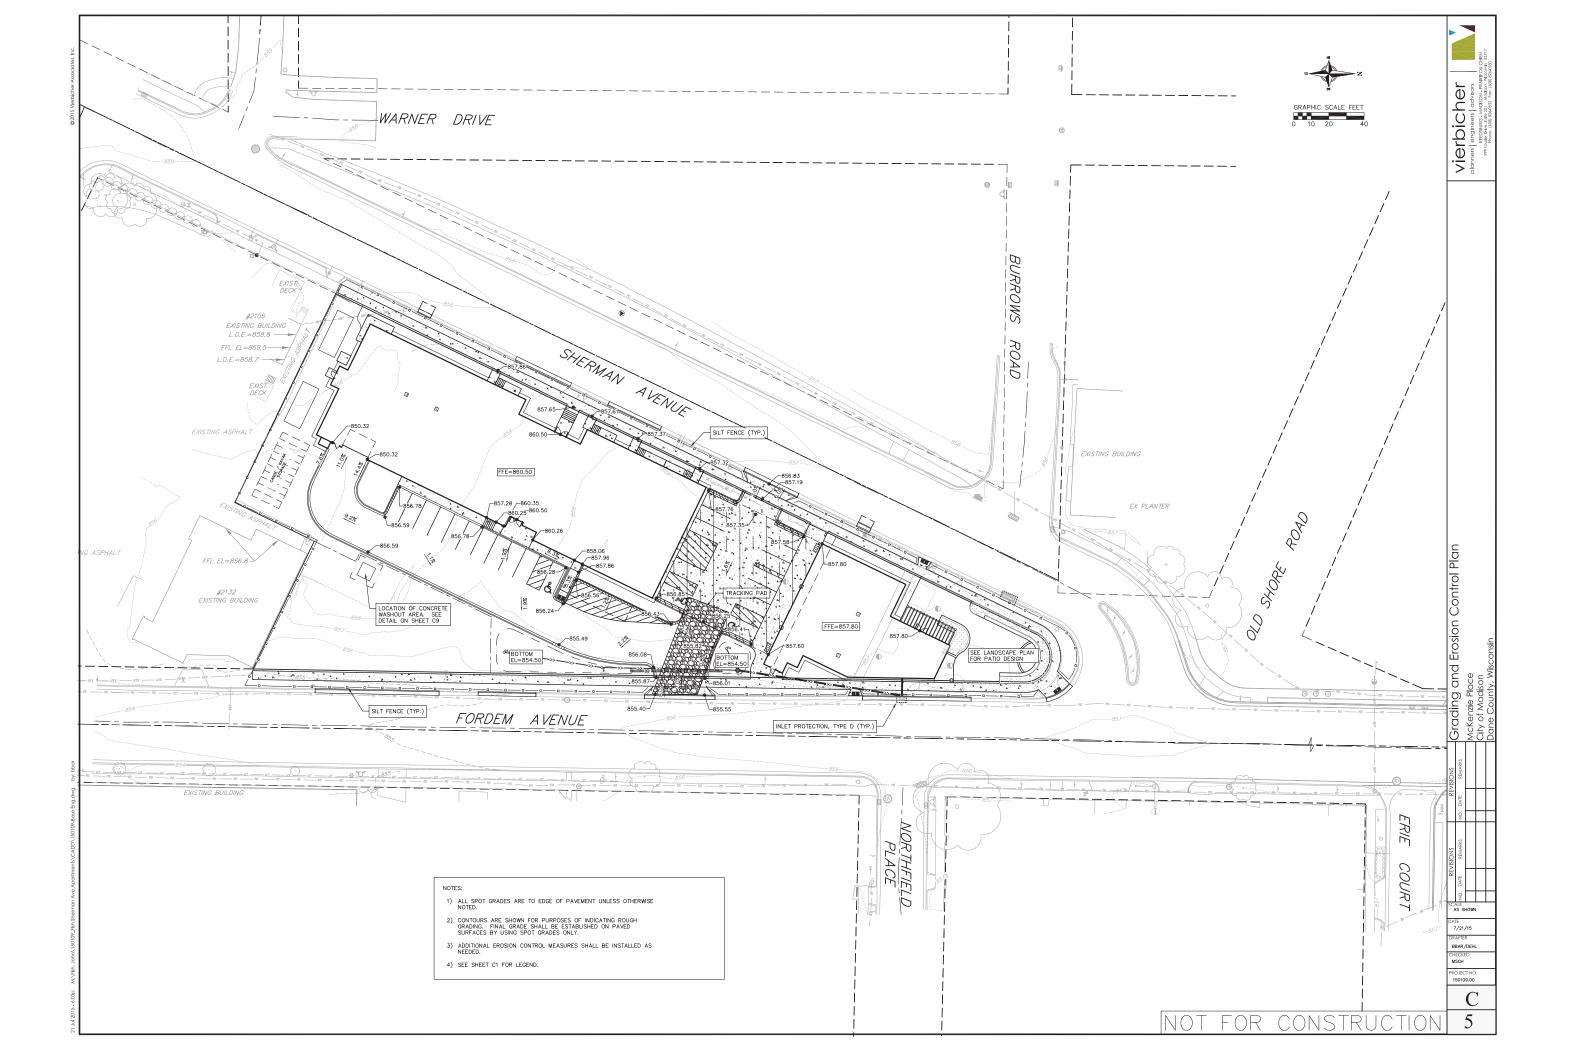

- EROSION CONTROL SHALL BE IN ACCORDANCE WITH THE CITY OF MADISON EROSION CONTROL ORDINANCE AND CHAPTER NR 216 OF THE WISCONSIN ADMINISTRATIVE CODE.
- CONSTRUCT AND MAINTAIN ALL EROSION AND SEDIMENT CONTROL MEASURES IN ACCORDANCE WITH WISCONSIN DNR TECHNICAL STANDARDS (http://dnr.wi.gov/runoff/stormwater/techstds.htm) AND WISCONSIN CONSTRUCTION SITE BEST MANAGEMENT PRACTICE HANDBOOK.
- 3. INSTALL SEDIMENT CONTROL PRACTICES (TRACKING PAD, PERIMETER SILT FENCE, SEDIMENT BASINS, ETC.) PRIOR TO INITIATING OTHER LAND DISTURBING CONSTRUCTION ACTIVITIES.
- 4. THE CONTRACTOR IS REQUIRED TO MAKE EROSION CONTROL INSPECTIONS AT THE END OF EACH WEEK AND WHEN 0.5 INCHES OF RAIN FALLS WITHIN 24 HOURS.
 INSPECTION REPORTS SHALL BE PREPARED AND FILED AS REQUIRED BY THE DNR AND/OR CITY. ALL MAINTENANCE WILL FOLLOW AN INSPECTION WITHIN 24 HOURS.
- 5. EROSION CONTROL IS THE RESPONSIBILITY OF THE CONTRACTOR UNTIL ACCEPTANCE OF THIS PROJECT. EROSION CONTROL MEASURES AS SHOWN BE HE MINIMUM PRECAUTIONS THAT WILL BE ALLOWED. ADDITIONAL EROSION CONTROL MEASURES, AS REQUESTED IN WRITING BY THE STATE OR LOC INSPECTORS, OR THE DEVELOPER'S ENGINEER, SHALL BE INSTALLED WITHIN 24 HOURS.
- 6. A 3" CLEAR STONE TRACKING PAD SHALL BE INSTALLED AT THE END OF FROAD CONSTRUCTION LIMITS TO PREVENT SEDIMENT FROM BEING TRACKED ONTO THE ADJACENT PACE PUBLIC ROADWAY. SEDIMENT TRACKING PAD SHALL CONFORM TO WISDING TECHNICAL STANDARD 1057. SEDIMENT REACHING THE PUBLIC ROAD SHALL BE REMOVED BY STREET CLEANING (NOT HYDRAULIC FLUSHING) BEFORE THE END OF EACH WORK DAY.
- CHANNELIZED RUNOFF: FROM ADJACENT AREAS PASSING THROUGH THE SITE SHALL BE DIVERTED AROUND DISTURBED AREAS.
- 8. STABILIZED DISTURBED GROUND: ANY SOIL OR DIRT PILES WHICH WILL REMAIN IN EXISTENCE FOR MORE THAN 7-CONSECUTIVE DAYS, WHETHER TO BE WORKED DURING THAT PERIOD OR NOT, SHALL NOT BE LOCATED WITHIN 25-FEET OF ANY ROADWAY, PARKING LOT, PAYED AREA, OR DRAINAGE STRUCTURE OR CHANNEL (UNLESS INTENDED TO BE USED AS PART OF THE EROSION CONTROL MEASURES). TEMPORARY STABILIZATION AND CONTROL MEASURES (SEEDING, MUCHING, TARRHO, EROSION MATTING, BARRIER FENCING, ETC.) ARE REQUIRED FOR THE OPTICETION OF DISTURBED AREAS AND SOIL PILES, WHICH WILL REMAIN UN-WORKED FOR A PERIOD OF MORE THAN 14-CONSECUTIVE CALENDAR DAYS. THESE MEASURES SHALL REMAIN IN PLACE UNTIL SITE HAS STABILIZED.
- 10. WASHED STONE WEEPERS OR TEMPORARY EARTH BERMS SHALL BE BUILT PER PLAN BY CONTRACTOR TO TRAP SEDIMENT OR SLOW THE VELOCITY OF STORM WATER.
- SEE DETAIL SHEETS FOR RIP-RAP SIZING. IN NO CASE WILL RIP-RAP BE SMALLER THAN 3" TO 6".
- 12. INLET FILTERS ARE TO BE PLACED IN STORMWATER INLET STRUCTURES AS SOON AS THEY ARE INSTALLED. ALL PROJECT AREA STORM INLETS NEED WISCONSIN D.O.T. TYPE D INLET PROTECTION. THE FILTERS SHALL BE MAINTAINED UNTIL THE CITY HAS ACCEPTED THE BINDER COURSE OF ASPHALT.
- 13. USE DETENTION BASINS AS SEDIMENT BASINS DURING CONSTRUCTION (DO NOT USE INFILTRATION AREAS). AT THE END OF CONSTRUCTION, REMOVE SEDIMENT AND RESTORE PER PLAN.
- 14. RESTORATION (SEED, FERTILIZE AND MULCH) SHALL BE PER SPECIFICATIONS ON THIS SHEET (NOTE: ADD SEEDING RATE STANDARD OF DETAIL BLOCK TO PLAN) UNLESS SPECIAL RESTORATION IS CALLED FOR ON THE LANDSCAPE PLAN OR THE DETENTION BASIN DETAIL SHEET.
- 15. TERRACES SHALL BE RESTORED WITH 6" TOPSOIL, PERMANENT SEED, FERTILIZER AND MULCH. LOTS SHALL BE RESTORED WITH 6" TOPSOIL, TEMPORAR' SEED, FERTILIZER AND MULCH.
- 16. AFTER DETENTION BASIN GRADING IS COMPLETE, THE BOTTOM OF DRY BASINS SHALL RECEIVE 6" TOPSOIL AND SHALL BE CHISEL-PLOWED TO A MINIMUM DEPTH OF 12" PRIOR TO RESTORATION.
- 17. SEED, FERTILIZER AND MULCH SHALL BE APPLIED WITHIN 7 DAYS AFTER FINAL GRADE HAS BEEN ESTABLISHED. IF DISTURBED AREAS WILL NOT BE RESTORED IMMEDIATELY AFTER ROUGH GRADING, TEMPORARY SEED SHALL BE PLACED.
- 18. FOR THE FIRST SIX WEEKS AFTER RESTORATION (E.G. SEED & MULCH, EROSION MAT, SOD) OF A DISTURBED AREA, INCLUDE SUMMER WATERING PROVISIONS OF ALL NEWLY SEEDED AND MULCHED AREAS WHENEVER 7 DAYS ELAPSE WITHOUT A RAIN EVENT.
- EROSION MAT (CLASS I, TYPE A URBAN PER WISCONSIN D.O.T. P.A.L.) SHALL BE INSTALLED ON ALL SLOPES 3:1 OR GREATER BUT LESS THAN 1:1.
- 20. EROSION MAT (CLASS I, TYPE B URBAN PER WISCONSIN D.O.T. P.A.L.) SHALL BE INSTALLED ON THE BOTTOM (INVERT) OF ROADSIDE DITCHES/SWALES AS SHOWN ON THIS PLAN, 1 ROLL WIDTH.
- 21. SOIL STABILIZERS SHALL BE APPLIED TO DISTURBED AREAS WITH SLOPES BETWEEN 10% AND 3:1 (DO NOT USE IN CHANNELS). SOIL STABILIZERS SHALL BE TYPE B, PER WISCONSIN D.O.T. P.A.L. (PRODUCT ACCEPTABILITY LIST), OR EQUAL. APPLY AT RATES AND METHODS SPECIFIED PER MANUFACTURER. SOIL STABILIZERS AHALL BE RE-APPLIED WHENEVERY EVELICES OR OTHER EQUIPMENT TRACK ON THE AREA.
- 22. SILT FENCE OR EROSION MAT SHALL BE INSTALLED ALONG THE CONTOURS AT 100 FOOT INTERVALS DOWN THE SLOPE ON THE DISTURBED SLOPES STEEPER THAN 5% AND MORE THAN 100 FEET LONG THAT SHEET FLOW TO THE ROADWAY UNLESS SOIL STABILIZERS ARE USED.
- 23. INSTALL MINIMUM 6'-7' WIDE EROSION MAT ALONG THE BACK OF CURB AFTER TOPSOIL HAS BEEN PLACED IN THE TERRACE IF THIS AREA WILL NOT BE SEEDED AND MULCHED WITHIN 48 HOURS OF PLACING TOPSOIL.
- 24. SILT FENCE TO BE USED ACROSS AREAS OF THE LOT THAT SLOPE TOWARDS A PUBLIC STREET OR WATERWAY. SEE DETAILS.
- 25. SEDIMENT SHALL BE CLEANED FROM CURB AND GUTTER AFTER EACH RAINFALL AND PRIOR TO PROJECT ACCEPTANCE
- 26. ACCUMULATED CONSTRUCTION SEDIMENT SHALL BE REMOVED FROM ALL PERMANENT BASINS TO THE ELEVATION SHOWN ON THE GRADING PLAN FOLLOWING THE STABILIZATION OF DRAINAGE AREAS.
- 27. ALL CONSTRUCTION ENTRANCES SHALL HAVE TEMPORARY ROAD CLOSED SIGNS THAT WILL BE IN PLACE WHEN THE ENTRANCE IS NOT IN USE AND AT THE END OF EACH DAY.
- 28. ANY PROPOSED CHANGES TO THE EROSION CONTROL PLAN MUST BE SUBMITTED AND APPROVED BY DANE COUNTY LAND CONSERVATION OR PERMITTING MUNICIPALITY.
- 29. THE CITY, OWNER AND/OR ENGINEER MAY REQUIRE ADDITIONAL EROSION CONTROL MEASURES AT ANY TIME DURING CONSTRUCTION.

CONSTRUCTION SEQUENCE:

- 1. INSTALL SILT FENCE AND TRACKING PAD
- 2. STRIP TOPSOIL-DETENTION BASINS
- 3. ROUGH GRADE DETENTION BASINS
- 5. STRIP TOPSOIL-STREETS & LOTS. 6. ROUGH GRADE STREETS & LOTS

- 8. CONSTRUCT UNDERGROUND UTILITIES 9. INSTALL INLET PROTECTION
- 10. CONSTRUCT ROADS (STONE BASE CURB & GUTTER, AND SIDEWALK). REMOVE DRIVE-OVER VELOCITY CHECKS WHEN BASE COURSE IS PLACED
- 11. RESTORE TERRACES
- 12. REMOVE TRACKING PAD, SILT FENCE AND DIVERSION BERM MEASURES AFTER DISTURBED AREAS ARE RESTORED

SEEDING RATES:

1. USE ANNUAL OATS AT 3.0 LB./1,000 S.F. FOR SPRING AND SUMMER PLANTINGS. SUMMER FLANINGS. 2. USE WINTER WHEAT OR RYE AT 3.0 LB./1,000 SF FOR FALL PLANTINGS STARTED AFTER SEPTEMBER 15.


PERMANENT: 1. USE WISCONSIN D.O.T. SEED MIX #40 AT 2 LB./1,000 S.F.

FERTILIZING RATES:

TEMPORARY AND PERMANENT: USE WISCONSIN D.O.T. TYPE A OR B AT 7 LB./1,000 S.F. MULCHING RATES:

TEMPORARY AND PERMANENT:
USE ½° TO 1-½° STRAW OR HAY MULCH, CRIMPED PER
SECTION 607.32.3, OR OTHER RATE AND METHOD PER SECTION
627, MISCONSIN DO.1. STANDARD SPECIFICATIONS FOR
HIGHWAY AND STRUCTURE CONSTRUCTION

- MOUNTABLE BERM 6" MIN. HEIGHT (OPTIONAL) __ EXISTING PAVEMENT 50' MINIMUM LENGTH 5.7 EARTH FILL PAD OF 3" CLEAR STONE OVER FULL LENGTH AND WIDTH OF STRUCTURE PIPE AS NECESSARY SEE NOTE 6

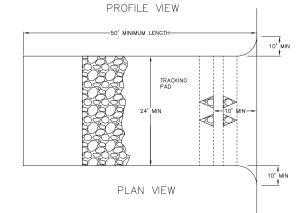

STEEL OR WOOD POST FENCE SUPPORT MESH (OPTIONAL)
SEE NOTE 4 -BACKFILLED AND COMPACTED SOIL

NOTES:

- INSTALL SILT FENCE TO FOLLOW THE GROUND CONTOURS AS CLOSELY AS POSSIBLE.
- CURVE THE SILT FENCE UP THE SLOPE TO PREVENT WATER FROM RUNNING AROUND THE ENDS.
- POST SPACING WITH FENCE SUPPORT MESH = 10 FT. (MAX.)
- POST SPACING WITHOUT FENCE SUPPORT MESH = 6 FT. (MAX.)
- 4. SILT FENCE SUPPORT MESH CONSISTS OF 14—GAUGE STEEL WIRE WITH A MESH SPACING OF 6 IN. X 6 IN. OR PREFABRICATED POLYMERIC MESH OF EQUIVALENT STRENGTH




- 1. FOLLOW WISCONSIN DNR TECHNICAL STANDARD 1057 FOR FURTHER DETAILS AND INSTALLATION.
- 2. LENGTH MINIMUM OF 50'
- 4. ON SITES WITH A HIGH GROUND WATER TABLE OR WHERE SATURATED CONDITIONS EXIST, GEOTEXTILE FABRIC SHALL BE PLACED OVER EXISTING GROUND PRIOR TO PLACING STONE. FABRIC SHALL BE WISDOT TYPE—HR GEOTEXTILE FABRIC.
- 5. STONE CRUSHED 3" CLEAR STONE SHALL BE PLACED AT LEAST 12" DEEP OVER THE ENTIRE LENGTH AND WIDTH OF ENTRANCE

6. SURFACE WATER — ALL SURFACE WATER FLOWING TO OR DIVERTED TOWARDS CONSTRUCTION ENTRANCES SHALL BE PIPED THROUGH THE ENTRANCE. MAINTAINING POSITIVE DRAINAGE. PIPE INSTALLED THROUGH THE STABILIZED CONSTRUCTION ENTRANCE SHALL BE PROTECTED WITH A MOUNTABLE BERM WITH 5:1 SLOPES AND MINIMIUM OF 6" STONE OVER THE PIPE. PIPE SHALL BE SIZED ACCORDING TO THE DRAINAGE REQUIREMENTS. WHEN THE ENTRANCE IS LOCATED AT A HIGH SPOT AND HAS NO DRAINAGE TO CONVEY A PIPE SHALL NOT BE NECESSARY. THE MINIMUM PIPE DIAMETER SHALL BE 6". CONTRACTOR SHALL BE RESPONSIBLE FOR THE MAINTENANCE OF SAID PIPE.

7. LOCATION - A STABILIZED CONSTRUCTION ENTRANCE SHALL BE LOCATED WHERE CONSTRUCTION TRAFFIC ENTERS AND/OR LEAVES THE CONSTRUCTION SITE. VEHICLES LEAVING THE SITE MUST TRAVEL OVER THE ENTIRE LENGTH OF THE TRACKING PAD.



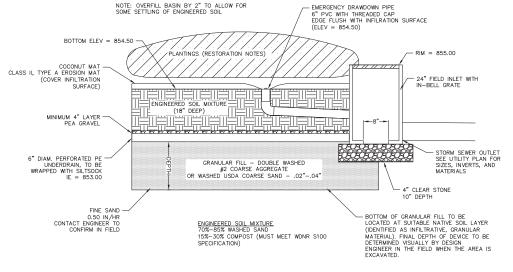

BIO-RETENTION AREA RESTORATION SPECIFICATIONS:
NOTE: BIO-RETENTION AREA MUST NOT BE CONSTRUCTED (INSTALLED) UNTIL THE SITE IS STABILIZED, I.E. THE GRASS COVER IS WELL ESTABILISHED.

 $\ensuremath{\mathsf{BIO}}\xspace-\mathsf{RETENTION}$ area must conform to wisconsin DNR technical standard 1004 (Bioretention for infiltration)

USE RAINWATER GARDEN LIVE NATIVE PLANT PLUGS FROM AGRECOL (SUNNY, SHORT, OR MEDIUM STATURE) — OR ENGINEER APPROVED EQUAL.

PLANT PLUGS AT 1 PER SQUARE FOOT.

BIO-RETENTION BASIN

PLANTING, MULCH, AND MAINTENANCE NOTES:
PLANTING SHOULD TAKE PLACE BETWEEN AVAILABILITY OF PLANTS IN SPRING AND JUNE
30TH, OR BETWEEN SEPTEMBER 1ST AND OCTOBER 15TH. IF PLANTED JULY 1ST
THROUGH AUGUST 31ST, HEAVILY WATER THE PLANTS AT THE TIME THEY ARE PLANTED,
AND EVERY DYHER DAY FOR A TOTAL OF 4 WATERINGS. A RAIN EVENT OFFER THAN
0.5 INCHES CONSTITUTES A WATERING, IF PLANTED SEPTEMBER 1ST THROUGH OCTOBER
15TH, PLACE CERTIFIED WEED-FREE STRAW MULCH AT 3" MINIMUM THICKNESS BETWEEN
PLANTS TO HELP PREVENT FROST HEAVE. IF PLANTING IS TO OCCUR AFTER OCTOBER
15TH, IT ALS THE PLANTING AND THE PLANTING IS TO OCCUR AFTER OCTOBER
15TH, IT ALS THE PLANTING AND THE PLANTING IS TO OCCUR AFTER OCTOBER
15TH, IT ALS THE PLANTING AND THE PLANTING OF THE PLANTING TO THE PLANTING AND THE PLANTIN 15TH, IT MUST BE POSTPONED UNTIL THE FOLLOWING SPRING (MAY). FOR THE FIRST 3 YEARS AFTER PLANTING, SPOT TREAT THE AREA WITH HERBICIDE TO REMOVE WEEDS.

- RESTORATION OF THE INFILITRATION AREA (NOT INCLUDING SIDE SLOPES):

 1. OVER-EXCAVATE THE AREA TO INFILITRATIVE LAYER TO BE DETERMINED IN THE FIELD, DURING EXCAVATION, BY DESIGN ENGINEER.


 2. CHISEL PLOW, OR ROTO—TILL THE BASE OF THE AREA TO BREAK UP ANY HARDPAN IN THE NATIVE SOIL LAYER.

 3. PLACE WASHED SAND (FREE OF P200 PARTICLES) TO 46 INCHES BELOW GROUND SURFACE (F. REQUIRED SKIDNEERED SOIL, COMPRISED OF:

 4. PLACE JOSE MASHED SAND THE WORD SIDE OF:

 15—302 COMPRISED SIDE OF THE STAND SIDE OF SIDE OF

- 15-30% COMPOST (MUST MEET WDNR S100 SPECIFICATION 5. PLANT PLUG, MULCH, WATER, AND MAINTAIN AS DIRECTED ABOVE.

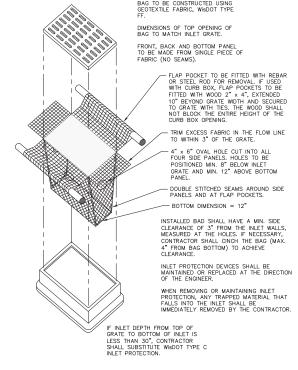

INLET PROTECTION TYPE D


Construction Carenzie Place

her


Vierbich

Ŷ. AS SHOWN 7/21/15

OJECT NO. 150109.00

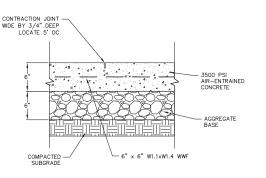


CONCRETE PAD

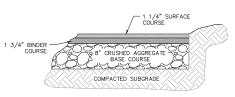


BITUMINOUS PAVEMENT PARKING LOT


SITE PAVEMENT NOT TO SCALE

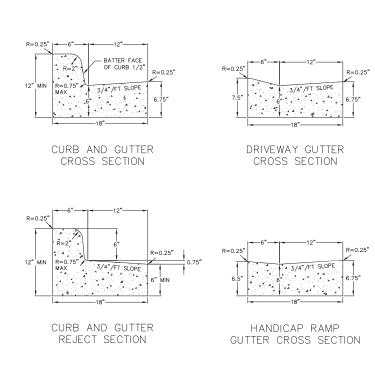





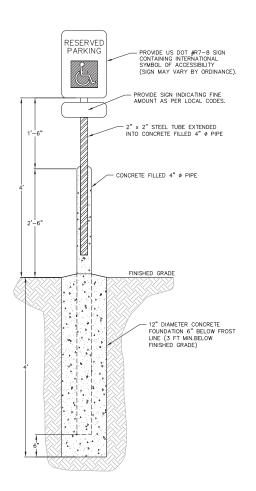



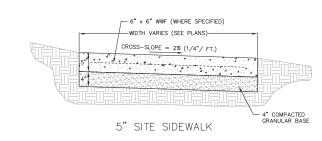

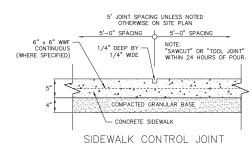

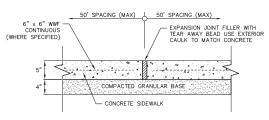

SIDEWALK EXPANSION JOINT




- 1. ALL SIGNS SHALL BE FABRICATED AND INSTALLED IN ACCORDANCE WITH THE MANUAL ON UNIFORM TRAFFIC CONTROL DEVICES.

 2. SIGNS SHALL BE A DISTANCE OF 7' FROM GROUND LEVEL TO THE BOTTOM OF THE SIGN MOUNTED ON THE POST AND LOCATED 3' BEHIND THE BACK OF CURB.

 3. STREET NAME SIGNS SHALL HAVE WHITE LETTERS AND GREEN BACKGROUND.

 4. SIGN POSTS SHALL BE 2—3/8" O., GALVANIZED 10 FT LLONG, 13 GAUGE, AND 0.095 WALL THICKNESS. MOUNT SIGN AT TOP OF THE POST, AND INSTALL POSTS 3' DEEP AND MIX 1/2 BAG OF 80 LB SAKRETE CONCRETE, POURING IT AROUND THE POST BELOW THE GROUND BEFORE COVERING WITH 8" OF TOPSOIL.

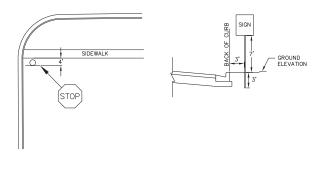

STOP SIGN NOT TO SCALE

Construction Details
McKenzie Place
City of Madison
Dane County, Wasser

Vierbicher planners | advisors





Construction Details
McKenzie Place
City of Madison

AS SHOWN

7/21/15


ROJECT NO. 150109.00

GENERAL NOTES


RAMPS SHALL BE BUILT AT 12:1 OR FLATTER.
WHEN NECESSARY, THE SIDEWALK ELEVATION
MAY BE LOWERED TO MEET THE HIGH POINT

THE RAMP SHALL BE BORDERED ON BOTH SIDES AND ON THE CURB LINE WITH A 4 INCH WIDE YELLOW STRIPE OR WITH BRICK OF A CONTRASTING COLOR. NORMALLY THE PAINT STRIPE ALTERNATE WILL BE USED. THE CONTRACTOR WILL APPLY THIS STRIPING UNLESS OTHERWISE SPECIFIED IN THE CONTRACT.

IF THE OWNER REQUIRES THE BRICK ALTERNATE. SPECIAL DETAILS AND PROVISIONS ARE SHOWN ELSEWHERE IN THE PLANS.

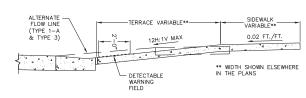

SECTION B-B

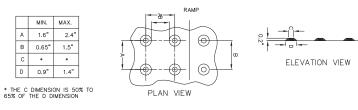

10:1 SLOPE (MAX)

CONCRETE RAMP WITH

2'x4' DETECTABLE WARNING FIELD

—4" WIDE, PAINTED WHITE STRIPE

PLAN VIEW

DETECTABLE WARNING FIELD (TYPICAL)

NOTE: MATERIALS AND METHOD OF CONSTRUCTION FOR TRUNCATED DOMES SHALL BE SPECIFIED IN SPECIAL PROVISIONS OR AS REQUIRED BY THE CITY ENGINEER

TRUNCATED DOMES DETECTABLE WARNING

PATTERN DETAIL

X 10: 1 MAX

10:1 SLOPE (MAX)

MIN. MAX. 1.6" 2.4" 0.65" 1.5"


0.9" 1.4"

RAMP PLAN VIEW


15'-0"


RAMP PROFILE VIEW


SITE HANDICAP RAMP NOT TO SCALE

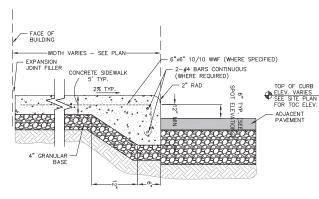

CURBED SIDEWALK DETAIL

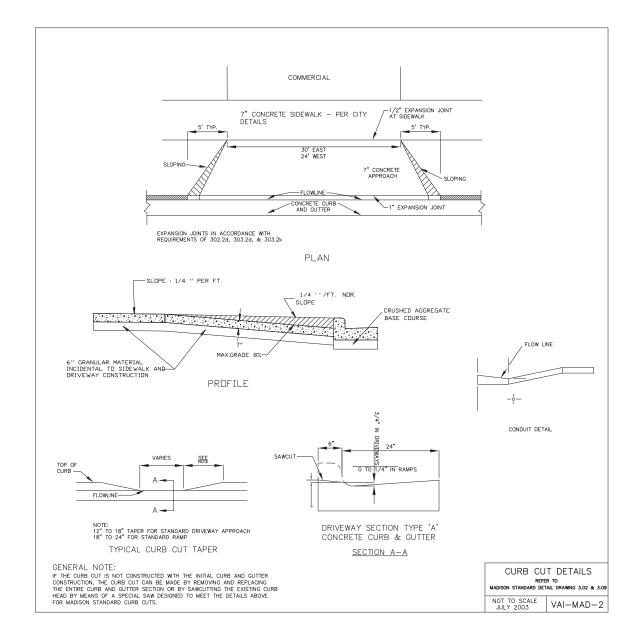

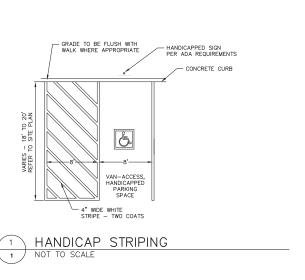


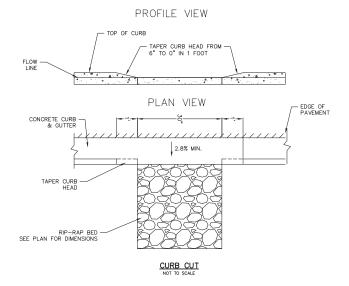

1 CURB CUT

STANDARD TRENCH SECTION


DRY TRENCH CONDITION

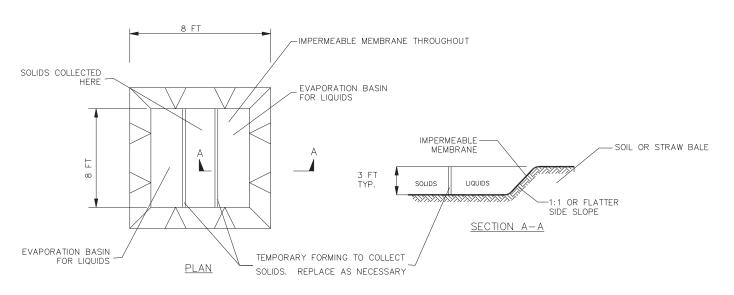



EXCAVATED WASHOUT STRUCTURE

CONSTRUCTION SPECIFICATIONS


- 1.LOCATE WASHOUT STRUCTURE A MINIMUM OF 50 FEET AWAY FROM OPEN CHANNELS, STORM DRAIN INLETS, SENSITIVE AREAS, WETLANDS, BUFFERS AND WATER COURSES AND AWAY FROM CONSTRUCTION TRAFFIC.
- 2.PREPARE SOIL BASE FREE OF ROCKS OR OTHER DEBRIS THAT MAY CAUSE TEARS OR HOLES IN THE LINER. FOR LINER, USE 10 MIL OR THICKER UV RESISTANT, IMPERMEABLE SHEETING, FREE OF HOLES AND TEARS OR OTHER DEFECTS THAT COMPROMISE IMPERMEABILITY OF THE MATERIAL.
- 3.KEEP CONCRETE WASHOUT STRUCTURE WATER TIGHT. REPLACE IMPERMEABLE LINER IF DAMAGED (E.G., RIPPED OR PUNCTURED). EMPTY OR REPLACE WASHOUT STRUCTURE THAT IS 75 PERCENT FULL, AND DISPOSE OF ACCUMULATED MATERIAL PROPERLY. DO NOT REUSE PLASTIC LINER. WET-VACUUM STORED LIQUIDS THAT HAVE NOT EVAPORATED AND DISPOSE OF IN AN APPROVED MANNER. REMOVE HARDENED SOLIDS, WHOLE OR BROKEN UP, FOR DISPOSAL OR RECYCLING. MAINTAIN RUNOFF DIVERSION AROUND EXCAVATED WASHOUT STRUCTURE UNTIL STRUCTURE IS REMOVED.

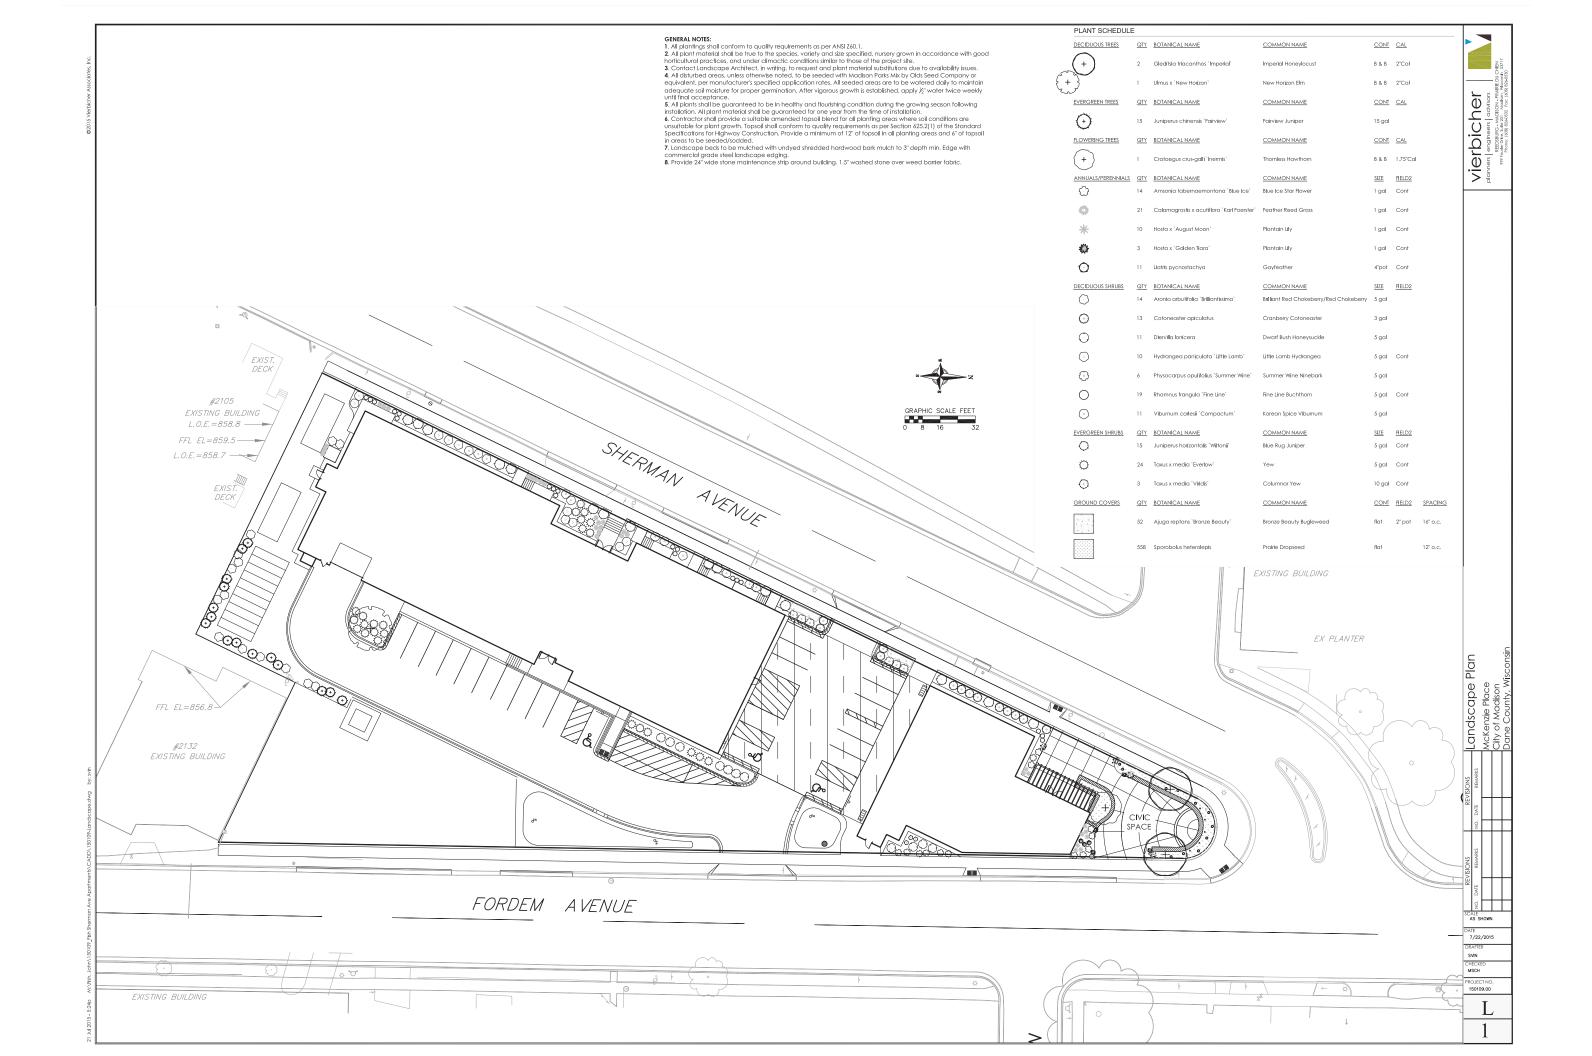

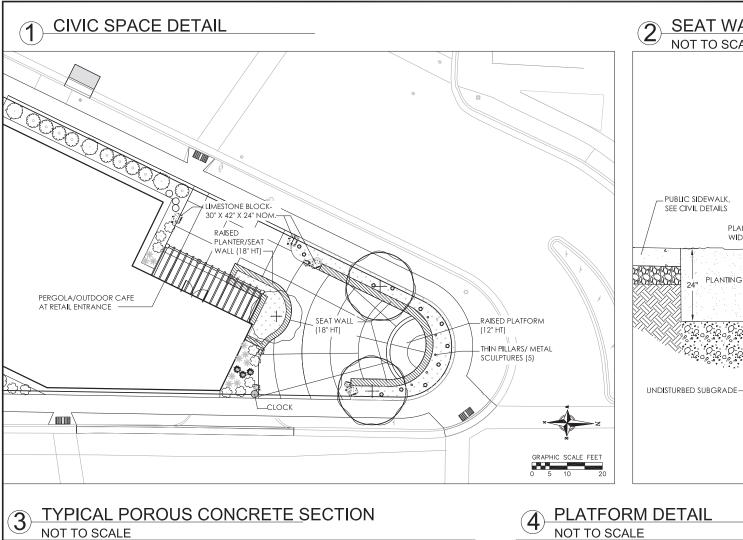

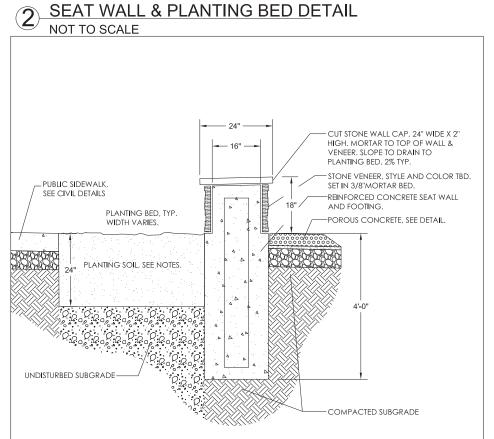

,—CHOKER COURSE AASHTO #57 (1") CLEAN WASHED STONE -RESERVOIR COURSE 1.5-2.5" WASHED STONE – existing subgrade (uncompacted)

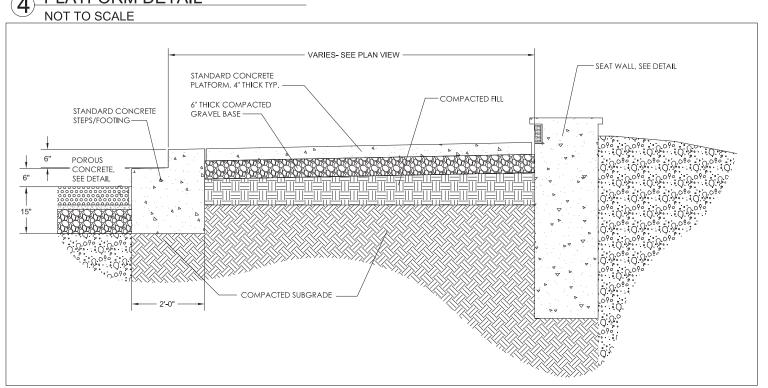

Details TE 7/22/2015

> L 2

Vierbicher