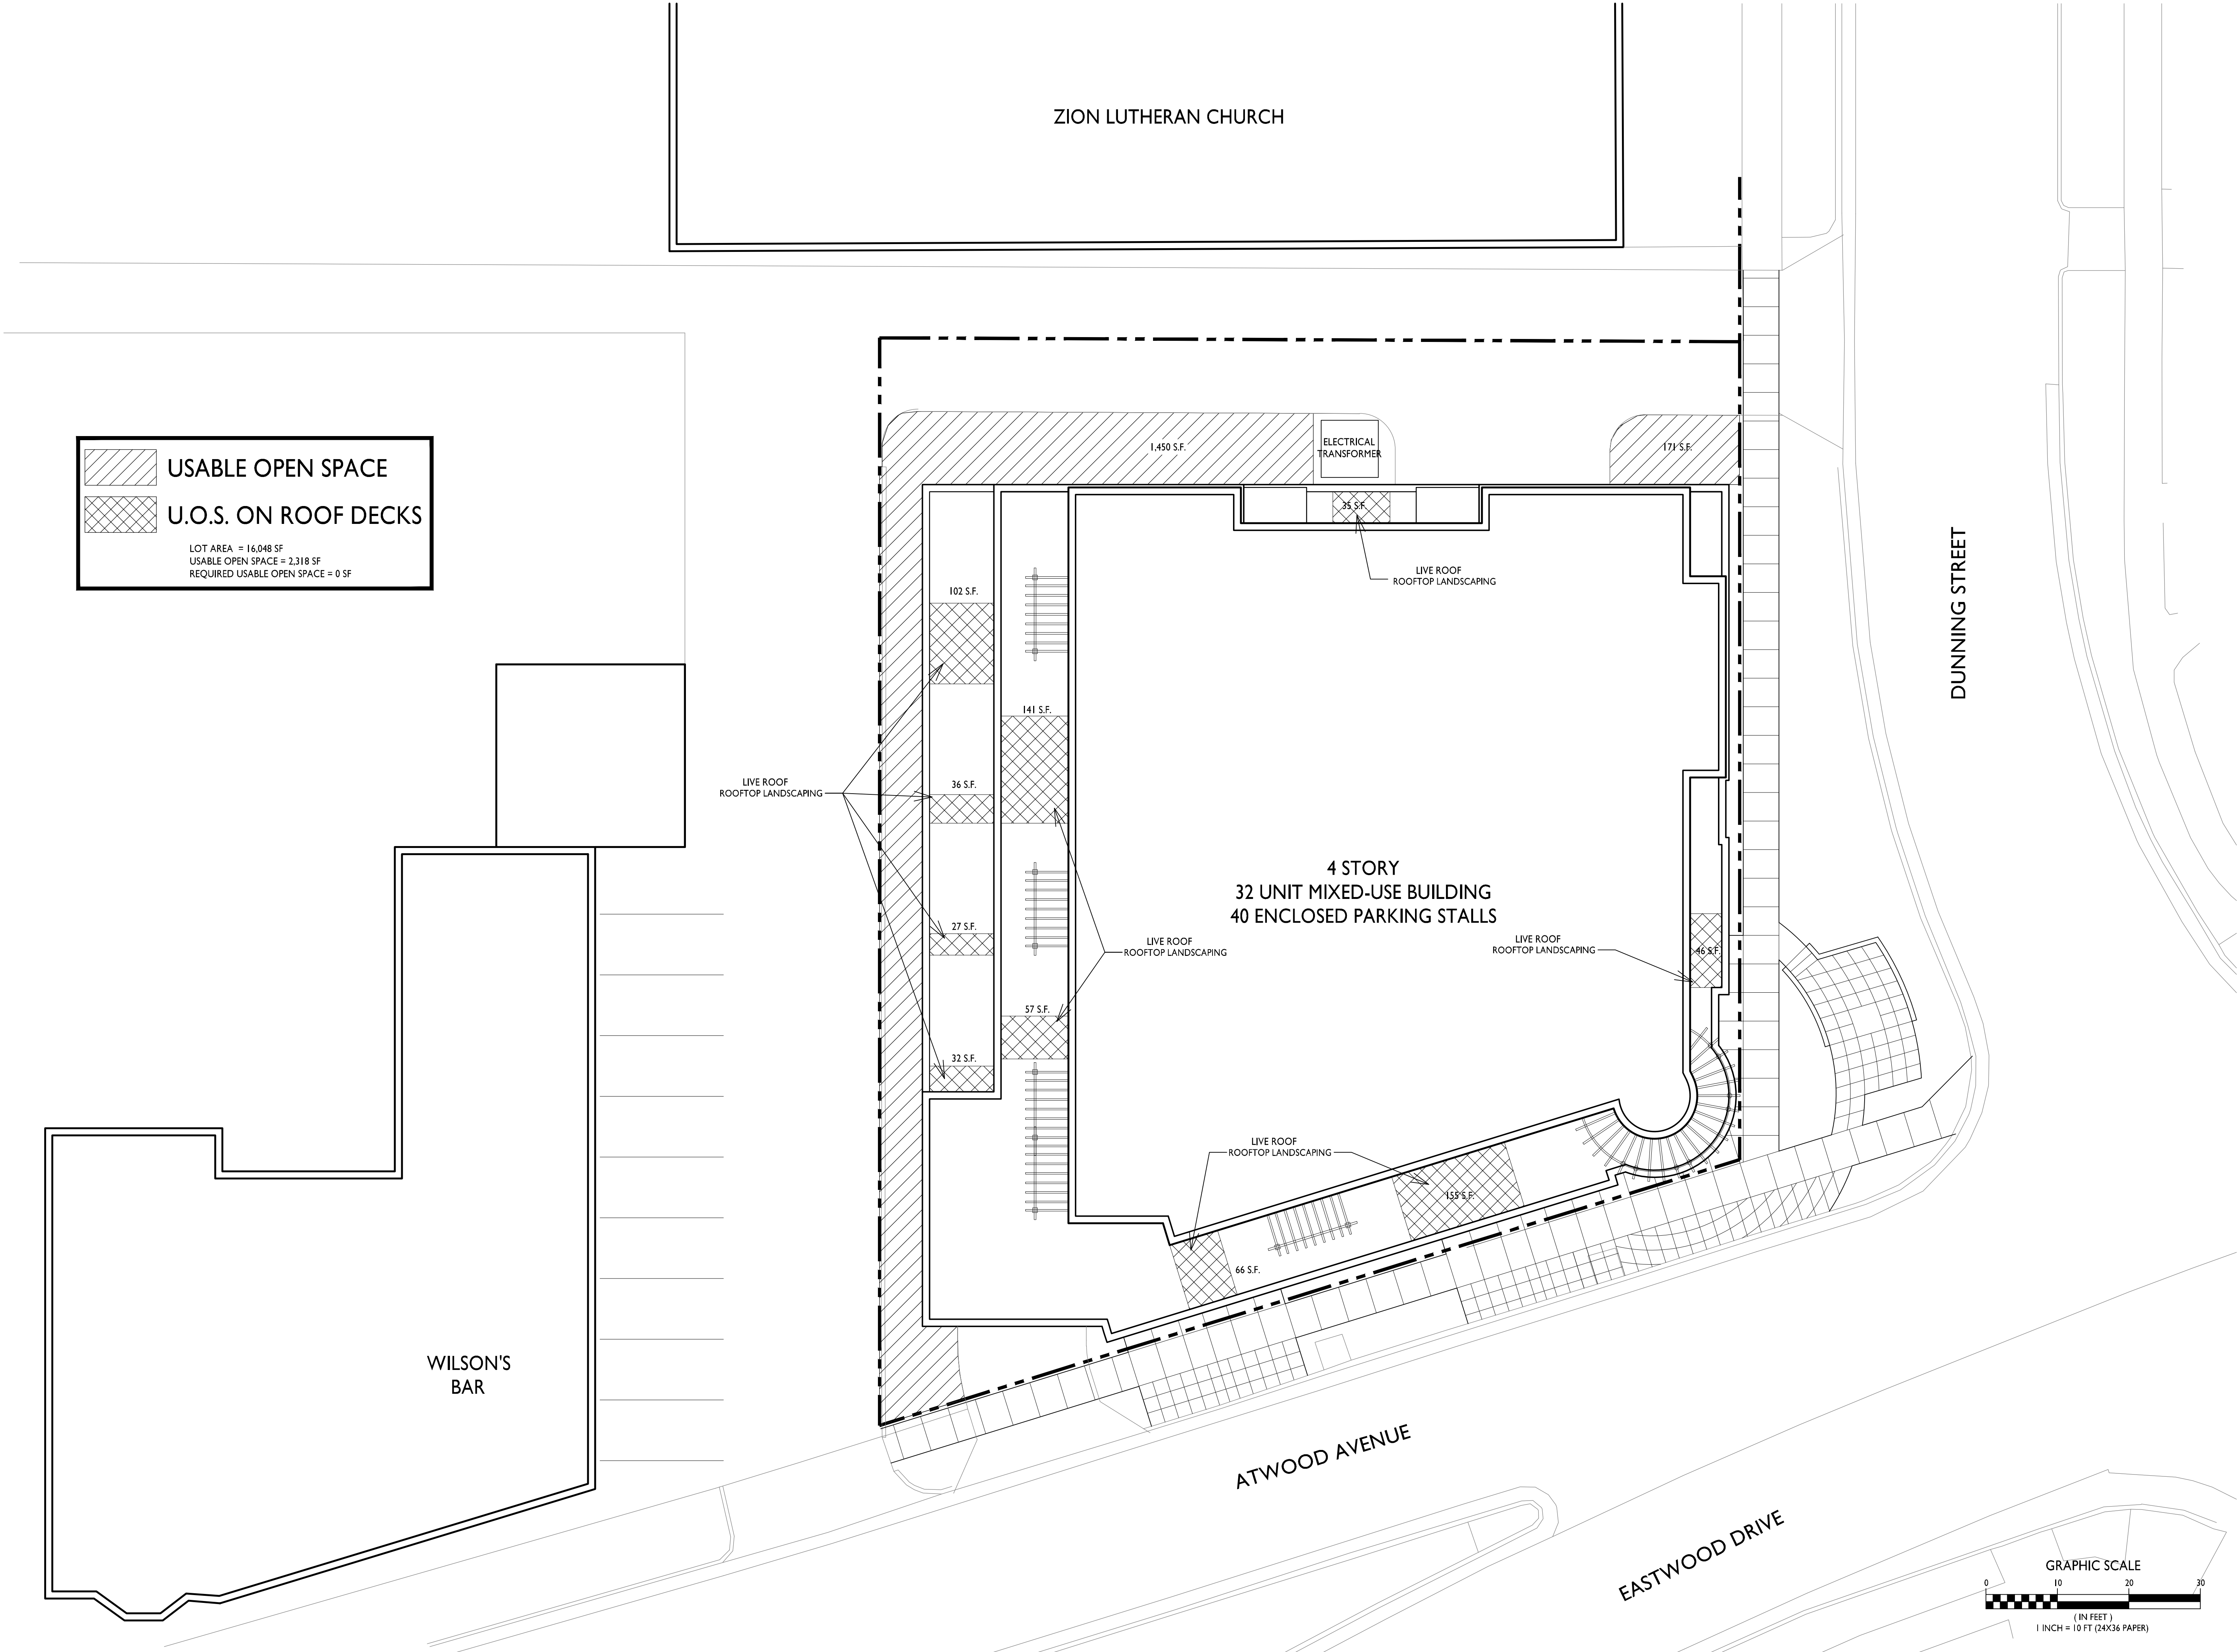


ISSUED
Issued for Review - June 25, 2014
Revised - July 28, 2014

PROJECT TITLE
**KRUPP
ATWOOD
DEVELOPMENT**

2158 Atwood Ave
SHEET TITLE
**Roof Plan &
Usable Open
Space**

SHEET NUMBER
C-1.2
PROJECT NO. **1359**
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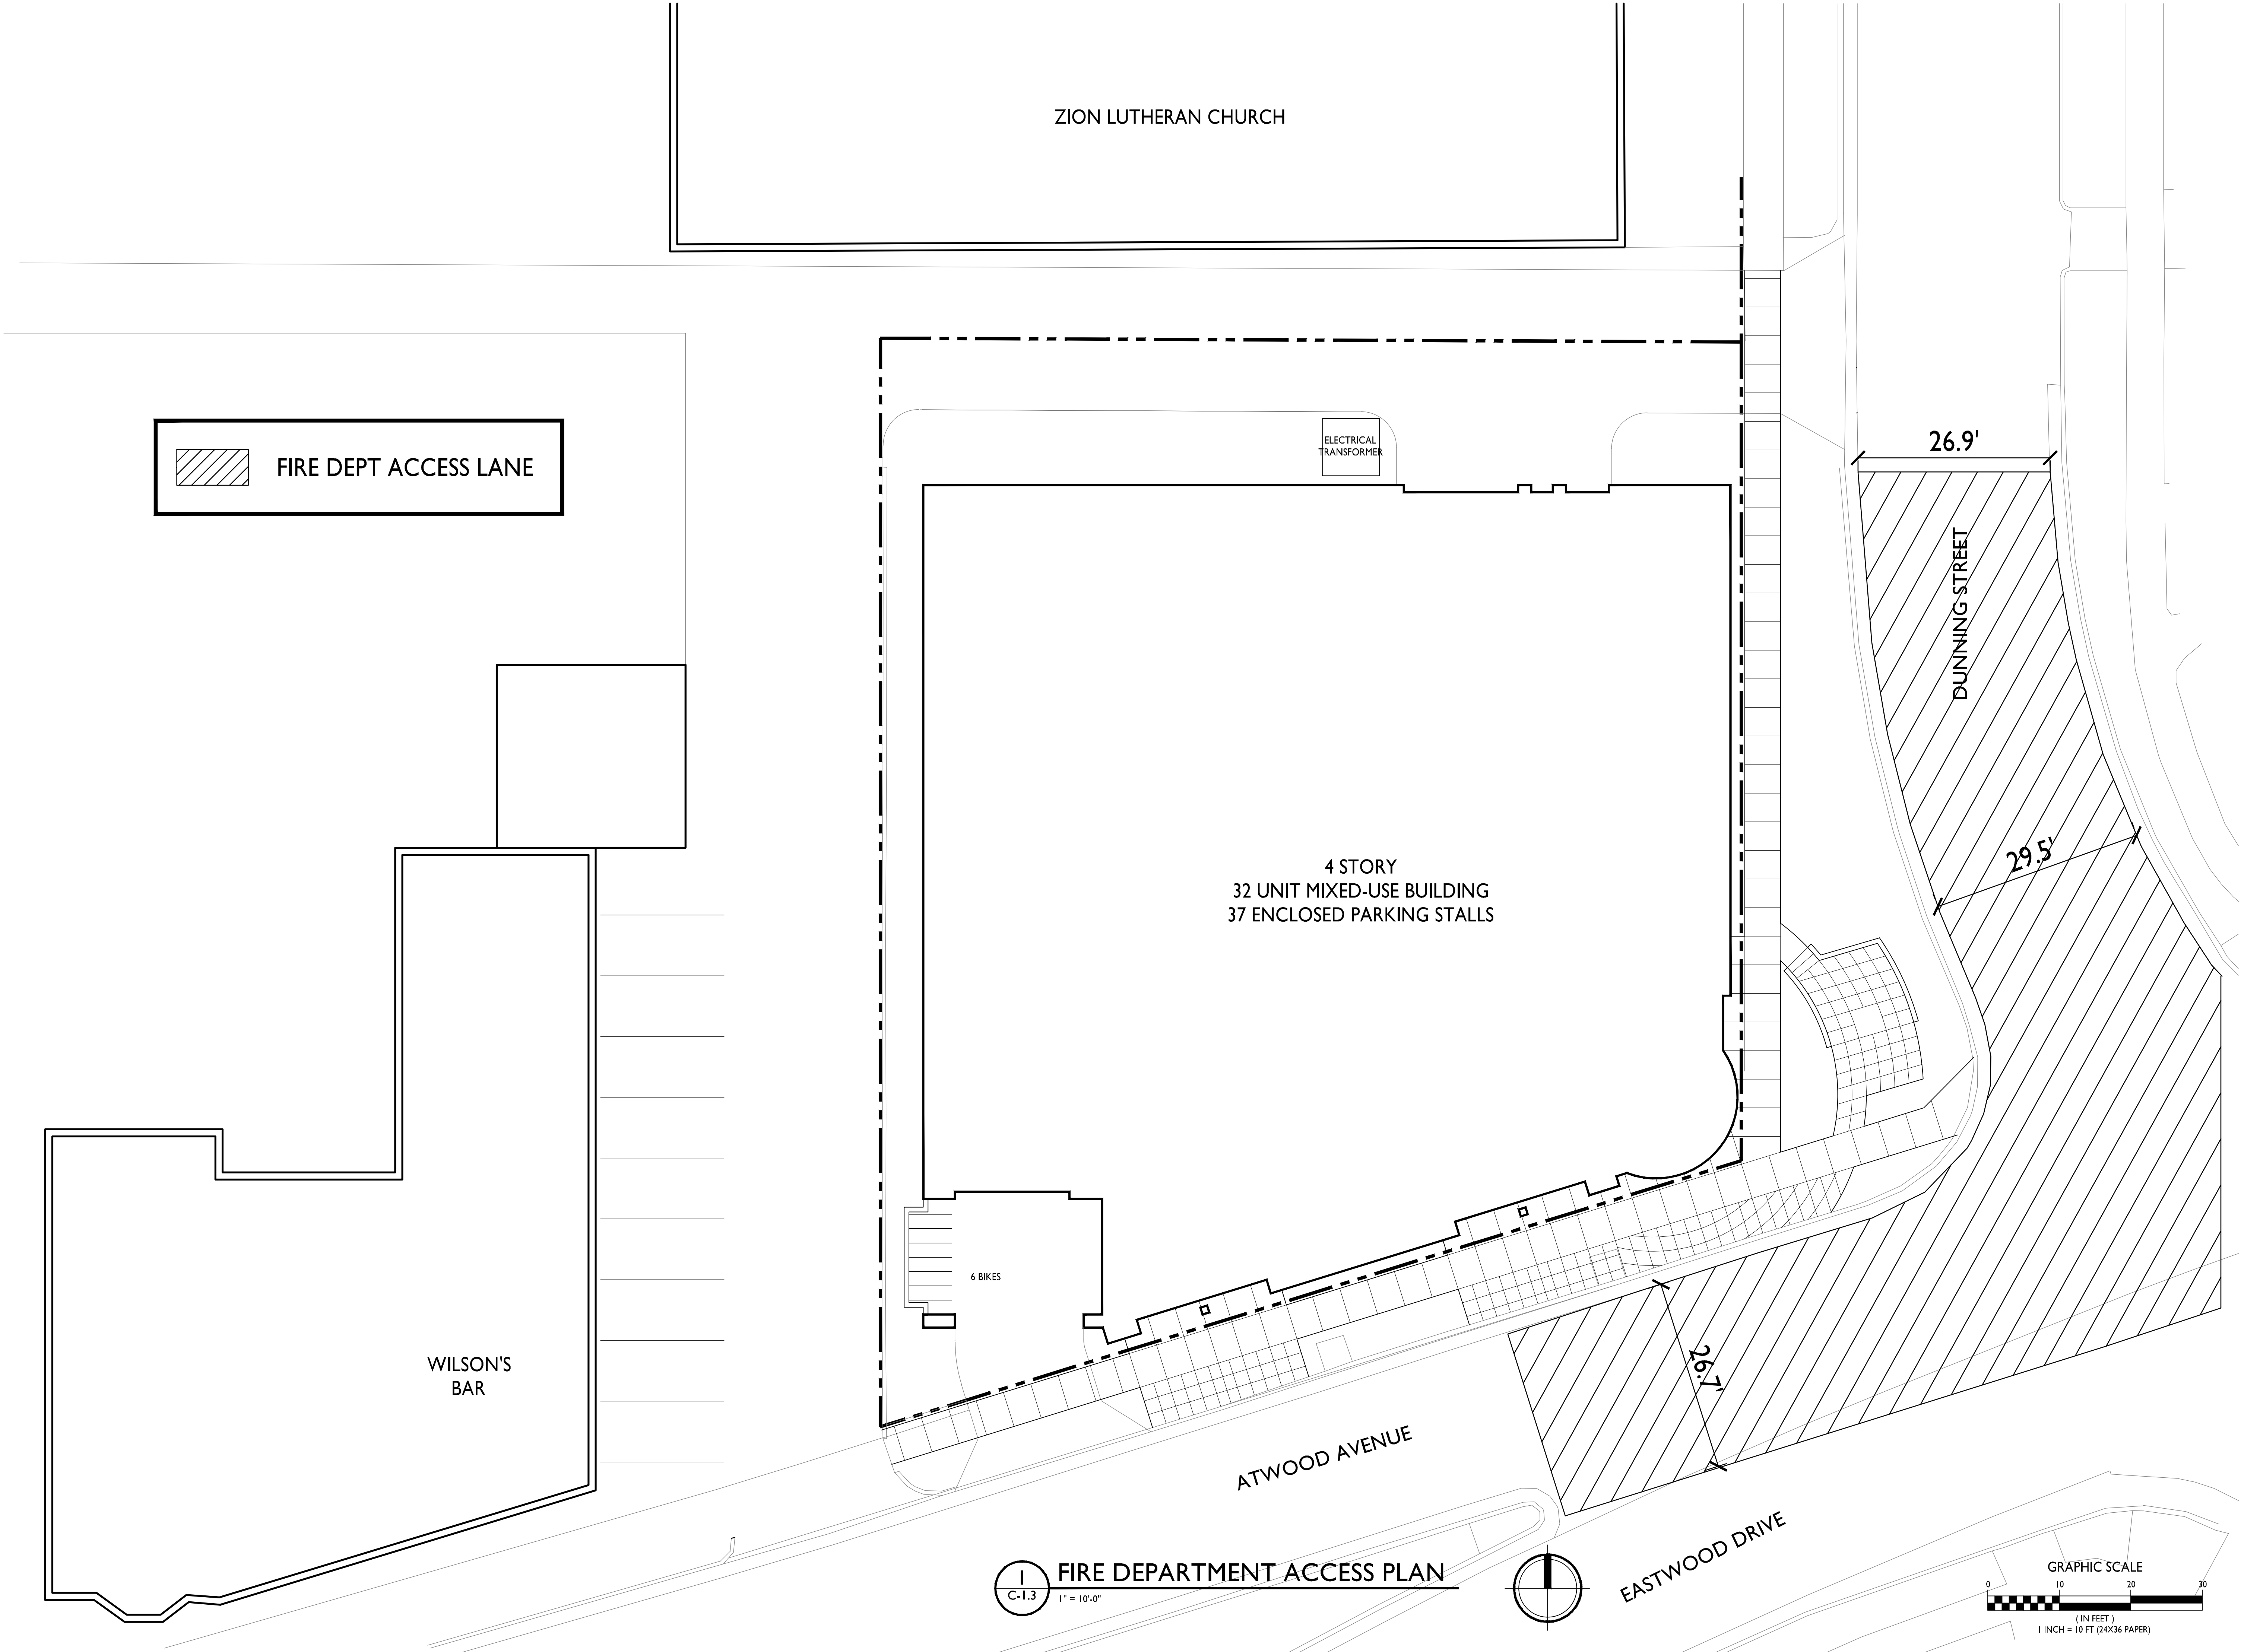
ISSUED
Issued for Review - June 25, 2014
Revised - July 28, 2014

PROJECT TITLE
**KRUPP
ATWOOD
DEVELOPMENT**

2158 Atwood Ave
SHEET TITLE
**Fire Department
Access Plan**

SHEET NUMBER

C-1.3
PROJECT NO. 1359
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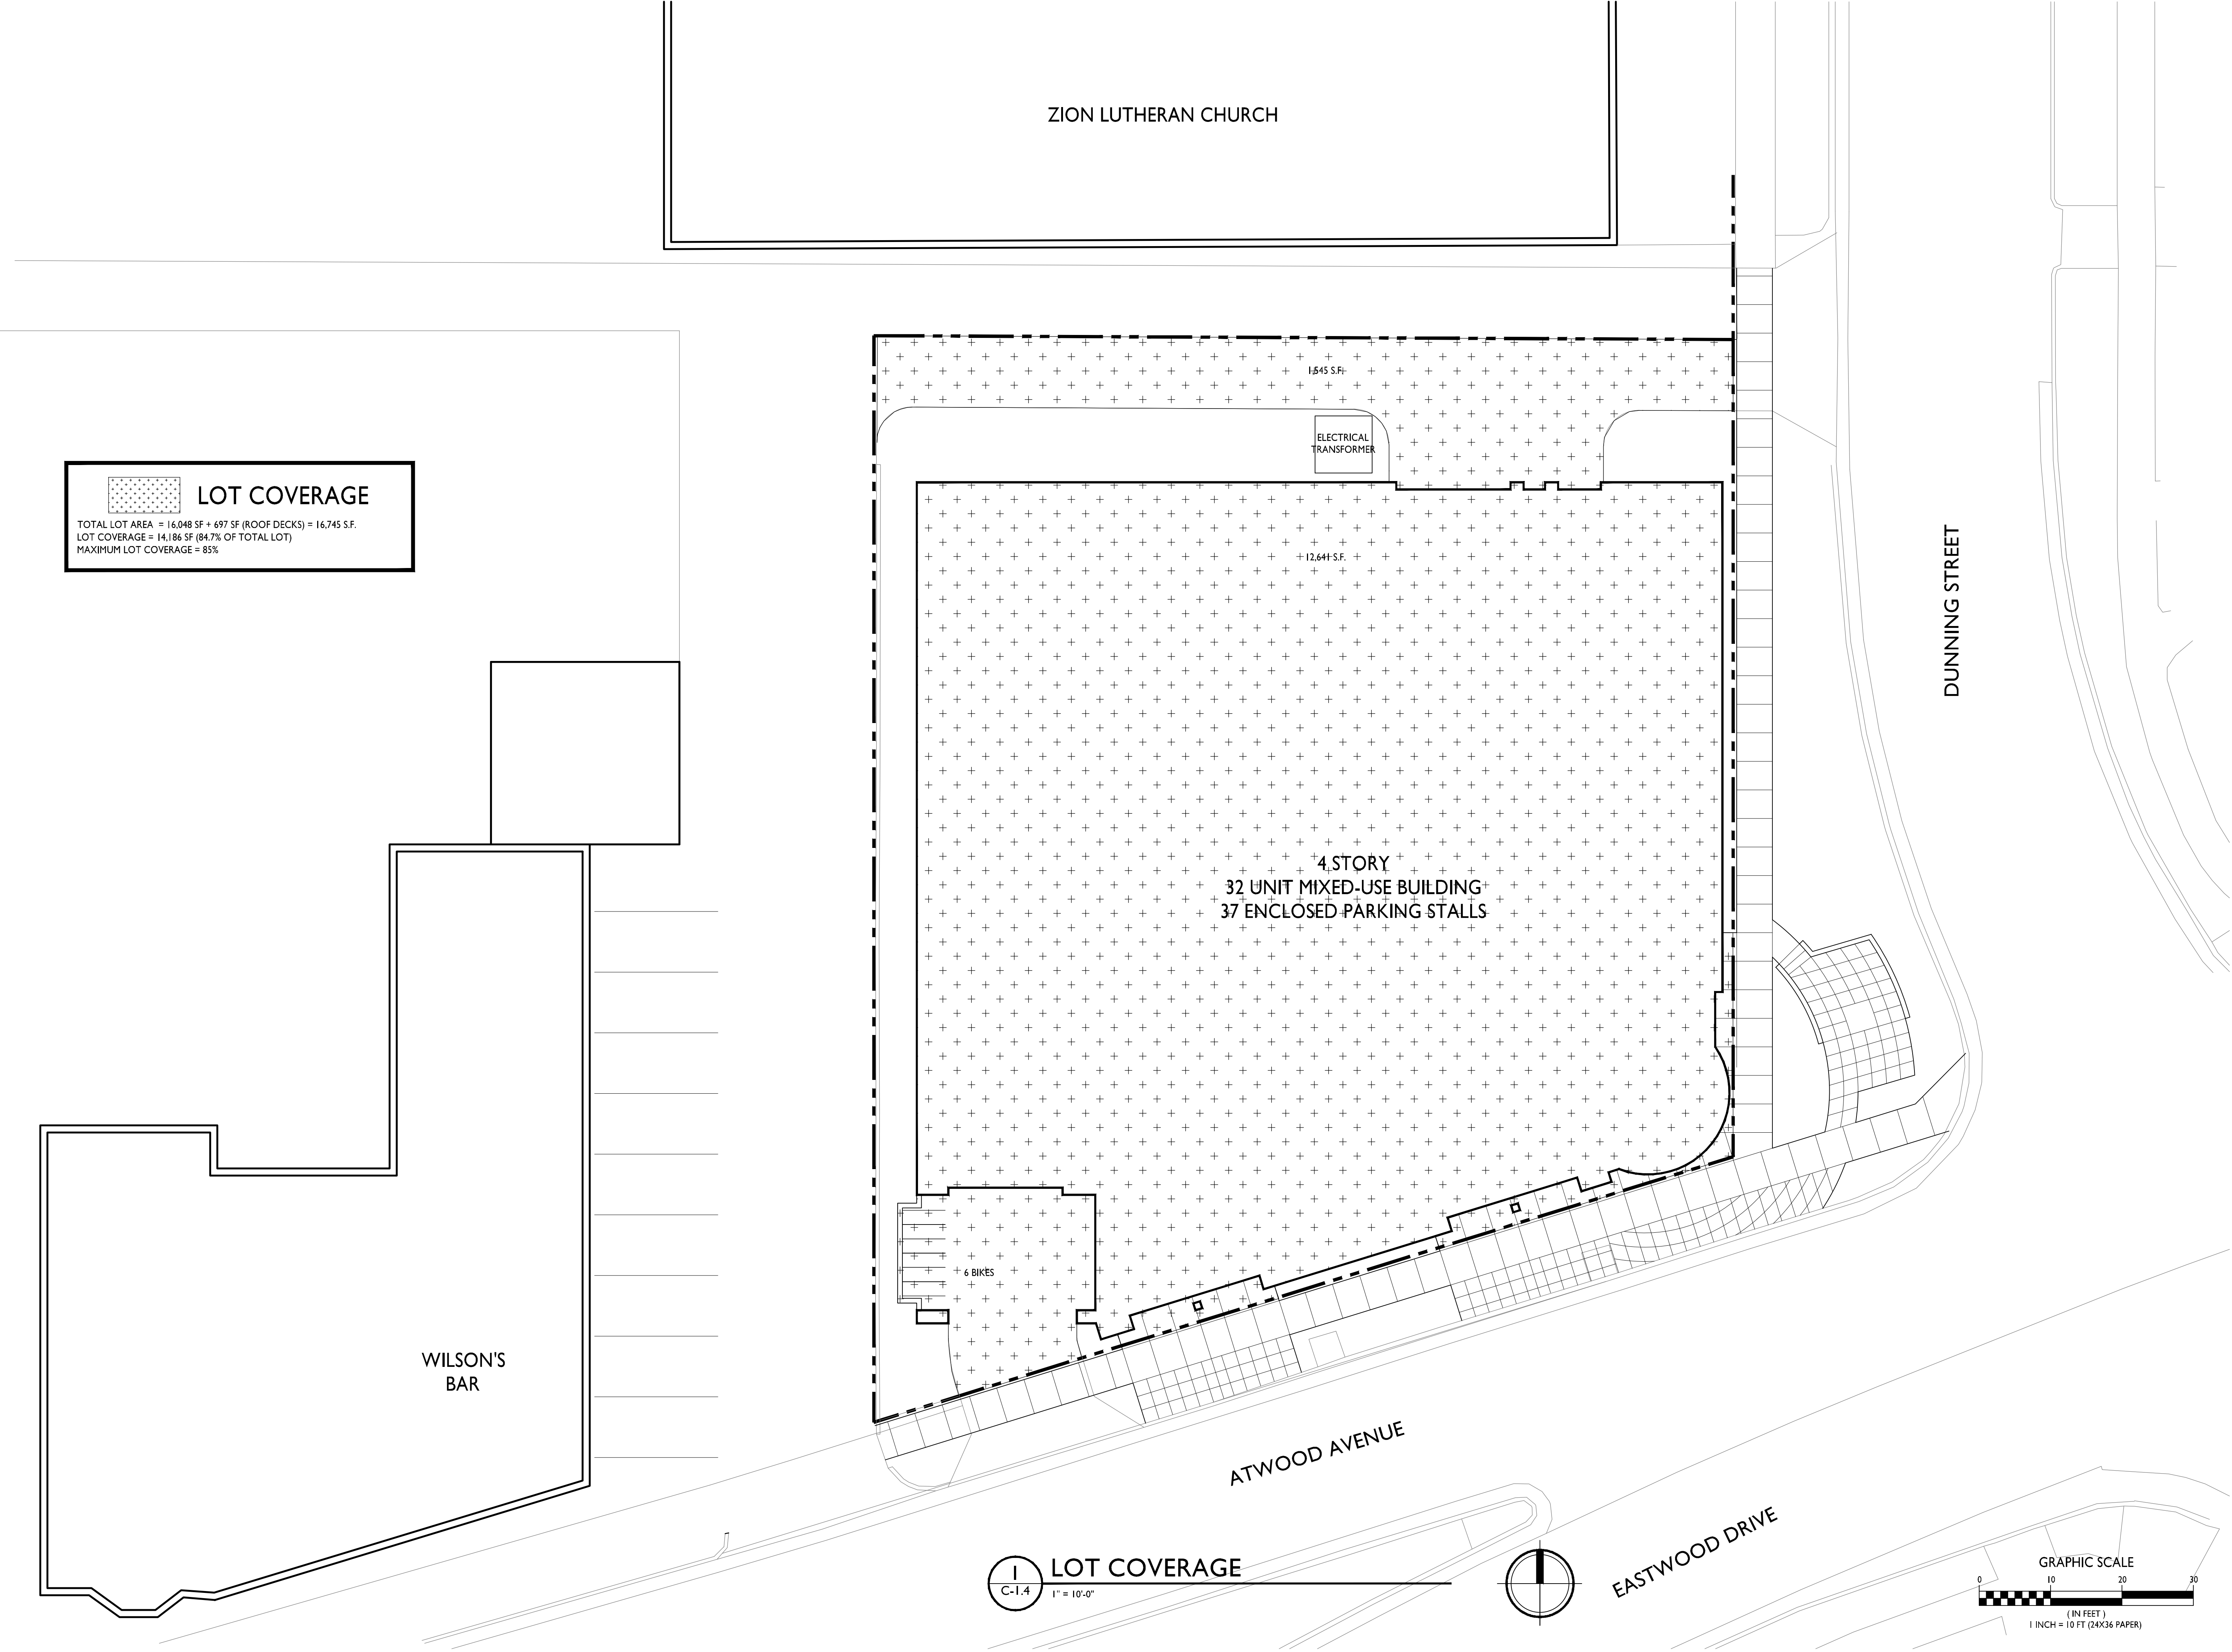
ISSUED
Issued for Review - June 25, 2014
Revised - July 28, 2014

PROJECT TITLE
KRUPP
ATWOOD
DEVELOPMENT


2158 Atwood Ave
SHEET TITLE
Lot Coverage Plan

SHEET NUMBER


C-1.4
PROJECT NO. 1359
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ALL OF LOTS 7, 8 AND 9, BLOCK 5, FAIR OAKS, AS RECORDED IN VOLUME 2 OF PLATS, ON PAGE 37, AS DOCUMENT NUMBER 243077, DANE COUNTY REGISTRY, LOCATED IN THE SOUTHEAST QUARTER OF THE SOUTHEAST QUARTER OF SECTION 06, TOWNSHIP 07 NORTH, RANGE 10 EAST, CITY OF MADISON, DANE COUNTY, WISCONSIN.



NUMBER	RM/TC	INVERT ELEV.	INVERT ELEV.	INVERT ELEV.	INVERT ELEV.
MH01	865.88	E IE: 851.60	N IE: 851.76	W IE: 851.50	
MH02	866.10	FLOOR: 859.60	FULL OF WATER: NO PIPES VISIBLE		
MH03	866.31	E IE: 851.45	S IE: 851.76	W IE: 851.41	
INL04	866.92	E IE: 863.42	W IE: 863.42		
MH05	866.66	E IE: 863.41	W IE: 863.28	N IE: 861.41	S IE: 861.38
INL06	866.76	E IE: 863.75			
MH07	866.84	NE IE: 860.49	N IE: 859.66	S IE: 859.34	
MH08	860.72	W IE: 850.21	N IE: 850.57	E IE: 850.31	S IE: 852.92
MH09	873.51	N IE: 865.09	S IE: 864.89		
MH10	872.78	FLOOR: 860.50	S IE: 862.04		
MH11	866.05	UNABLE TO OPEN			
INL12	866.28	FABRIC BARRIER, NOT ABLE TO MEASURE			
INL13	865.76	W IE: 861.91	E IE: 862.06		

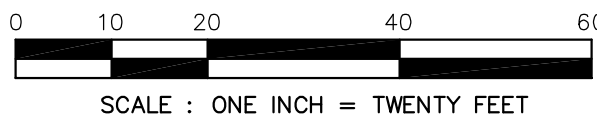

- LEGEND**
- SOLID IRON ROD FOUND SIZE NOTED
 - IRON PIPE FOUND OUTSIDE DIAMETER NOTED
 - SET "X" IN CONCRETE
 - FOUND DRILL HOLE
 - FOUND RAILROAD SPIKE
 - SET MAG NAIL
 - OVERHEAD UTILITY WIRE
 - BURIED GAS LINE
 - WATER MAIN
 - SANITARY SEWER
 - STORM SEWER
 - BURIED TELEPHONE
 - BURIED ELECTRIC
 - BURIED FIBER OPTIC
 - GAS VALVE
 - GAS METER
 - ELECTRIC PEDESTAL
 - UTILITY POLE
 - TRAFFIC SIGNAL
 - LIGHT POLE
 - TELEPHONE PEDESTAL
 - FIRE HYDRANT
 - SIGN
 - GUY WIRE
 - BOLLARD
 - STORM SEWER INLET
 - ELECTRIC MANHOLE
 - FIBER OPTIC MANHOLE
 - EXISTING CONTOUR MAJOR
 - EXISTING CONTOUR MINOR
 - STORM SEWER MANHOLE
 - STORM SEWER STRUCTURE
 - RECTANGLE CATCH BASIN
 - SANITARY SEWER MANHOLE
 - DECIDUOUS TREE
 - CONIFEROUS TREE
 - INDICATES RECORDED AS
- DISTANCES ARE MEASURED TO THE NEAREST HUNDRETH OF A FOOT. BUILDINGS ARE MEASURED TO THE NEAREST TENTH OF A FOOT.

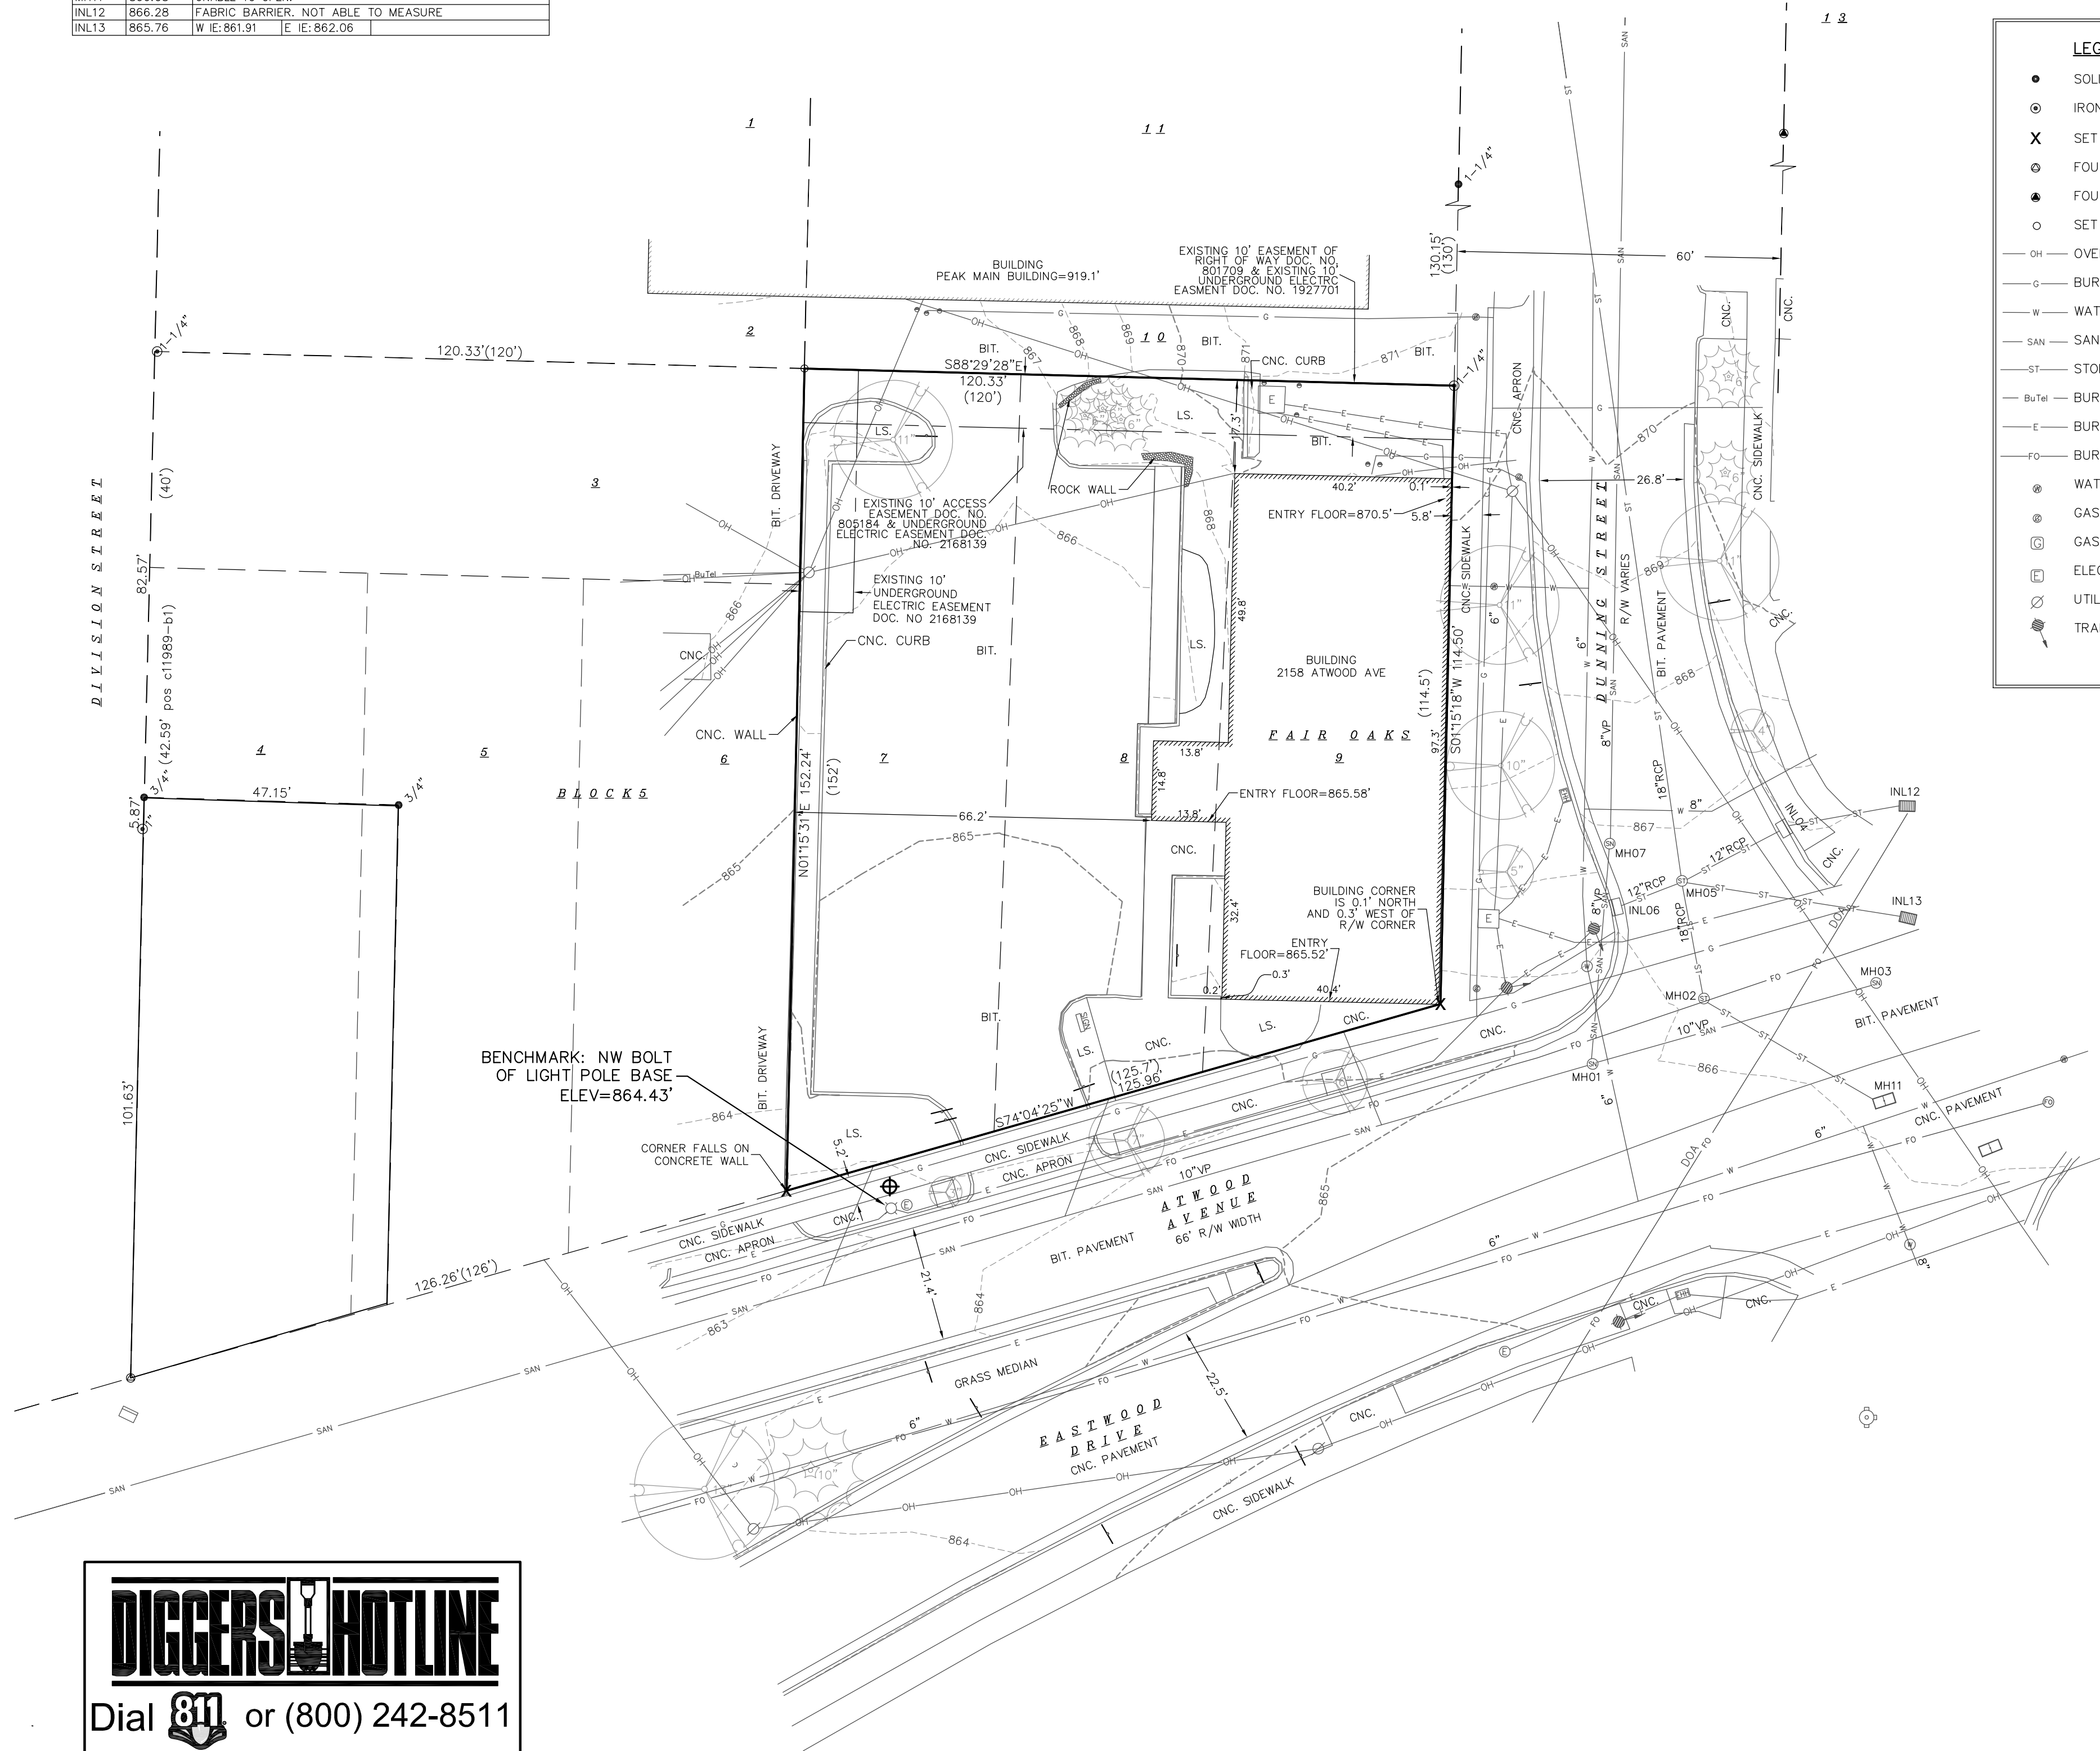- NOTES:**
- Except as specifically stated or shown on this map, this survey does not purport to reflect any of the following which may be applicable to the subject real estate: easements; building setback lines; restrictive covenants; subdivision restrictions; zoning or other land use regulations; and any other facts that an accurate and current title search may disclose.
 - No attempt has been made as a part of this survey to obtain or show data concerning condition or capacity of any utility or municipal/public service facility. For information regarding these utilities or facilities, please contact the appropriate agencies.
 - Date of field work: 05-16-2014
 - Surveyor has made no investigation or independent search for easements of record, encumbrances, restrictive covenants, ownership title evidence, or any other facts that an accurate and current title search may disclose.
 - All surface and subsurface improvements on and adjacent to the site are not necessarily shown hereon.
 - All trees, hedges and ground cover on the site may not necessarily be shown hereon.
 - Routing of public utilities is based upon drawings obtained from the City of Madison Engineering Department, markings provided by Digger's Hotline Ticket Numbers 20141818264, 20141818288, 20141818316, 20141818341, 20141922669 and visible above ground structures. Additional buried utilities/structures may be encountered. No excavations were made to located utilities. Before excavations are performed contact Digger's Hotline.
 - Total parcel area = 16,049 square feet
 - Elevations are based upon NAVD88 datum. The brass cap monument at the Southwest corner of Section 06 has an elevation of 852.169' based upon benchmark on tiesheet by Carl M. Sandnes, dated 2-16-04.
 - Site Benchmark is the NW bolt of the light pole base west of driveway off Atwood. Elevation = 864.43

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Fax: 608-250-9266
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APPROVALS	PROJECT ENG.	MLB	DESIGNED BY	PDF	SEAL	PDF	CHECKED BY	MLB	APPROVED	MLB
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2158 Atwood Avenue
2158 Atwood Avenue
Madison, WI 53704
Joe Krupp
2020 Eastwood Drive
Madison, WI 53704

PROJECT #: BSE1732-14
PLOT DATE: 06/24/2014
REVISION DATES:
ISSUE DATES:
06/24/2014


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C-100



DEMOLITION NOTES:


- COORDINATE EXISTING UTILITY REMOVAL WITH LOCAL AUTHORITIES AND UTILITY COMPANIES HAVING JURISDICTION. ALL PRIVATE UTILITIES (GAS, ELECTRIC, AND TELECOMMUNICATIONS) SERVING EXISTING BUILDINGS SCHEDULED FOR DEMOLITION TO BE ABANDONED OR REMOVED BY CORRESPONDING UTILITY COMPANY.
- ALL SAWCUTTING SHALL BE FULL DEPTH TO PROVIDE A CLEAN EDGE TO MATCH NEW CONSTRUCTION. MATCH EXISTING ELEVATIONS AT POINTS OF CONNECTION FOR NEW AND EXISTING PAVEMENT, CURB, SIDEWALKS, ETC. ALL SAWCUT LOCATIONS SHOWN ARE APPROXIMATE AND MAY BE FIELD ADJUSTED TO ACCOMMODATE CONDITIONS, JOINTS, MATERIAL TYPE, ETC. REMOVE MINIMUM AMOUNT NECESSARY FOR INSTALLATION OF PROPOSED IMPROVEMENTS.
- CONTRACTOR SHALL PROVIDE AND SHALL BE RESPONSIBLE FOR ANY NECESSARY TRAFFIC CONTROL AND SAFETY MEASURES DURING DEMOLITION AND CONSTRUCTION OPERATIONS WITHIN OR NEAR THE PUBLIC ROADWAY.
- IT IS THE CONTRACTOR'S RESPONSIBILITY TO VERIFY THE LOCATION OF UNDERGROUND UTILITIES. UTILITIES WERE LOCATED BY OBSERVED EVIDENCE, MARKINGS PROVIDED BY DIGGER'S HOTLINE, AND RECORD DRAWINGS FROM THE CITY OF MADISON.
- CONTRACTOR SHALL INSTALL TREE PROTECTION FENCING IN THE AREA BETWEEN THE CURB AND SIDEWALK AND EXTEND IT AT LEAST 5 FEET FROM BOTH SIDES OF THE TREE ALONG THE LENGTH OF THE TERRACE.
- NO EXCAVATION IS PERMITTED WITHIN 5 FEET OF THE OUTSIDE EDGE OF A TREE TRUNK. IF EXCAVATION WITH 5 FEET OF ANY TREE IS NECESSARY, CONTRACTOR SHALL CONTACT CITY FORESTRY (266-4816) PRIOR TO EXCAVATION TO ASSESS THE IMPACT TO THE TREE AND ROOT SYSTEM
- TREE PRUNING SHALL BE COORDINATED WITH CITY FORESTRY.
- TREE PROTECTION SPECIFICATIONS CAN BE FOUND IN SECTION 107.13 OF THE CITY OF MADISON STANDARD SPECIFICATIONS FOR PUBLIC WORKS CONSTRUCTION.

GENERAL NOTES:

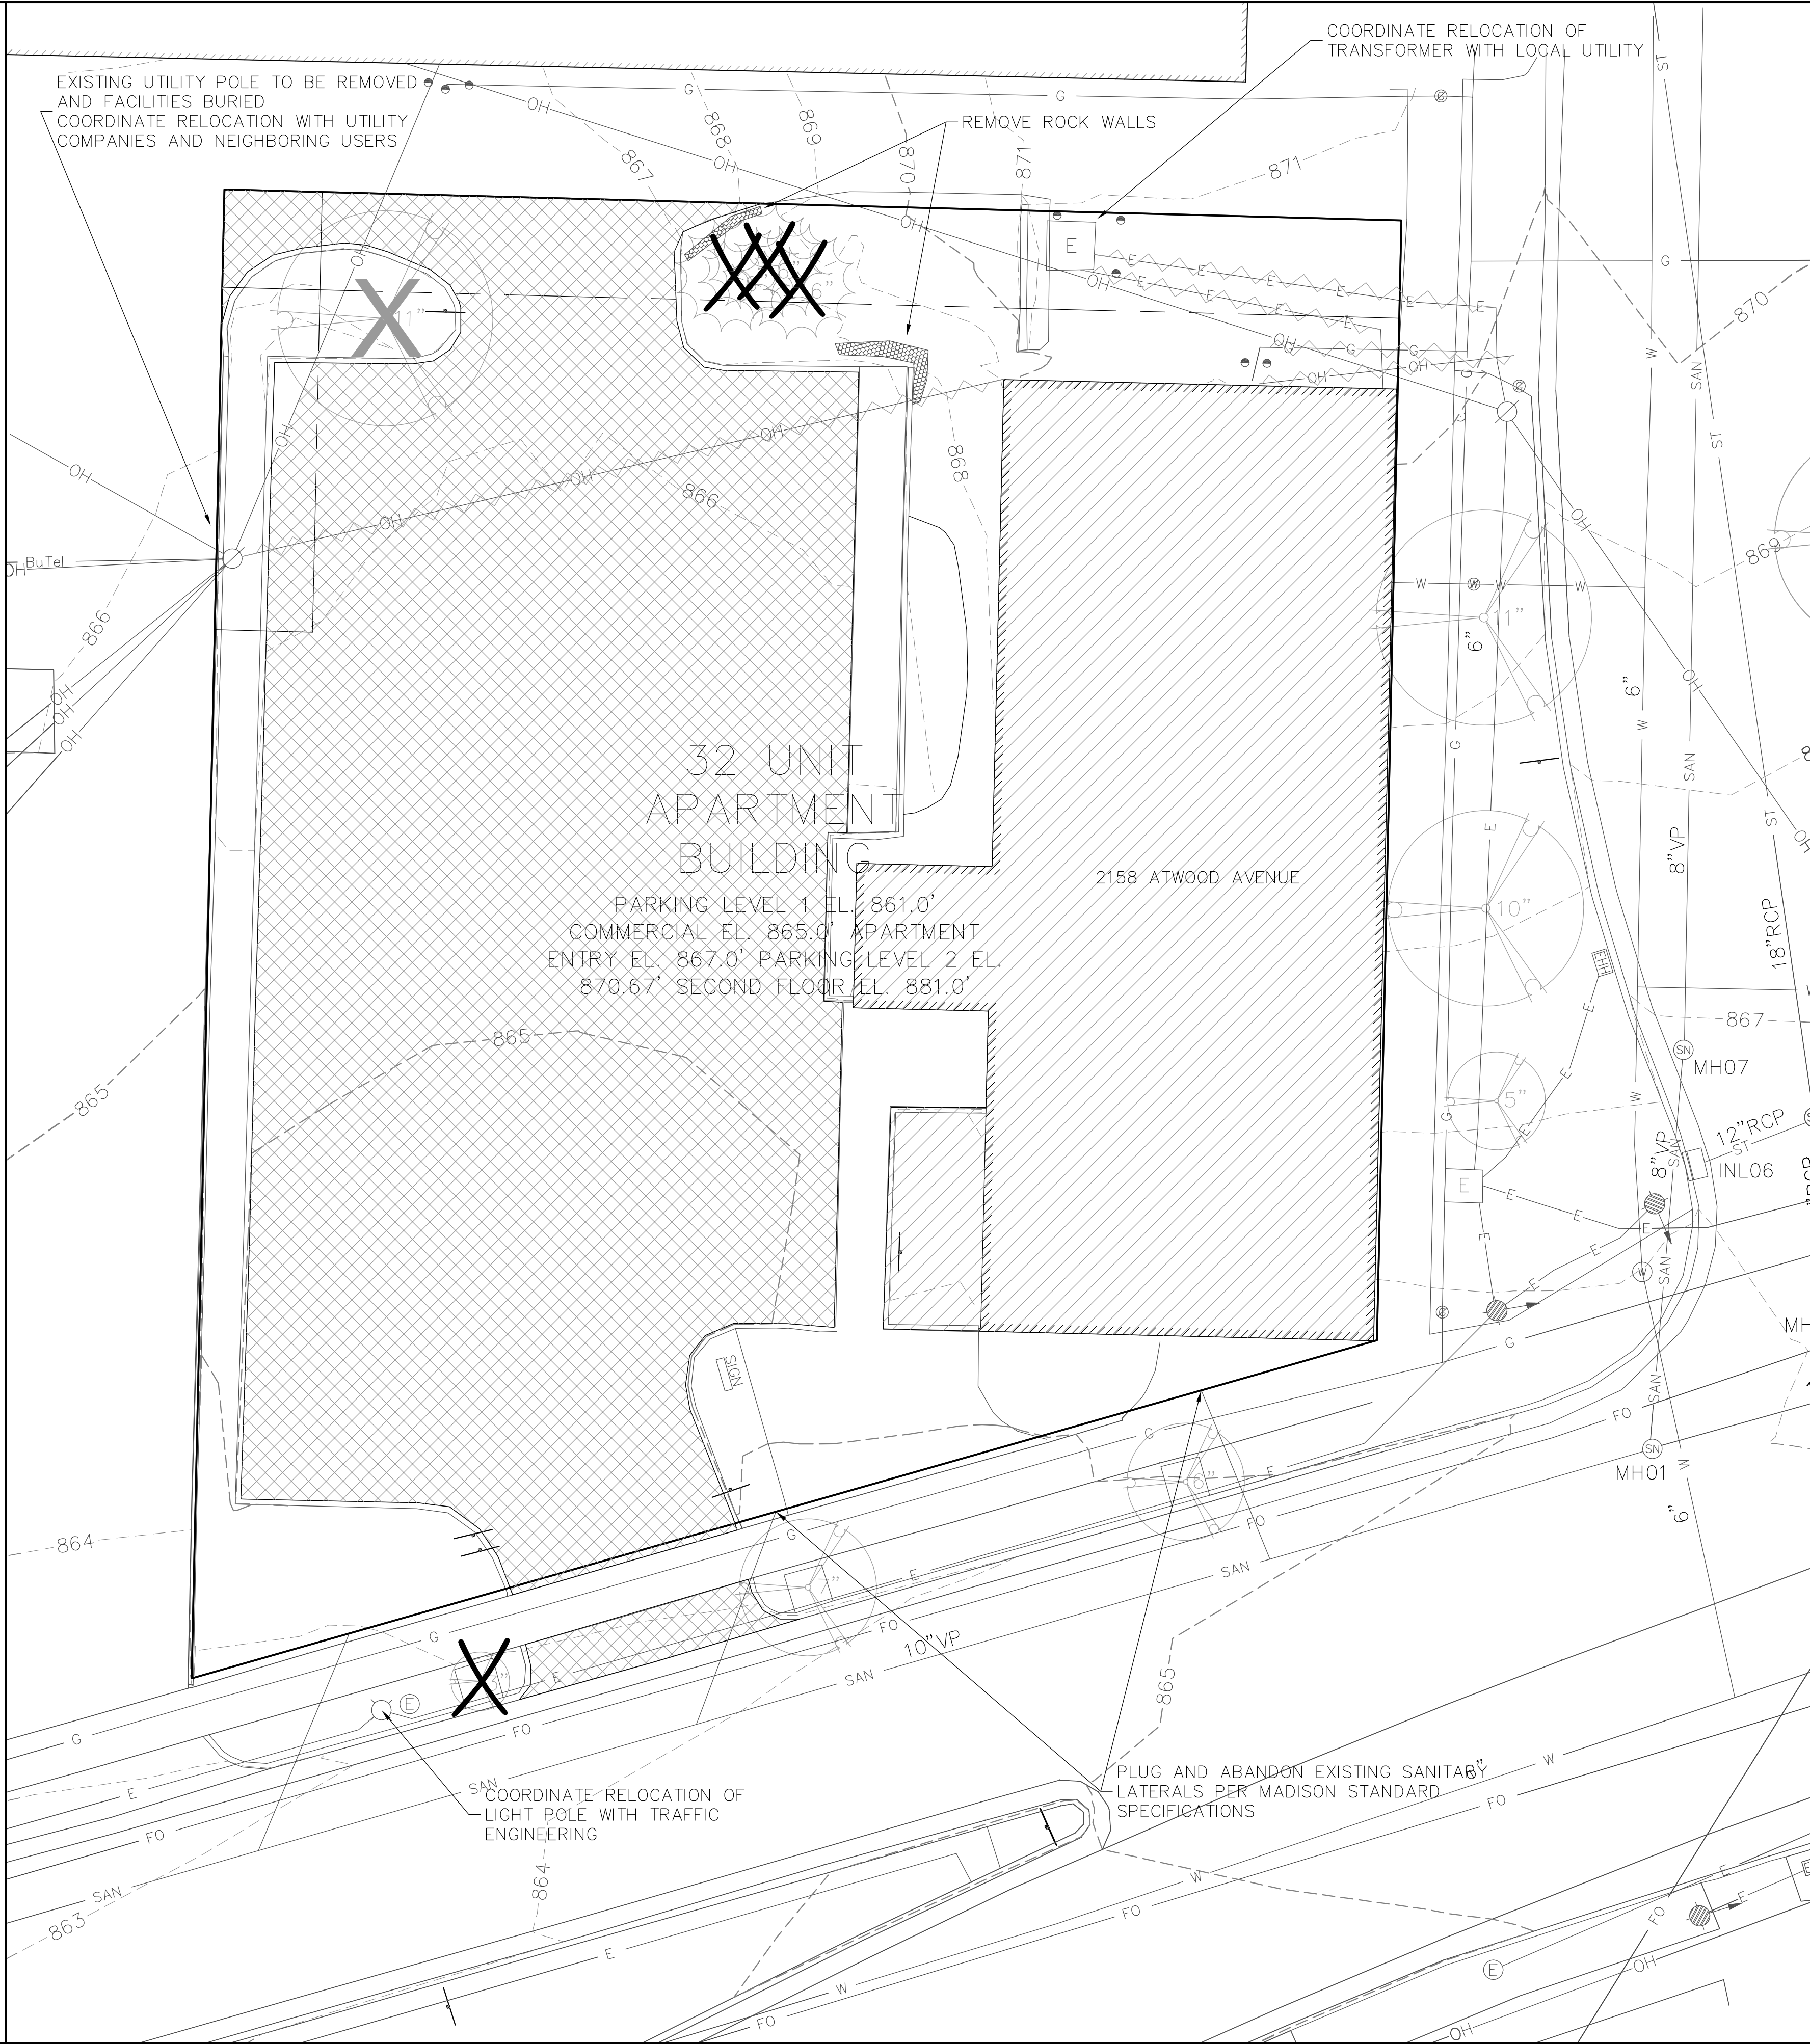- THE LOCATION OF EXISTING UNDERGROUND UTILITIES AS SHOWN ON THE PLANS HAS BEEN DETERMINED FROM THE BEST AVAILABLE INFORMATION AND IS GIVEN FOR THE CONVENIENCE OF THE CONTRACTOR. THE OWNER AND THE ENGINEER DO NOT ASSUME RESPONSIBILITY IN THE EVENT THAT DURING CONSTRUCTION, UTILITIES OTHER THAN THOSE SHOWN MAY BE ENCOUNTERED, AND THAT THE ACTUAL LOCATION OF THOSE WHICH ARE SHOWN MAY BE DIFFERENT FROM THE LOCATIONS AS SHOWN ON THE PLANS.
- ANY PAVEMENT ABUTTING THE PROPERTY SHALL BE REPLACED IF IT IS DAMAGED DURING CONSTRUCTION.
- PRIOR TO THE USE OF THESE DRAWINGS FOR CONSTRUCTION PURPOSES, THE USER SHALL VERIFY ALL DIMENSIONS AND LOCATIONS OF BUILDINGS WITH THE ARCHITECTURAL SITE PLAN. IF CONFLICTS EXIST THE USER OF THESE DRAWINGS SHALL CONTACT THE ENGINEER IMMEDIATELY.

DEMO LEGEND

- RAZE BUILDING
- REMOVE PAVEMENT
- REMOVE UTILITY LINE
- REMOVE TREE/SHRUB

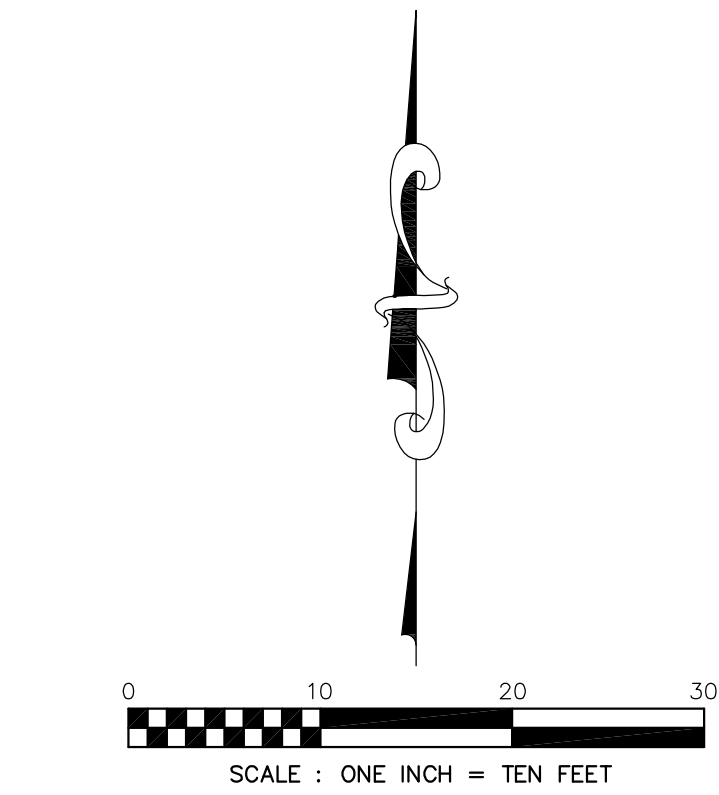

LEGEND	
—OH—	OVERHEAD UTILITY
—G—	BURIED GAS MAIN
—W—	WATER MAIN
—SAN—	SANITARY SEWER
—ST—	STORM SEWER
—Bu.Tel—	BURIED TELEPHONE
—E—	BURIED ELECTRIC
—Cn.Tv—	BURIED CABLE TV
—FO—	BURIED FIBER OPTIC
•	WATER VALVE
•	GAS VALVE
TV	CABLE TV PEDESTAL
E	ELECTRIC PEDESTAL
T	TELEPHONE PEDESTAL
Ø	UTILITY POLE
□	LIGHT POLE
—	GUY WIRE
—	SIGN
•	IRON PIPE FOUND (OUTSIDE DIAMETER NOTED)
•	SOLID IRON ROD FOUND SIZE NOTED
○	3/4" x 18" SOLID IRON RE-ROD SET, WT. 1.50 lbs./ft.
•	SET MAG NAIL
()	INDICATES RECORDED AS
•	FIRE HYDRANT
EH	ELECTRIC HAND HOLE
■	RECTANGULAR CATCH BASIN
□	STORM SEWER INLET
⊕	ELECTRIC MANHOLE
⊕	TELECOMM. MANHOLE
⊕	STORM SEWER MANHOLE
⊕	SANITARY SEWER MANHOLE
•	DECIDUOUS TREE
•	CONIFEROUS TREE
BT	BITUMINOUS PAVEMENT
CNC	CONCRETE PAVEMENT
LS	LANDSCAPING
•	BOLLARD
⊕	BENCHMARK
•	TRAFFIC SIGNAL

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PROJECT ENG: **MLB**
DESIGNED BY: **PDF**
DRAWN BY: **PDF**
CHECKED BY: **MLB**
APPROVED: **MLB**

2158 Atwood Avenue
2158 Atwood Avenue
Madison, WI 53704
Joe Krupp
2020 Eastwood Drive
Madison, WI 53704

PROJECT #: BSE1732-14
PLOT DATE: 06/24/2014


REVISION DATES:

ISSUE DATES:
06/24/2014

DEMOLITION PLAN

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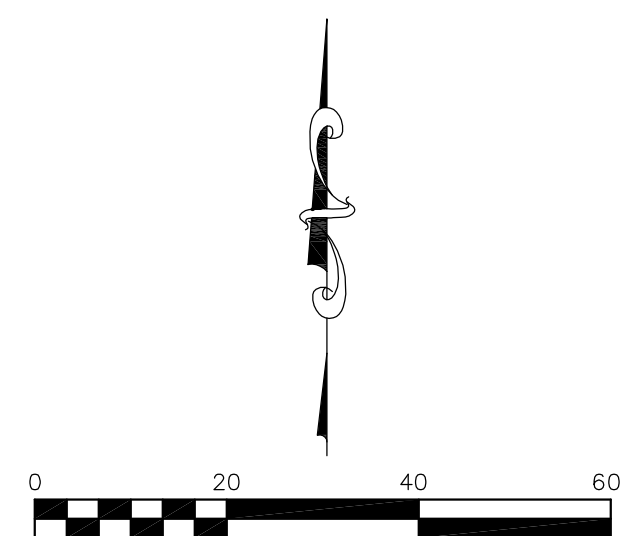
Erosion Control Notes/Specifications:

1. Erosion control devices and/or structures shall be installed prior to clearing and grubbing operations. These shall be properly maintained for maximum effectiveness until vegetation is re-established.
2. Erosion control is the responsibility of the contractor until acceptance of this project. Erosion control measures as shown shall be the minimum precautions that will be allowed. The contractor shall be responsible for recognizing and correcting all erosion control problems that are the result of construction activities. Additional erosion control measures, as requested in writing by the state or local inspectors, or the developer's engineer, shall be installed within 24 hours.
3. All erosion control measures and structures serving the site must be inspected at least weekly or within 24 hours of the time 0.5 inches of rain is produced. All maintenance will follow an inspection within 24 hours. Inspection schedule and record keeping shall comply with NR 216.46(9), Wis. Adm. Code.
4. Construction Entrances — Provide a stone tracking pad at each point of access. Install according to WDNR Standard 1057. Refer to WDNR's stormwater web page of technical standards at: http://dnr.wi.gov/topic/stormwater/standards/const_standards.html. The Tracking Pad must be maintained in a condition that prevents the tracking of material onto the public street.
5. Dewatering — Water pumped from the site shall be treated by using a temporary sedimentation basin, portable dewatering basin, geotextile bag, or an equivalent device. Show on the plan the anticipated locations of dewatering activity, and provide an engineering detail of the dewatering system. Devices shall comply with WDNR Technical Standard 1061 found at: http://dnr.wi.gov/topic/stormwater/standards/const_standards.html. This water shall be discharged in a manner that does not induce erosion of the site or adjacent property.
6. Storm Sewer Inlets — Provide WDOT Type D "CatchAll" inlet protection or equivalent. Refer to WDOT Product Acceptability List at: <http://www.dot.wisconsin.gov/business/engserv/pal.htm>. Inlet protection shall be installed prior to the storm sewer system receiving site runoff. Other than for performing maintenance, these devices shall not be removed until plot-level stabilization is complete.
7. Building and waste materials shall be prevented from running-off the site and entering waters of the state in conformance with NR151.12(6m).
8. No solid material shall be discharged or deposited into waters of the state in violation of Ch. 30 or 31 of the Wisconsin State Statutes or 33 USC 1344 permits.
9. Erosion control devices shall adhere to the technical standards found at: <http://dnr.wi.gov/runoff/stormwater/techstds.htm> and comply with all City of Madison ordinances.
10. All debris tracked onto public streets shall be swept or scraped clean by the end of each workday.
11. All building and waste material shall be handled properly to prevent runoff of these materials off of the site.
12. All disturbed areas shall be seeded immediately after grading activities have been completed.
13. All disturbed areas, except paved areas, shall receive a minimum of four (4) inches of topsoil, fertilizer, seed, and mulch. Seed mixtures shall be selected appropriate to the intended function. A qualified Landscaping Contractor, Landscape Architect or Nursery can be consulted for recommendations. Seeding rates shall be based on pounds or ounces of Pure Live Seed per acre and shall be provided by the seed supplier. Fertilizer can be applied to help promote growth, but a soil test is recommended to determine the type and amount of fertilizer to be applied. All seeding and restoration shall be in conformance to WDNR Technical Standard 1059 found at http://dnr.wi.gov/topic/stormwater/standards/const_standards.html. Seeding and sodding may only be used from May 1st to September 15th of any year. Temporary seed shall be used after September 15. If temporary seeding is used, a permanent cover shall also be required as part of the final site stabilization.
14. For the first six (6) weeks after the initial stabilization of a disturbed area, watering shall be performed whenever more than seven (7) days of dry weather elapse.

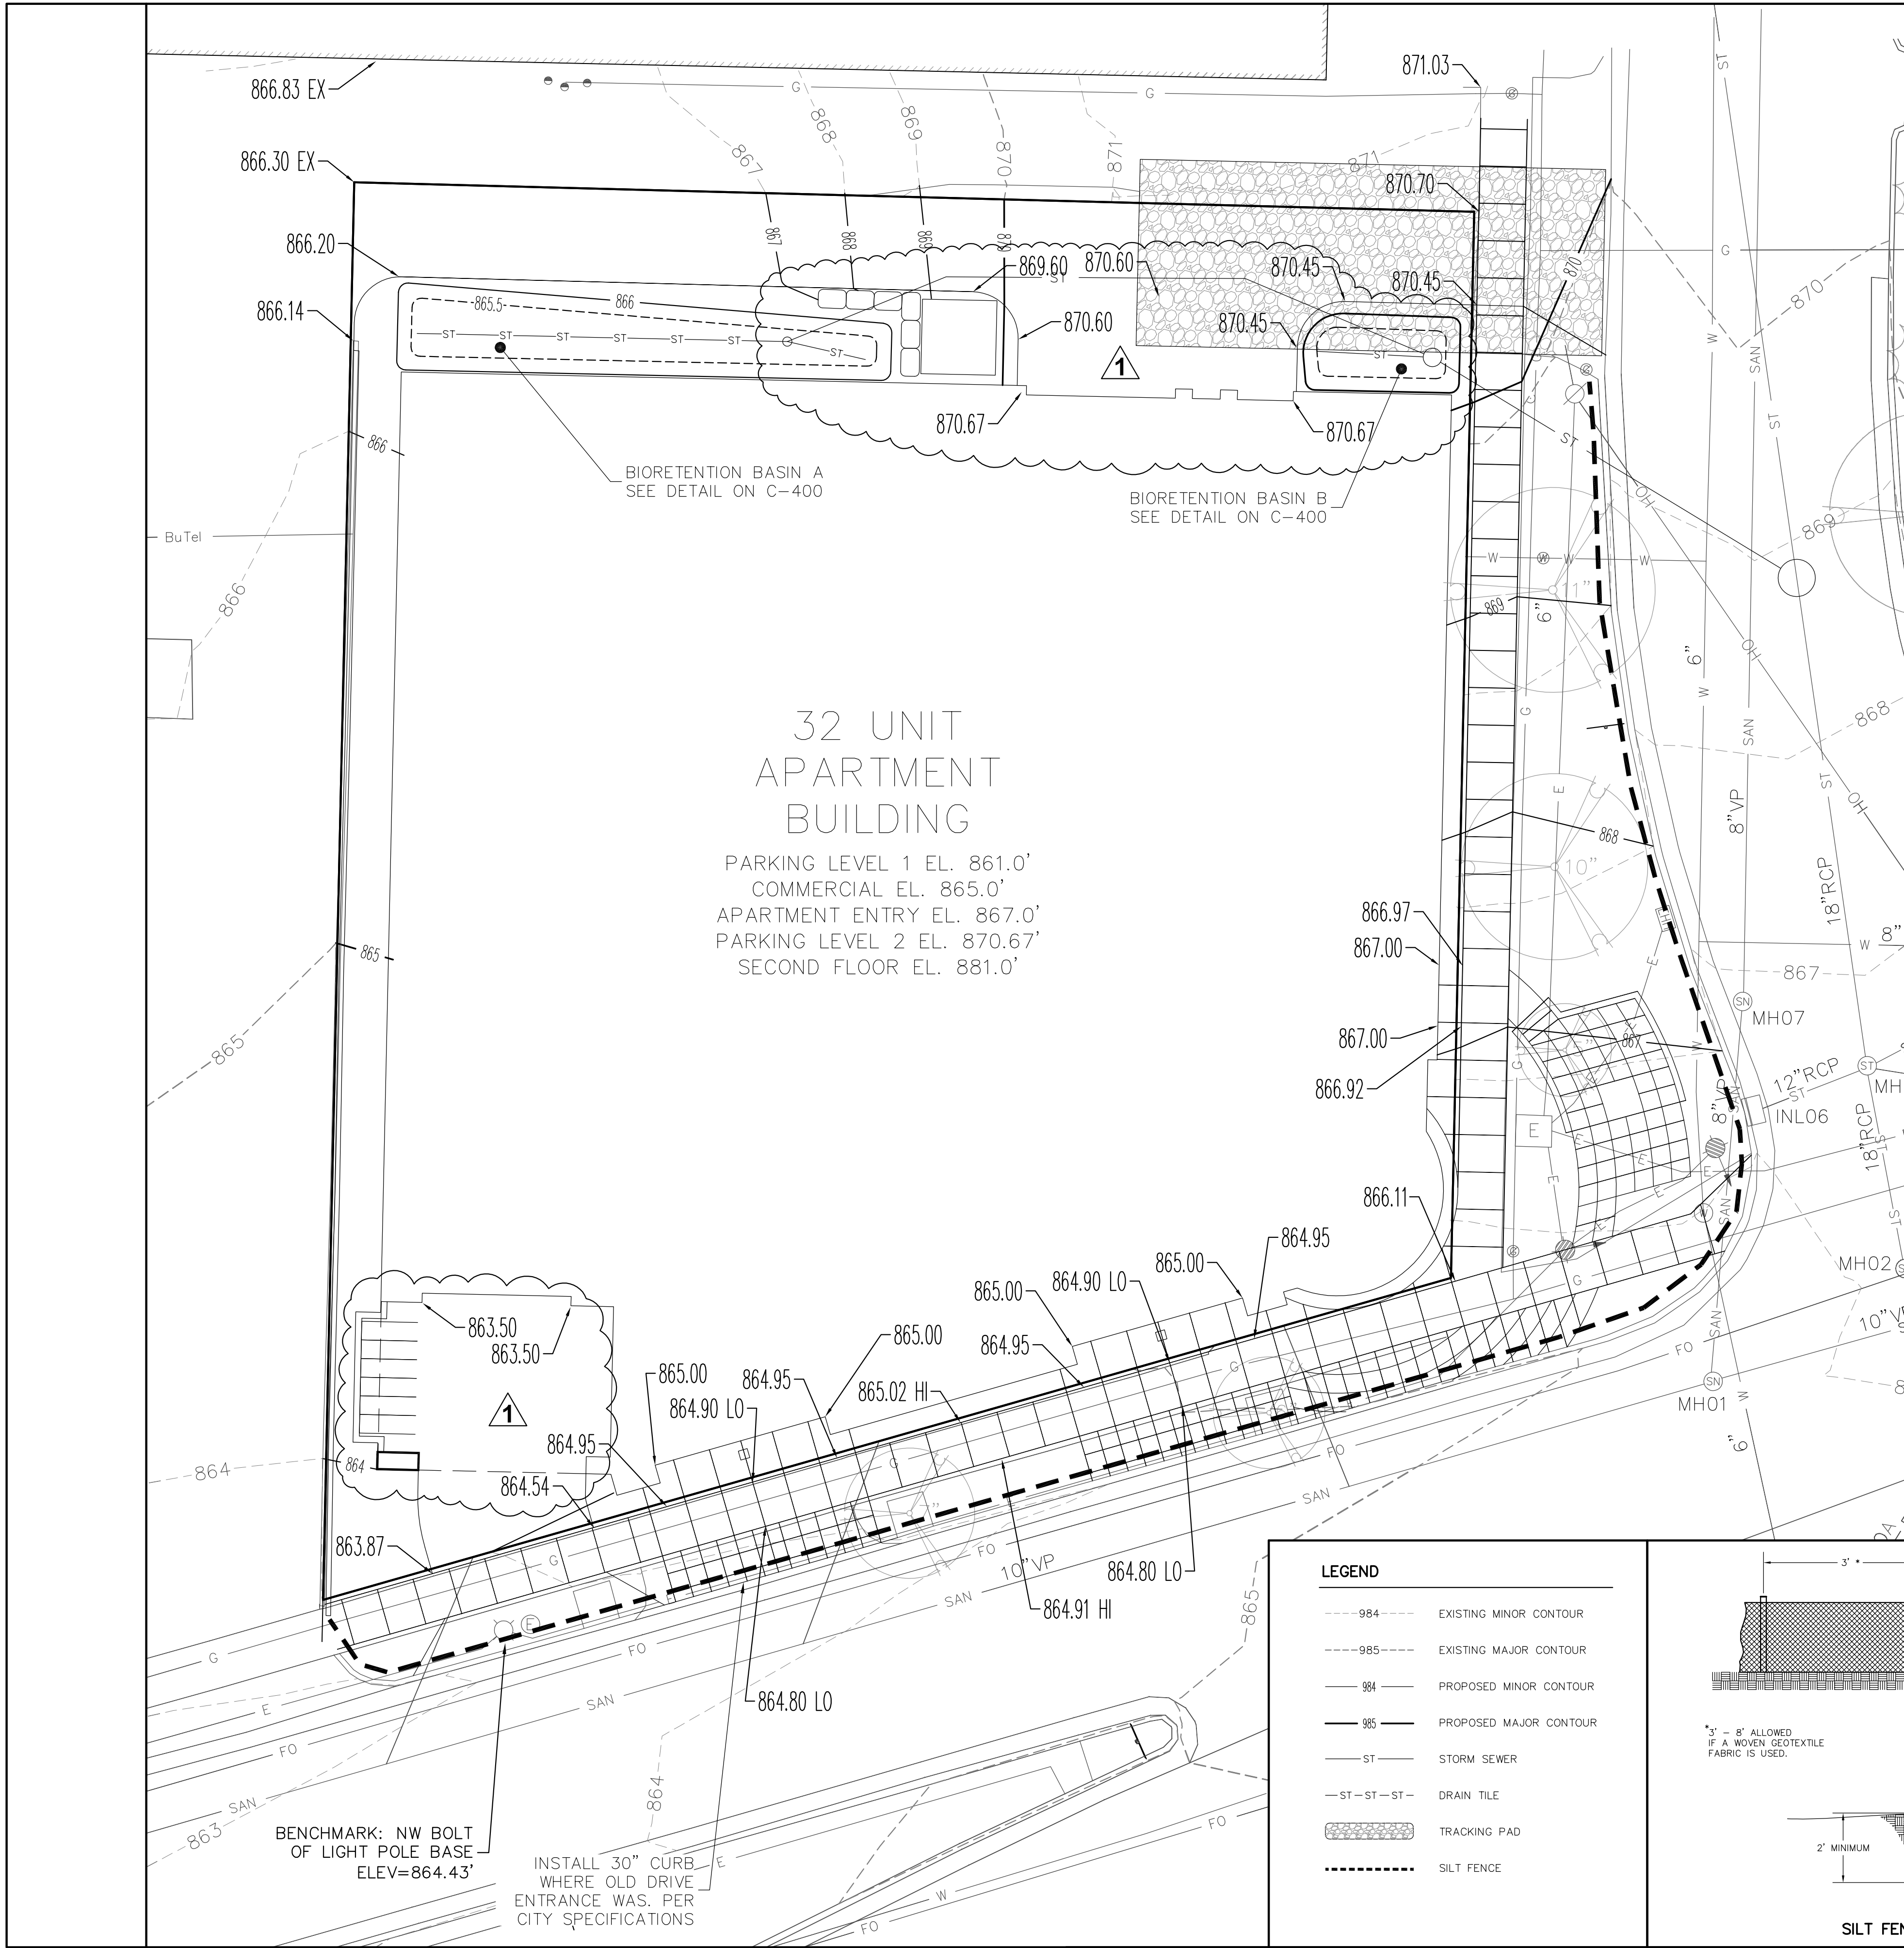
Emergency Contact
Joe Krupp
Krupp Construction
2020 Eastwood Drive
Madison, WI 53704
(608) 249-2020
joe@kruppconstruction.com

Schedule:	
September 1, 2014	Install silt fence and construction entrance.
September 2, 2014	Begin disturbance of site ground cover.
September 1, 2015	Hardscape installed. Apply seed and mulch to all pervious areas.
November 1, 2015	Vegetation established.


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- LEGEND**
- 984 --- EXISTING MINOR CONTOUR
 - 985 --- EXISTING MAJOR CONTOUR
 - 984 --- PROPOSED MINOR CONTOUR
 - 985 --- PROPOSED MAJOR CONTOUR
 - ST — STORM SEWER
 - ST—ST—ST — DRAIN TILE
 - [Pattern] TRACKING PAD
 - SILT FENCE



SILT FENCE CONSTRUCTION

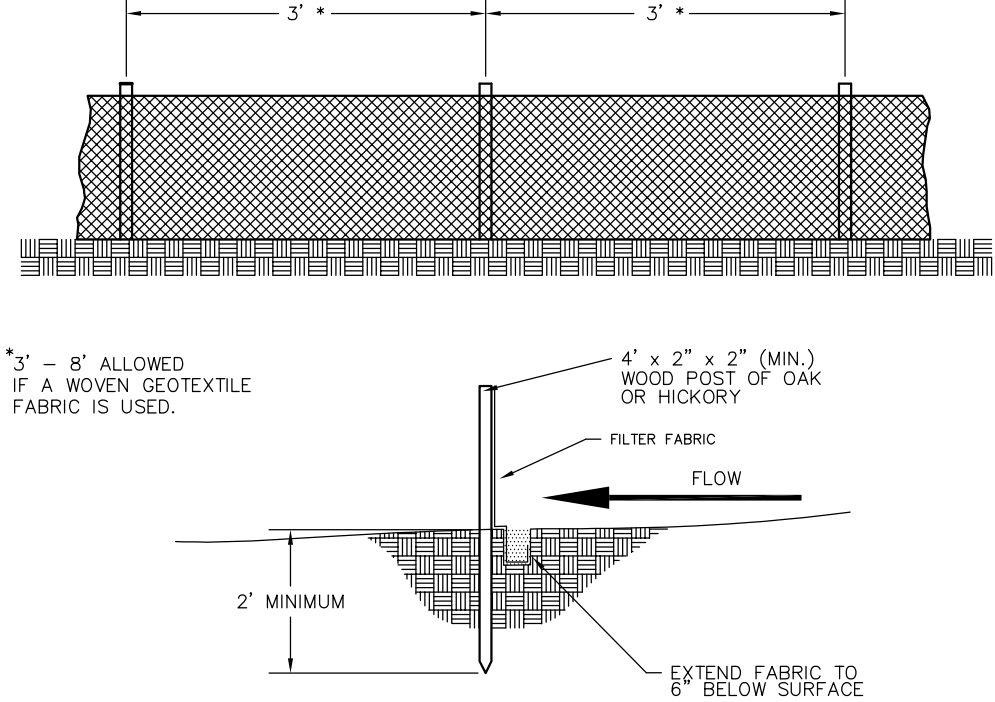

TRACKING PAD
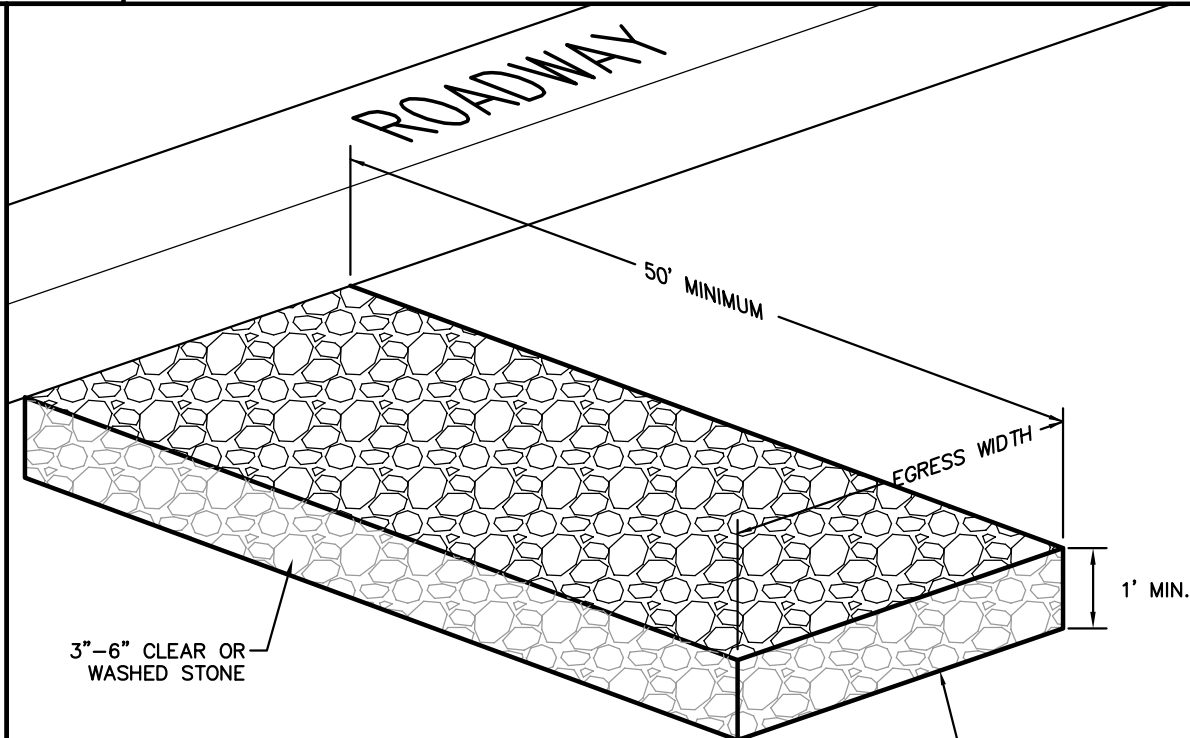
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APPROVALS	PROJECT ENG	MLB	DESIGNED BY	PDF	SEAL	PDF	CHECKED BY	MLB	APPROVED	MLB
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2158 Atwood Avenue
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Madison, WI 53704
Joe Krupp
2020 Eastwood Drive
Madison, WI 53704

PROJECT #: BSE1732-14
PLOT DATE: 07/28/2014

REVISION DATES:
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07/28/2014

GRADING AND EROSION CONTROL PLAN

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APPROVALS
PROJECT NO. MLB
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APPROVED BY MLB

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Madison, WI 53704
Joe Krupp
2020 Eastwood Drive
Madison, WI 53704

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UTILITY PLAN


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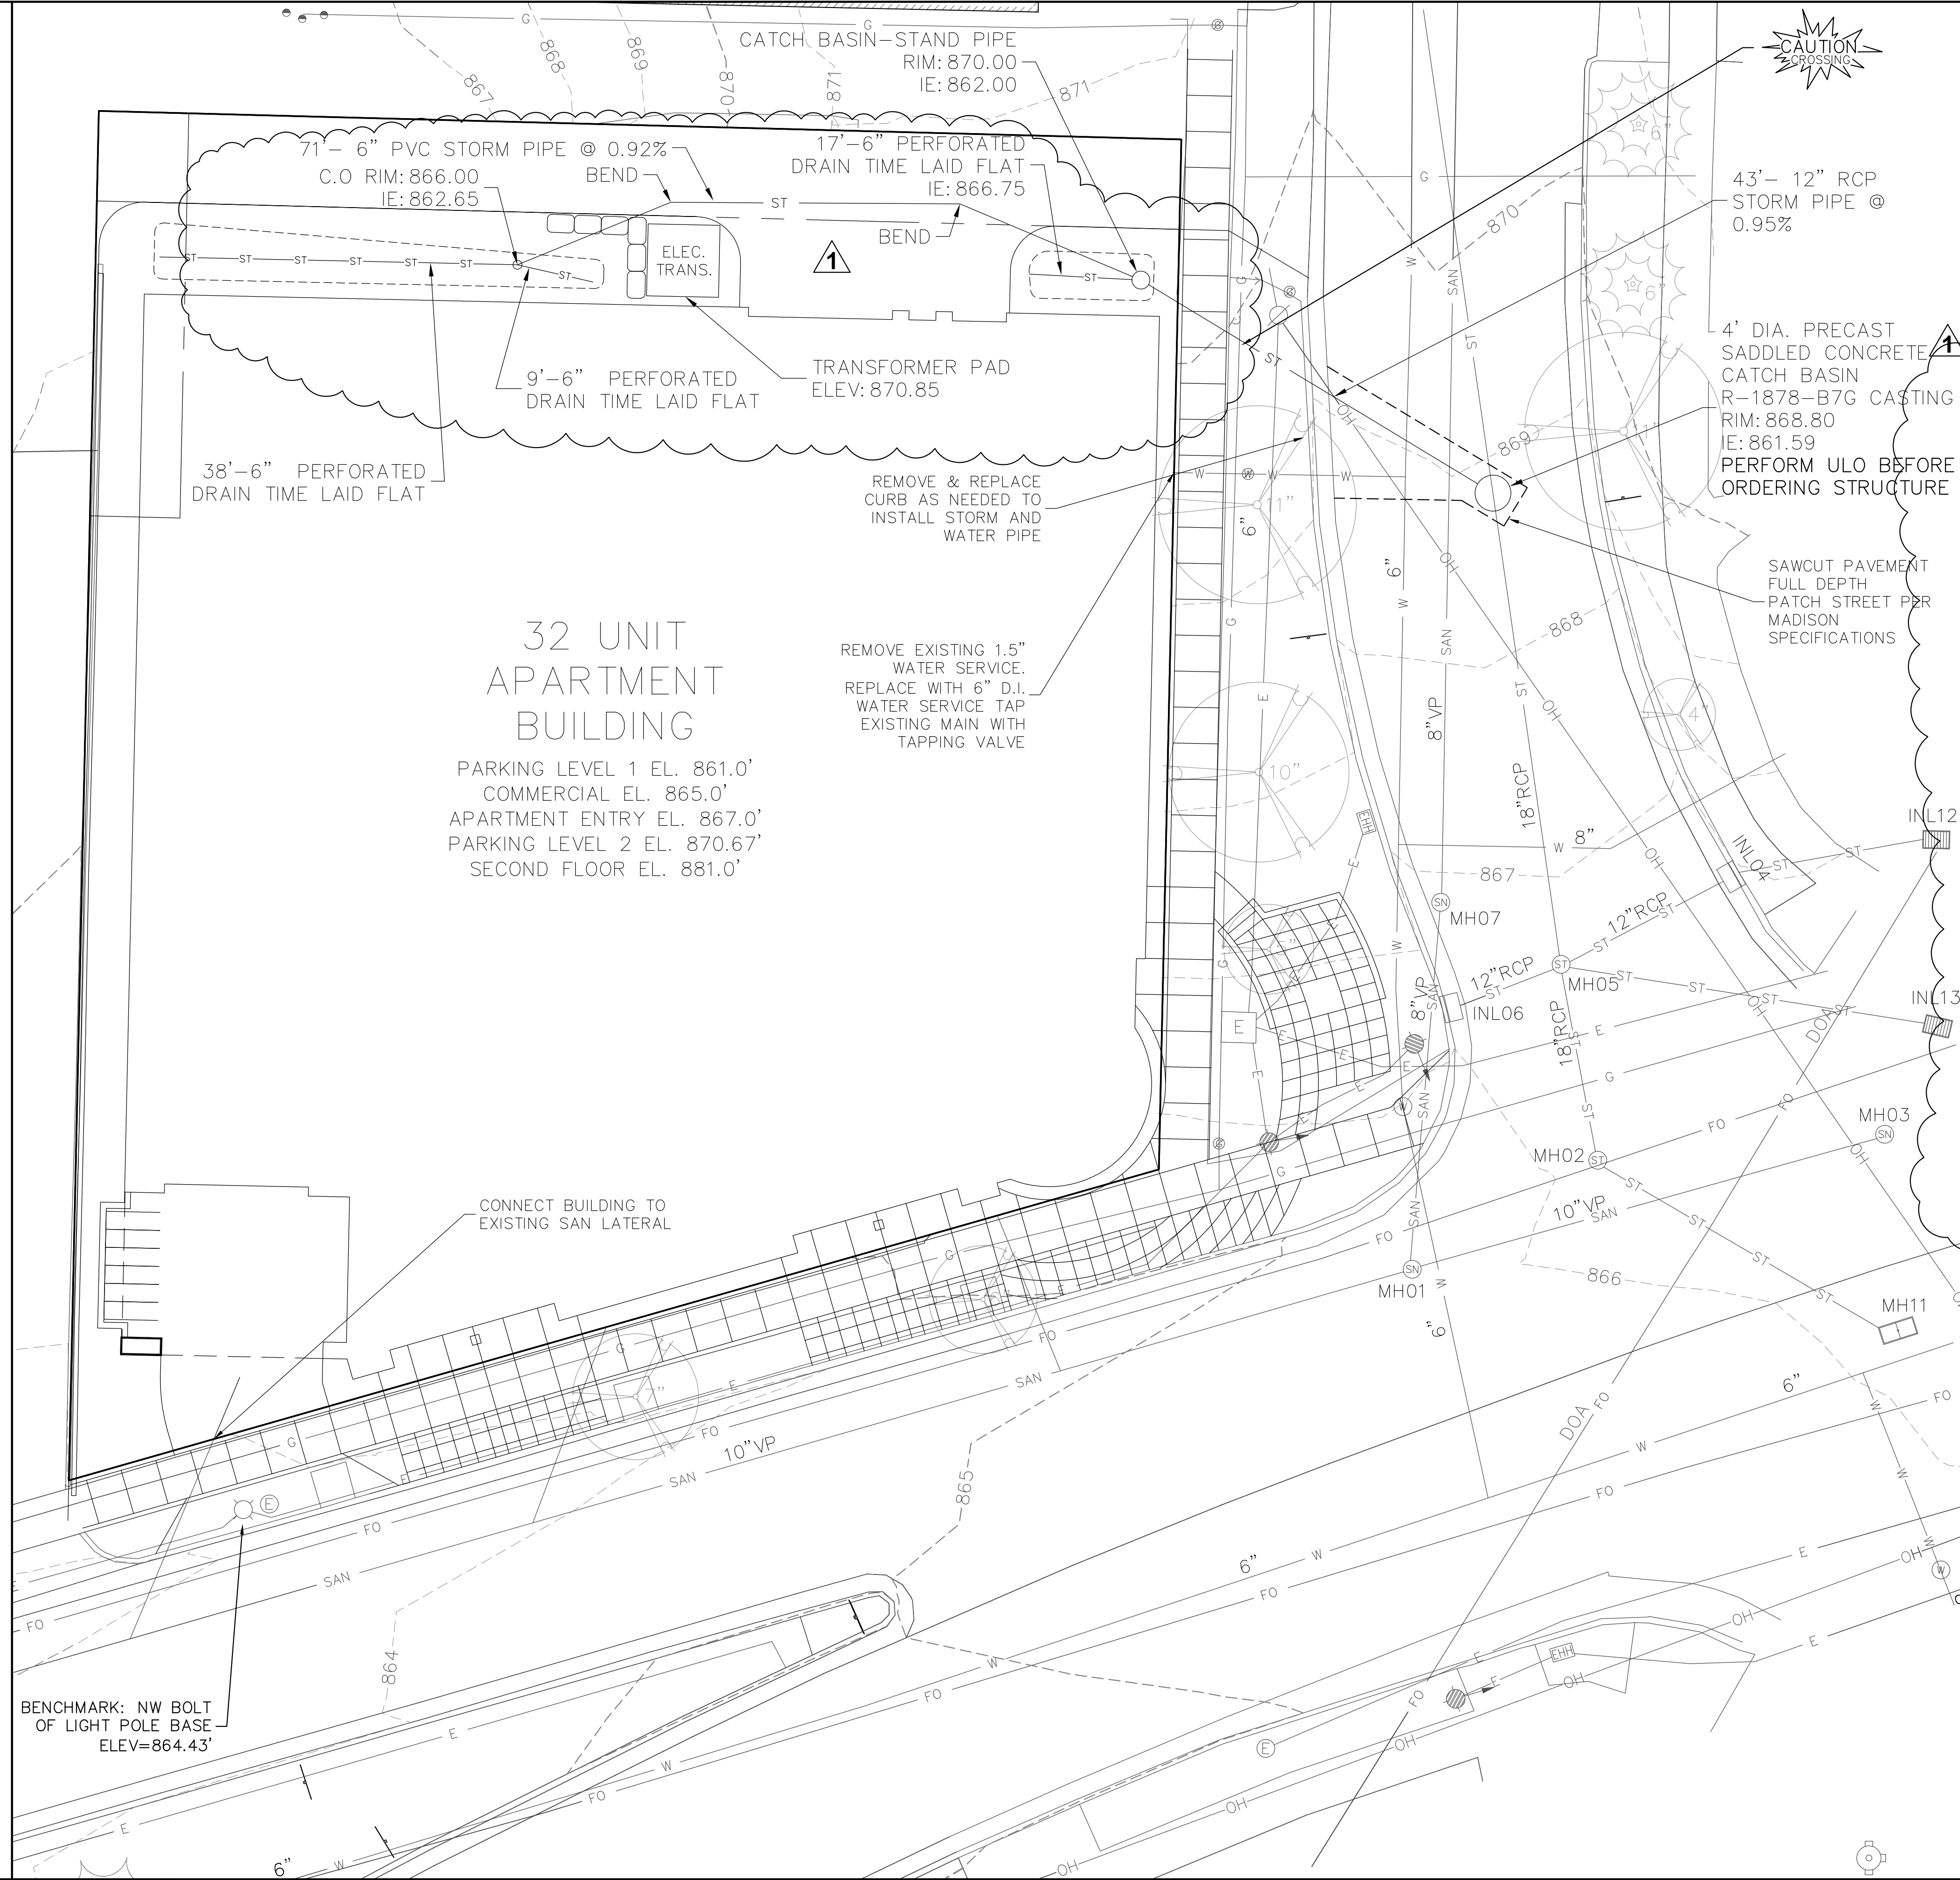
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STORM SEWER AND SANITARY SEWER ELEVATION TABLE				
NUMBER	RIM/TC	INVERT ELEV.	INVERT ELEV.	INVERT ELEV.
MH01	865.88	E IE: 851.60	N IE: 851.76	W IE: 851.50
MH02	866.10	FLOOR: 859.60	FULL OF WATER, NO PIPES VISIBLE	
MH03	866.31	E IE: 851.45	S IE: 851.76	W IE: 851.41
INL04	866.92	E IE: 863.42	W IE: 863.42	N IE: 861.41
MH05	866.66	E IE: 862.41	W IE: 863.28	N IE: 861.41
INL06	866.76	E IE: 863.75		S IE: 861.38
MH07	866.84	NE IE: 860.49	N IE: 859.66	S IE: 859.34
MH08	860.72	W IE: 850.21	N IE: 850.57	E IE: 850.31
MH09	873.51	N IE: 865.09	S IE: 864.89	
MH10	872.78	FLOOR: 860.50	S IE: 862.04	
MH11	866.05	UNABLE TO OPEN.		
INL12	866.28	FABRIC BARRIER, NOT ABLE TO MEASURE		
INL13	865.76	W IE: 861.91	E IE: 862.06	



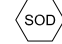
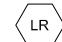


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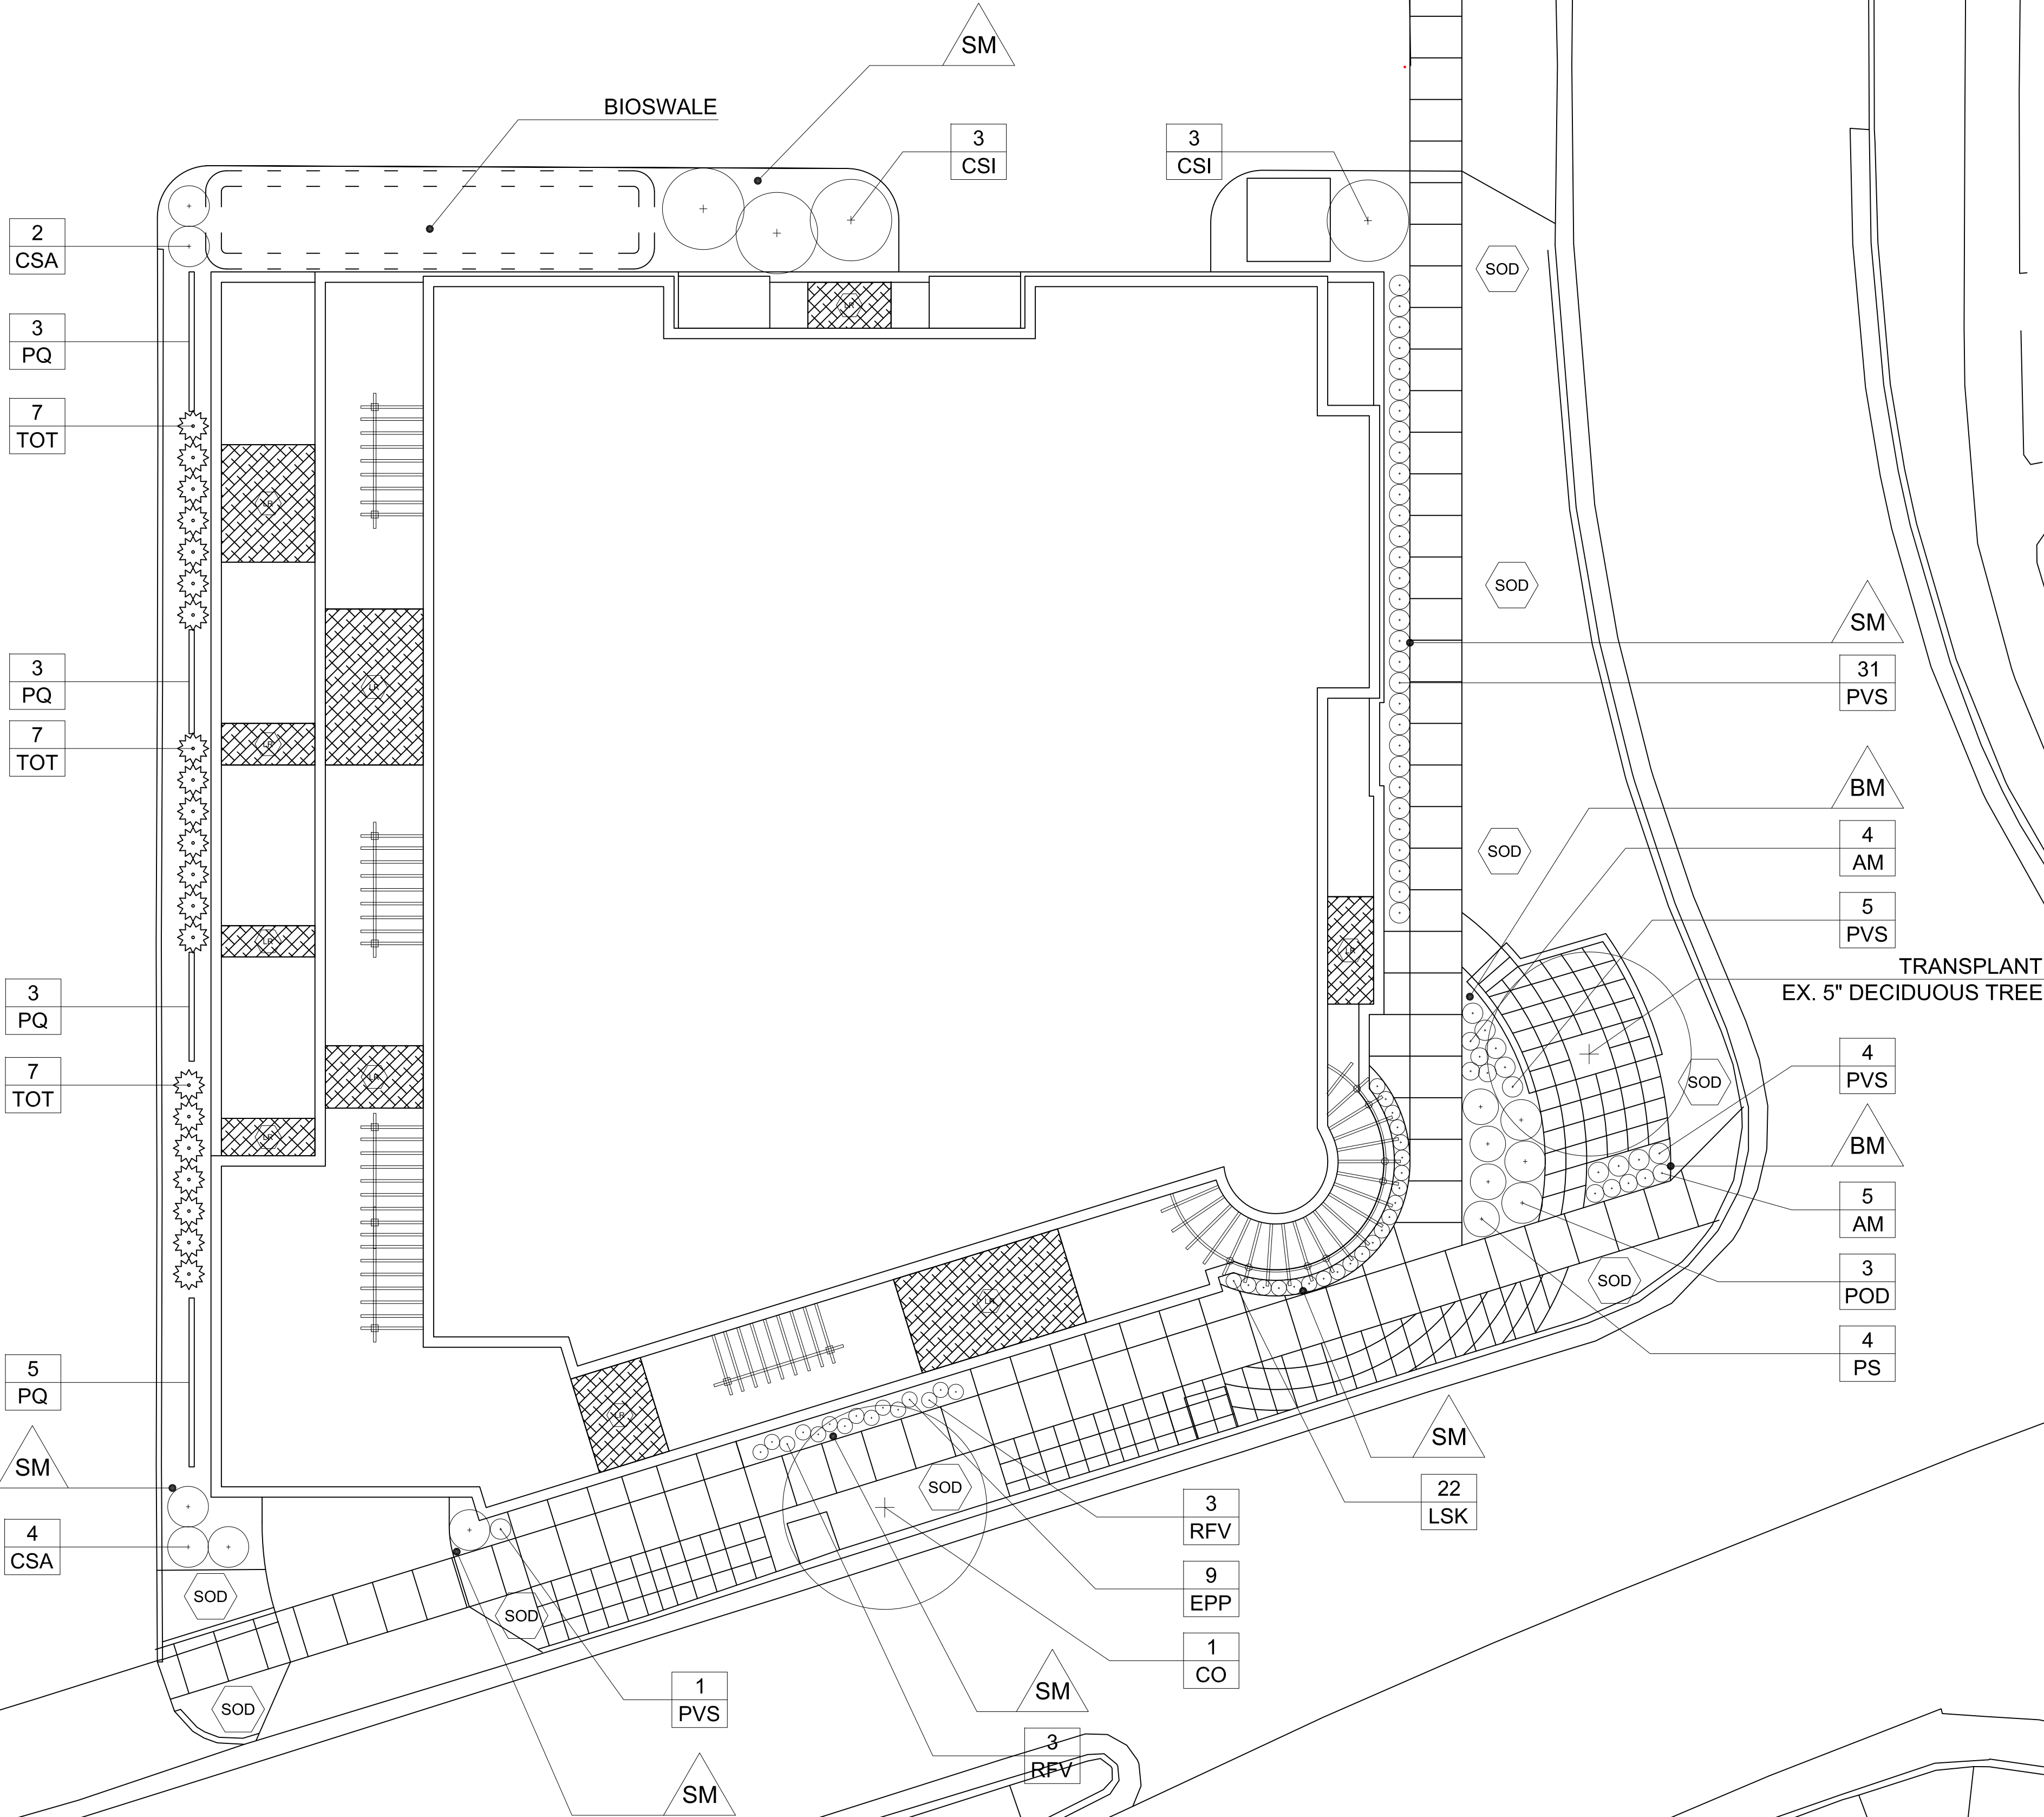
PLANT LIST

KEY	SCIENTIFIC NAME	COMMON NAME	QTY	PLANTING SIZE	ROOT CONDITION
EVERGREEN SHRUBS					
CO	Cellis occidentalis	Common Hackberry	1	2 1/2'	B&B
EVERGREEN SHRUBS					
TOT	Thuja occidentalis 'Technito'	Technito Arborvitae	21	4'	B&B
DECIDUOUS SHRUBS					
CSA	Cornus sericea 'Alleman's'	Alleman's Compact Dogwood	6	#5	Cont.
CSI	Cornus sericea 'Isanti'	Isanti Dogwood	4	#5	Cont.
POD	Physocarpus opulifolius 'Donna May'	Little Devil Ninebark	3	#3	Cont.
PS	Philadelphus 'Snowbelle'	Snowbelle Mockorange	4	#3	Cont.
ORNAMENTAL GRASSES					
AM	Achillea millefolium 'Moonshine'	Moonshine Yarrow	9	#1	Cont.
EPP	Echinacea purpurea 'PowWow White'	PowWow White Coneflower	9	#1	Cont.
LSK	Liatris spicata 'Kobold'	Kobold Blazingstar	22	#1	Cont.
PVS	Panicum virgatum 'Shenandoah'	Shenandoah Switch Grass	41	#1	Cont.
PQ	Parthenocissus quinquefolia	Virginia Creeper	14	#1	Cont.
RFV	Rudbeckia fuldiga 'Viete's Little Suzy'	Little Suzy Black-eyed Susan	6	#1	Cont.

-  Decorative Stone over fabric weed barrier
-  Brown Dyed Wood Mulch
-  SOD
-  Live Roof

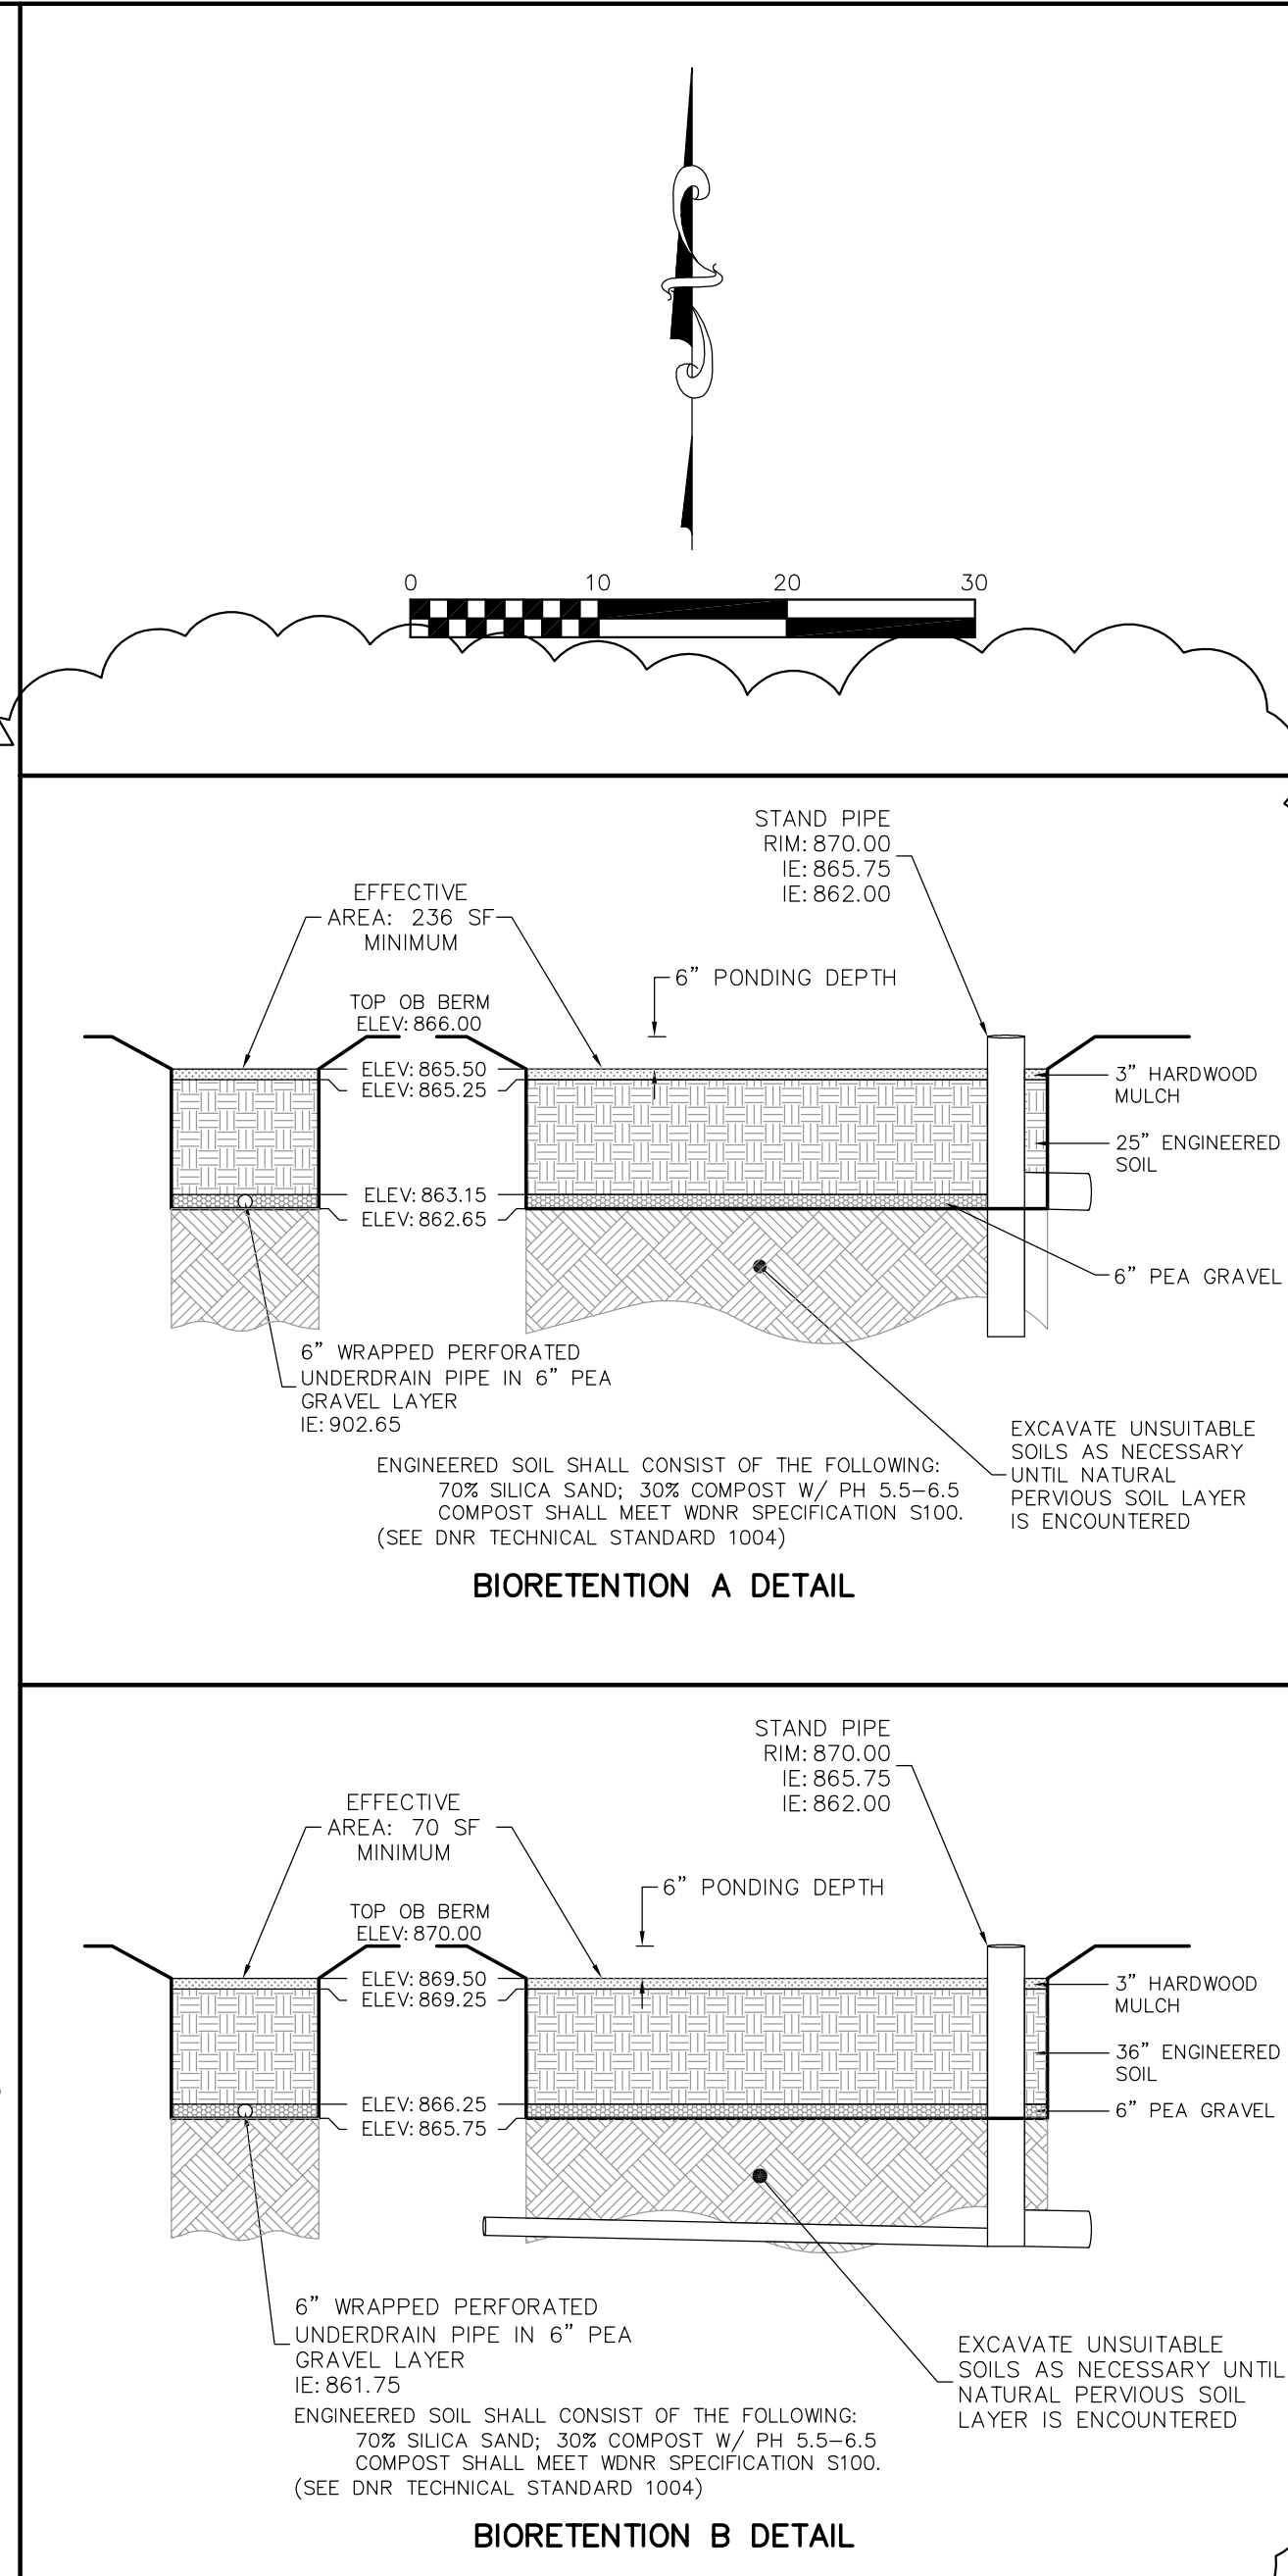BIOSWALES

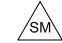Butterfly Weed	50	2.5"	Plug	12" O.C.
Blue False Indigo	40	2.5"	Plug	12" O.C.
White False Indigo	40	2.5"	Plug	12" O.C.
Purple Coneflower	40	2.5"	Plug	12" O.C.
Blue Flag Iris	40	2.5"	Plug	12" O.C.
Cardinal Flower	40	2.5"	Plug	12" O.C.
Marsh Blazingstar	40	2.5"	Plug	12" O.C.
Brown Eyed Susan	40	2.5"	Plug	12" O.C.
Stiff Goldenrod	40	2.5"	Plug	12" O.C.
Bottlebrush Sedge	50	2.5"	Plug	12" O.C.
Fox Sedge	50	2.5"	Plug	12" O.C.
Torrey's Rush	50	2.5"	Plug	12" O.C.
Switch Grass	50	2.5"	Plug	12" O.C.



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ISSUED
June 24, 2014

Revised - July 28, 2014

PROJECT TITLE
**KRUPP
ATWOOD
DEVELOPMENT**

2158 Atwood Ave
SHEET TITLE
Landscape Plan

SHEET NUMBER

L-1.0

PROJECT NO. **1359**
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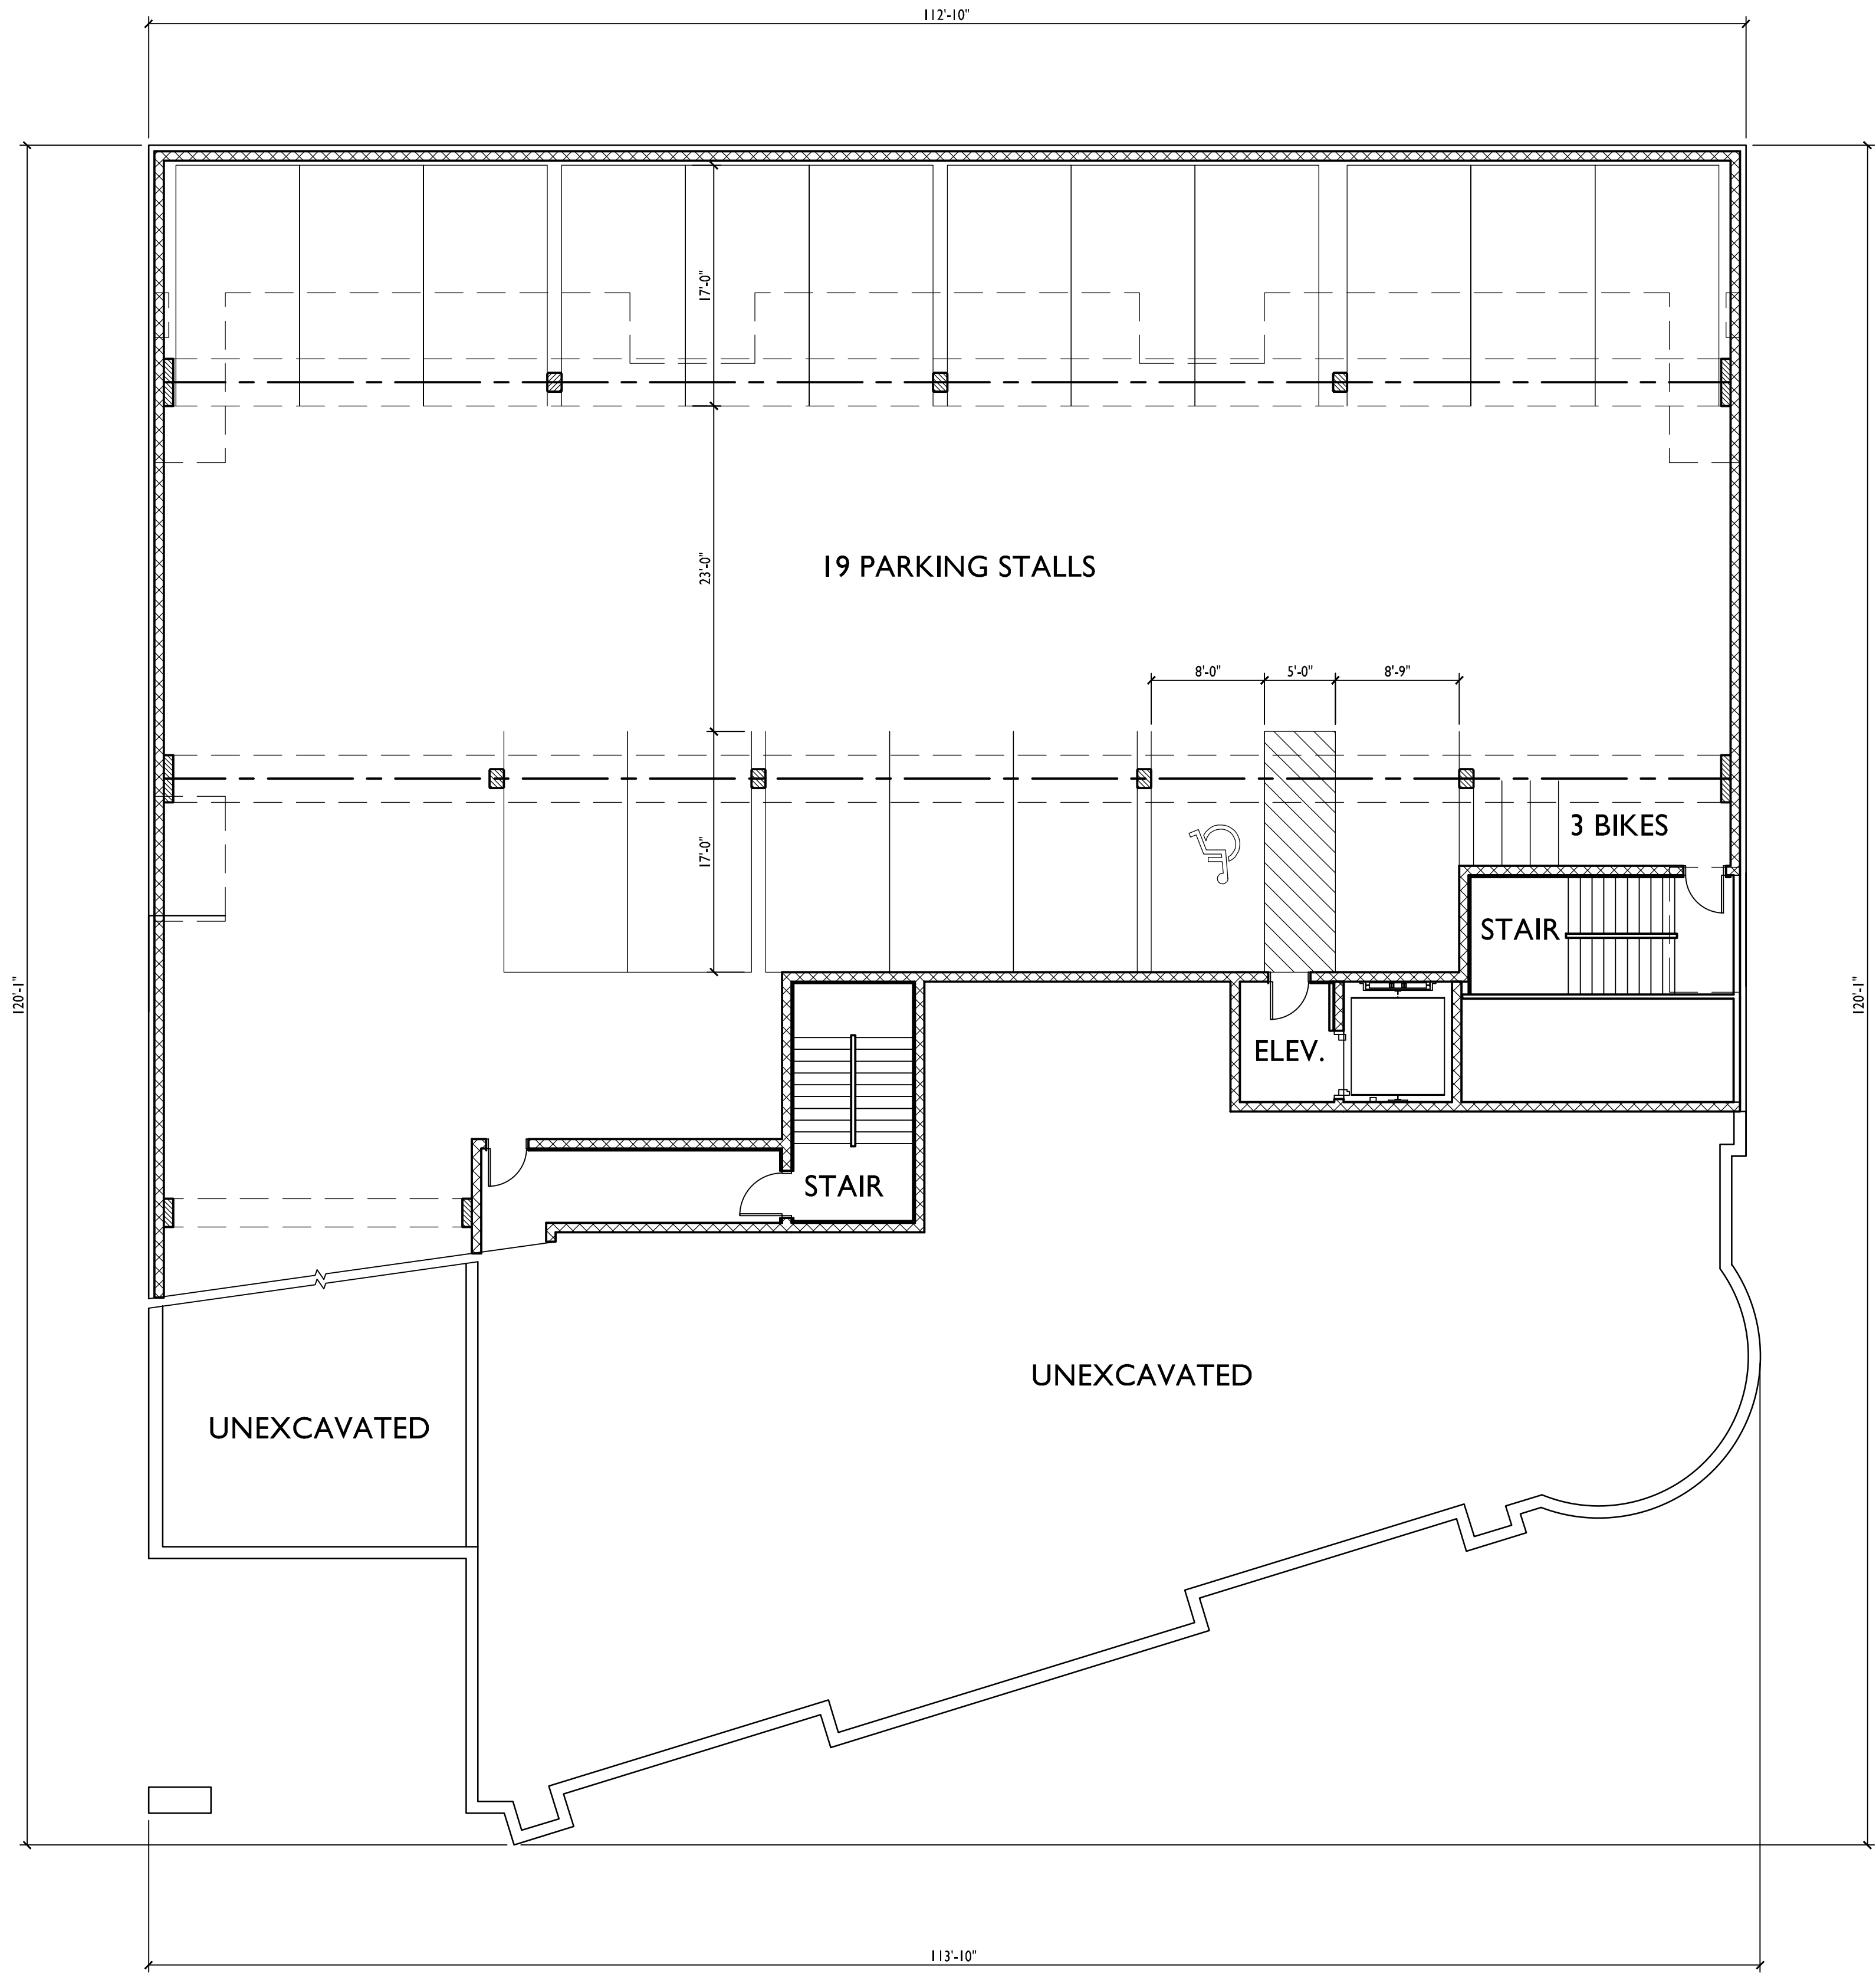
ISSUED
Issued for Review - July 28, 2014

PROJECT TITLE
**KRUPP
ATWOOD
DEVELOPMENT**


2158 Atwood Ave
SHEET TITLE
**Lower Level
Parking Plan**

SHEET NUMBER

A-1.0
PROJECT NO. **1359**
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1 LOWER LEVEL PARKING PLAN
A-1.0 1/8"=1'-0"




ISSUED
Issued for Review - July 28, 2014

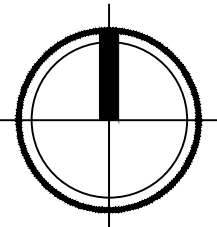PROJECT TITLE
**KRUPP
ATWOOD
DEVELOPMENT**


2158 Atwood Ave
SHEET TITLE
First Floor Plan

SHEET NUMBER

A-1.1
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FIRST FLOOR PLAN
A-1.1
1/8"=1'-0"

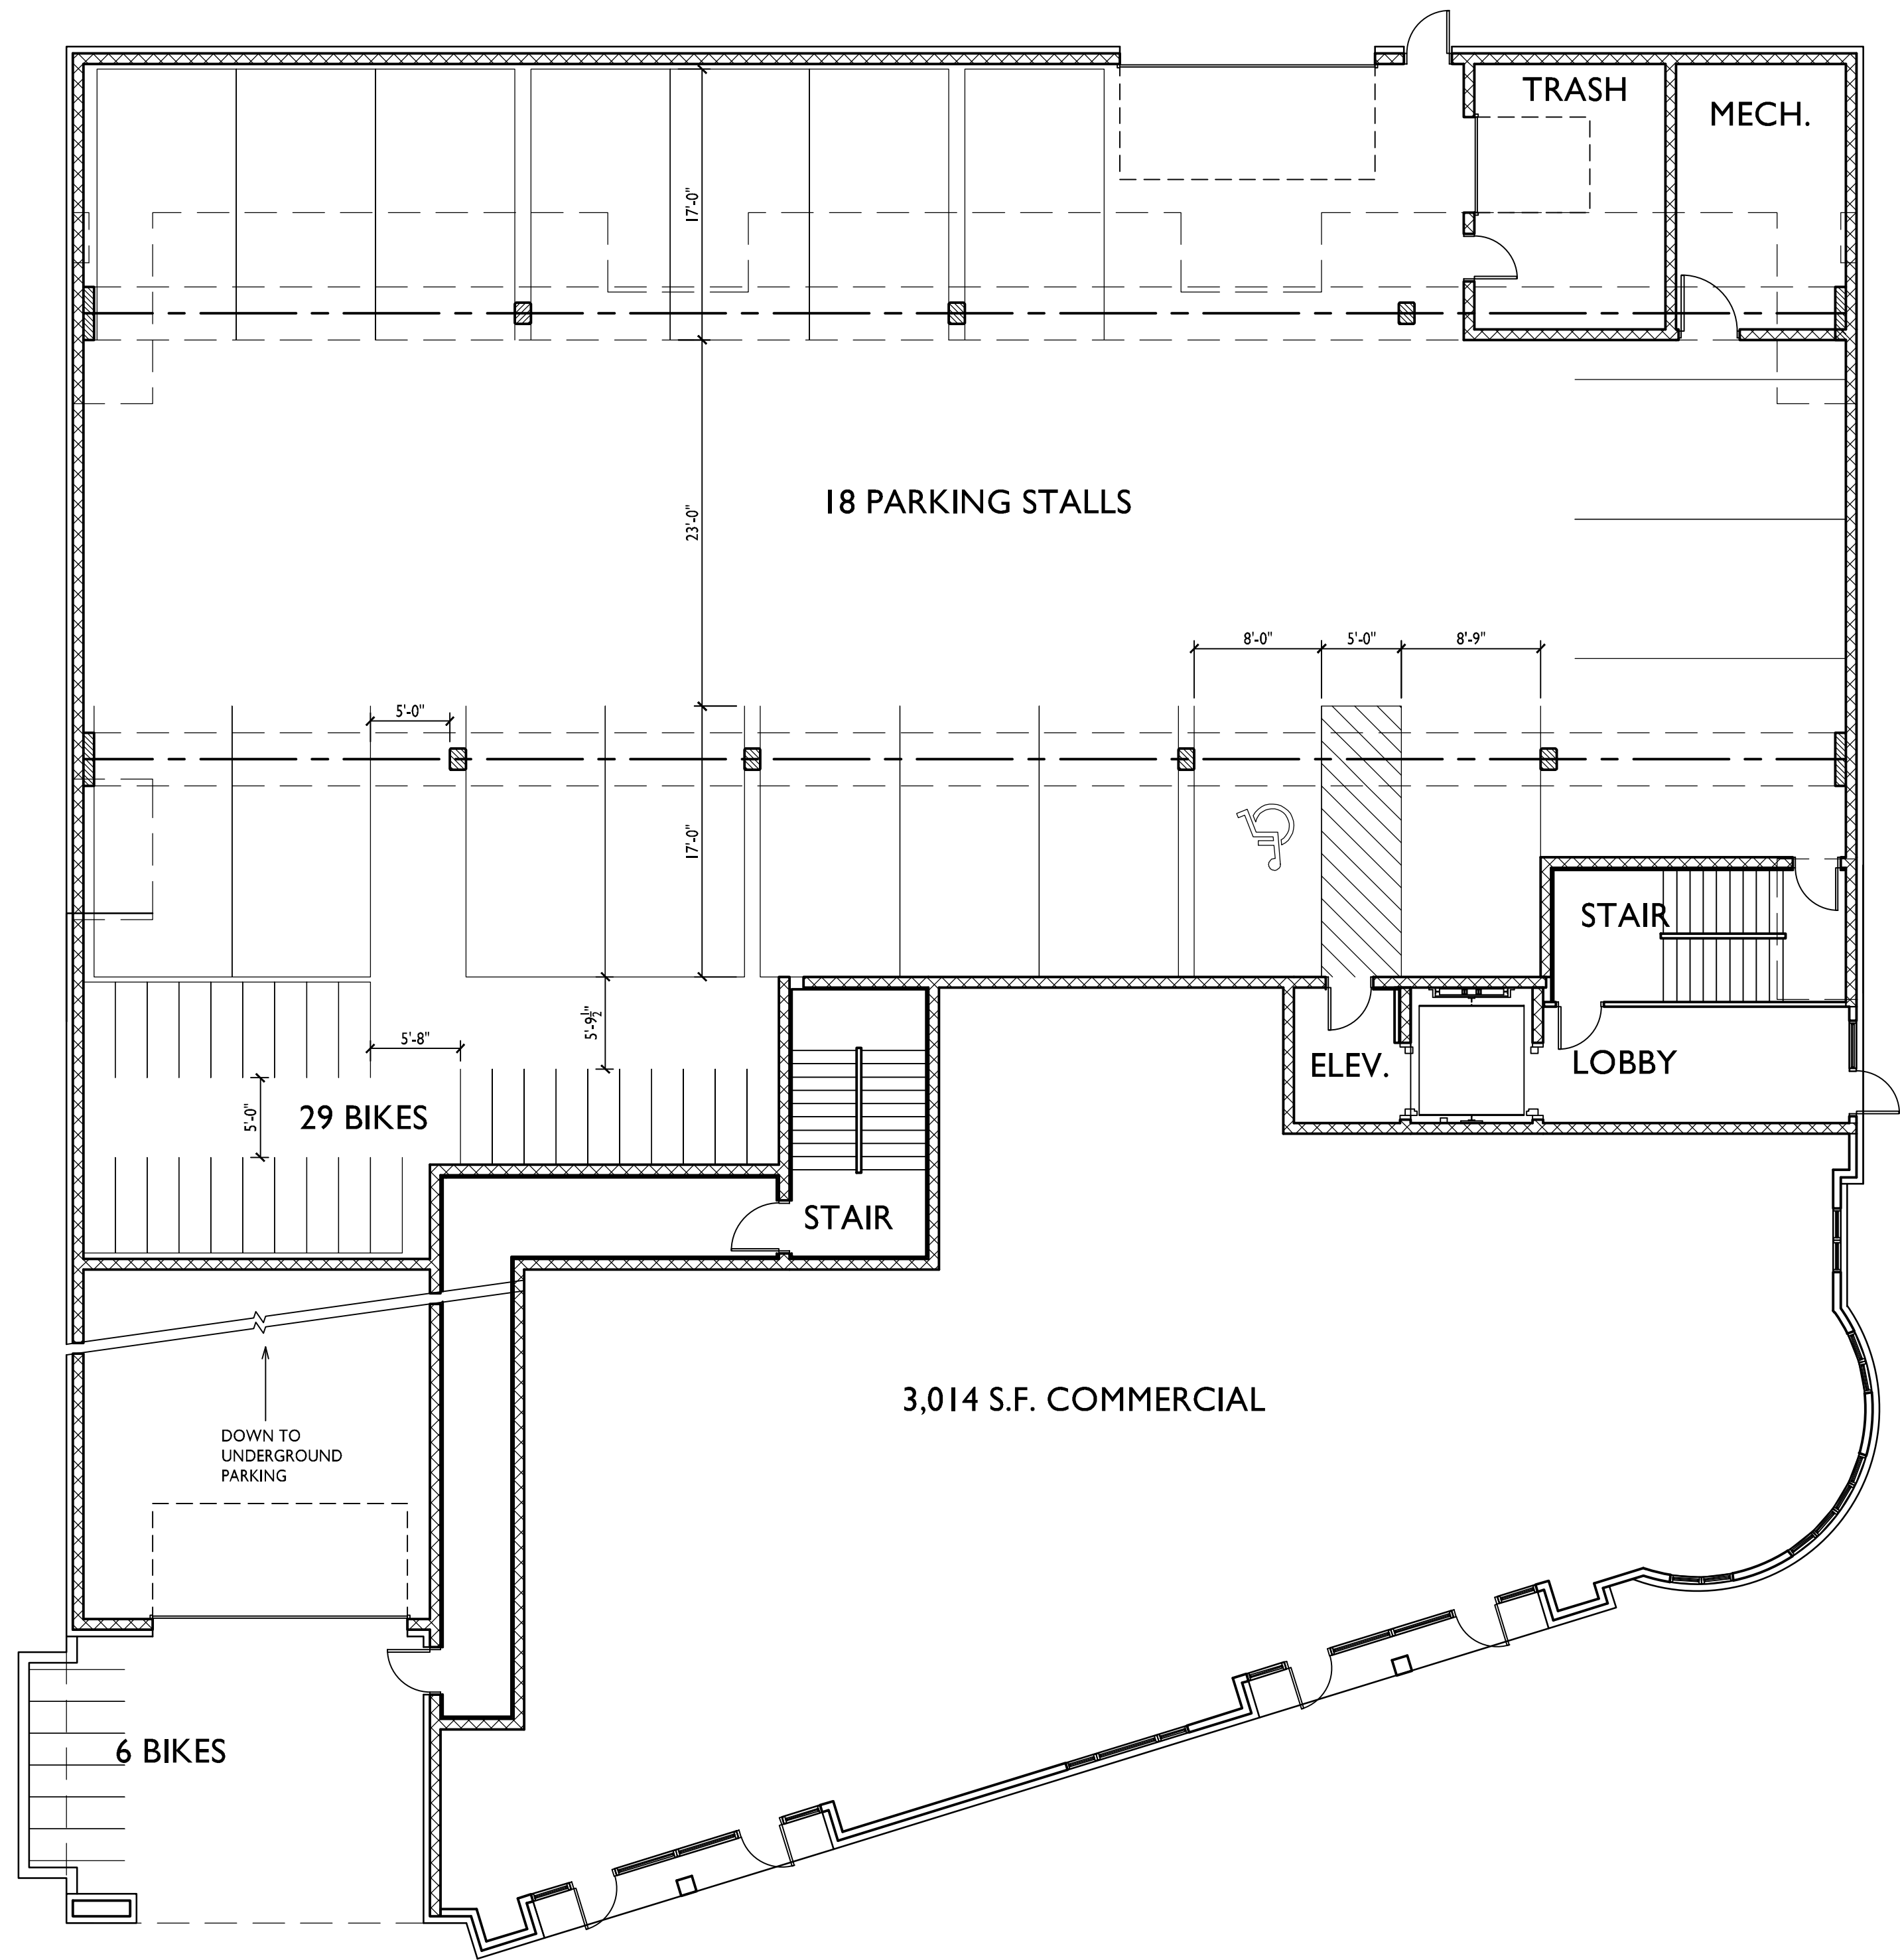

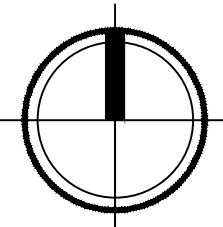

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PROJECT TITLE
KRUPP
ATWOOD
DEVELOPMENT

2158 Atwood Ave
SHEET TITLE
Second Floor Plan


SHEET NUMBER

A-1.2

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1 SECOND FLOOR PLAN
A-1.2 1/8"=1'-0"



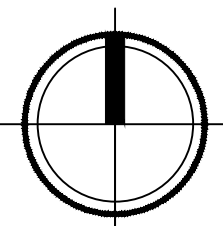

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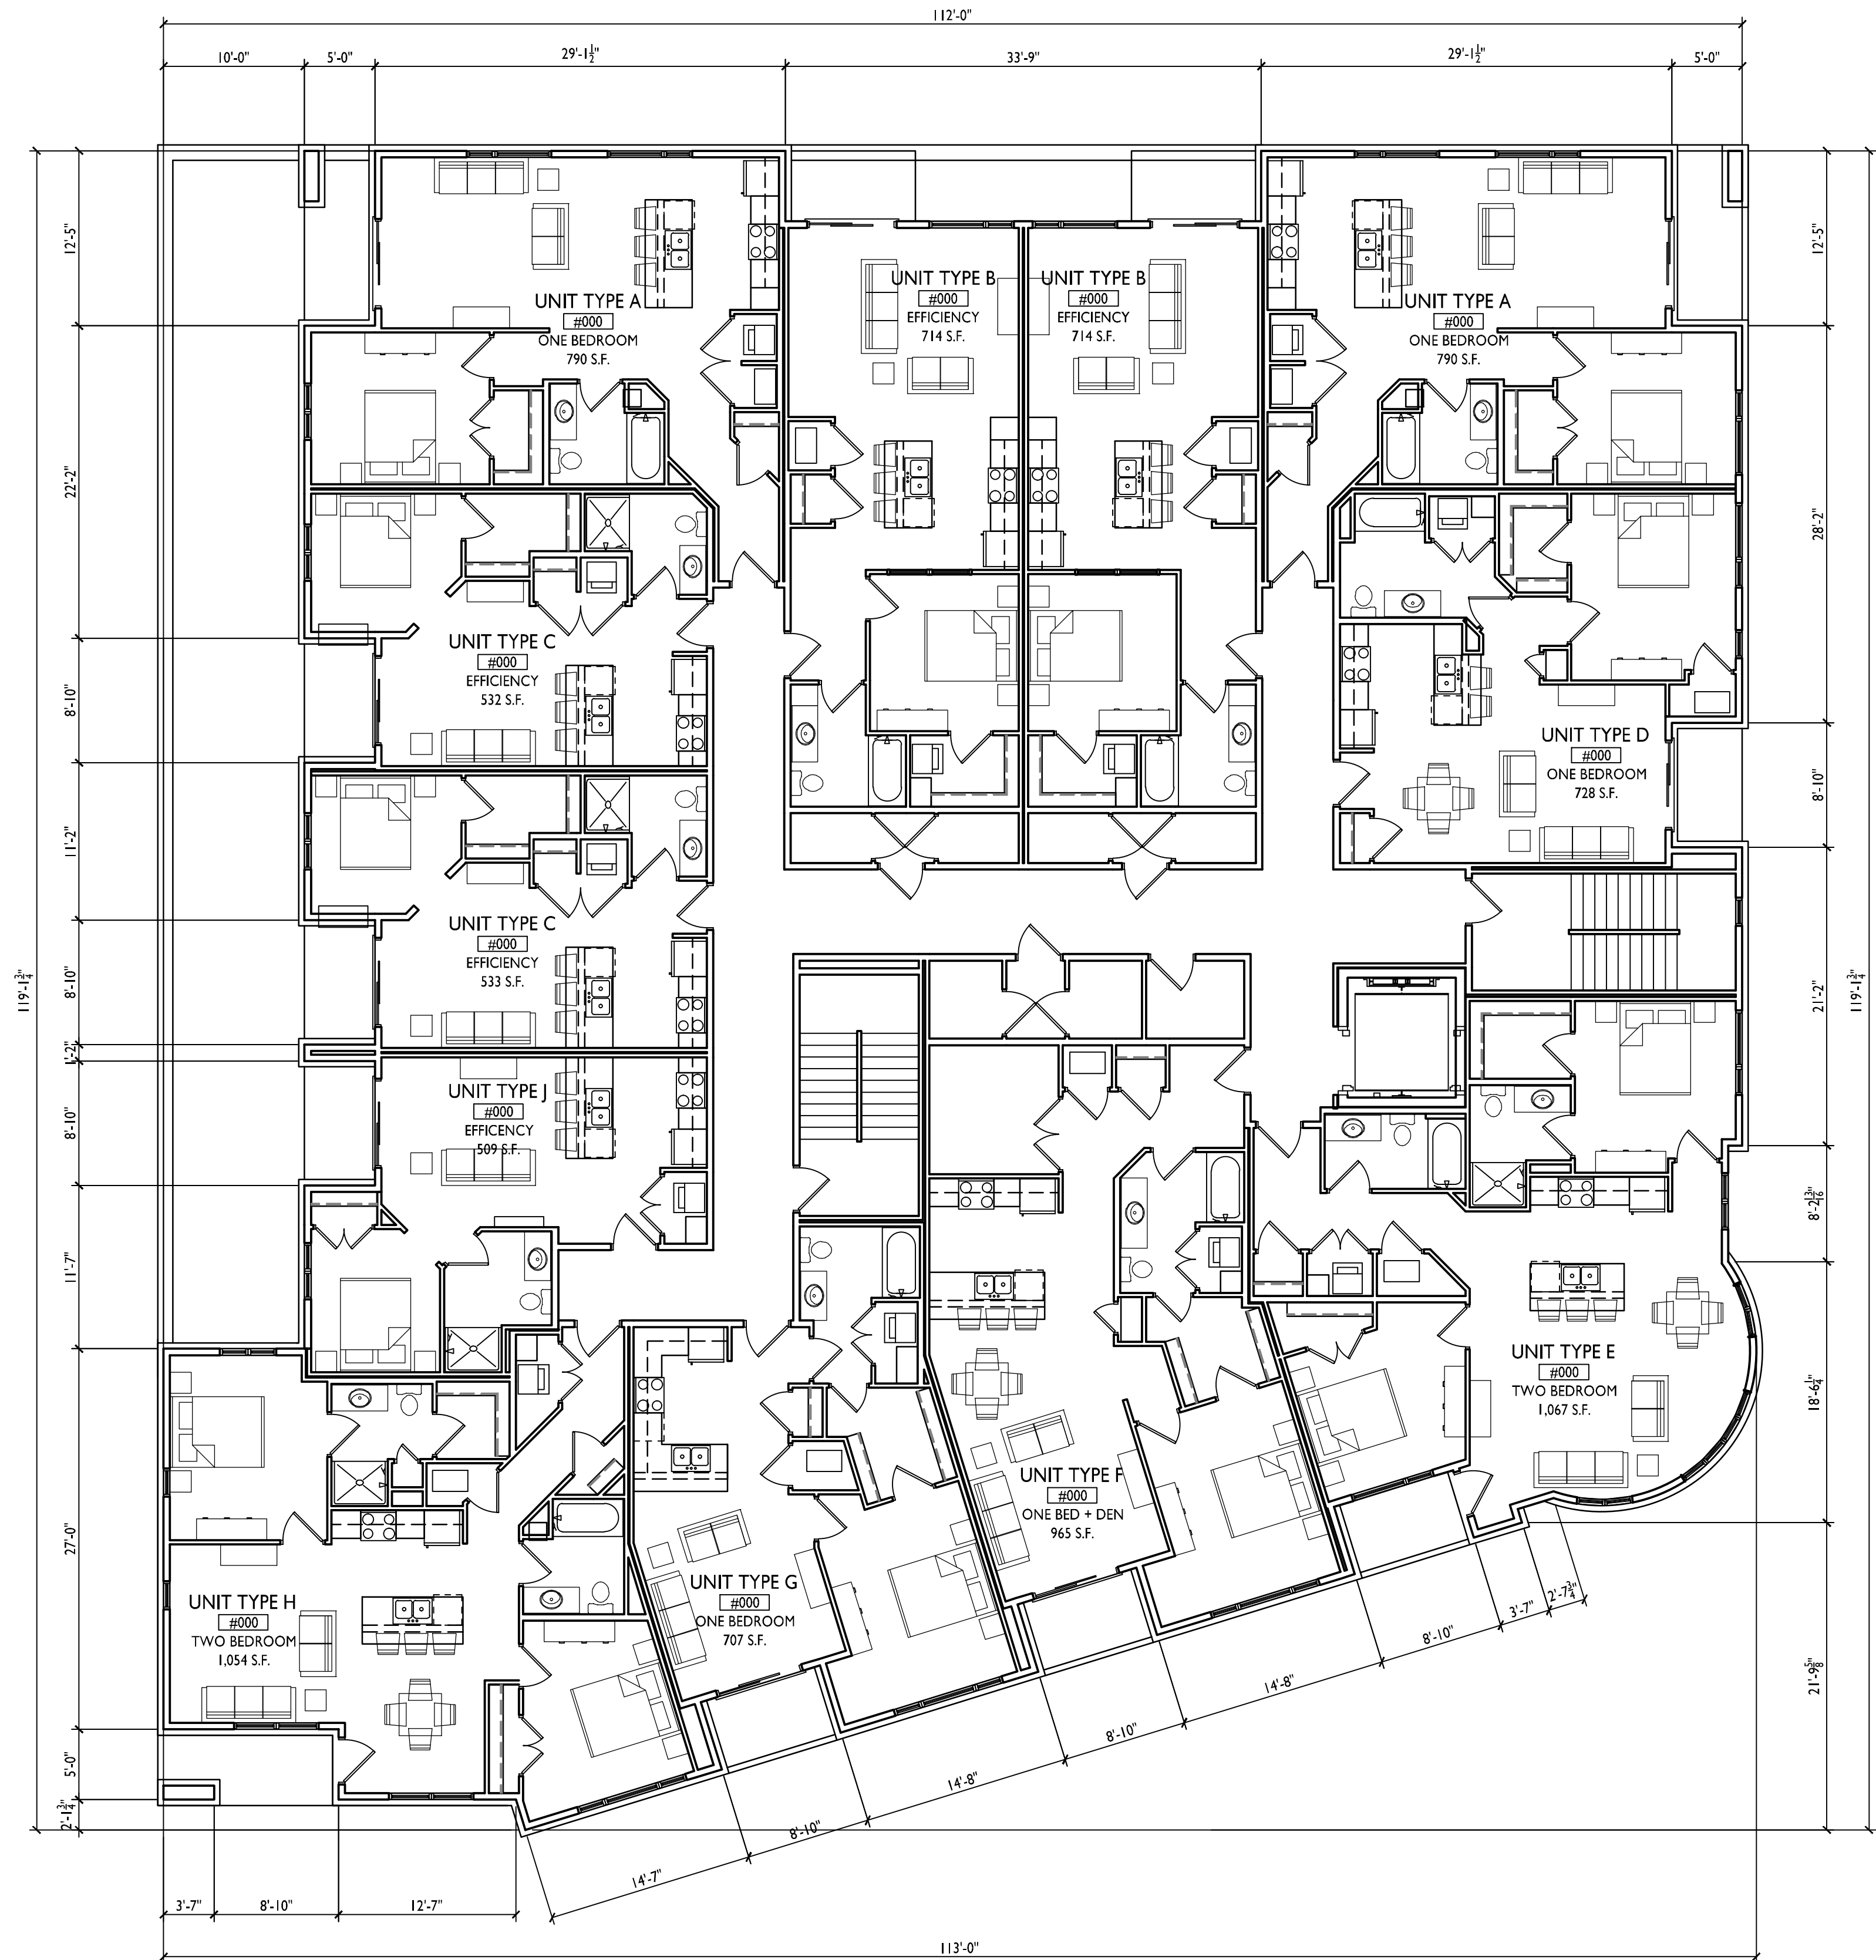
PROJECT TITLE
KRUPP
ATWOOD
DEVELOPMENT

2158 Atwood Ave
SHEET TITLE
Third Floor Plan


SHEET NUMBER

A-1.3

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1 THIRD FLOOR PLAN
A-1.3 1/8"=1'-0"



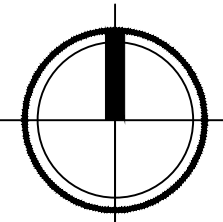

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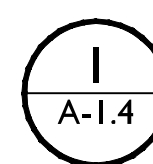
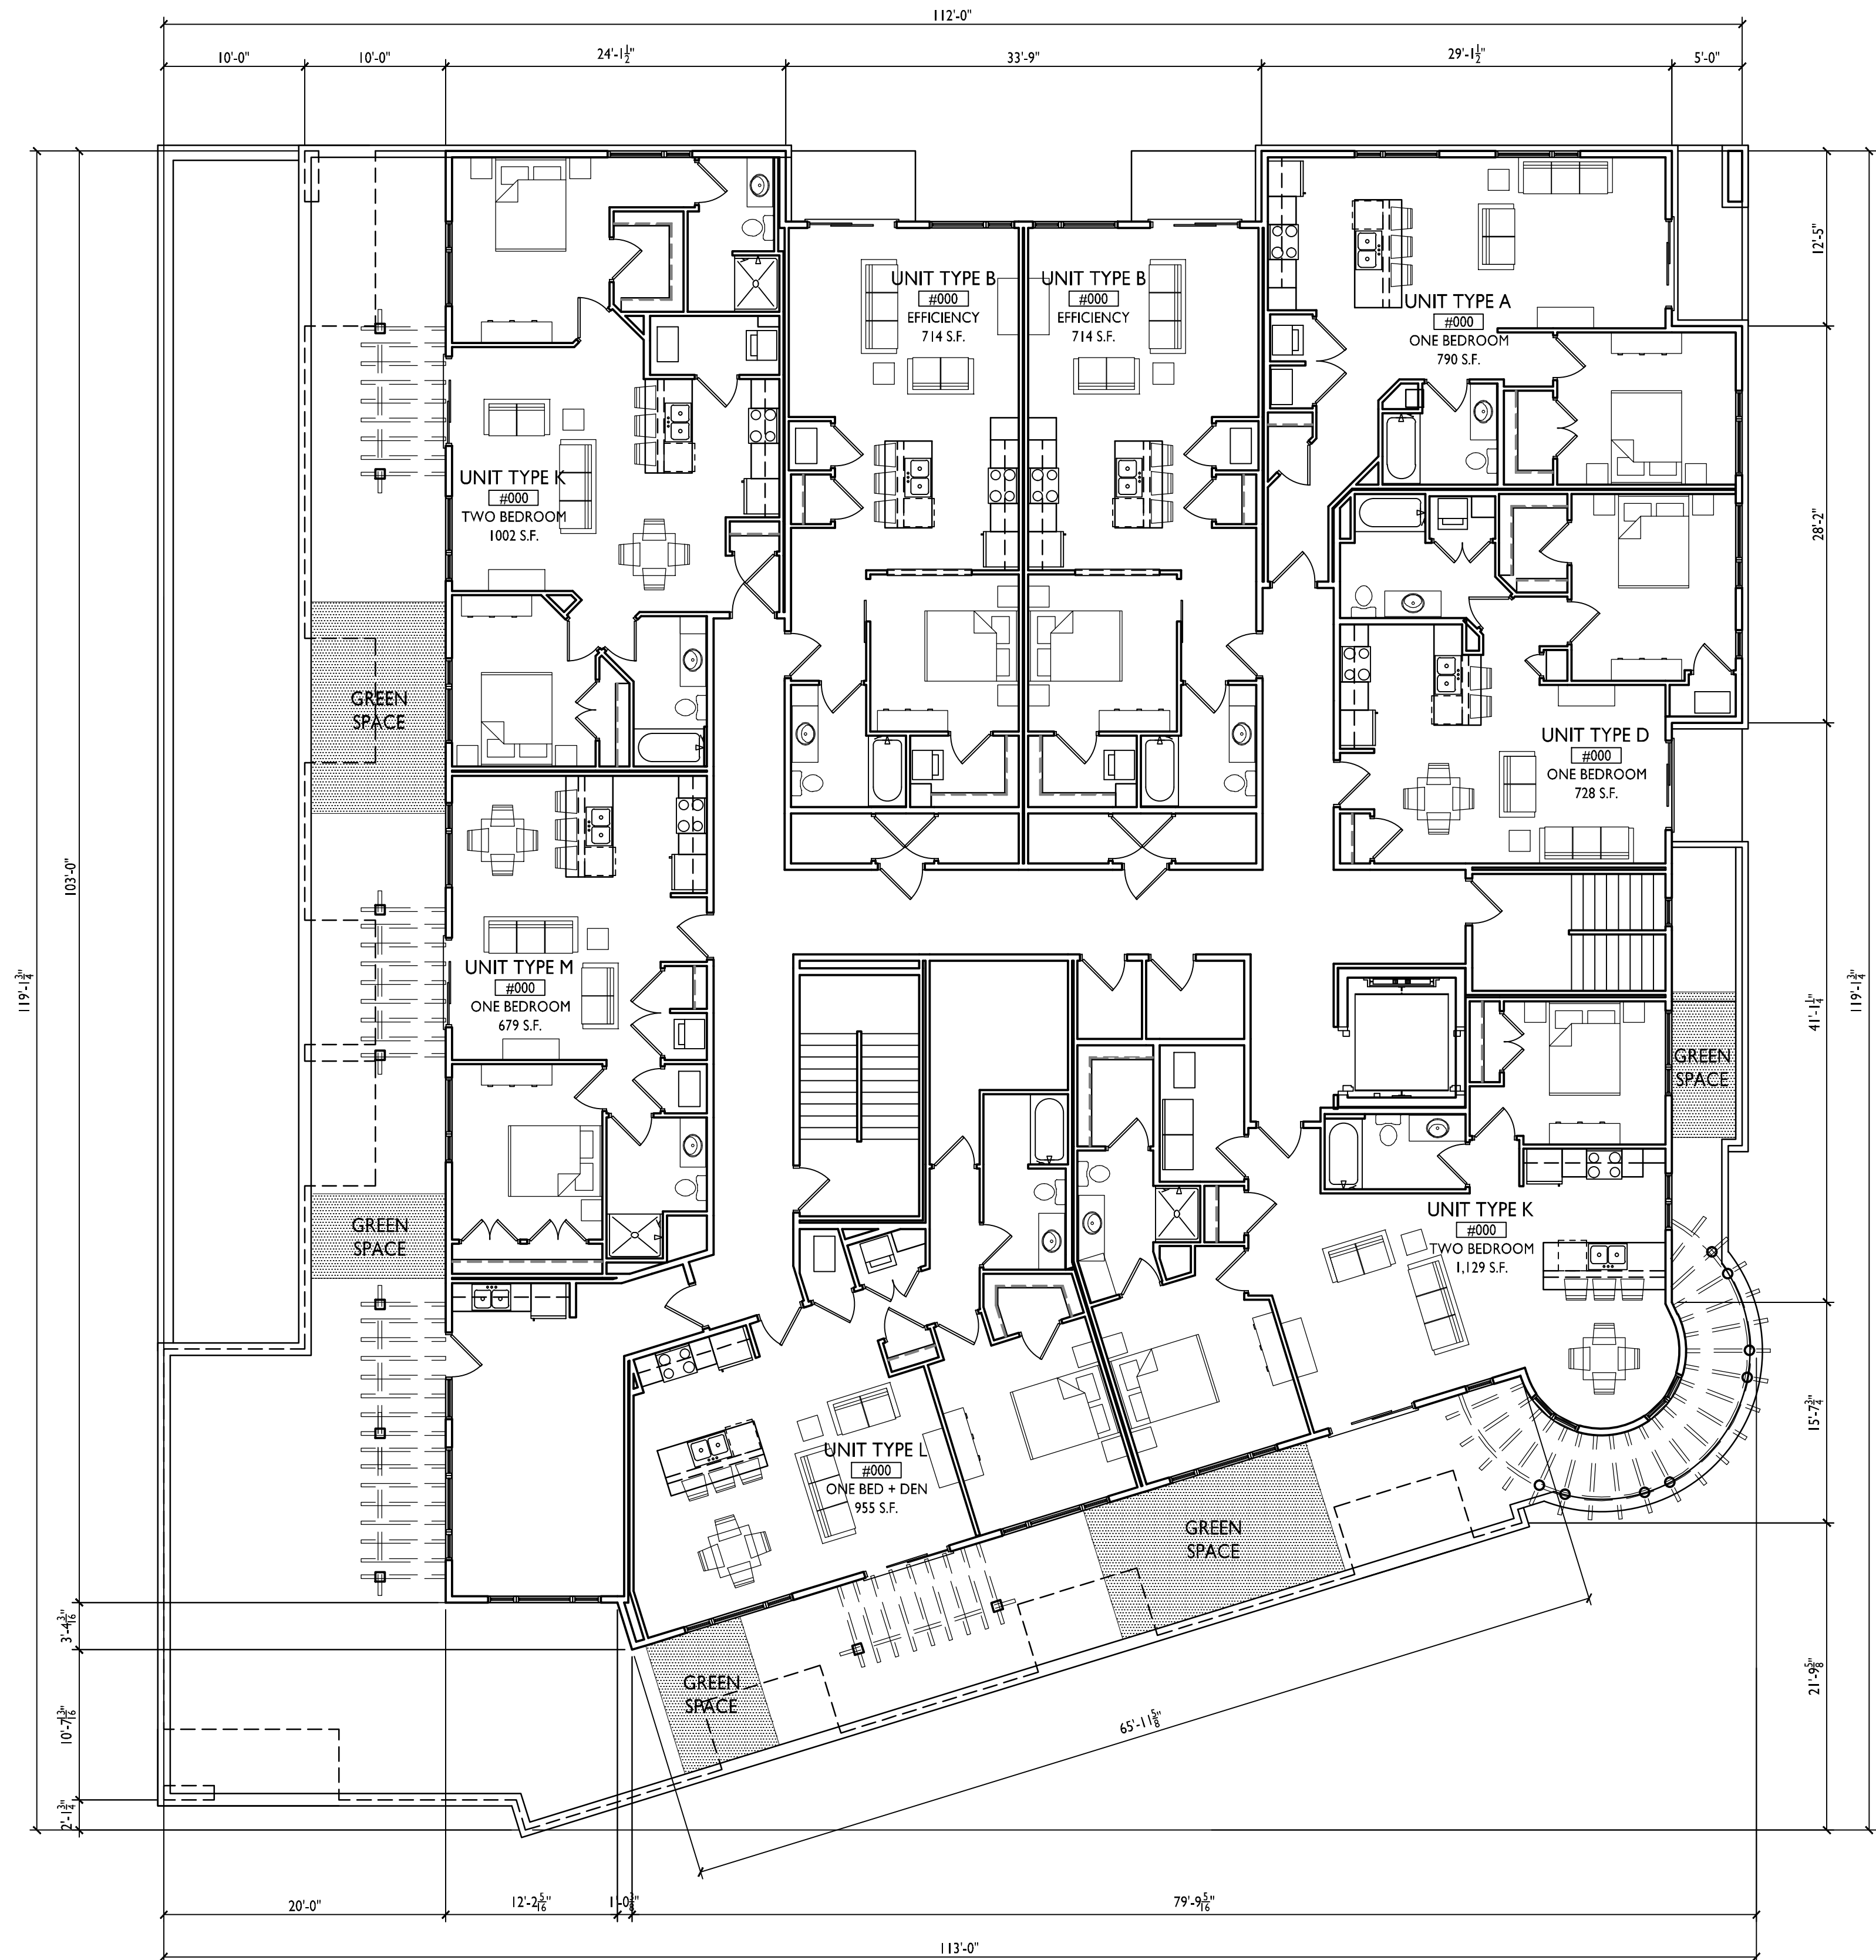
PROJECT TITLE
KRUPP
ATWOOD
DEVELOPMENT

2158 Atwood Ave
SHEET TITLE
Fourth Floor Plan

SHEET NUMBER


A-1.4

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FOURTH FLOOR PLAN

1/8"=1'-0"



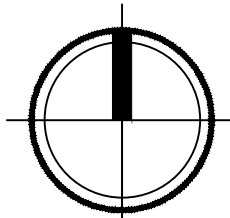

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1 SOUTH ELEVATION - ATWOOD AVE.
A-2.1 1/8"=1'-0"



2 EAST ELEVATION - DUNNING ST.
A-2.1 1/8"=1'-0"

PROJECT TITLE
KRUPP
ATWOOD
DEVELOPMENT

2158 Atwood Ave
SHEET TITLE
Exterior
Elevations

SHEET NUMBER

A-2.1
PROJECT NO. 1359
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1 NORTH ELEVATION
A-2.1 1/8"=1'-0"



2 WEST ELEVATION
A-2.1 1/8"=1'-0"

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Issued for Review - July 28, 2014

PROJECT TITLE
KRUPP
ATWOOD
DEVELOPMENT

2158 Atwood Ave
SHEET TITLE
Exterior
Elevations

SHEET NUMBER

A-2.2

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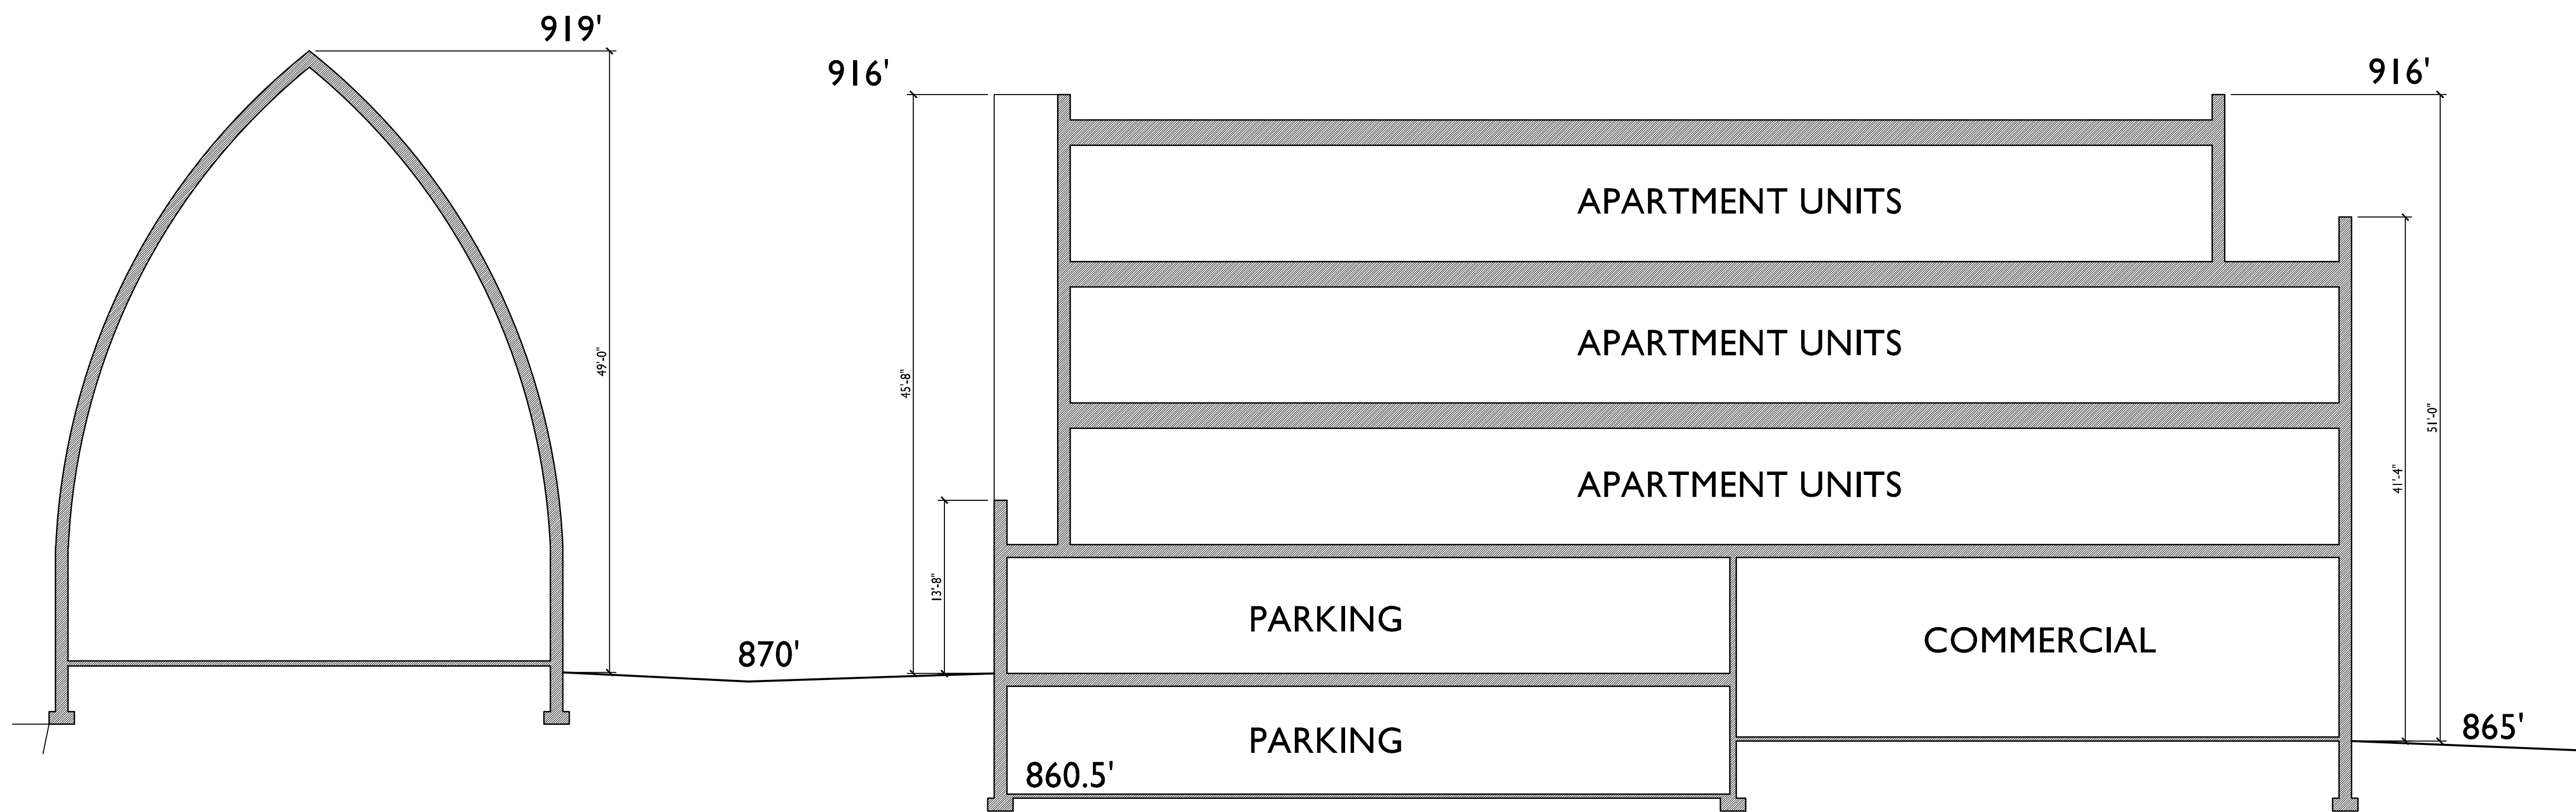
PROJECT TITLE
KRUPP
ATWOOD
DEVELOPMENT

2158 Atwood Ave
SHEET TITLE
Building Section

SHEET NUMBER

A-3.1

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I SCHEMATIC SITE SECTION
A-3.1 1/8"=1'-0"