
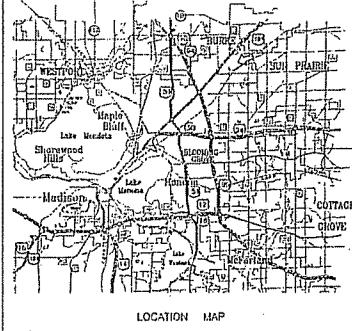


SCALE: 1" = 20'

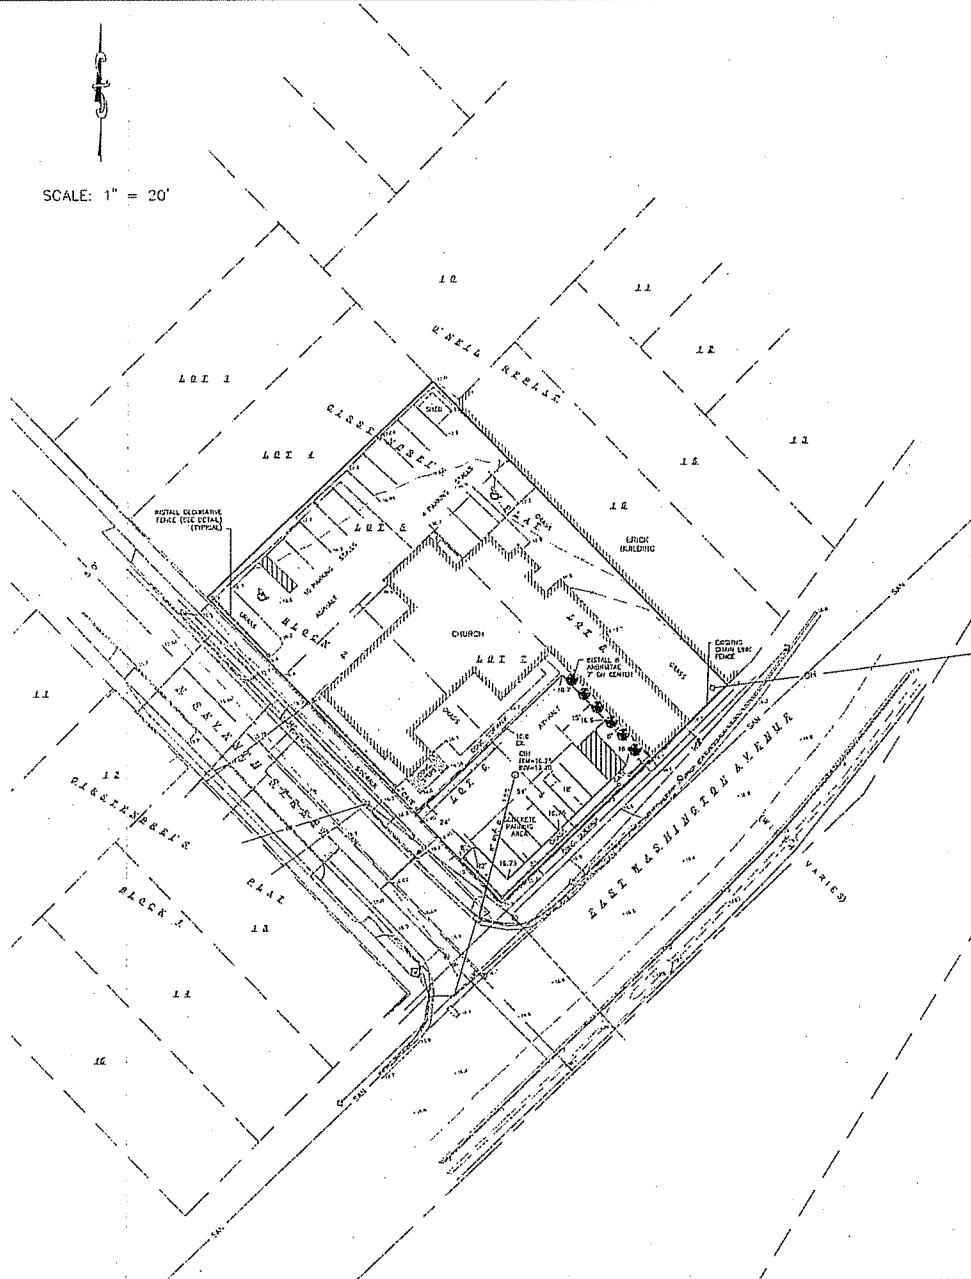

Schedule:

JULY 17, 2006

Install tilt fence and construction entrance.

JULY 18, 2006

Begin Demolition and removals.

JULY 31, 2006

Base course installed. Apply seed and mulch to all disturbed areas.

SEPTEMBER 30, 2006

Vegetation established.

2007

Parking lot construction after East Washington reconstruction completed.

Site & Erosion Control Notes/Specifications:

1. Erosion control devices and/or structures shall be installed prior to completion of the project. Erosion control measures shall be maintained for maximum effectiveness until vegetation is re-established.

2. Erosion control is the responsibility of the contractor until completion of this project. Erosion control measures as shown shall be the minimum that will be allowed. The contractor shall be responsible for recognizing and correcting all erosion control problems that are the result of construction activities. Any additional erosion control measures, as requested in writing by the state or local inspectors, or the developer's engineer, shall be installed within 24 hours.

3. All erosion control measures and structures serving the site must be inspected at least weekly or within 24 hours of the time 0.5 inches of rain is produced. All maintenance will follow an inspection within 24 hours.

4. Install Type D inlet filters in any street inlet receiving runoff from this site. Refer to WDOT Product Acceptability List at: <http://www.dot.wisconsin.gov/business/engineer/policies>

5. Erosion control devices shall adhere to the technical standards found at: <http://dnr.wi.gov/stp/water/wm/pas/stormwater/technicstd.htm> and comply with all City of Madison ordinances.

6. All debris tracked onto public streets shall be swept or scraped clean by the end of each workday.

7. All disturbed areas shall be seeded immediately after grading activities have been completed.

8. All disturbed areas, except paved areas, shall receive a minimum of four (4) inches of topsoil, fertilizer, seed, and mulch. Seed mixture shall be used on all disturbed areas in accordance with section 620 of Wisconsin D.O.T. specifications. Seed mixtures and fertilizer shall be applied at the rate of seven (7) pounds per 1,000 square feet. Mulch shall be applied at the rate of 2 tons per acre and shall be anchored into the soil by staking. Seed and fertilizer shall not be used from April 15 to September 15 of any year. Temporary seed shall be used after September 15. If temporary seeding is used, a permanent cover shall also be required as part of the final site stabilization.

9. For the first six (6) weeks after the initial stabilization of a disturbed area, watering shall be performed whenever more than seven (7) days of dry weather elapse.


10. The excess point to the project site must have a Stone Construction Entrance.

11. Parcel Size = 19,410 sq. ft.


Engineering Consultant
Spokane L. Petrichko, PE
c/o Assumption Greek Orthodox church
11 N. Seventh Street
Madison, WI 53704
(414) 291-4894 work
(202) 352-8162 cell




05/15/2006

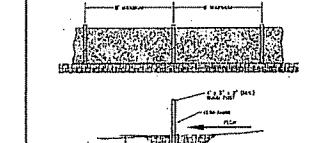

SILT FENCE CONSTRUCTION

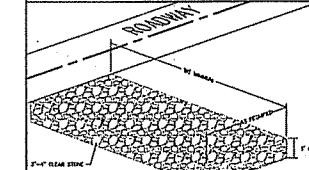

STONE CONSTRUCTION ENTRANCE

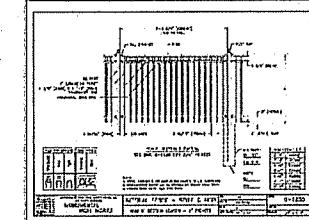

LEGEND

- 981 EXISTING MAJOR ELEVATION
- 985 EXISTING MAJOR CONTOUR
- 981 PROPOSED MAJOR CONTOUR
- 982 PROPOSED MAJOR CONTOUR
- SILT FENCE
- 1/4" SOLID RIGID PVC PIPE
- PVC PIPE, SIZE EXACTED
- PVC CRIMPED "T" IN CONCRETE
- SET HAD HAD
- 3/4" X 1" X 12' SLAB DRILL PE-PIPE SET, WT. 1.00 lb./ft.
- SPOT ELEVATION
- 1# OHV POWER LINE
- CIRCUIT GAS LINE
- 1# C1 WATER MAIN
- SAN. #1 SANITARY SEWER
- DIAL TELEPHONE
- DIALED ELECTRIC
- DIALED RADIO ACCESS TELEVISION LINE
- NATURAL GAS VALVE
- GAS VALVE
- TV BOX
- ELECTRIC BOX
- UTILITY POLE
- LIGHT POLE
- TELEPHONE POLE
- GFI RECEPT
- SITE
- STONE SEMI RAIL
- ELECTRIC MANHOLE
- TELEPHONE MANHOLE
- STONE SEWER MANHOLE
- SANITARY SEWER MANHOLE
- EXCAVATED TRENCH
- COVERED TRENCH
- DUGGED ARE
- O.P. ORIGINAL PLAT OF MADISON

AGOC DEMO & PARKING PROJECT

2502 E. WASHINGTON AVENUE

ASSUMPTION GREEK ORTHODOX CHURCH

111 N. SEVENTH STREET

MADISON, WI 53704

PROJECT #: USER02-00

PLATDATE: 05/15/2006

REVISION DATES:

ISSUE DATES:

SITE RESTORATION PLAN

Burke

Engineering and Designing, Inc.

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DRAWING NUMBER

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