


SCALE: 1/4"=1"-@"

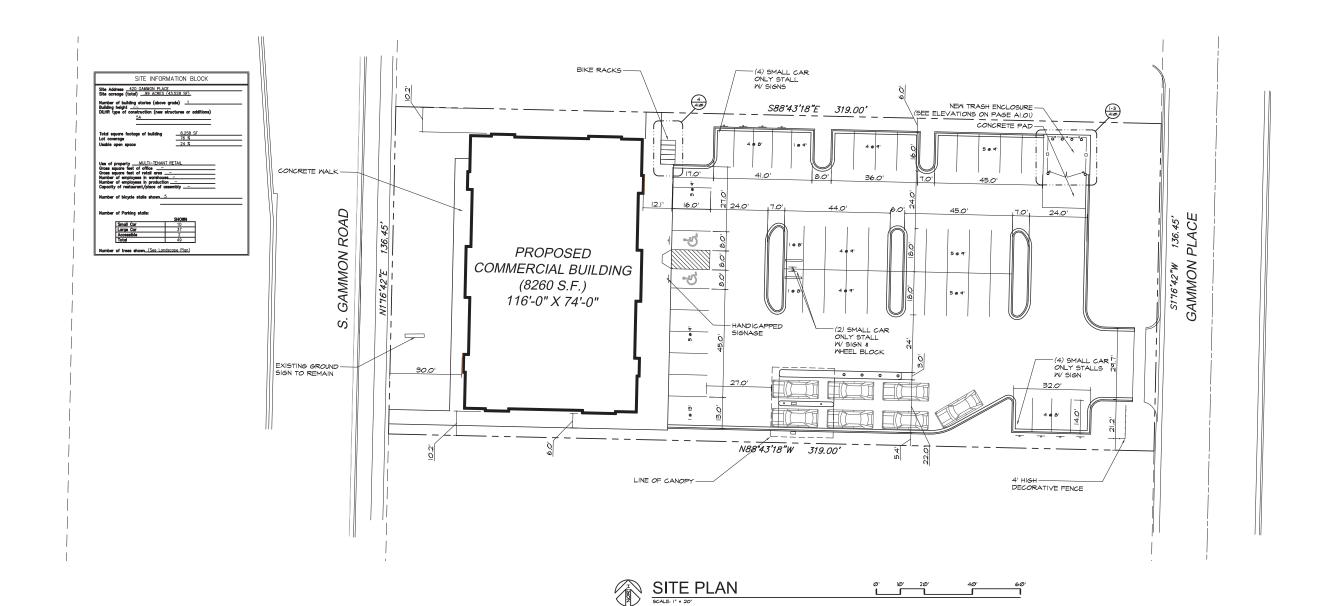

3) TRASH E

420 GAMMON PLACE
MADISON, WI 53719
CLIENT:
PARK TOWNE DEVELOPMENT
402 GAMMON PLACE, SUITE 300
MADISON, WI 53719 PROJECT:
420 GAMMON PLACE
420 GAMMON PLACE
MADISON, WI 53719

GARY BRINK & ASSOCIATES

8401 EXCELSIOR DRIVE MADISON, WI 53717 608-829-1750 608-829-3056 (FAX)


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DRAWN BY: DATE:

SCALE: AS NOTED

SITE PLAN



PROJECT:

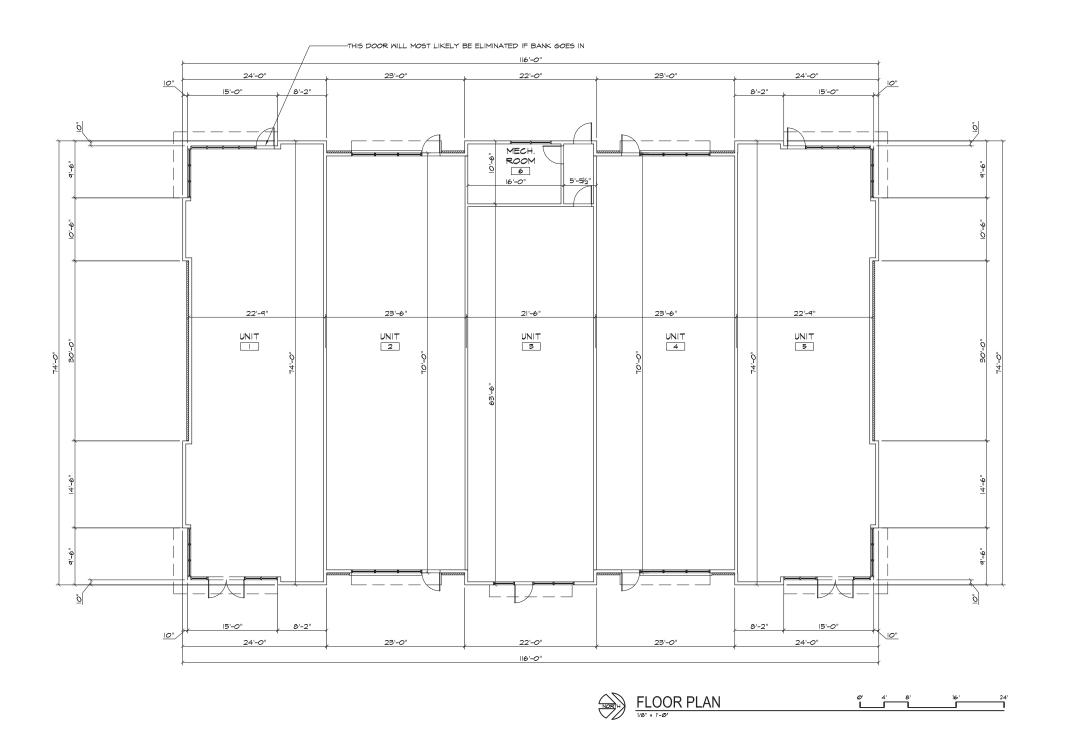420 GAMMON PLACE

420 GAMMON PLACE

420 GAMMON PLACE

MADISON, WI 53719

PARK TOWNE DEVELOPMENT

402 GAMMON PLACE, SUITE 300

MADISON, WI 53719

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PROJECT: 201211

AS NOTED

*0*5 23 2*0*13 *0*6 *.0*5 2*0*13

PROJECT: DRAWN BY: DATE:

SCALE:

PRELIMINARY SUBMITTAL

FLOOR PLAN

- GARY BRINK & ASSOCIATES ARCHITECTS
 - 8401 EXCELSIOR DRIVE MADISON, WI 53717 608-829-1750 608-829-3056 (FAX)

- $0^{\circ} \times 24^{\circ}$ LARGE FORMAT, BURNISHED ARCHITECTURAL BLACK IN STACK BOXC
- 8" WIDE FLAT FACE (TEEL FLUSH PANELS IN SILVER FINISH
- ALIMINIM COMPOSITE PANELS
- 24 GA, FRE-FNISHED STEEL FASCIA, SILVER FNISH
- CANVAS AUNING
- PRE-FNISHED COMPOSITE PANEL, ROUTE AND REVEAL IN 1-1/2" WIDE REVEAL
- 24 GA STEEL COPINS, SILVER FINISH
- 8 24" PROJECTING METAL CLAD EYEBROUG
 - ALIMNIM STOREFROIT IN CLEAR ANCOIZED FINSH, ALL GLASS



PROJECT: 420 GAMMON PLACE
420 GAMMON PLACE
AND GAMMON PLACE
MADISON, WI 53719
CLENT:
PARK TOWNE DEVELOPMENT
422 GAMMON PLACE, SUITE 300
MADISON, WI 53719

AS NOTED

65.23.263

04.05203

DRAWN BY: DATE: SCALE:

PRELIMINARY


SUBHITTAL

EXTERIOR ELEVATIONS

A6.01

- II' X 24' LARGE FORMAT, BURNISHED ARCHITECTURAL BLACK IN STACK BOND
- 2 8' UIDE FLAT FACE (TEEL FLUSH PANELS IN SILVER FINISH
 - ALIMNUM COMPOSITE PANELS
- 24 GA, PRE-PNISHED STEEL FASCIA, SILVER FINISH
- PRE-FINISHED COMPOSITE PANEL, ROUTE AND REVEAL UF I-VI'S WIDE REVEAL
- 24 GA STEEL COPINS, SILVER FINISH
- 8 24" PROJECTING METAL CLAD EYEBROUG
- ALIMINIM STOREPROIT IN CLEAR ANODIZED FINISH, ALL GLASS



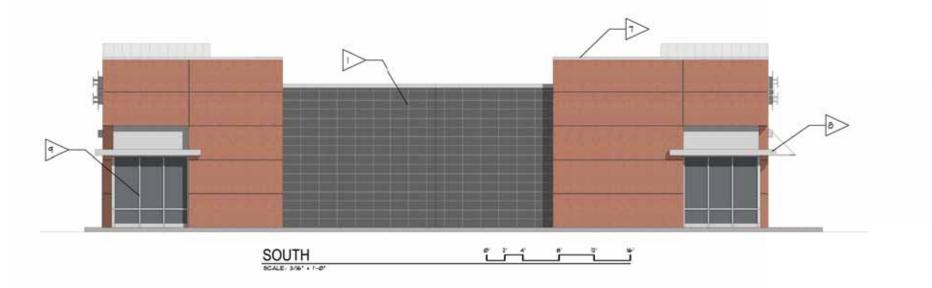



GARY BRINK & ASSOCIATES ARCHITECTS

8401 EXCELSIOR DRIVE MADISON, WI 53717 608-829-1750 608-829-3056 (FAX)

420 GAMMON PLACE
MADISON, WI 53719
CLENT:
PARK TOWNE DEVELOPMENT
402 GAMMON PLACE, SUITE 300
MADISON, WI 53719 420 GAMMON PLACE
420 GAMMON PLACE
MADISON, WI 53719


201211

PROJECT: DRAWN BY: DATE

SCALE:

AS NOTED PRELIMINARY 65.23.263 SUBHITTAL 04.05203

> EXTERIOR **ELEVATIONS**

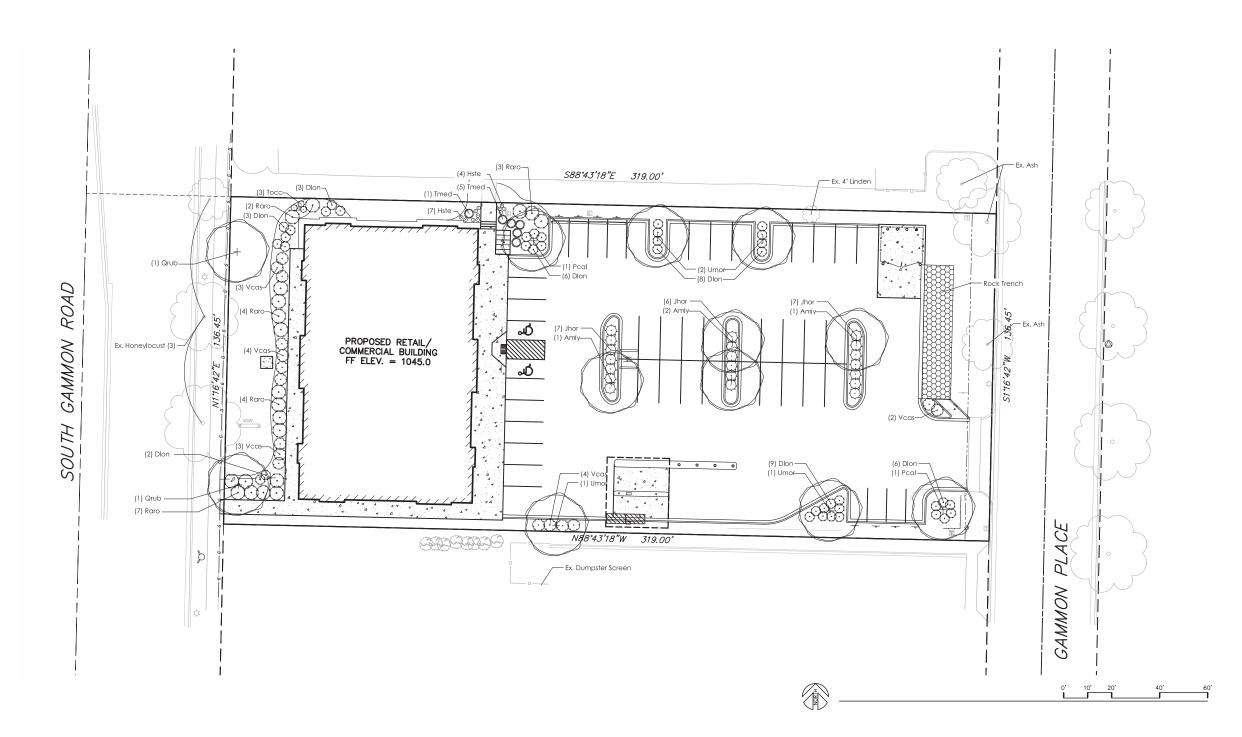

			Plant List			
key	qty.	botanical name	common name	planting size	root cond.	mature size
			shade trees			
Amiy	4	Acer miyabei 'Morton'	State Street Maple	2.5" cal.	B&B	50' x 40'
Pcal	2	Pyrus calleryana 'Cleveland Select'	Cleveland Select Pear	2.5" cal.	B&B	35' x 15'
Qrub	2	Quercus rubra	Red Oak	2.5" cal.	B&B	wi native
Umor	4	Ulmus 'Morton Glossy'	Triumph Elm	2.5" cal.	B&B	55' x 45'
						•
			deciduous shrubs			
Olon	37	Diervilla lonicera	Dwarf Bush-Honeysuckle	#5	cont.	3' x 4'
Raro	20	Rhus aromatica 'Gro-low'	Gro-low Sumac	#5	cont.	30" x 6'
Vcas	16	Viburnum cassinoides	Witherod Viburnum	#5	cont.	4' x 5'
			evergreen shrubs			
Jhor	20	Juniperus horizontalis 'Wisconsin'	Wisconsin Juniper	#5	cont.	8" x 5'
ſmed	6	Taxus x media 'Everlow'	Everlow Yew	#5	cont.	30" x 4'
Госс	3	Thuja occidentalis 'Holmstrup'	Holmstrup Arb	5' ht.	cont.	14' x 3'
		•	•	•	•	•
			perennials			
Iste	11	Hemerocallis 'Stella d'Oro'	Stella D'Oro Daylily	#1	cont.	18" x 18"

LANDSCAPING REQUIREMENTS: CITY OF MADISON

Total Developed Area: 43,527.6 SF Developed Area / 300 SF= 145.1 Landscape Units Landscape Units x 5 landscape points = 725.5 Total Points Required

Credit for Existing Landscape: 105 Points

Overstory Deciduous Tree: 3 x 35 points = 105

Total for Proposed Landscape: 675 Points

12 x 35 points = 420 Overstory Deciduous Tree: 0 x 15 points = 0 0 x 15 points = 0 Ornamental Tree: Evergreen Tree: Deciduous Shrub 73 x 2 points = 146 29 x 3 points = 87 11 x 2 points = 22 Evergreen Shrub: Perennial:

Total Points Provided: 780 Points

GENERAL NOTES:

- 1. All plantings shall conform to quality requirements as per ANSI Z60.1.
- 2. All plant material shall be true to the species, variety and size specified, nursery grown in accordance with good horticultural practices, and under climactic conditions similar to those of the project site.
- 3. Contact Landscape Architect, in writing, to request and plant material substitutions due to availability issues.
- 4. All disturbed areas, unless otherwise noted, to be seeded with Madison Parks Mix by Olds Seed Company or equivalent, per manufacturer's specified application rates. All seeded areas are to be watered daily to maintain adequate soil moisture for proper germination. After vigorous growth is established, apply $\frac{1}{2}$ " water twice weekly until final acceptance. **5.** All plants shall be guaranteed to be in healthy and flourishing condition during the growing season
- following installation. All plant material shall be guaranteed for one year from the time of installation.
- 6. Contractor shall provide a suitable amended topsoil blend for all planting areas where soil conditions are unsuitable for plant growth. Topsoil shall conform to qualify requirements as per Section 625.2(1) of the Standard Specifications for Highway Construction. Provide a minimum of 12" of topsoil in all planting areas and 6" of topsoil in areas to be seeded/sodded.
- 7. Landscape beds to be mulched with undyed shredded hardwood bark mulch to 3" depth min.
- 8. Landscape beds to be edged with black vinyl edging, Black Diamond or equal.
- 9. Protect existing trees from damage due to construction activity.



GARY BRINK & ASSOCIATES ARCHITECTS

8401 EXCELSIOR DRIVE MADISON, WI 53717 608-829-1750 608-829-3056 (FAX)



vierbicher

PROJECT:
420 GAMMON PLACE
420 GAMMON PLACE
420 GAMMON PLACE
MADISON, WI 53719
CLIENT:
PARK TOWNE DEVELOPMENT
402 GAMMON PLACE, SUITE 300
MADISON, WI 53719

PROJECT: 201211 DRAWN BY: DATE: SCALE: AS NOTED PRELIMINARY 06.05.2013

> LANDSCAPE PLAN

L1.0

PROPOSED COMMERCIAL BUILDING

FOR



420 GAMMON PLACE MADISON, WI 53719

CONCEPTUAL RENDERING



SHEET INDEX

COVER SHEET & PROJECT CONTACTS

CIVII C1.0 **EXISTING CONDITIONS**

DEMOLITION PLAN C2.0

CONSTRUCITON DETAILS C5.0

C7.0 CONSTRUCITON DETAILS

ARCHITECTURAL

SITE PLAN AND DETAILS

FLOOR PLAN A2.01

OWNER:

PARK TOWNE DEVELOPMENT

402 GAMMON PLACE, SUITE 300

MADISON, WI 53719 PHONE: 608.833.9044 FAX: 608.833.1792 CONTACT: MIKE RING EMAIL: miker@parktowne.com

ARCHITECT:

GARY BRINK & ASSOCIATES, INC.

8401 EXCELSIOR DRIVE MADISON, WISCONSIN 53717

PHONE: 608,829,1750 FAX: 608.829.3056 CONTACT: GARY BRINK EMAIL: gary@garybrink.com

CIVIL ENGINEER: VEIRBICHER

999 FOURIER DRIVE, SUITE 201 MADISON, WISCONSIN 53717

PHONE: 608.826.0532 FAX: 608.826.0530

CONTACT: JEFFREY QUAMME EMAIL: jqua@vierbicher.com

LANDSCAPE ARCHITECT: **VEIRBICHER**

999 FOURIER DRIVE, SUITE 201 MADISON, WISCONSIN 53717 PHONE: 608.826.0532

FAX: 608.826.0530 CONTACT: SUZANNE VINCENT EMAIL: svin@vierbicher.com

GENERAL CONTRACTOR: ENGINEERED CONSTRUCTION

525 COMMERCE PARKWAY VERONA, WI 53593 PHONE: 608.845.7930 CONTACT: DAVE LOMBARDO

PROJECT LOCATION (



GENERAL PROJECT NOTES:

1. THE CONTRACTORS SHALL REVIEW THE DRAWING(S), SPECIFICATIONS (WHEN INCLUDED) AND UNDERSTAND THE SCOPE OF THE DRAWINGS TO BE THE FOLLOWING: THE DOCUMENTS (DRAWINGS, SPECIFICATIONS, ADDENDUMS, ETC.) INDICATE THE GENERAL SCOPE OF THE PROJECT IN TERMS OF ARCHITECTURAL DESIGN CONCEPTS, THE DIMENSION OF THE BUILDING, THE MAJOR ARCHITECTURAL ELEMENTS AND THE MAJOR STRUCTURAL ELEMENTS AND SYSTEMS. THE DOCUMENTS DO NOT AND ARE NOT INTENDED TO INDICATE OR DESCRIBE ALL THE WORK REQUIRED FOR FULL PERFORMANCE OF, AND COMPLETION OF THE REQUIREMENTS OF THE CONTRACT. ON THE BASIS OF THE GENERAL SCOPE INDICATED OR DESCRIBED HEREIN, THE CONTRACTOR AND CONTRACTOR'S SUB-CONTRACTORS SHALL FURNISH ALL ITEMS REQUIRED FOR THE PROPER EXECUTION AND COMPLETION OF THE

2. THE CONTRACTOR SHALL NOTIFY THE ARCHITECT IMMEDIATELY OF ANY DISCREPANCIES OR OMISSIONS ENCOUNTERED. NO ADDITIONAL COMPENSATION WILL BE CONSIDERED FOR ITEMS THAT WERE VISIBLE OR COULD HAVE BEEN ANTICIPATED AT TIME OF BID. THE CONTRACTOR SHALL FOLLOW AND OBEY ALL FEDERAL, STATE AND LOCAL CODES LAWS, SAFETY REGULATIONS, ACCESSIBILITY/ADA AND HAZARDOUS WASTE LAWS, ETC. THE WORK SHALL BE PERFORMED IN AN INDUSTRY APPROVED, WORKMANLIKE MANNER.
GENERAL CONTRACTOR SHALL OBTAIN, PROCURE AND PAY FOR ALL PERMITS, LICENSES,
AND INSPECTION FEES AND SHALL COMPLY WITH REQUIREMENTS OF LICENSING AGENCIES. TEMPORARILY BRACE THE STRUCTURE AS REQUIRED TO MAINTAIN STRUCTURAL INTEGRITY UNTIL THE WORK IS COMPLETE AND FUNCTIONING PER THE DESIGN INTENT IN ACCORDANCE WITH THE GENERALLY ACCEPTED CONSTRUCTION PRACTICES,. CONTRACTOR WILL BE SOLELY AND COMPLETELY RESPONSIBLE FOR THE CONDITIONS OF THE JOB SITE, INCLUDING SAFETY OF ALL PERSONS AND PROPERTY DURING THE PERFORMANCE OF THE WORK. THIS REQUIREMENT WILL APPLY CONTINUOUSLY AND NOT BE LIMITED TO NORMAL WORKING

3. THESE DRAWINGS AND SPECIFICATIONS (WHEN INCLUDED) FROM ALL DISCIPLINES ARE COOPERATIVE AND COMPLEMENTARY AND WORK TOGETHER AS A WHOLE. NO DISCIPLINES' DOCUMENTS CONTAIN ALL OF THE REQUIRED INFORMATION FOR ANY ONE TRADE. ALL CONTRACTORS & SUPPLIERS WILL NEED TO CROSS REFERENCE THE DOCUMENTS OF VARIOUS DISCIPLINES TO GAIN COMPLETE UNDERSTANDING OF ALL WORK REQUIRED FOR

1 THE PROJECT.

4. THE DRAWINGS, SPECIFICATIONS, ADDENDUMS, ETC. INDICATE WHAT IS TO BE INCLUDED IN THE BASE BID. MODIFICATIONS FROM THE CONTRACT DOCUMENTS SHOULD BE INDICATED AS AN ALTERNATE AND SHOULD INCLUDE THE EXTRA COST OR CREDIT ASSOCIATED WITH THE MODIFICATION AS WELL AS ANY OTHER PERTINENT INFORMATION SUCH AS REQUIRED TIME EXTENSIONS, MODIFICATIONS REQUIRED TO ANOTHER TRADES SCOPE DUE TO THE PROPOSED MODIFICATION, ETC.

5. ALL MECHANICAL, ELECTRICAL, PLUMBING, FIRE PROTECTION, FIRE ALARM ARE TO HAVE A SERVICE CENTER LOCATED WITHIN A 100 MILE RADIUS OF THE JOB SITE. IT IS THE RESPONSIBILITY OF EACH RESPECTIVE TRADE TO ENSURE ALL ASPECTS OF WORK COMPLY WITH ALL APPLICABLE LAWS, COVENANTS, CODES ORDINANCES, RULES, REGULATIONS, RESTRICTIONS, ETC. WHICH IMPACT THE USE OF THE FACILITY.

6. PRODUCT DATA AND/OR SHOP DRAWINGS SHALL BE SUBMITTED TO TENANT/ARCHITECT FOR APPROVAL ON ALL FINISHES & FURNISHING.

C3.0 SITE UTILITY PLAN

C4.0 GRADING AND EROSION CONTROL PLAN

CONSTRUCITON DETAILS

L1.0 LANDSCAPE PLAN

A1 01

BUILDING ELEVATIONS A6 01

BUILDING ELEVATIONS

GARY BRINK & ASSOCIATES

ARCHITECTS

8401 EXCELSIOR DRIVE MADISON, WI 53717 608-829-1750 608-829-3056 (FAX)

TOWNE DEVELOPMENT **GAMMON PLACE**


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201211

PROJECT: DRAWN BY DATE

AS NOTED SCALE

> **COVER SHEET** AND PROJECT CONTACTS



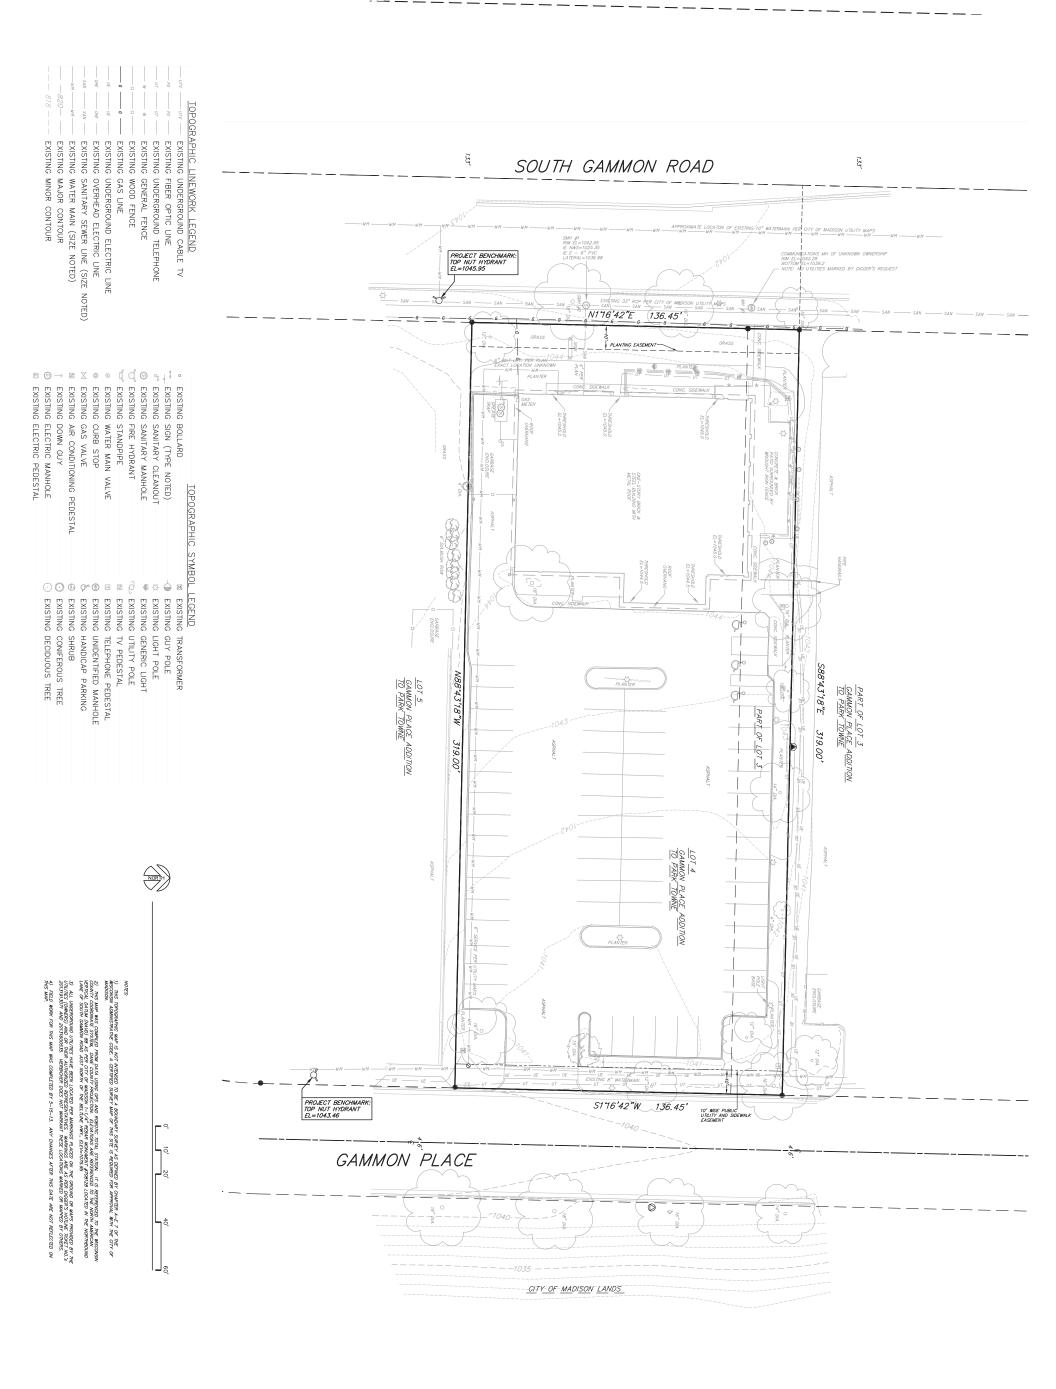

DRAWN BY: DATE: DEHL

420 GAMMON PLACE
420 GAMMON PLACE
420 GAMMON PLACE
MADISON, WI 53719
CLIENT:





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8401 EXCELSIOR DRIVE MADISON, WI 53717 608-829-1750 608-829-3056 (FAX)



PROJECT:
420 GAMMON PLACE
420 GAMMON PLACE
MADISON, WI 33719 JISON, ENT: ARK CAMMON P

TOWNE DEVELOPMENT


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PROJECT: 201211 DRAWN BY: DEHL AS NOTED SCALE:

PRELIMINARY 06.05.2013

DEMOLITION PLAN




ABBREVIATIONS STMH — STORM MANHOLE FI — FIELD INLET CI — CURB INLET CB — CATCH BASIN EW — ENDWALL SMH — SANITARY MANHOLE

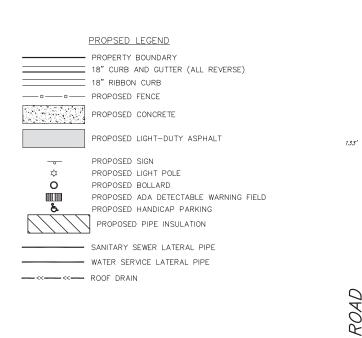

CALL DIGGER'S HOTLINE 1-800-242-8511 TOLL FREE TELEFAX: 1-800-338-3860 TDC (FOR HEARING IMPAIRED):
1-800-542-2289
WIS. STATUTE 182.0175 (1979)
REQUIRES MINIMUM OF 3 WORKING DAYS
NOTICE BEFORE YOU EXCAVATE.

SITE AND UTILITY NOTES:

- 1. A COPY OF THE APPROVED UTILITY PLANS, SPECIFICATIONS AND PLUMBING PERMIT APPROVAL LETTER SHALL BE ON-SITE DURING CONSTRUCTION AND OPEN TO INSPECTION BY AUTHORIZED REPRESENTATIVES OF DSPS AND OTHER LOCAL INSPECTORS.
- 2. PRIVATE SANITARY SEWER AND LATERALS SHALL BE POLYVINYL CHLORIDE (PVC) ASTM_D3034 SDR 35 OR APPROVED EQUAL MATERIAL THAT CONFORMS TO
- 3. A MEANS TO LOCATE BURIED UNDERGROUND EXTERIOR NON METALLIC SEWERS/MAINS AND WATER SERVICES/MAINS MUST BE PROVIDED WITH TRACER WIRE OR OTHER METHODS IN ORDER TO BE LOCATED PER SPS 382.
- 4. EXTERIOR WATER SUPPLY PIPING SETBACKS AND CROSSINGS SHALL BE IN
- 5. NO PERSON MAY ENGAGE IN WORK AT PLUMBING IN THE STATE UNLESS LICENSED TO DO SO.
- 6. SITE CONTRACTOR SHALL LEAVE SANITARY AND WATER LATERALS FIVE (5) FEET SHORT (HORIZONTALLY) FROM THE BUILDING. BUILDING PLUMBER SHALL VERIFY SIZE AND EXACT LOCATION OF PROPOSED SANITARY AND WATER
- 7. CONTRACTOR SHALL FIELD VERIFY THE SIZE, TYPE, LOCATION, AND ELEVATION OF EXISTING UTILITIES PRIOR TO INSTALLING ANY ON—SITE UTILITIES OR STRUCTURES. CONTACT ENGINEER PRIOR TO INSTALLATION IF DISCREPANCY EXISTS WITHIN THESE PLANS.

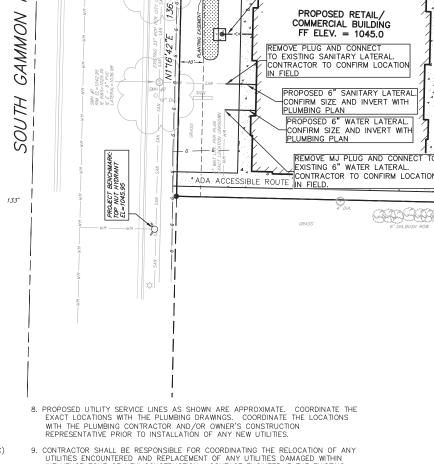

STAIRS AND RAILING

ARCHITECTURAL PLAN)


(COORDINATE WITH

6" PVC ROOF DRAIN CONNECTION

AND GOOSE NECK WITH CONCRETE PAD. CONFIRM LOCATION AND INVERT WITH PLUMBING PLAN


9. CONTRACTOR SHALL BE RESPONSIBLE FOR COORDINATING THE RELOCATION OF ANY UTILITIES ENCOUNTERED AND REPLACEMENT OF ANY UTILITIES DAMAGED WITHIN INFLUENCE ZONE OF NEW CONSTRUCTION. CONTACT ENGINEER IF THE EXISTING UTILITIES VARY APPRECIABLY FROM THE PLANS.

- 10. ALL WATER MAIN AND SERVICES SHALL BE INSTALLED AT A MINIMUM DEPTH OF 6.5' FROM TOP OF FINISHED GROUND ELEVATION TO TOP OF MAIN.
- 11. CLEAN OUT ALL EXISTING AND PROPOSED STORM INLETS AND CATCH BASINS AT
- 12. ALL DIMENSIONS GIVEN ARE TO FACE OF CURB OR EDGE OF ASPHALT WHEN CURB IS ABSENT.
- 13. CONTRACTOR TO SUBMIT CONCRETE JOINT PATTERNS FOR REVIEW AND APPROVAL PRIOR TO CONSTRUCTION.

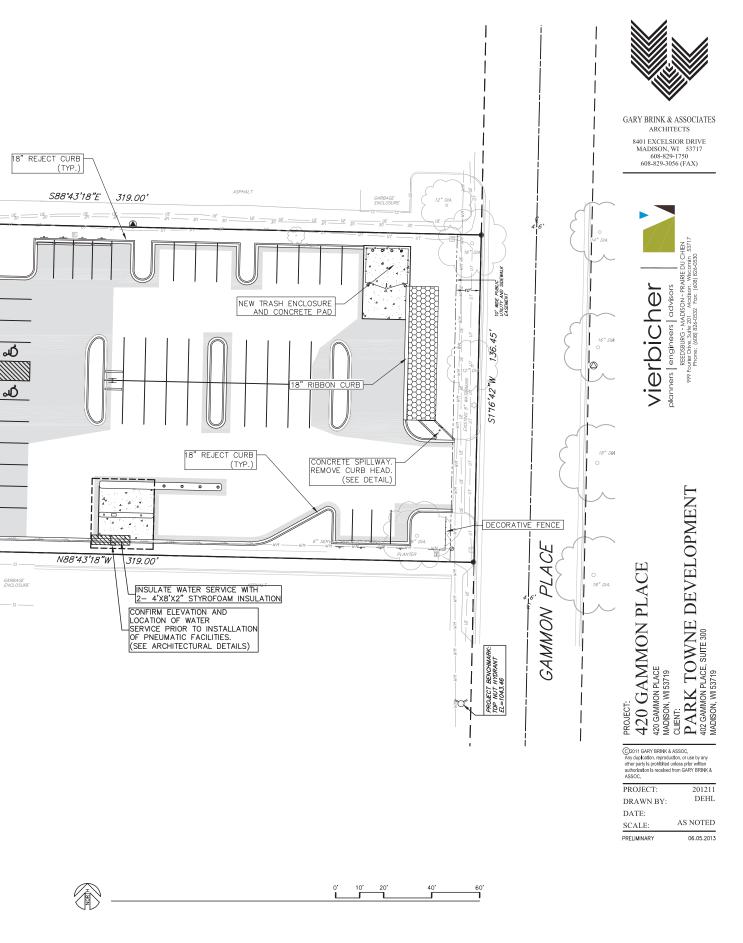

SITE UTILITY PLAN

C3.0

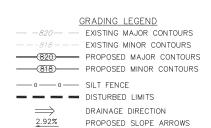

1048.61 PROPOSED SPOT ELEVATIONS **Ø** INLET PROTECTION

TRACKING PAD


+1048.61

EXISTING SPOT ELEVATIONS





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TDC (FOR HEARING IMPAIRED):
1-800-542-2289
WIS. STATUTE 182.0175 (1979)
REQUIRES MINIMUM OF 3 WORKING DAYS
NOTICE BEFORE YOU EXCAVATE.

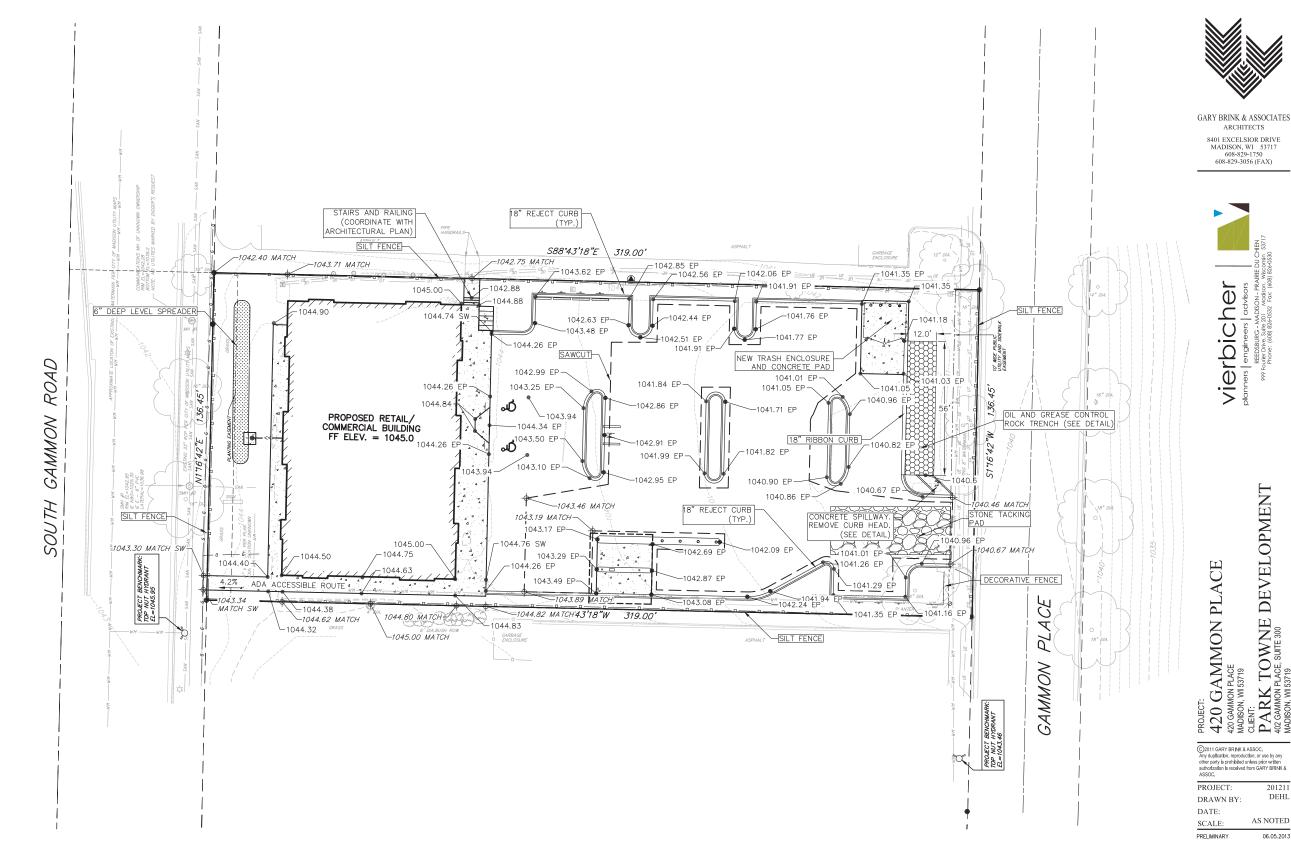

GENERAL NOTES:

- 1. THE LOCATION OF EXISTING UNDERGROUND UTILITIES AS SHOWN ON THE PLANS HAS BEEN DETERMINED FROM THE BEST AVAILABLE INFORMATION AND IS GIVEN FOR THE CONVENIENCE OF THE CONTRACTOR. THE OWNER AND THE ENGINEER DO NOT ASSUME RESPONSIBILITY IN THE EVENT THAT DURING CONSTRUCTION, UTILITIES OTHER THAN THOSE SHOWN MAY BE ENCOUNTERED, AND THAT THE ACTUAL LOCATION OF THOSE WHICH ARE SHOWN MAY BE DIFFERENT FROM THE
- 2. ACCESSIBLE ROUTES SHALL BE 5% MAX LONGITUDINAL SLOPE AND 2% MAX CROSS SLOPE. ACCESSIBLE LOADING AREAS OR LANDINGS SHALL BE 2% MAX IN ANY DIRECTION. RAMPS SHALL BE 8.33% MAX.
- 3. CONTOURS ARE SHOWN FOR PURPOSES OF INDICATING ROUGH GRADING.
- 4. FINAL GRADE SHALL BE ESTABLISHED ON PAVED SURFACES BY USING SPOT GRADES ONLY.
- 5. SEE CONSTRUCTION DETAIL SHEET FOR EROSION CONTROL NOTES AND CONSTRUCTION SEQUENCE



GRADING AND **EROSION** CONTROL

TOWNE DEVELOPMENT

ARK

201211 DEHL

AS NOTED

ARCHITECTS

C4.0

EROSION CONTROL MEASURES

- EROSION CONTROL SHALL BE IN ACCORDANCE WITH THE CITY OF MADISON EROSION CONTROL ORDINANCE AND CHAPTER NR 216 OF THE WISCONSIN ADMINISTRATIVE CODE
- 2. CONSTRUCT AND MAINTAIN ALL EROSION AND SEDIMENT CONTROL MEASURES IN ACCORDANCE WITH WISCONSIN DNR TECHNICAL STANDARDS (http://dnr.wi.gov/runoff/stormwater/techstds.htm) AND WISCONSIN CONSTRUCTION SITE BEST MANAGEMENT PRACTICE HANDBOOK.
- INSTALL SEDIMENT CONTROL PRACTICES (TRACKING PAD, PERIMETER SILT FENCE, SEDIMENT BASINS, ETC.) PRIOR TO INITIATING OTHER LAND DISTURBING CONSTRUCTION ACTIVITIES.
- THE CONTRACTOR IS REQUIRED TO MAKE EROSION CONTROL INSPECTIONS AT THE END OF EACH WEEK AND WHEN 0.5 INCHES OF RAIN FALLS WITHIN 24 HOURS. INSPECTION REPORTS SHALL BE PREPARED AND FILED AS REQUIRED BY THE DNR AND/OR CITY. ALL MAINTENANCE WILL FOLLOW AN INSPECTION
- 5. EROSION CONTROL IS THE RESPONSIBILITY OF THE CONTRACTOR UNTIL ACCEPTANCE OF THIS PROJECT. EROSION CONTROL MEASURES AS SHOWN SHALL BE THE MINIMUM PRECAUTIONS THAT WILL BE ALLOWED. ADDITIONAL EROSION CONTROL MEASURES, AS REQUESTED IN WRITING BY THE STATE OR LOCAL INSPECTORS, OR THE DEVELOPER'S ENGINEER, SHALL BE INSTALLED WITHIN 24 HOURS.
- 6. A 3" CLEAR STONE TRACKING PAD SHALL BE INSTALLED AT THE END OF ROAD CONSTRUCTION LIMITS TO PREVENT SEDIMENT FROM BEING TRACKED ONTO THE ADJACENT PAVED PUBLIC ROADWAY. SEDIMENT TRACKING PAD SHALL CONFORM TO WISDNR TECHNICAL STANDARD 1057. SEDIMENT REACHING THE PUBLIC ROAD SHALL BE REMOVED BY STREET CLEANING (NOT HYDRAULIC FLUSHING) BEFORE THE END OF EACH WORK DAY.
- CHANNELIZED RUNOFF: FROM ADJACENT AREAS PASSING THROUGH THE SITE SHALL BE DIVERTED AROUND DISTURBED AREAS.
- 8. <u>Stabilized disturbed ground:</u> any soil or dirt piles which will remain in existence for more than 7-consecutive days, whether to be worked during that period or not, shall not be located within 25-feet of any roadway, parking lot, paved area, or drainage structure OR CHANNEL (UNLESS INTENDED TO BE USED AS PART OF THE EROSION CONTROL MEASURES). TEMPORARY STABILIZATION AND CONTROL MEASURES (SEEDING, MULCHING, TARPING, EROSION MATTING, BARRIER FENCING, ETC.) ARE REQUIRED FOR THE PROTECTION OF DISTURBED AREAS AND SOIL PILES, WHICH WILL REMAIN UN-WORKED FOR A PERIOD OF MORE THAN 7-CONSECUTIVE CALENDAR DAYS. THESE MEASURES SHALL REMAIN IN PLACE UNTIL SITE HAS STABILIZED.
- 9. <u>SITE DE-WATERING:</u> WATER PUMPED FROM THE SITE SHALL BE TREATED BY TEMPORARY SEDIMENTATION BASINS OR OTHER APPROPRIATE CONTROL MEASURES. SEDIMENTATION BASINS SHALL HAVE A DEPTH OF AT LEAST 3 FEET, BE SURROUNDED BY SNOWFENCE OR EQUIVALENT BARRIER AND HAVE SUFFICIENT SURFACE AREA TO PROVIDE A SURFACE SETTLING RATE OF NO MORE THAN 750 GALLONS PER SQUARE FOOT PER DAY AT THE HIGHEST DEWATERING PUMPING RATE. WATER MAY NOT BE DISCHARGED IN A MANNER THAT CAUSES EROSION OF THE SITE, A NEIGHBORING SITE, OR THE BED OR BANKS OF THE RECEIVING WATER. POLYMERS MAY BE USED AS DIRECTED BY DNR TECHNICAL STANDARD 1061 (DE-WATERING).
- 10. SEE DETAIL SHEETS FOR RIP-RAP SIZING, IN NO CASE WILL RIP-RAP BE SMALLER THAN 3" TO 6"
- 11. RESTORATION (SEED, FERTILIZE AND MULCH) SHALL BE PER SPECIFICATIONS ON THIS SHEET (NOTE: ADD SEEDING RATE STANDARD OF DETAIL BLOCK TO PLAN) UNLESS SPECIAL RESTORATION IS CALLED FOR ON THE LANDSCAPE PLAN.
- 12. LAWN AREAS SHALL BE RESTORED WITH 6" TOPSOIL, TEMPORARY SEED, FERTILIZER AND MULCH
- 13. SEED, FERTILIZER AND MULCH SHALL BE APPLIED WITHIN 7 DAYS AFTER FINAL GRADE HAS BEEN ESTABLISHED. IF DISTURBED AREAS WILL NOT BE RESTORED IMMEDIATELY AFTER ROUGH GRADING, TEMPORARY SEED SHALL BE PLACED.
- 14. FOR THE FIRST SIX WEEKS AFTER RESTORATION (E.G. SEED & MULCH, EROSION MAT, SOD) OF A DISTURBED AREA, INCLUDE SUMMER WATERING PROVISIONS OF ALL NEWLY SEEDED AND MULCHED AREAS WHENEVER 7 DAYS ELAPSE WITHOUT A RAIN EVENT.
- 15. EROSION MAT (CLASS I, TYPE A URBAN PER WISCONSIN D.O.T. P.A.L.) SHALL BE INSTALLED ON ALL SLOPES 3:1 OR GREATER BUT LESS THAN 1:1.
- 16. EROSION MAT (CLASS I, TYPE B URBAN PER WISCONSIN D.O.T. P.A.L.) SHALL BE INSTALLED ON THE BOTTOM (INVERT) OF ROADSIDE DITCHES/SWALES AS SHOWN ON THIS PLAN, 1 ROLL WIDTH
- 17. SOIL STABILIZERS SHALL BE APPLIED TO DISTURBED AREAS WITH SLOPES BETWEEN 10% AND 3:1 (DO NOT USE IN CHANNELS). SOIL STABILIZERS SHALL BE TYPE B, PER WISCONSIN D.O.T. P.A.L. (PRODUCT ACCEPTABILITY LIST), OR EQUAL. APPLY AT RATES AND METHODS SPECIFIED PER MANUFACTURER. SOIL STABILIZERS SHALL BE RE-APPLIED WHENEVER VEHICLES OR OTHER EQUIPMENT TRACK ON THE AREA.
- 18. SILT FENCE OR EROSION MAT SHALL BE INSTALLED ALONG THE CONTOURS AT 100 FOOT INTERVALS DOWN THE SLOPE ON THE DISTURBED SLOPES STEEPER THAN 5% AND MORE THAN 100 FEET LONG THAT SHEET FLOW TO THE ROADWAY UNLESS SOIL STABILIZERS ARE USED.
- 19. SILT FENCE TO BE USED ACROSS AREAS OF THE LOT THAT SLOPE TOWARDS A PUBLIC STREET OR WATERWAY. SEE DETAILS.
- 20. SEDIMENT SHALL BE CLEANED FROM CURB AND GUTTER AFTER EACH RAINFALL AND PRIOR TO PROJECT ACCEPTANCE.
- 21. ANY PROPOSED CHANGES TO THE EROSION CONTROL PLAN MUST BE SUBMITTED AND APPROVED BY CITY OF MADISON ENGINEERING.
- 22. THE CITY, OWNER AND/OR ENGINEER MAY REQUIRE ADDITIONAL EROSION CONTROL MEASURES AT ANY TIME DURING CONSTRUCTION

STEEL OR WOOD POST FENCE SUPPORT MESH (OPTIONAL) SEE NOTE 4 -BACKFILLED AND COMPACTED SOIL 'MIN ' FLOW (MIN.) TRENCH 18" (MIN.)

- 1. INSTALL SILT FENCE TO FOLLOW THE GROUND CONTOURS AS CLOSELY AS POSSIBLE.
- 2. CURVE THE SILT FENCE UP THE SLOPE TO PREVENT WATER FROM RUNNING AROUND THE ENDS.
- 3. POST SPACING WITH FENCE SUPPORT MESH = 10 FT. (MAX.)

POST SPACING WITHOUT FENCE SUPPORT MESH = 6 FT. (MAX.)

4. SILT FENCE SUPPORT MESH CONSISTS OF 14-GAUGE STEEL WIRE WITH A MESH SPACING OF 6 IN X 6 IN OR PREFABRICATED POLYMERIC MESH OF EQUIVALENT STRENGTH



CONSTRUCTION SEQUENCE:

- 1. INSTALL SILT FENCE/SILT SOCK AND TRACKING PAD
- 2. DEMOLITION OF EXISTING BUILDING, SIDEWALK, AND PARKING AREA PER DEMOLITION PLAN.
- 3. ROUGH GRADE DISTURBED AREA
- 4. SEED AND EROSION MAT THE DISTURBED PROPOSED LAWN AREAS
- 5. CONSTRUCT UNDERGROUND UTILITIES
- 6. CONSTRUCT PARKING AREAS (STONE BASE, CURB & GUTTER, AND SIDEWALK).
- 7. CONSTRUCT OIL AND GREASE CONTROL ROCK TRENCH (PER DETAIL).
- 8. REMOVE TRACKING PAD AND SILT FENCE/SILT SOCK

SEEDING RATES:

TEMPORARY:

. USE ANNUAL OATS AT 3.0 LB./1,000 S.F. FOR SPRING AND SLIMMER PLANTINGS

2. USE WINTER WHEAT OR RYE AT 3.0 LB./1,000 SF FOR FALL AFTER SEPTEMBER 15.

PERMANENT

1. USE WISCONSIN D.O.T. SEED MIX #40 AT 2 LB./1,000 S.F.

FERTILIZING RATES:


TEMPORARY AND PERMANENT:

USE WISCONSIN D.O.T. TYPE A OR B AT 7 LB./1,000 S.F.

MULCHING RATES:


TEMPORARY AND PERMANENT:

USE ½" TO 1-½" STRAW OR HAY MULCH, CRIMPED PER SECTION 607.3.2.3, OR OTHER RATE AND METHOD PER SECTION 627, WISCONSIN D.O.T. STANDARD SPECIFICATIONS FOR HIGHWAY AND STRUCTURE CONSTRUCTION

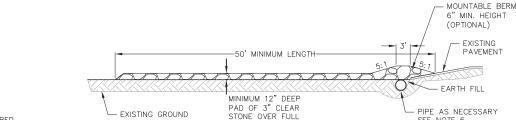

LENGTH AND WIDTH


OF STRUCTURE

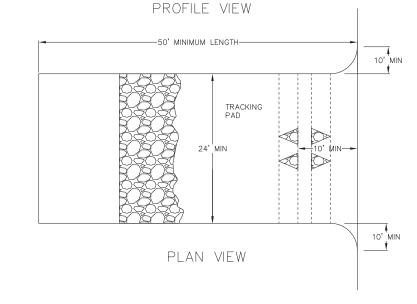

SEE NOTE 6

- 1. FOLLOW WISCONSIN DNR TECHNICAL STANDARD 1057 FOR FURTHER DETAILS AND INSTALLATION
- 2. LENGTH MINIMUM OF 50'.
- 3. WIDTH 24' MINIMUM, SHOULD BE FLARED AT THE EXISTING ROAD TO PROVIDE A TURNING RADIUS
- 4. ON SITES WITH A HIGH GROUND WATER TABLE OR WHERE SATURATED CONDITIONS EXIST, GEOTEXTILE FABRICSHALL BE PLACED OVER EXISTING GROUND PRIOR TO PLACING STONE. FABRIC SHALL BE WISDOT TYPE-HR GEOTEXTILE FABRIC.
- 5. STONE CRUSHED 3" CLEAR STONE SHALL BE PLACED AT LEAST 12" DEEP OVER THE ENTIRE LENGTH AND WIDTH OF ENTRANCE.
- 6 SURFACE WATER ALL SURFACE WATER FLOWING TO OR DIVERTED TOWARDS CONSTRUCTION ENTRANCES SHALL BE PIPE 6. SORFACE WATER — ALL SURFACE WATER FLOWING TO OR DIVERTIED TOWARDS CONSTRUCTION ENTRANCES SHALL BE PREDICTIVE THROUGH THE ENTRANCE, MAINTAINING POSITIVE DRAINAGE, PIPE INSTALLED THROUGH THE STABILIZED CONSTRUCTION ENTRANCE SHALL BE PROTECTED WITH A MOUNTABLE BERM WITH 5:1 SLOPES AND MINIMIUM OF 6" STONE OVER THE PIPE, PIPE SHALL BE SIZED ACCORDING TO THE DRAINAGE REQUIREMENTS. WHEN THE ENTRANCE IS LOCATED AT A HIGH SPOT AND HAS NO DRAINAGE TO CONVEY A PIPE SHALL NOT BE NECESSARY. THE MINIMUM PIPE DIAMETER SHALL BE 6". CONTRACTOR SHALL BE RESPONSIBLE FOR THE MAINTENANCE OF SAID PIPE.
- 7. LOCATION A STABILIZED CONSTRUCTION ENTRANCE SHALL BE LOCATED WHERE CONSTRUCTION TRAFFIC ENTERS AND/OR LEAVES THE CONSTRUCTION SITE. VEHICLES LEAVING THE SITE MUST TRAVEL OVER THE ENTIRE LENGTH OF THE TRACKING PAD.



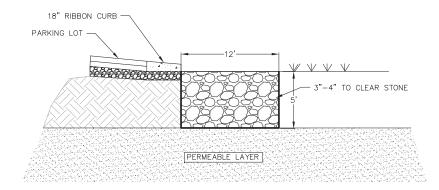





GARY BRINK & ASSOCIATES ARCHITECTS

8401 EXCELSIOR DRIVE MADISON, WI 53717 608-829-1750 608-829-3056 (FAX)




DEVELOPMENT PL TOWNE **GAMMON**

ARK .20 ©2011 GARY BRINK & ASSOC, uthorization is received from GARY BRINK 8

PROJECT DEHI DRAWN BY DATE:


AS NOTED SCALE PRELIMINARY 06.05.2013

> CONSTRUCTION DETAILS

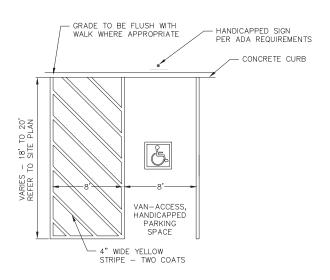


1 HANDICAP STRIPING

NOT TO SCALE

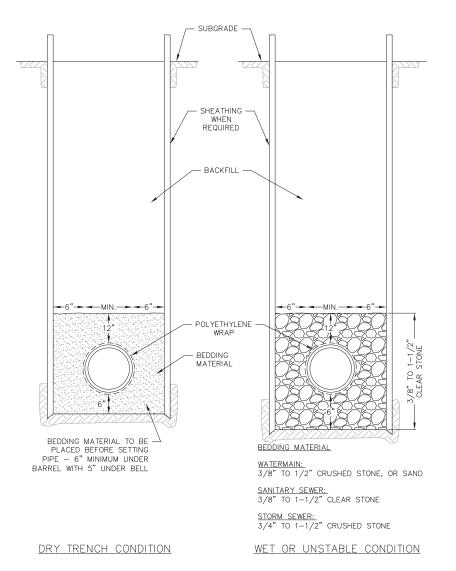


STANDARD TRENCH SECTION


NOT TO SCALE

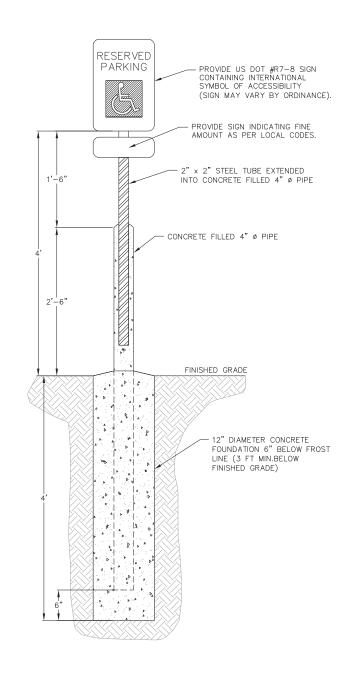

1 HANDICAP PARKING SIGN

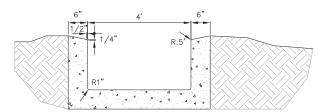


1 CONCRETE SPILLWAY/CURB CUT
1 NOT TO SCALE

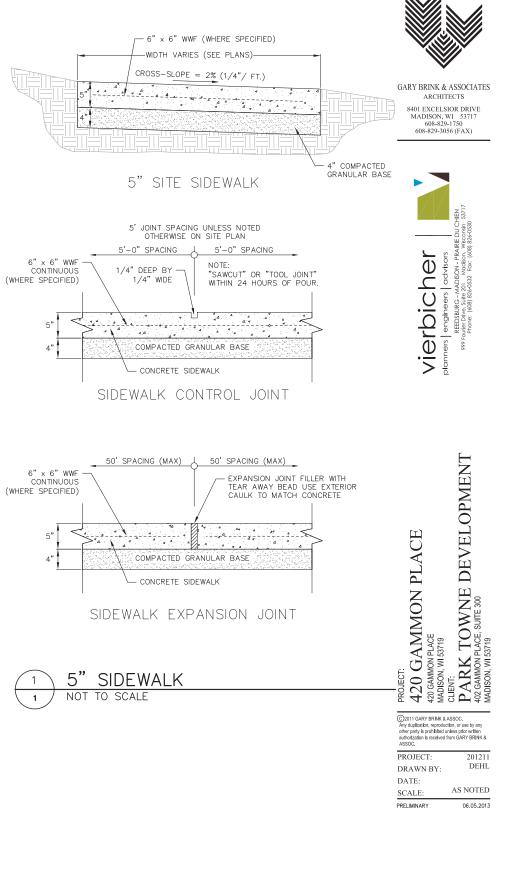


CONSTRUCTION DETAILS

C6.0

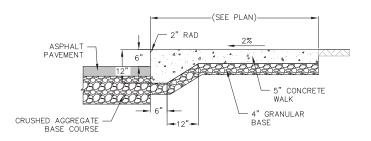


CURBED SIDEWALK SITE DETAIL

NOT TO SCALE

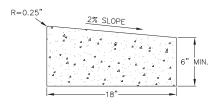


RIBBON CURB

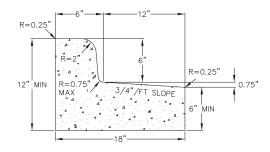


CURB AND GUTTER REJECT SECTION



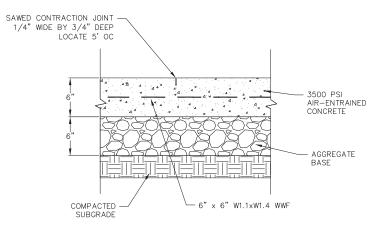



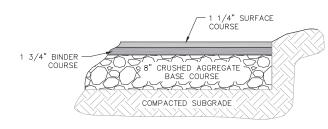

BITUMINOUS PAVEMENT PARKING LOT













GAMMON PLACE
MMON PLACE
DN, WI 53719

PROJECT: 201211 DEHL

DRAWN BY DATE: AS NOTED SCALE:

10:1 MAX 1<u>0:1 MAX</u> RAMP PLAN VIEW 15'-0" 10:1 SLOPE (MAX) 10:1 SLOPE (MAX) (MAA) - CONCRETE RAMP RAMP PROFILE VIEW PLAN VIEW DETECTABLE WARNING FIELD (TYPICAL)

2'x4' DETECTABLE

WARNING FIELD

12:

GENERAL NOTES

ON THE RAMP.

RAMPS SHALL BE BUILT AT 12:1 OR FLATTER.

WHEN NECESSARY, THE SIDEWALK ELEVATION MAY BE LOWERED TO MEET THE HIGH POINT

NOT TO SCALE

CURB RAMP DETAIL

CONSTRUCTION **DETAILS**

C7.0

