

TRASH ENCLOSURE - FRONT ELEVATION (SOUTH)

SLEEVES AT 90° OPENING


SCALE: 1/4"=1'-@"

TRASH ENCLOSURE
EAST & WEST ELEVATIONS

9CALE: 1/4'=1'-0'

TRASH ENCLOSURE - BACK ELEVATION (NORTH)

9CALE: 1/4'=1'-@'

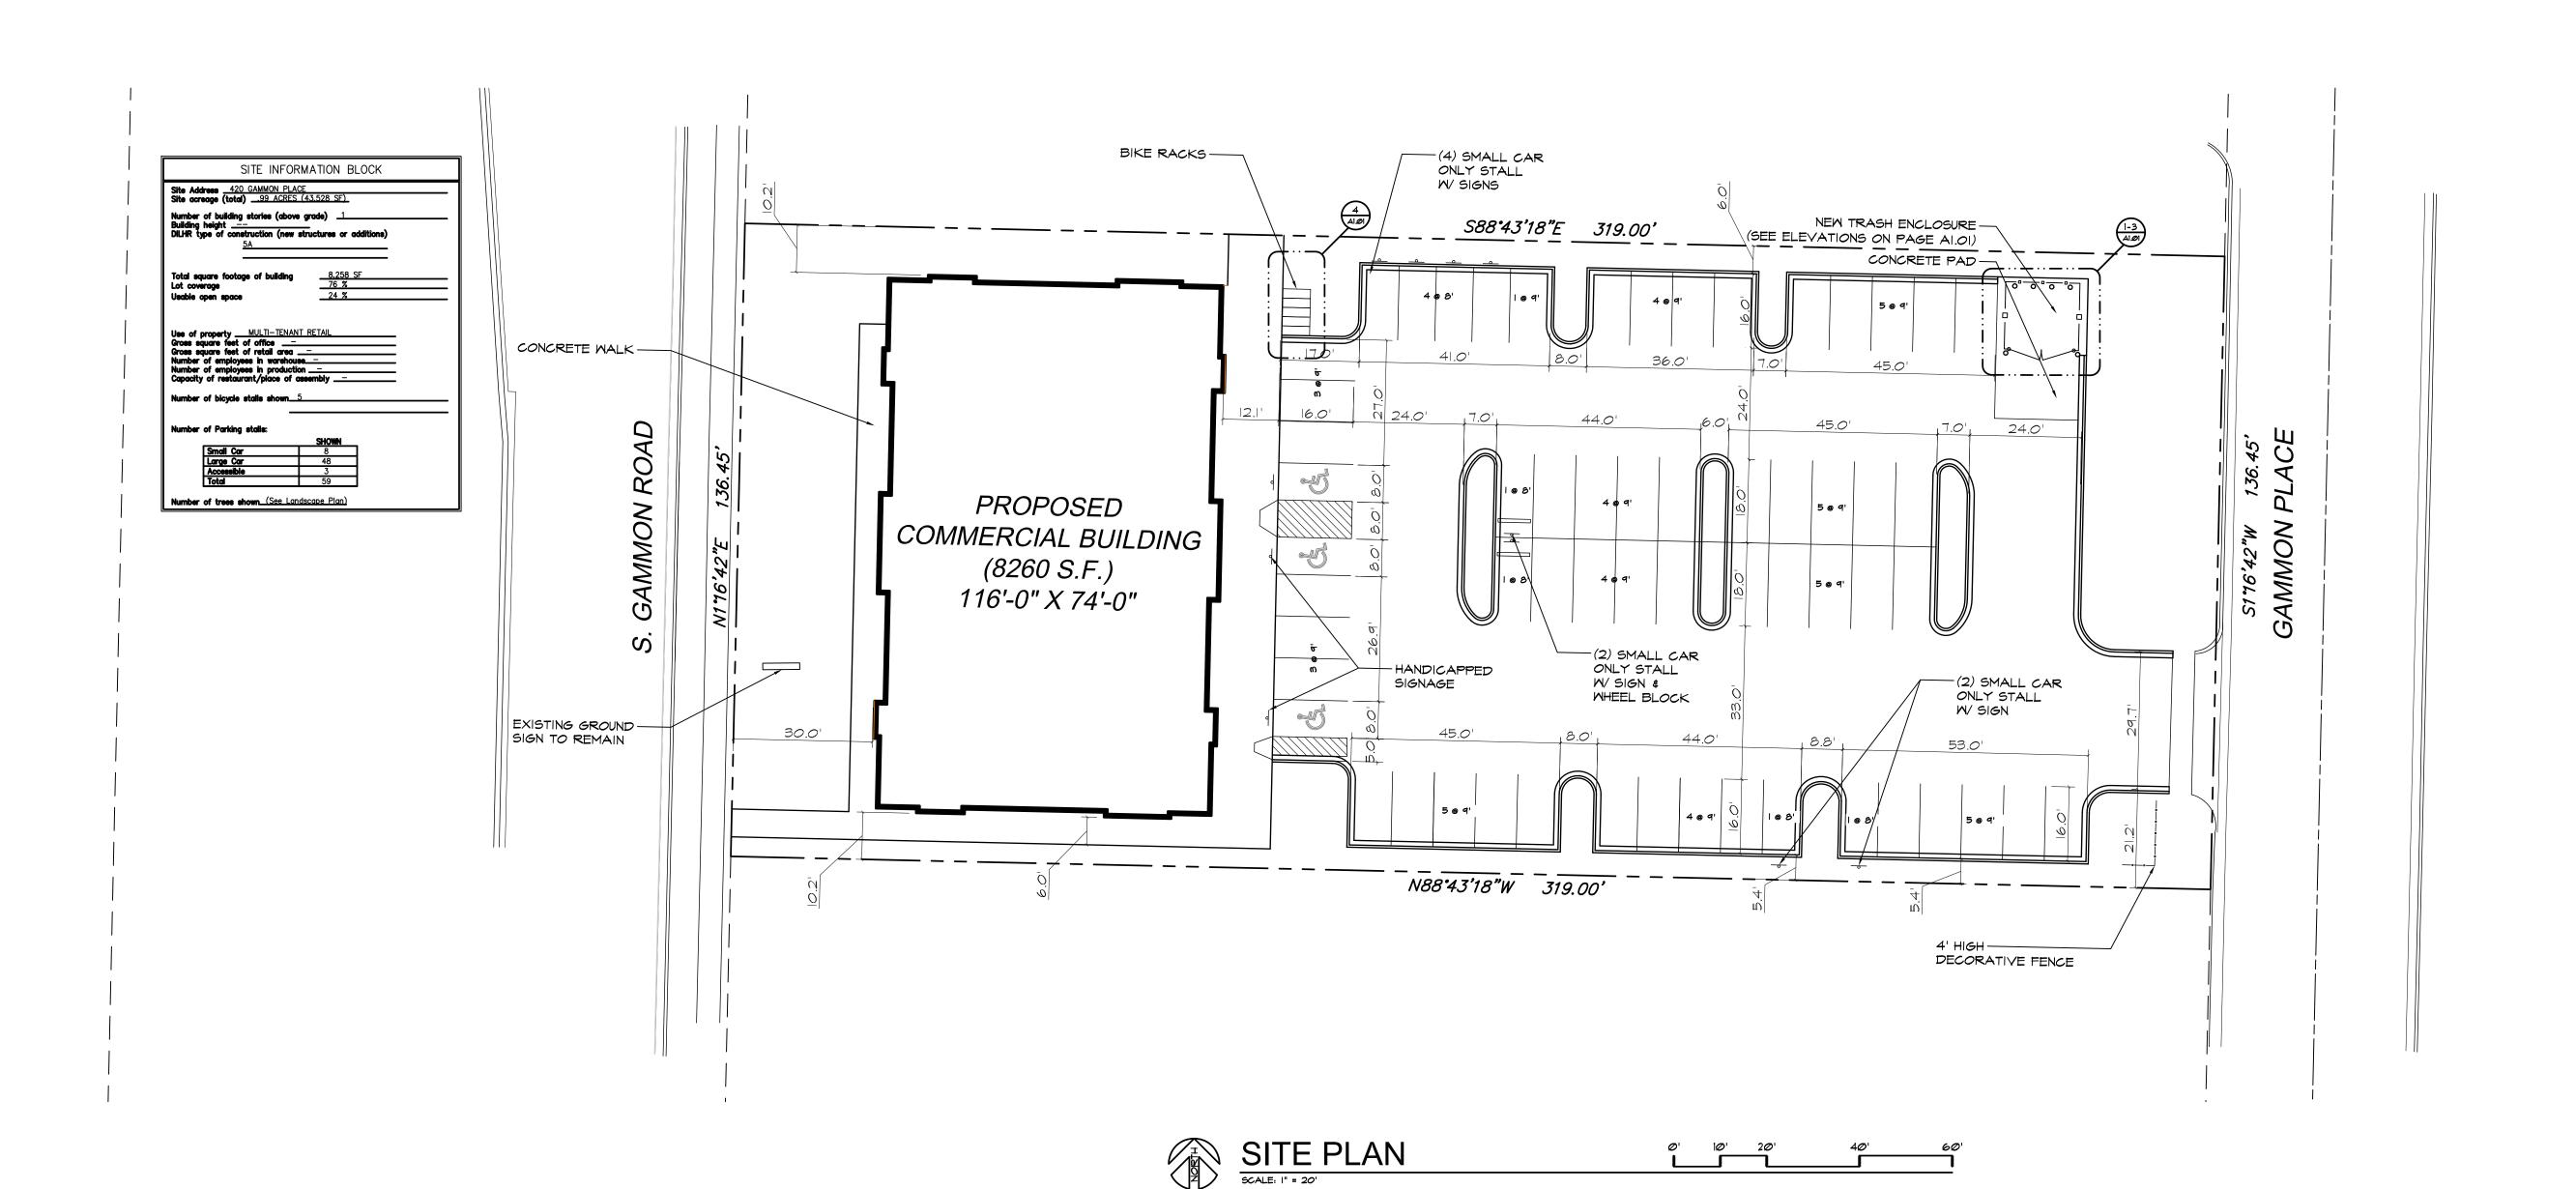

PROJECT:
420 GAMMON PLACE
420 GAMMON PLACE
MADISON, WI 53719
CLIENT:
PARK TOWNE DEVELOPMENT

GARY BRINK & ASSOCIATES

ARCHITECTS

8401 EXCELSIOR DRIVE

MADISON, WI 53717 608-829-1750

608-829-3056 (FAX)

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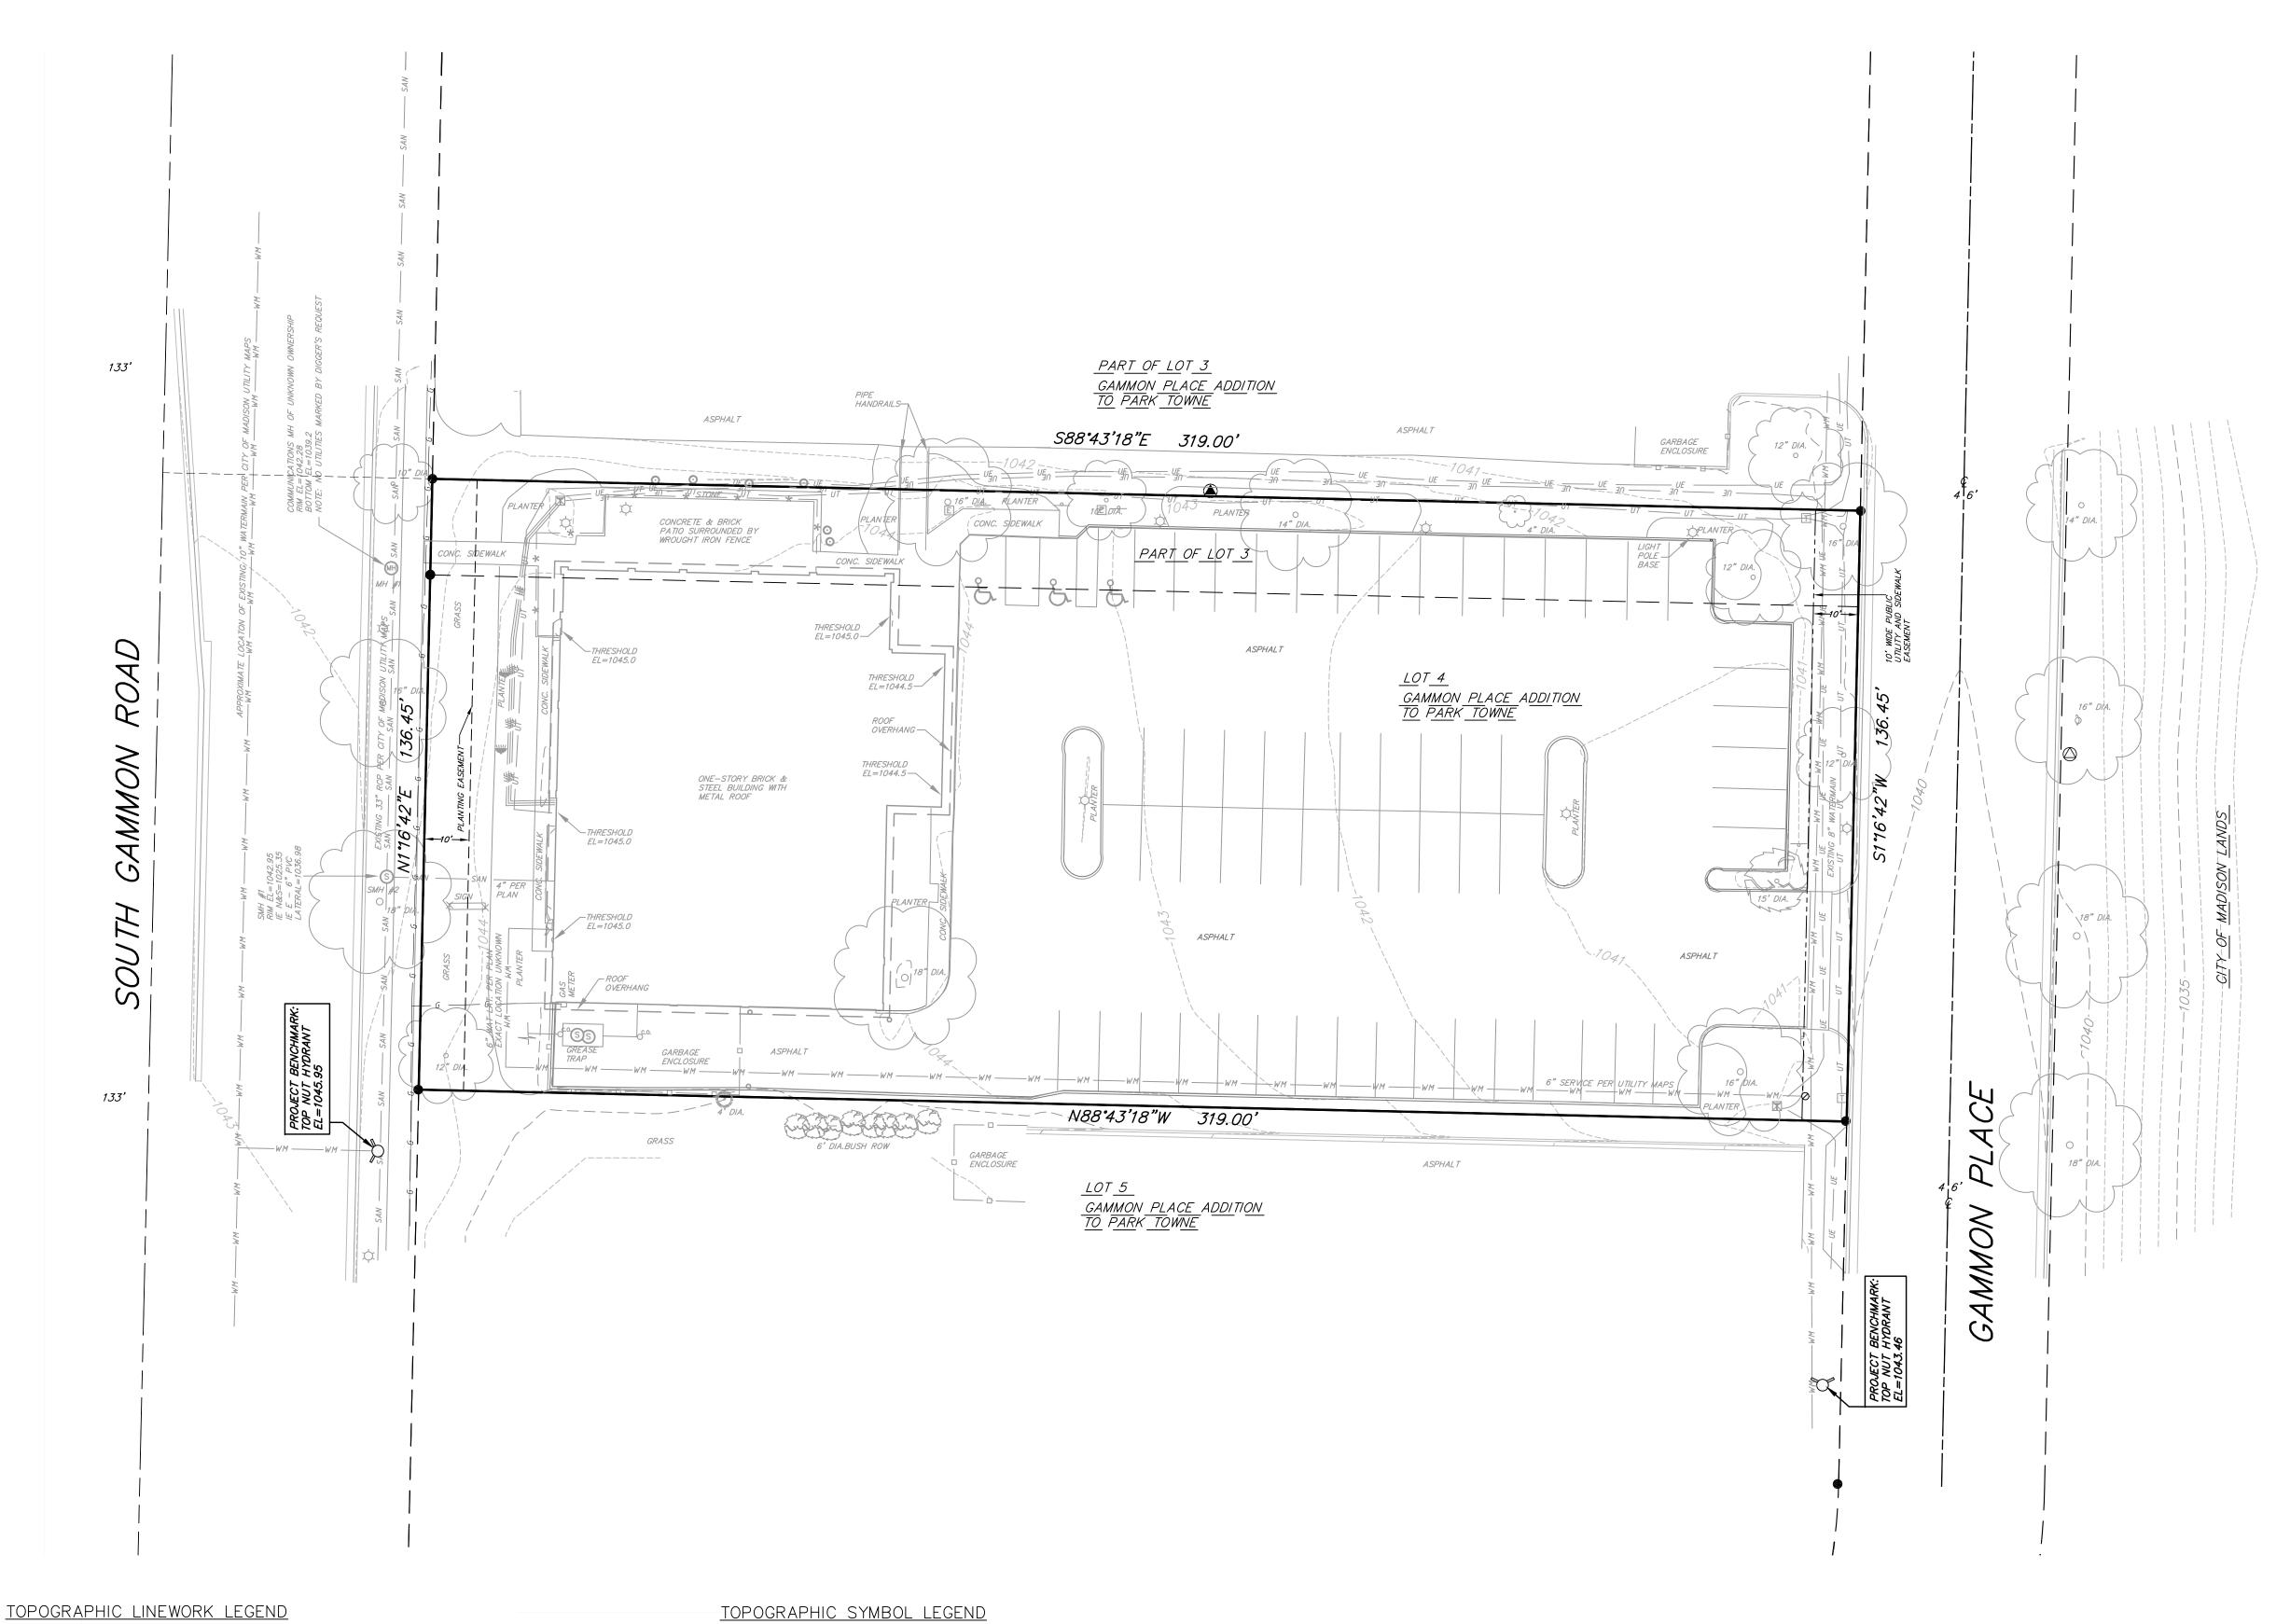
PROJECT: 201211
DRAWN BY: KD
DATE:
SCALE: AS NOTED

 PRELIMINARY
 Ø5 23 2013

 SUBMITTAL
 Ø6 Ø5 2013

 REVISED SITE PLAN
 Ø6 24 2013

SITE PLAN



■ EXISTING TRANSFORMER

- EXISTING GUY POLE

CONTRACTOR STATES STATE **EXISTING GENERIC LIGHT**

EXISTING UTILITY POLE

M EXISTING TV PEDESTAL

EXISTING SHRUB

EXISTING TELEPHONE PEDESTAL

M EXISTING UNIDENTIFIED MANHOLE

🖔 EXISTING HANDICAP PARKING

EXISTING CONIFEROUS TREE

EXISTING DECIDUOUS TREE

— UT — UT — EXISTING UNDERGROUND TELEPHONE

— SAN — SAN — EXISTING SANITARY SEWER LINE (SIZE NOTED)

—— FO —— FO —— EXISTING FIBER OPTIC LINE

---- * ---- * EXISTING GENERAL FENCE

---818--- EXISTING MINOR CONTOUR

---- EXISTING WOOD FENCE

—— G —— G EXISTING GAS LINE

EXISTING BOLLARD

EXISTING SIGN (TYPE NOTED)

60 EXISTING SANITARY CLEANOUT

S EXISTING SANITARY MANHOLE

E EXISTING ELECTRIC MANHOLE

E EXISTING ELECTRIC PEDESTAL

M EXISTING AIR CONDITIONING PEDESTAL

EXISTING FIRE HYDRANT

EXISTING STANDPIPE

© EXISTING CURB STOP

M EXISTING GAS VALVE

TEXISTING DOWN GUY

1) THIS TOPOGRAPHIC MAP IS NOT INTENDED TO BE A BOUNDARY SURVEY AS DEFINED BY CHAPTER A—E 7 OF THE WISCONSIN ADMINISTRATIVE CODE. A CERTIFIED SURVEY MAP OF THIS SITE IS REQUIRED FOR APPROVAL WITH THE CITY OF MADISON.

2) THIS MAP WAS COMPILED FROM DATA USING GPS AND ROBOTIC TOTAL STATION. IT IS REFERENCED TO THE WISCONSIN COUNTY COORDINATE SYSTEM, DANE COUNTY PROJECTION. ELEVATIONS ARE REFERENCED TO THE NORTH AMERICAN VERTICAL DATUM (NAVD) 88 AS PER CITY OF MADISON 1-1/4" REBAR MONUMENT #708128 LOCATED IN THE NORTHBOUND LANE OF SOUTH GAMMON ROAD JUST NORTH OF THE BELTLINE HWY., ELEV=1075.95

3) ALL UNDERGROUND UTILITIES HAVE BEEN LOCATED PER MARKINGS PLACED ON THE GROUND OR MAPS PROVIDED BY THE UTILITIES (OWNERS) AND OR THEIR AUTHORIZED REPRESENTATIVES. MARKINGS ARE AS PER DIGGER'S HOTLINE TICKET NO.'S 20131913071 AND 20131600535. VIERBICHER DOES NOT WARRANT THESE LOCATIONS MARKED OR MAPPED BY OTHERS. 4) FIELD WORK FOR THIS MAP WAS COMPLETED BY 5-15-13. ANY CHANGES AFTER THIS DATE ARE NOT REFLECTED ON THIS MAP.

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8401 EXCELSIOR DRIVE MADISON, WI 53717 608-829-1750 608-829-3056 (FAX)

PROJECT: 201211 DRAWN BY: DEHL DATE: SCALE: AS NOTED

06.05.2013

PRELIMINARY

EXISTING CONDITIONS PLAN

16. PLUG AND ABANDON EXISTING WATER SERVICE AT LOCATION SHOWN AND REMOVE REMAINDER OF PIPE ON SITE. CONTACT WATER

17. OBTAIN SANITARY PLUG PERMIT AND COORDINATE WITH CITY ENGINEERING PRIOR TO SEWER LATERAL PIPE REMOVAL.

UTILITY PRIOR TO REMOVING WATER METER,



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GAMMON PLACE IN, WI 53719


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PROJECT:

DRAWN BY:	DEHL
DATE:	
SCALE:	AS NOTED
PRELIMINARY	06.05.2013
REV. 1	06.24.2013

201211

DEMOLITION

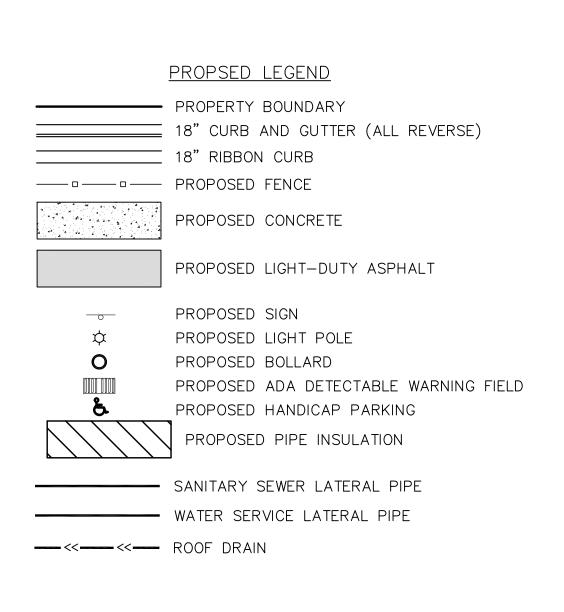

ABBREVIATIONS

STMH — STORM MANHOLE
FI — FIELD INLET
CI — CURB INLET
CB — CATCH BASIN
EW — ENDWALL
SMH — SANITARY MANHOLE



CALL DIGGER'S HOTLINE

1-800-242-8511

TOLL FREE

TELEFAX: 1-800-338-3860

TDC (FOR HEARING IMPAIRED):
1-800-542-2289

WIS. STATUTE 182.0175 (1979)

REQUIRES MINIMUM OF 3 WORKING DAYS
NOTICE BEFORE YOU EXCAVATE.

SITE AND UTILITY NOTES:

- 1. A COPY OF THE APPROVED UTILITY PLANS, SPECIFICATIONS AND PLUMBING PERMIT APPROVAL LETTER SHALL BE ON—SITE DURING CONSTRUCTION AND OPEN TO INSPECTION BY AUTHORIZED REPRESENTATIVES OF DSPS AND OTHER LOCAL INSPECTORS.
- 2. PRIVATE SANITARY SEWER AND LATERALS SHALL BE POLYVINYL CHLORIDE (PVC) ASTM D3034 SDR 35 OR APPROVED EQUAL MATERIAL THAT CONFORMS TO SPS 384.
- 3. A MEANS TO LOCATE BURIED UNDERGROUND EXTERIOR NON METALLIC SEWERS/MAINS AND WATER SERVICES/MAINS MUST BE PROVIDED WITH TRACER WIRE OR OTHER METHODS IN ORDER TO BE LOCATED PER SPS 382.

11. CLEAN OUT ALL EXISTING AND PROPOSED STORM INLETS AND CATCH BASINS AT

12. ALL DIMENSIONS GIVEN ARE TO FACE OF CURB OR EDGE OF ASPHALT WHEN CURB


13. CONTRACTOR TO SUBMIT CONCRETE JOINT PATTERNS FOR REVIEW AND APPROVAL

THE COMPLETION OF CONSTRUCTION.

PRIOR TO CONSTRUCTION.

IS ABSENT.

- 4. EXTERIOR WATER SUPPLY PIPING SETBACKS AND CROSSINGS SHALL BE IN ACCORDANCE WITH SPS 382.
- 5. NO PERSON MAY ENGAGE IN WORK AT PLUMBING IN THE STATE UNLESS LICENSED TO DO SO.
- 6. SITE CONTRACTOR SHALL LEAVE SANITARY AND WATER LATERALS FIVE (5) FEET SHORT (HORIZONTALLY) FROM THE BUILDING. BUILDING PLUMBER SHALL VERIFY SIZE AND EXACT LOCATION OF PROPOSED SANITARY AND WATER LATERALS.
- 7. CONTRACTOR SHALL FIELD VERIFY THE SIZE, TYPE, LOCATION, AND ELEVATION OF EXISTING UTILITIES PRIOR TO INSTALLING ANY ON—SITE UTILITIES OR STRUCTURES. CONTACT ENGINEER PRIOR TO INSTALLATION IF DISCREPANCY EXISTS WITHIN THESE PLANS.

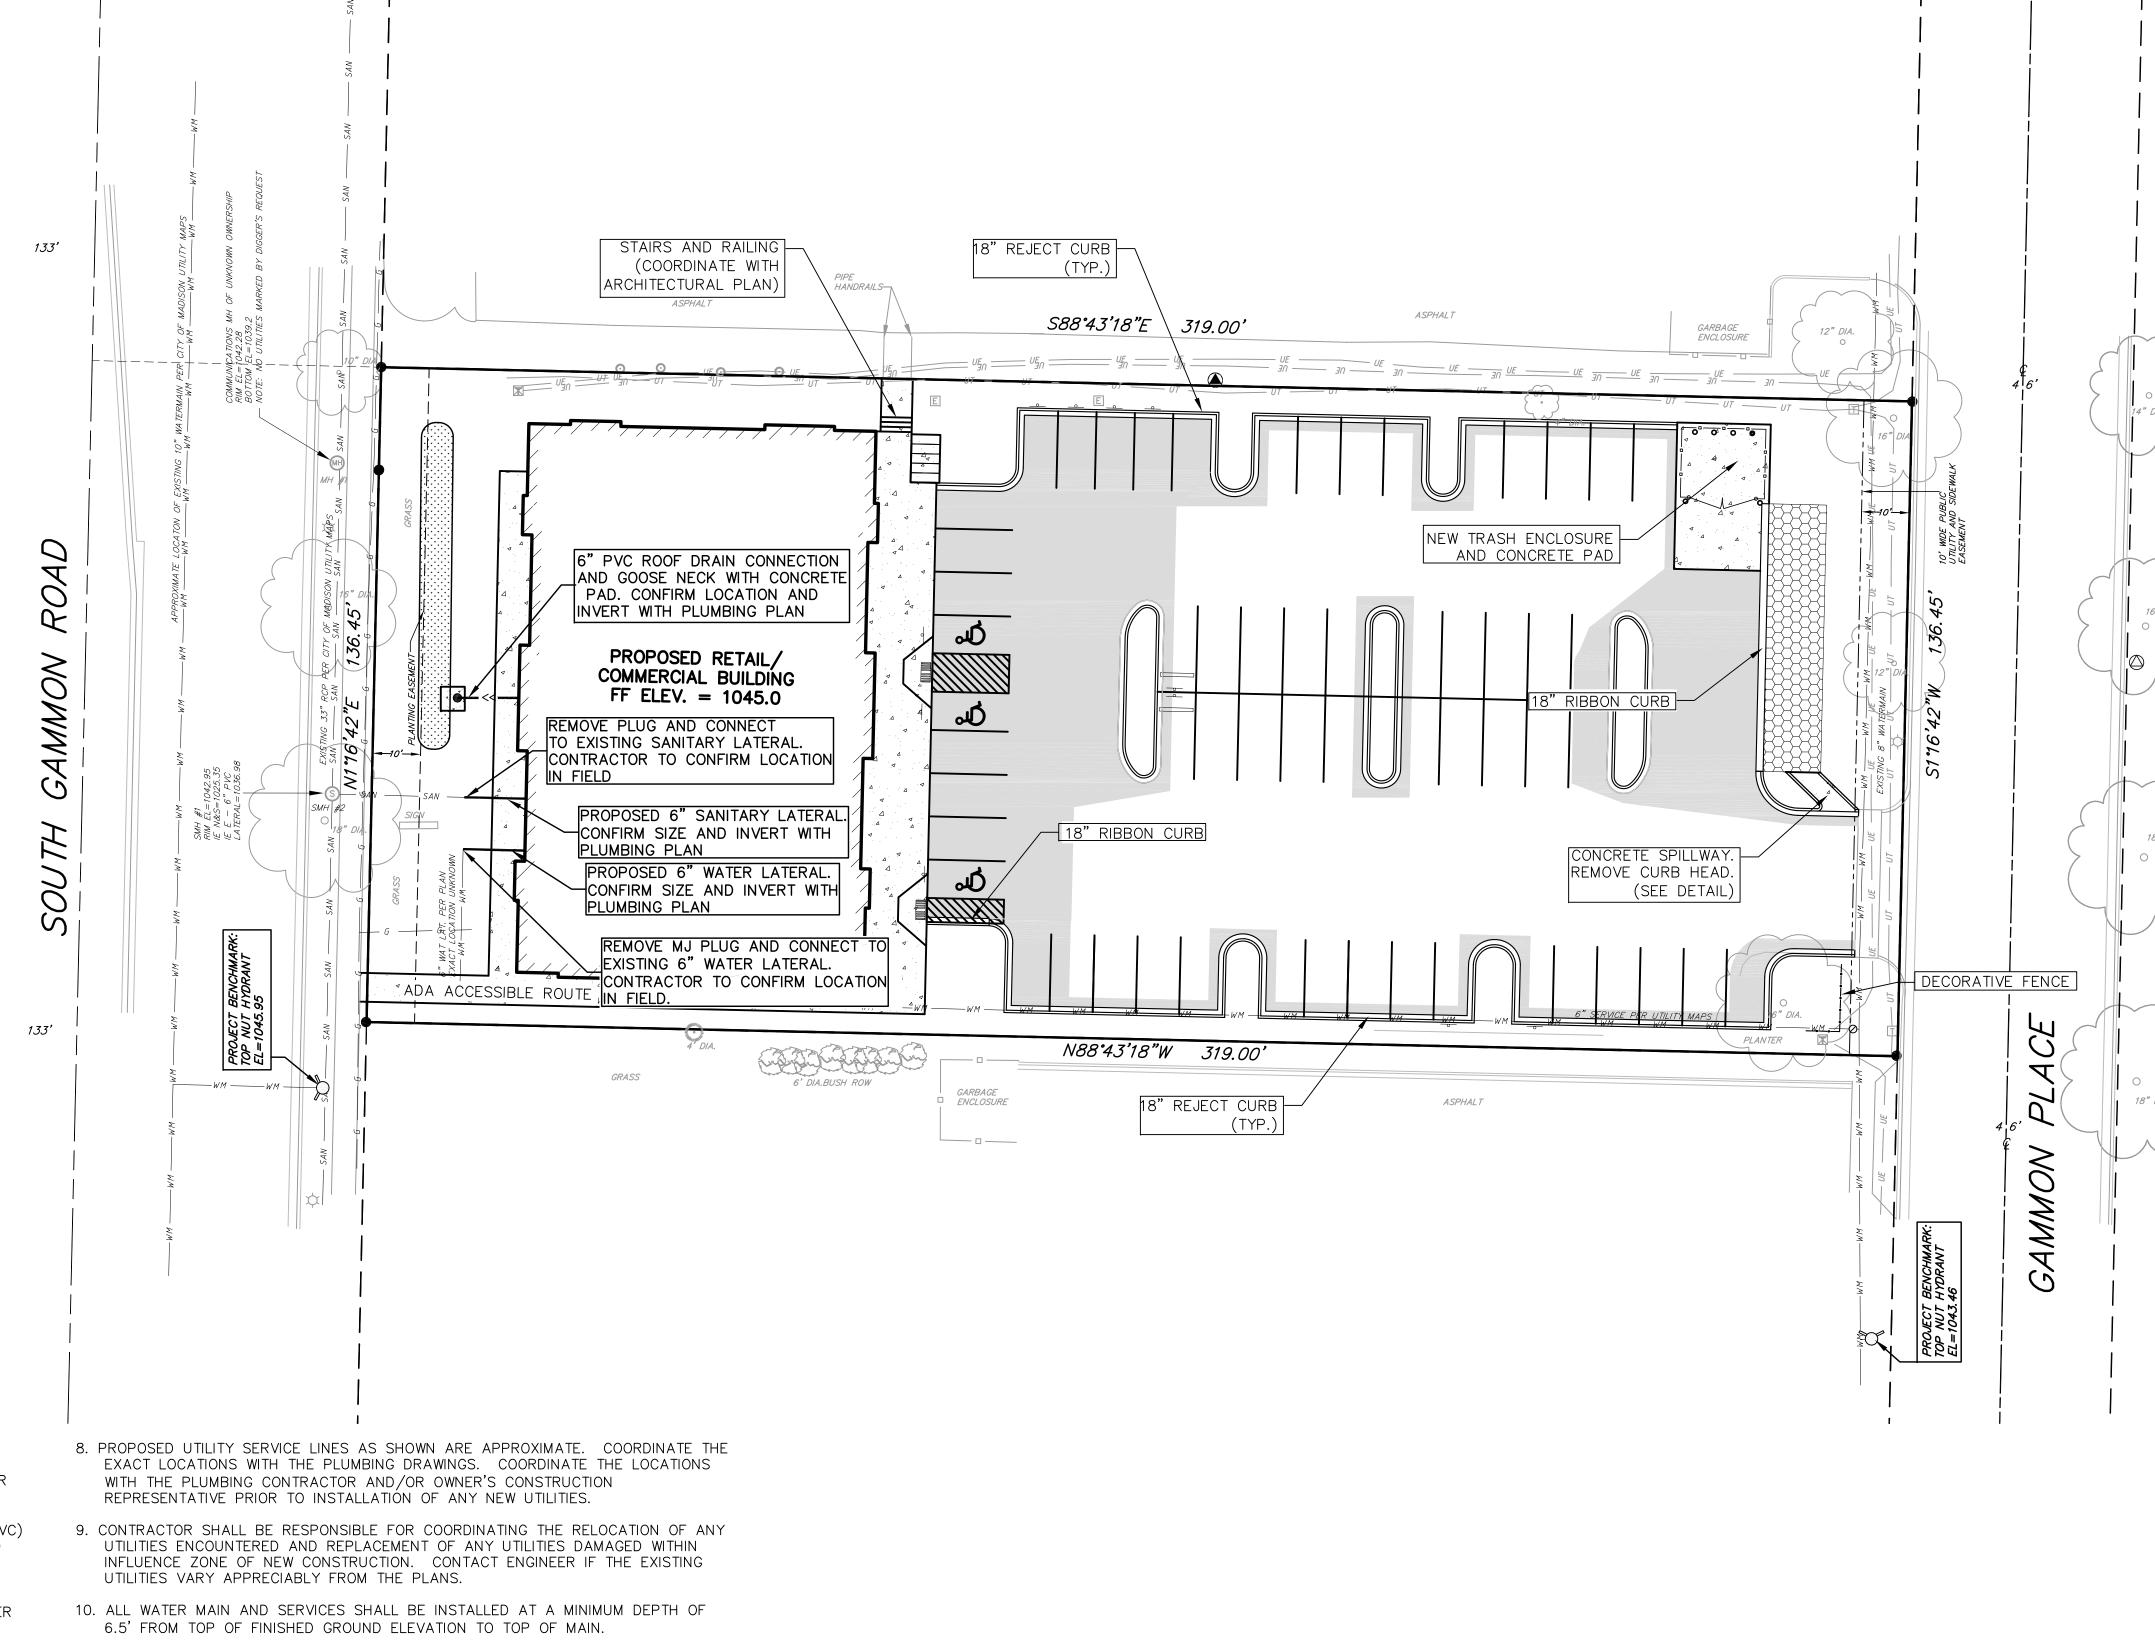

SITE UTILITY

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ASSOC.

DATE:

SCALE:

REV. 1

PRELIMINARY

PROJECT:

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201211

DEHL

AS NOTED

06.05.2013

06.24.2013

GARY BRINK & ASSOCIATES


ARCHITECTS

8401 EXCELSIOR DRIVE
MADISON, WI 53717

608-829-1750

608-829-3056 (FAX)

C3.0

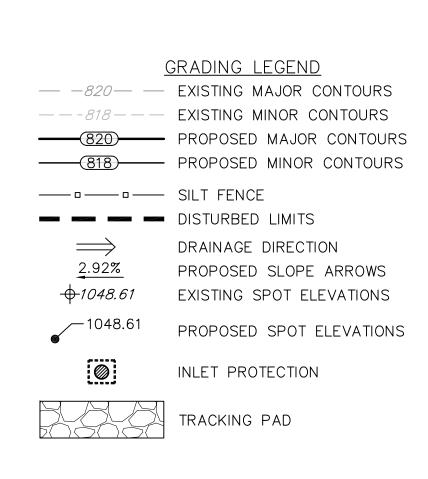


<u>ABBREVIATIONS</u>

TC - TOP OF CURB FF - FINISHED FLOOR

EP - EDGE OF PAVEMENT SW - TOP OF WALK TW - TOP OF WALL

BW - BOTTOM OF WALL

CALL DIGGER'S HOTLINE 1-800-242-8511 TOLL FREE TELEFAX: 1-800-338-3860 TDC (FOR HEARING IMPAIRED): 1-800-542-2289 WIS. STATUTE 182.0175 (1979) REQUIRES MINIMUM OF 3 WORKING DAYS NOTICE BEFORE YOU EXCAVATE.

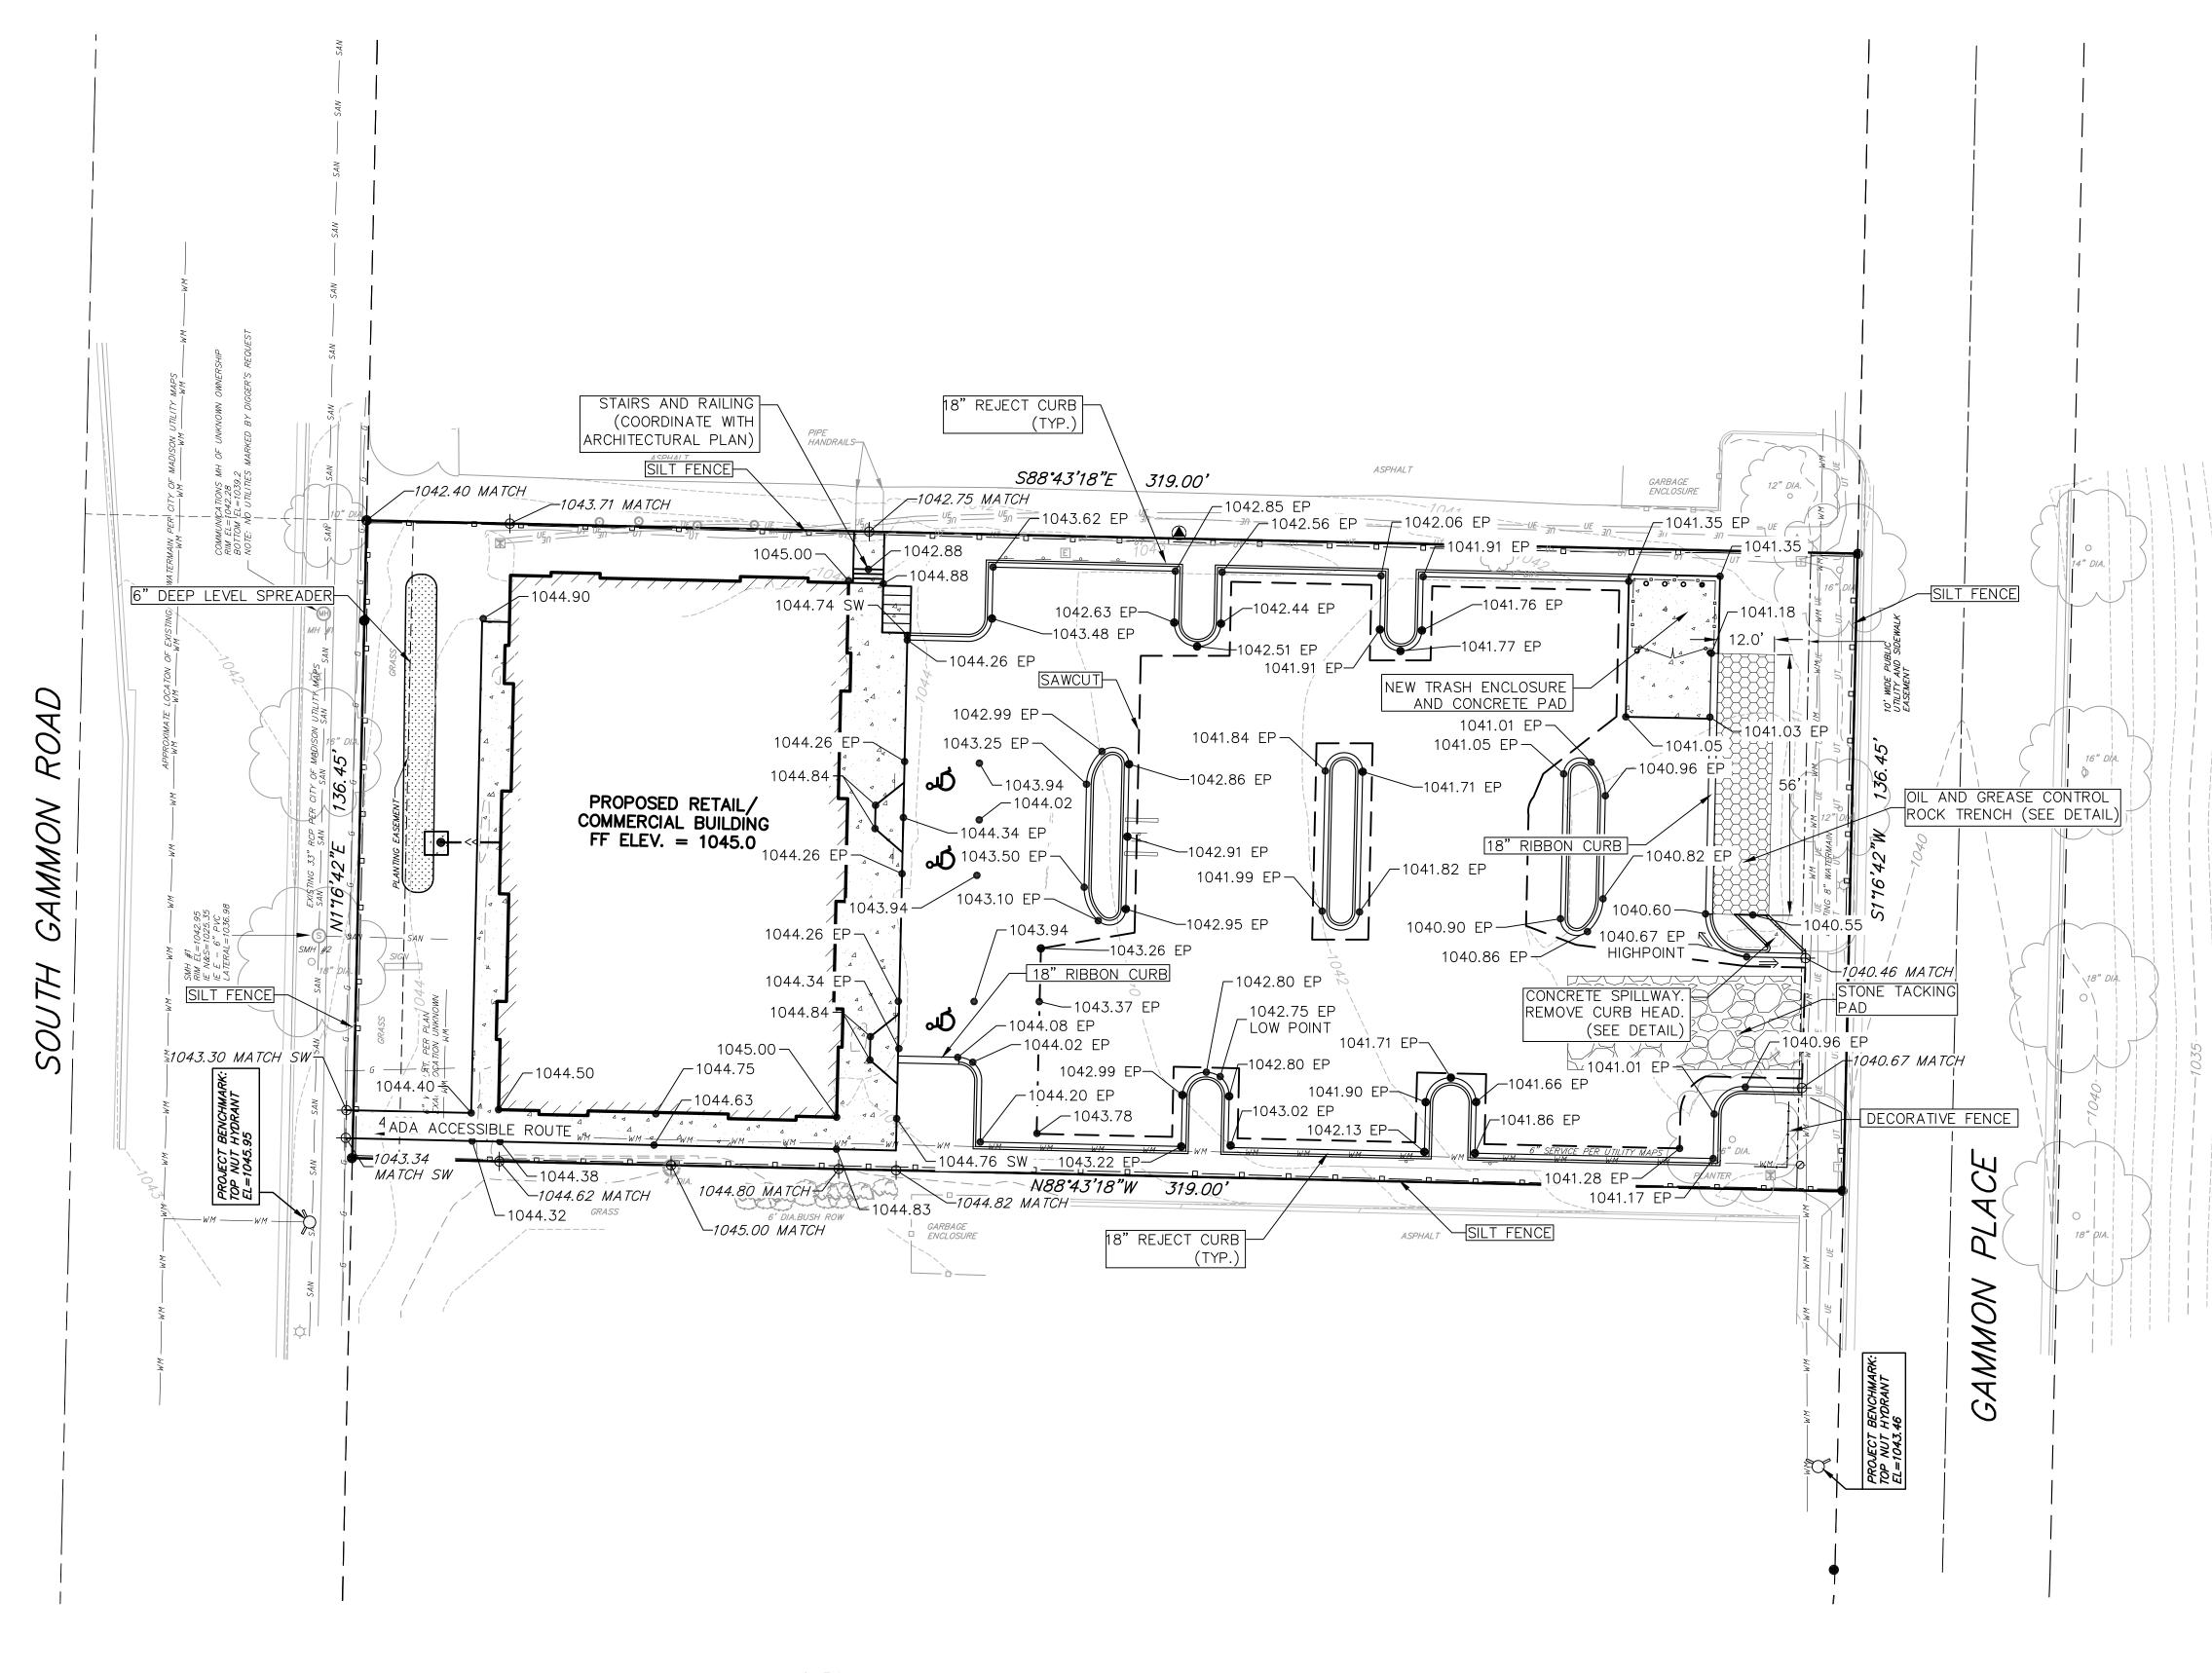

<u>GENERAL NOTES:</u>

- 1. THE LOCATION OF EXISTING UNDERGROUND UTILITIES AS SHOWN ON THE PLANS HAS BEEN DETERMINED FROM THE BEST AVAILABLE INFORMATION AND IS GIVEN FOR THE CONVENIENCE OF THE CONTRACTOR. THE OWNER AND THE ENGINEER DO NOT ASSUME RESPONSIBILITY IN THE EVENT THAT DURING CONSTRUCTION, UTILITIES OTHER THAN THOSE SHOWN MAY BE ENCOUNTERED, AND THAT THE ACTUAL LOCATION OF THOSE WHICH ARE SHOWN MAY BE DIFFERENT FROM THE LOCATION AS SHOWN ON THE PLANS.
- 2. ACCESSIBLE ROUTES SHALL BE 5% MAX LONGITUDINAL SLOPE AND 2% MAX CROSS SLOPE. ACCESSIBLE LOADING AREAS OR LANDINGS SHALL BE 2% MAX IN ANY DIRECTION. RAMPS SHALL BE 8.33% MAX.
- 3. CONTOURS ARE SHOWN FOR PURPOSES OF INDICATING ROUGH GRADING.
- 4. FINAL GRADE SHALL BE ESTABLISHED ON PAVED SURFACES BY USING SPOT GRADES ONLY.
- 5. SEE CONSTRUCTION DETAIL SHEET FOR EROSION CONTROL NOTES AND CONSTRUCTION SEQUENCE



GRADING AND EROSION CONTROL



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201211 DEHL DRAWN BY DATE: SCALE:

PRELIMINARY REV. 1

AS NOTED 06.05.2013

06.24.2013

EROSION CONTROL MEASURES

EROSION CONTROL SHALL BE IN ACCORDANCE WITH THE CITY OF MADISON EROSION CONTROL ORDINANCE AND CHAPTER NR 216 OF THE WISCONSIN ADMINISTRATIVE CODE.

2. CONSTRUCT AND MAINTAIN ALL EROSION AND SEDIMENT CONTROL MEASURES IN ACCORDANCE WITH WISCONSIN DNR TECHNICAL STANDARDS (http://dnr.wi.gov/runoff/stormwater/techstds.htm) AND WISCONSIN CONSTRUCTION SITE BEST MANAGEMENT PRACTICE HANDBOOK.

3. INSTALL SEDIMENT CONTROL PRACTICES (TRACKING PAD, PERIMETER SILT FENCE, SEDIMENT BASINS, ETC.) PRIOR TO INITIATING OTHER LAND DISTURBING CONSTRUCTION ACTIVITIES.

4. THE CONTRACTOR IS REQUIRED TO MAKE EROSION CONTROL INSPECTIONS AT THE END OF EACH WEEK AND WHEN 0.5 INCHES OF RAIN FALLS WITHIN 24 HOURS. INSPECTION REPORTS SHALL BE PREPARED AND FILED AS REQUIRED BY THE DNR AND/OR CITY. ALL MAINTENANCE WILL FOLLOW AN INSPECTION WITHIN 24 HOURS.

5. EROSION CONTROL IS THE RESPONSIBILITY OF THE CONTRACTOR UNTIL ACCEPTANCE OF THIS PROJECT. EROSION CONTROL MEASURES AS SHOWN SHALL BE THE MINIMUM PRECAUTIONS THAT WILL BE ALLOWED. ADDITIONAL EROSION CONTROL MEASURES, AS REQUESTED IN WRITING BY THE STATE OR LOCAL INSPECTORS, OR THE DEVELOPER'S ENGINEER, SHALL BE INSTALLED WITHIN 24 HOURS.

6. A 3" CLEAR STONE TRACKING PAD SHALL BE INSTALLED AT THE END OF ROAD CONSTRUCTION LIMITS TO PREVENT SEDIMENT FROM BEING TRACKED ONTO THE ADJACENT PAVED PUBLIC ROADWAY. SEDIMENT TRACKING PAD SHALL CONFORM TO WISDNR TECHNICAL STANDARD 1057. SEDIMENT REACHING THE PUBLIC ROAD SHALL BE REMOVED BY STREET CLEANING (NOT HYDRAULIC FLUSHING) BEFORE THE END OF EACH WORK DAY.

7. CHANNELIZED RUNOFF: FROM ADJACENT AREAS PASSING THROUGH THE SITE SHALL BE DIVERTED AROUND DISTURBED AREAS.

8. STABILIZED DISTURBED GROUND: ANY SOIL OR DIRT PILES WHICH WILL REMAIN IN EXISTENCE FOR MORE THAN 7-CONSECUTIVE DAYS, WHETHER TO BE WORKED DURING THAT PERIOD OR NOT, SHALL NOT BE LOCATED WITHIN 25-FEET OF ANY ROADWAY, PARKING LOT, PAVED AREA, OR DRAINAGE STRUCTURE OR CHANNEL (UNLESS INTENDED TO BE USED AS PART OF THE EROSION CONTROL MEASURES). TEMPORARY STABILIZATION AND CONTROL MEASURES (SEEDING. MULCHING. TARPING. EROSION MATTING. BARRIER FENCING. ETC.) ARE REQUIRED FOR THE PROTECTION OF DISTURBED AREAS AND SOIL PILES. WHICH WILL REMAIN UN-WORKED FOR A PERIOD OF MORE THAN 7-CONSECUTIVE CALENDAR DAYS. THESE MEASURES SHALL REMAIN IN PLACE UNTIL SITE HAS STABILIZED.

9. <u>SITE DE-WATERING:</u> WATER PUMPED FROM THE SITE SHALL BE TREATED BY TEMPORARY SEDIMENTATION BASINS OR OTHER APPROPRIATE CONTROL MEASURES. SEDIMENTATION BASINS SHALL HAVE A DEPTH OF AT LEAST 3 FEET, BE SURROUNDED BY SNOWFENCE OR EQUIVALENT BARRIER AND HAVE SUFFICIENT SURFACE AREA TO PROVIDE A SURFACE SETTLING RATE OF NO MORE THAN 750 GALLONS PER SQUARE FOOT PER DAY AT THE HIGHEST DEWATERING PUMPING RATE. WATER MAY NOT BE DISCHARGED IN A MANNER THAT CAUSES EROSION OF THE SITE, A NEIGHBORING SITE, OR THE BED OR BANKS OF THE RECEIVING WATER. POLYMERS MAY BE USED AS DIRECTED BY DNR TECHNICAL STANDARD 1061 (DE-WATERING).

10. SEE DETAIL SHEETS FOR RIP-RAP SIZING. IN NO CASE WILL RIP-RAP BE SMALLER THAN 3" TO 6".

11. RESTORATION (SEED, FERTILIZE AND MULCH) SHALL BE PER SPECIFICATIONS ON THIS SHEET (NOTE: ADD SEEDING RATE STANDARD OF DETAIL BLOCK TO PLAN) UNLESS SPECIAL RESTORATION IS CALLED FOR ON THE LANDSCAPE PLAN.

12. LAWN AREAS SHALL BE RESTORED WITH 6" TOPSOIL, TEMPORARY SEED, FERTILIZER AND MULCH.

13. SEED, FERTILIZER AND MULCH SHALL BE APPLIED WITHIN 7 DAYS AFTER FINAL GRADE HAS BEEN ESTABLISHED. IF DISTURBED AREAS WILL NOT BE RESTORED IMMEDIATELY AFTER ROUGH GRADING, TEMPORARY SEED SHALL BE PLACED.

14. FOR THE FIRST SIX WEEKS AFTER RESTORATION (E.G. SEED & MULCH, EROSION MAT, SOD) OF A DISTURBED AREA, INCLUDE SUMMER WATERING PROVISIONS OF ALL NEWLY SEEDED AND MULCHED AREAS WHENEVER 7 DAYS ELAPSE WITHOUT A RAIN EVENT.

15. EROSION MAT (CLASS I, TYPE A URBAN PER WISCONSIN D.O.T. P.A.L.) SHALL BE INSTALLED ON ALL SLOPES 3:1 OR GREATER BUT LESS THAN 1:1.

16. EROSION MAT (CLASS I, TYPE B URBAN PER WISCONSIN D.O.T. P.A.L.) SHALL BE INSTALLED ON THE BOTTOM (INVERT) OF ROADSIDE DITCHES/SWALES AS SHOWN ON THIS PLAN, 1 ROLL WIDTH.

17. SOIL STABILIZERS SHALL BE APPLIED TO DISTURBED AREAS WITH SLOPES BETWEEN 10% AND 3:1 (DO NOT USE IN CHANNELS). SOIL STABILIZERS SHALL BE TYPE B, PER WISCONSIN D.O.T. P.A.L. (PRODUCT ACCEPTABILITY LIST), OR EQUAL. APPLY AT RATES AND METHODS SPECIFIED PER MANUFACTURER. SOIL STABILIZERS SHALL BE RE-APPLIED WHENEVER VEHICLES OR OTHER EQUIPMENT TRACK ON THE AREA.

18. SILT FENCE OR EROSION MAT SHALL BE INSTALLED ALONG THE CONTOURS AT 100 FOOT INTERVALS DOWN THE SLOPE ON THE DISTURBED SLOPES STEEPER THAN 5% AND MORE THAN 100 FEET LONG THAT SHEET FLOW TO THE ROADWAY UNLESS SOIL STABILIZERS ARE USED.

19. SILT FENCE TO BE USED ACROSS AREAS OF THE LOT THAT SLOPE TOWARDS A PUBLIC STREET OR WATERWAY. SEE DETAILS.

20. SEDIMENT SHALL BE CLEANED FROM CURB AND GUTTER AFTER EACH RAINFALL AND PRIOR TO PROJECT ACCEPTANCE.

21. ANY PROPOSED CHANGES TO THE EROSION CONTROL PLAN MUST BE SUBMITTED AND APPROVED BY CITY OF MADISON ENGINEERING.

22. THE CITY, OWNER AND/OR ENGINEER MAY REQUIRE ADDITIONAL EROSION CONTROL MEASURES AT ANY TIME DURING CONSTRUCTION.

STEEL OR WOOD POST -FENCE SUPPORT MESH (OPTIONAL) SEE NOTE 4 -BACKFILLED AND COMPACTED SOIL 6" (MIN.) TRENCH 18" (MIN.) ⁾ 6" (MIN.)

NOTES:

1. INSTALL SILT FENCE TO FOLLOW THE GROUND CONTOURS AS CLOSELY AS POSSIBLE.

2. CURVE THE SILT FENCE UP THE SLOPE TO PREVENT WATER FROM RUNNING AROUND THE

3. POST SPACING WITH FENCE SUPPORT MESH = 10 FT. (MAX.)

POST SPACING WITHOUT FENCE SUPPORT MESH = 6 FT. (MAX.)

4. SILT FENCE SUPPORT MESH CONSISTS OF 14-GAUGE STEEL WIRE WITH A MESH SPACING OF 6 IN. X 6 IN. OR PREFABRICATED POLYMERIC MESH OF EQUIVALENT STRENGTH



SIDEWALK, AND PARKING AREA PER DEMOLITION PLAN.

3. ROUGH GRADE DISTURBED AREA

5. CONSTRUCT UNDERGROUND UTILITIES

6. CONSTRUCT PARKING AREAS (STONE

7. CONSTRUCT OIL AND GREASE CONTROL

8. REMOVE TRACKING PAD AND SILT

SEEDING RATES:

SUMMER PLANTINGS. 2. USE WINTER WHEAT OR RYE AT 3.0 LB./1,000 SF FOR FALL PLANTINGS STARTED AFTER SEPTEMBER 15.

1. USE WISCONSIN D.O.T. SEED MIX #40 AT 2 LB./1,000 S.F.

FERTILIZING RATES:

TEMPORARY AND PERMANENT:

USE WISCONSIN D.O.T. TYPE A OR B AT 7 LB./1,000 S.F.

TEMPORARY AND PERMANENT:

USE ½" TO 1-½" STRAW OR HAY MULCH, CRIMPED PER SECTION 607.3.2.3, OR OTHER RATE AND METHOD PER SECTION 627, WISCONSIN D.O.T. STANDARD SPECIFICATIONS FOR HIGHWAY AND STRUCTURE CONSTRUCTION

CONSTRUCTION SEQUENCE:

1. INSTALL SILT FENCE/SILT SOCK AND TRACKING PAD

2. DEMOLITION OF EXISTING BUILDING,

4. SEED AND EROSION MAT THE DISTURBED PROPOSED LAWN AREAS


BASE, CURB & GUTTER, AND SIDEWALK).


ROCK TRENCH (PER DETAIL).

FENCE/SILT SOCK

1. USE ANNUAL OATS AT 3.0 LB./1,000 S.F. FOR SPRING AND

MULCHING RATES:

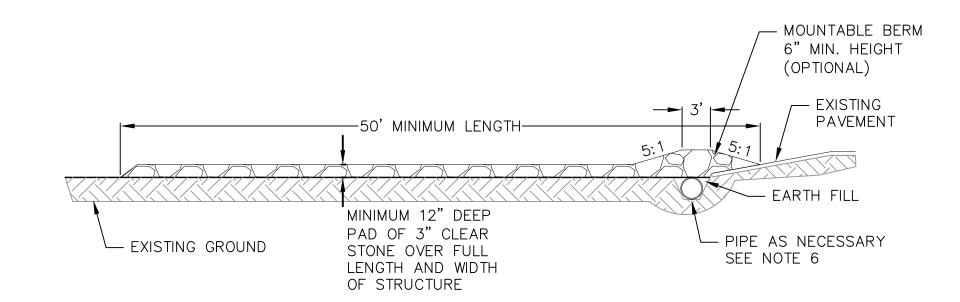

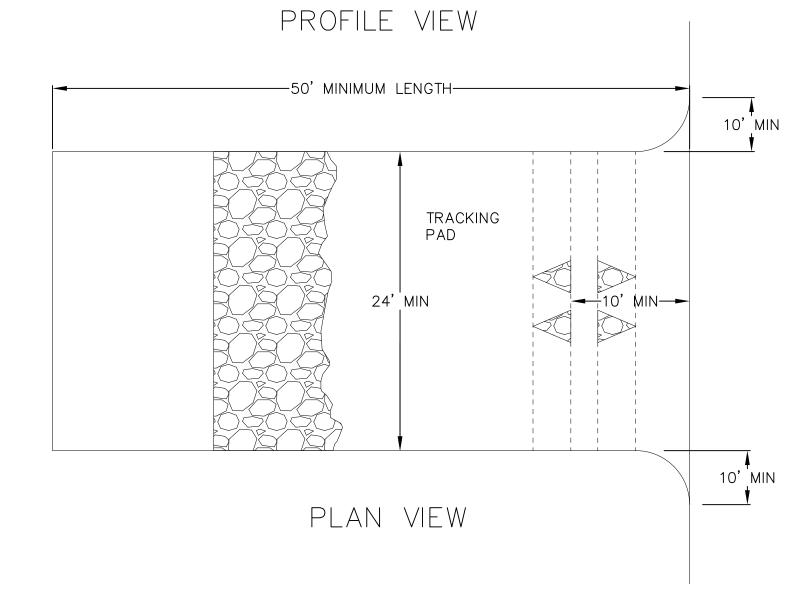

1. FOLLOW WISCONSIN DNR TECHNICAL STANDARD 1057 FOR FURTHER DETAILS AND INSTALLATION.

2. LENGTH - MINIMUM OF 50'.

3. WIDTH - 24' MINIMUM, SHOULD BE FLARED AT THE EXISTING ROAD TO PROVIDE A TURNING RADIUS.


4. ON SITES WITH A HIGH GROUND WATER TABLE OR WHERE SATURATED CONDITIONS EXIST, GEOTEXTILE FABRICSHALL BE PLACED OVER EXISTING GROUND PRIOR TO PLACING STONE. FABRIC SHALL BE WISDOT TYPE-HR GEOTEXTILE FABRIC.

5. STONE - CRUSHED 3" CLEAR STONE SHALL BE PLACED AT LEAST 12" DEEP OVER THE ENTIRE LENGTH AND WIDTH OF ENTRANCE.

6. SURFACE WATER - ALL SURFACE WATER FLOWING TO OR DIVERTED TOWARDS CONSTRUCTION ENTRANCES SHALL BE PIPED THROUGH THE ENTRANCE. MAINTAINING POSITIVE DRAINAGE. PIPE INSTALLED THROUGH THE STABILIZED CONSTRUCTION ENTRANCE SHALL BE PROTECTED WITH A MOUNTABLE BERM WITH 5:1 SLOPES AND MINIMIUM OF 6" STONE OVER THE PIPE. PIPE SHALL BE SIZED ACCORDING TO THE DRAINAGE REQUIREMENTS. WHEN THE ENTRANCE IS LOCATED AT A HIGH SPOT AND HAS NO DRAINAGE TO CONVEY A PIPE SHALL NOT BE NECESSARY. THE MINIMUM PIPE DIAMETER SHALL BE 6". CONTRACTOR SHALL BE RESPONSIBLE FOR THE MAINTENANCE OF SAID PIPE.

7. LOCATION - A STABILIZED CONSTRUCTION ENTRANCE SHALL BE LOCATED WHERE CONSTRUCTION TRAFFIC ENTERS AND/OR LEAVES THE CONSTRUCTION SITE. VEHICLES LEAVING THE SITE MUST TRAVEL OVER THE ENTIRE LENGTH OF THE TRACKING PAD.



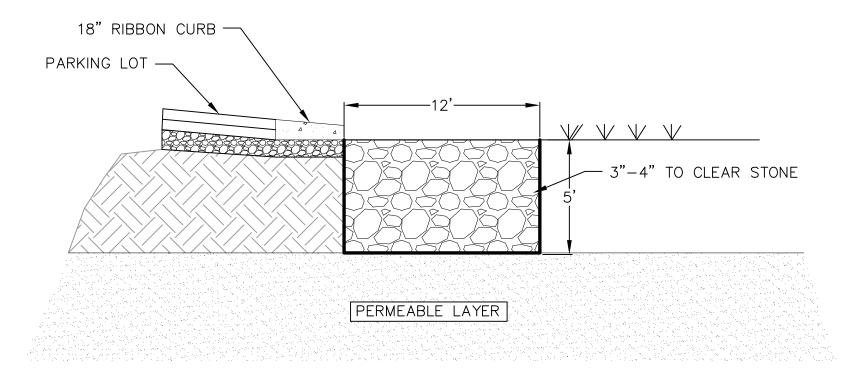





GARY BRINK & ASSOCIATES ARCHITECTS

8401 EXCELSIOR DRIVE MADISON, WI 53717 608-829-1750 608-829-3056 (FAX)



GAMMON IMON PLACE


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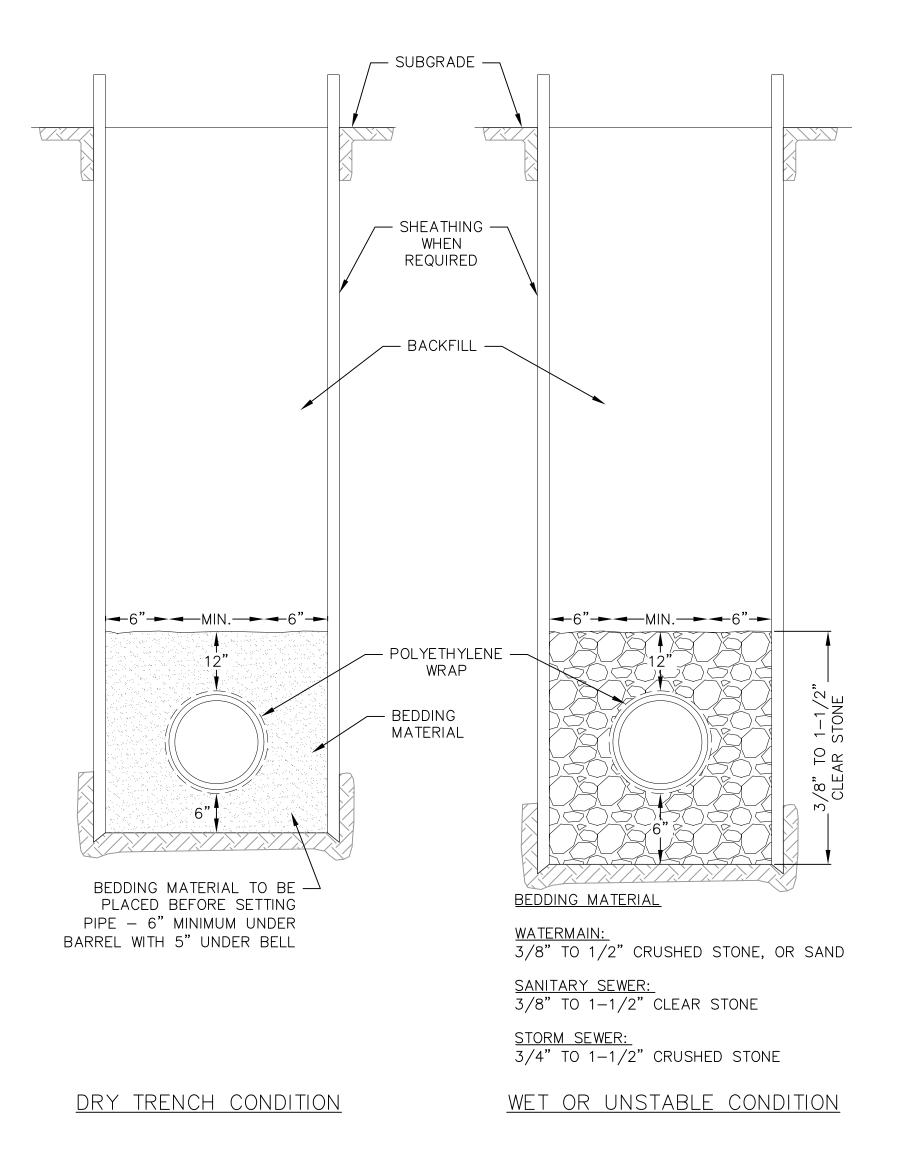
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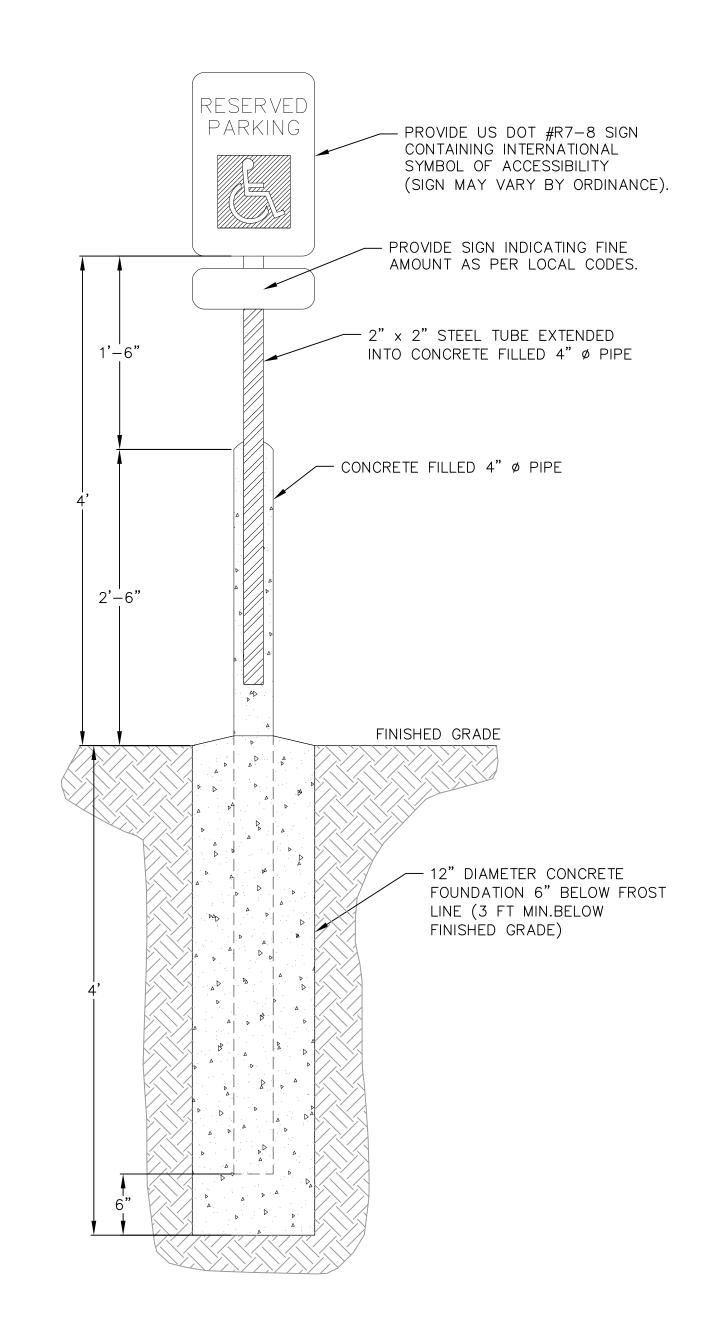
CONSTRUCTION DETAILS



1 HANDICAP STRIPING


NOT TO SCALE



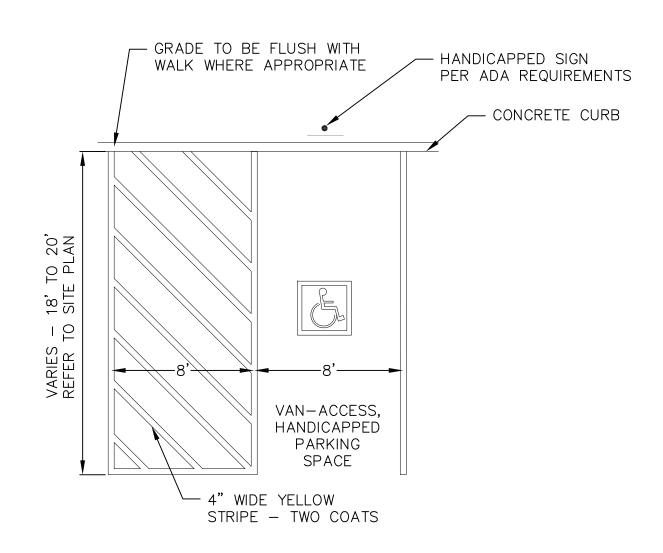


1 HANDICAP PARKING SIGN


1 NOT TO SCALE

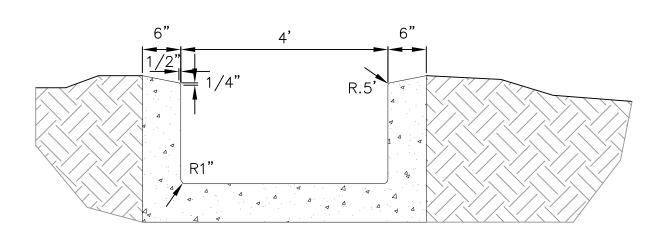

1 CONCRETE SPILLWAY/CURB CUT

1 NOT TO SCALE

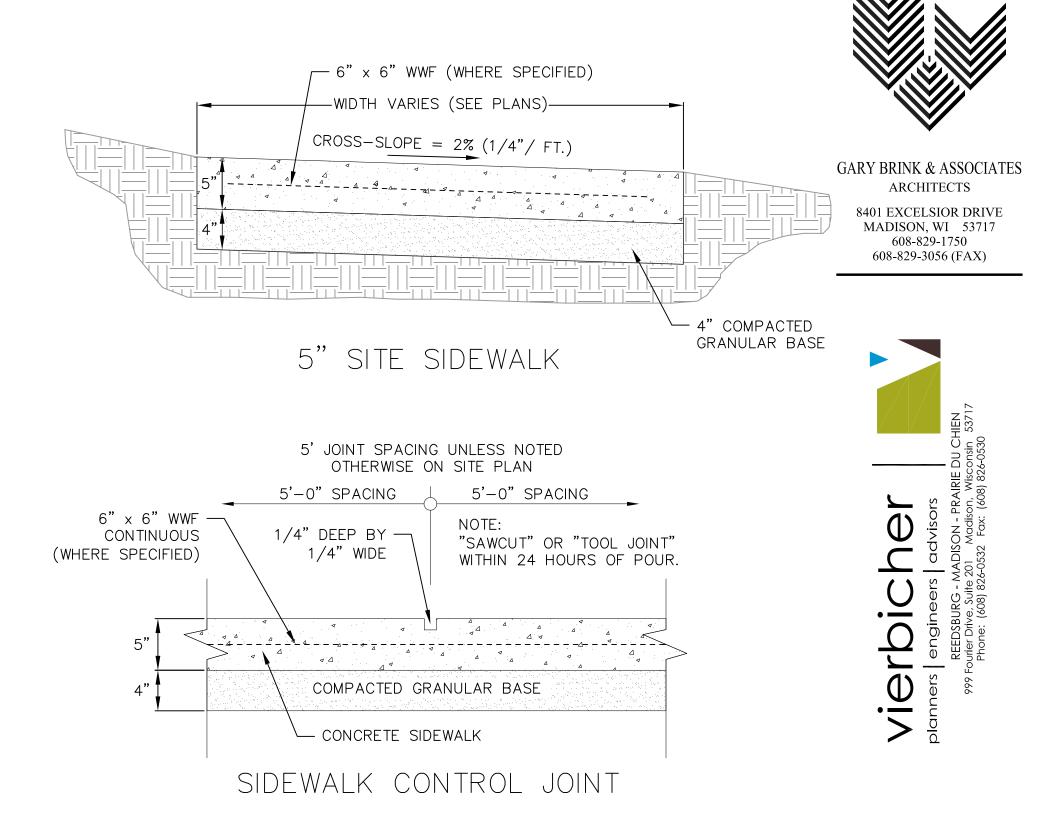

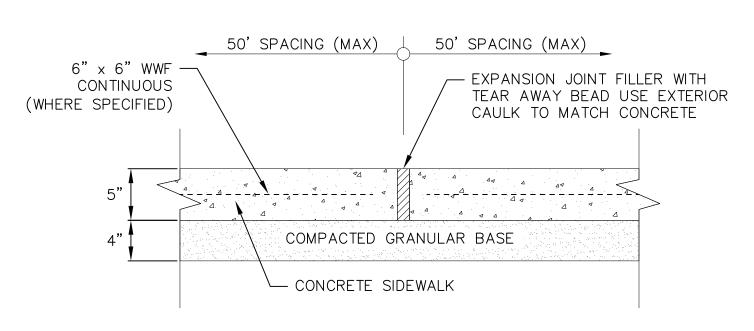

SIDEWALK EXPANSION JOINT



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PROJECT:

GAMMON PLACE
JN, WI 53719


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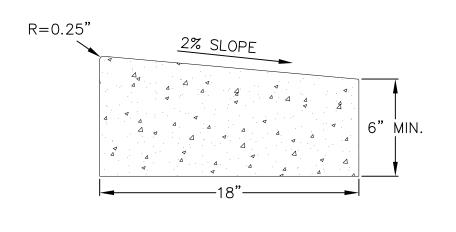
CONSTRUCTION DETAILS

C6.0






CURBED SIDEWALK SITE DETAIL NOT TO SCALE

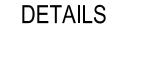


RIBBON CURB

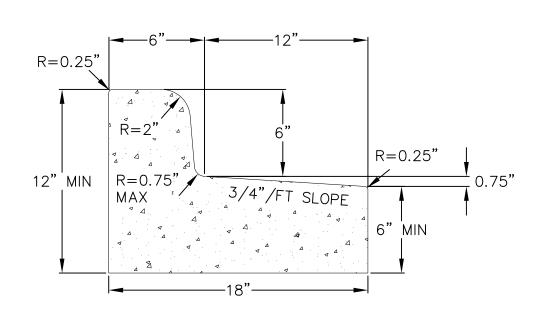


CURB AND GUTTER REJECT SECTION



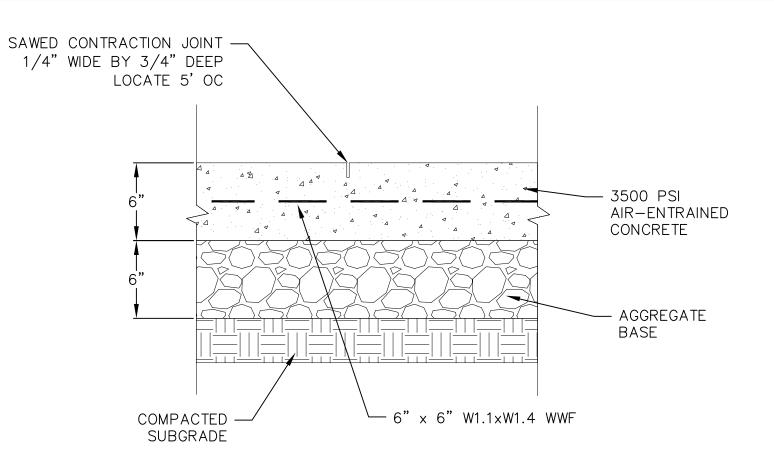



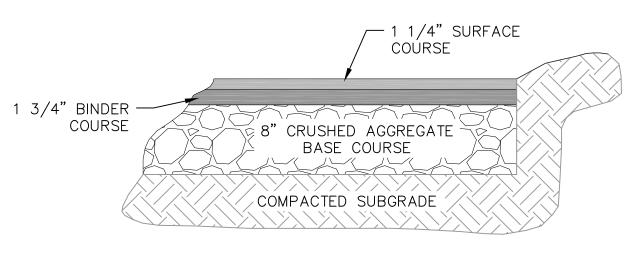

BITUMINOUS PAVEMENT PARKING LOT

GENERAL NOTES

ON THE RAMP.

RAMPS SHALL BE BUILT AT 12:1 OR FLATTER.


WHEN NECESSARY, THE SIDEWALK ELEVATION MAY BE LOWERED TO MEET THE HIGH POINT





GARY BRINK & ASSOCIATES
ARCHITECTS

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MADISON, WI 53717
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VIETDICT
planners | engineers | a

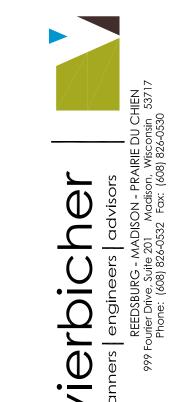REEDSBURG - MAD

999 Fourier Drive, Suite 201
Phone: (608) 826-055

OWNE DEVELOPMENT

420 GAMMON PLACE
MADISON, WI 53719
CLIENT:

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PRELIMINARY

RAMP PLAN VIĘW

15'-0"

5'-0"

10:1 SLOPE (MAX)

10:1 MAX


5'-0"


/ WARNING FIELD


10:1 MAX

5'-0"

- CONCRETE RAMP

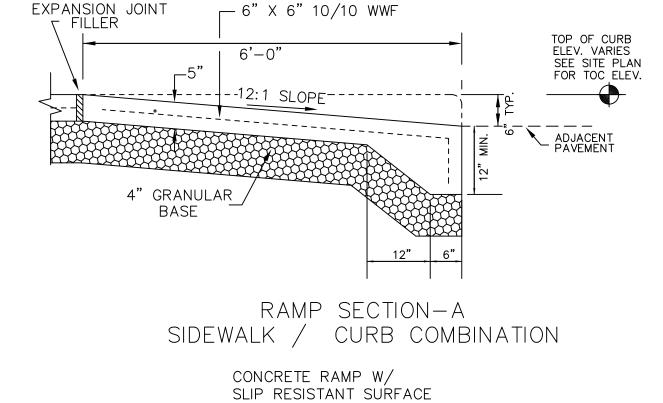

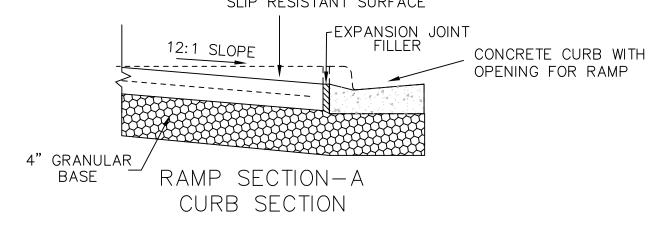

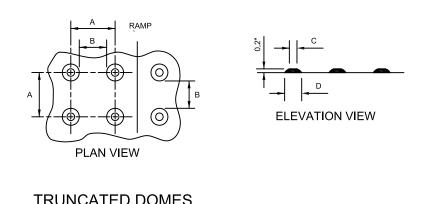

TRUNCATED DOMES


DETECTABLE WARNING
PATTERN DETAIL

NOTE: 1) MATERIALS AND METHOD OF CONSTRUCTION FOR TRUNCATED DOMES SHALL BE SPECIFIED IN SPECIAL PROVISIONS OR AS REQUIRED BY THE VILLAGE ENGINEER

2) COLOR SHALL BE A DISSIMILAR COLOR FROM THE ADJACENT PAVED SURFACE AND APPROVED BY THE OWNER AND

CONSTRUCTION DETAILS

 $\overline{C70}$

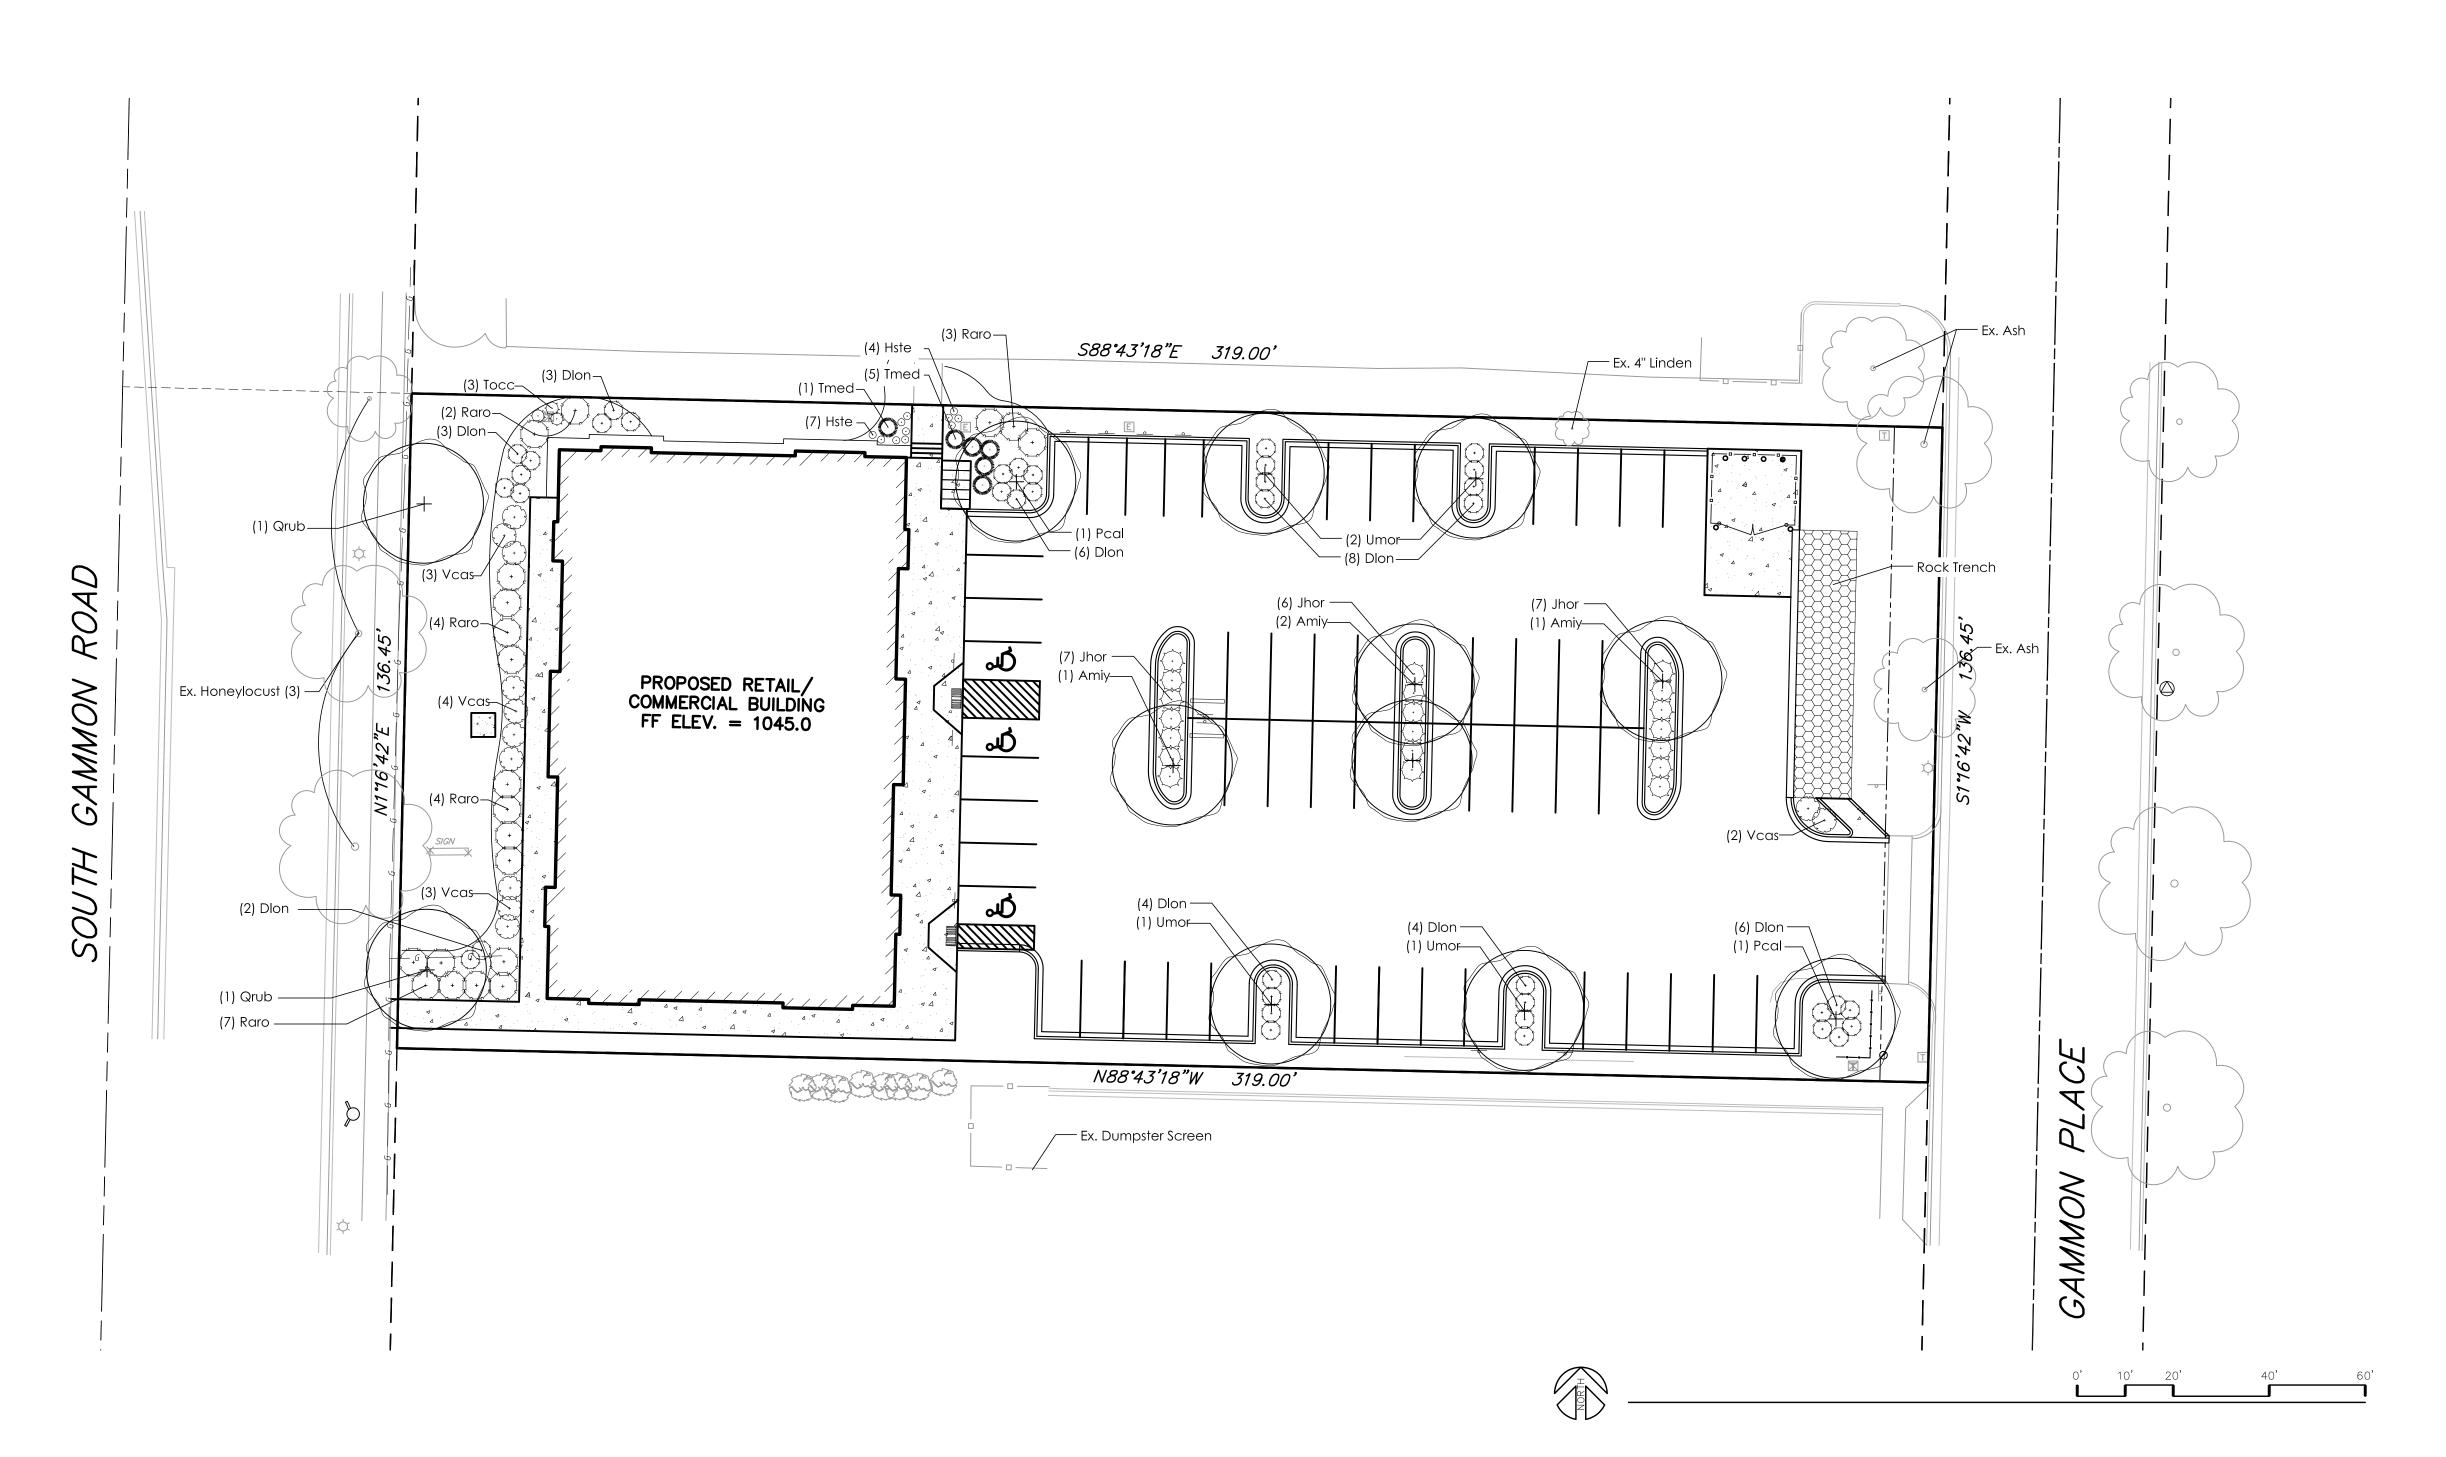

Plant List							
	· .					T	
key	qty.	botanical name	common name	planting size	root cond.	mature size	
			shade trees				
Amiy	4	Acer miyabei 'Morton'	State Street Maple	2.5" cal.	B&B	50' x 40'	
Pcal	2	Pyrus calleryana 'Cleveland Select'	Cleveland Select Pear	2.5" cal.	B&B	35' x 15'	
Qrub	2	Quercus rubra	Red Oak	2.5" cal.	B&B	wi native	
Umor	4	Ulmus 'Morton Glossy'	Triumph Elm	2.5" cal.	B&B	55' x 45'	
	•			<u>'</u>			
			deciduous shrubs				
Dlon	36	Diervilla Ionicera	Dwarf Bush-Honeysuckle	#5	cont.	3' x 4'	
Raro	20	Rhus aromatica 'Gro-low'	Gro-low Sumac	#5	cont.	30" x 6'	
Vcas	12	Viburnum cassinoides	Witherod Viburnum	#5	cont.	4' x 5'	
				·	•		
			evergreen shrubs				
Jhor	20	Juniperus horizontalis 'Wisconsin'	Wisconsin Juniper	#5	cont.	8" x 5'	
Tmed	6	Taxus x media 'Everlow'	Everlow Yew	#5	cont.	30" x 4'	
Тосс	3	Thuja occidentalis 'Holmstrup'	Holmstrup Arb	5' ht.	cont.	14' x 3'	
	•			<u>'</u>			
			perennials				
Hste	11	Hemerocallis 'Stella d'Oro'	Stella D'Oro Daylily	#1	cont.	18" x 18"	

LANDSCAPING REQUIREMENTS: CITY OF MADISON

Total Developed Area: 43,527.6 SF Developed Area / 300 SF= 145.1 Landscape Units

Landscape Units x 5 landscape points = 725.5 Total Points Required

Credit for Existing Landscape: 105 Points

Overstory Deciduous Tree: 3 x 35 points = 105

Total for Proposed Landscape: 665 Points

Overstory Deciduous Tree: 12×35 points = 420 0×15 points = 0Ornamental Tree: 0×15 points = 0**Evergreen Tree:** Deciduous Shrub: $68 \times 2 \text{ points} = 136$ **Evergreen Shrub:** $29 \times 3 \text{ points} = 87$ 11 x 2 points = 22 Perennial:

Total Points Provided: 770 Points

GENERAL NOTES:

1. All plantings shall conform to quality requirements as per ANSI Z60.1.

2. All plant material shall be true to the species, variety and size specified, nursery grown in accordance with good horticultural practices, and under climactic conditions similar to those of the project site.

3. Contact Landscape Architect, in writing, to request and plant material substitutions due to

4. All disturbed areas, unless otherwise noted, to be seeded with Madison Parks Mix by Olds Seed Company or equivalent, per manufacturer's specified application rates. All seeded areas are to be watered daily to maintain adequate soil moisture for proper germination. After vigorous growth is established, apply $\frac{1}{2}$ " water twice weekly until final acceptance.

5. All plants shall be guaranteed to be in healthy and flourishing condition during the growing season following installation. All plant material shall be guaranteed for one year from the time of installation. 6. Contractor shall provide a suitable amended topsoil blend for all planting areas where soil conditions are unsuitable for plant growth. Topsoil shall conform to quality requirements as per Section 625.2(1) of the Standard Specifications for Highway Construction. Provide a minimum of 12"

of topsoil in all planting areas and 6" of topsoil in areas to be seeded/sodded. 7. Landscape beds to be mulched with undyed shredded hardwood bark mulch to 3" depth min.

8. Landscape beds to be edged with black vinyl edging, Black Diamond or equal. **9**. Protect existing trees from damage due to construction activity.



GARY BRINK & ASSOCIATES ARCHITECTS

8401 EXCELSIOR DRIVE MADISON, WI 53717 608-829-1750 608-829-3056 (FAX)



ELOPMENT

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authorization is received ASSOC.	authorization is received from GARY BRINK & ASSOC.		
PROJECT:	20121		
DRAWN BY:	SVIN		
DATE:			
SCALE:	AS NOTEI		
PRELIMINARY	06.05.201		

REV. #1

06.24.2013

LANDSCAPE