
EXTERIOR RETAIL RENOVATION

434 GAMMON PLACE MADISON, WISCONSIN PLAN COMMISSION SUBMITTAL

APRIL 8, 2015

PROJECT LOCATION:

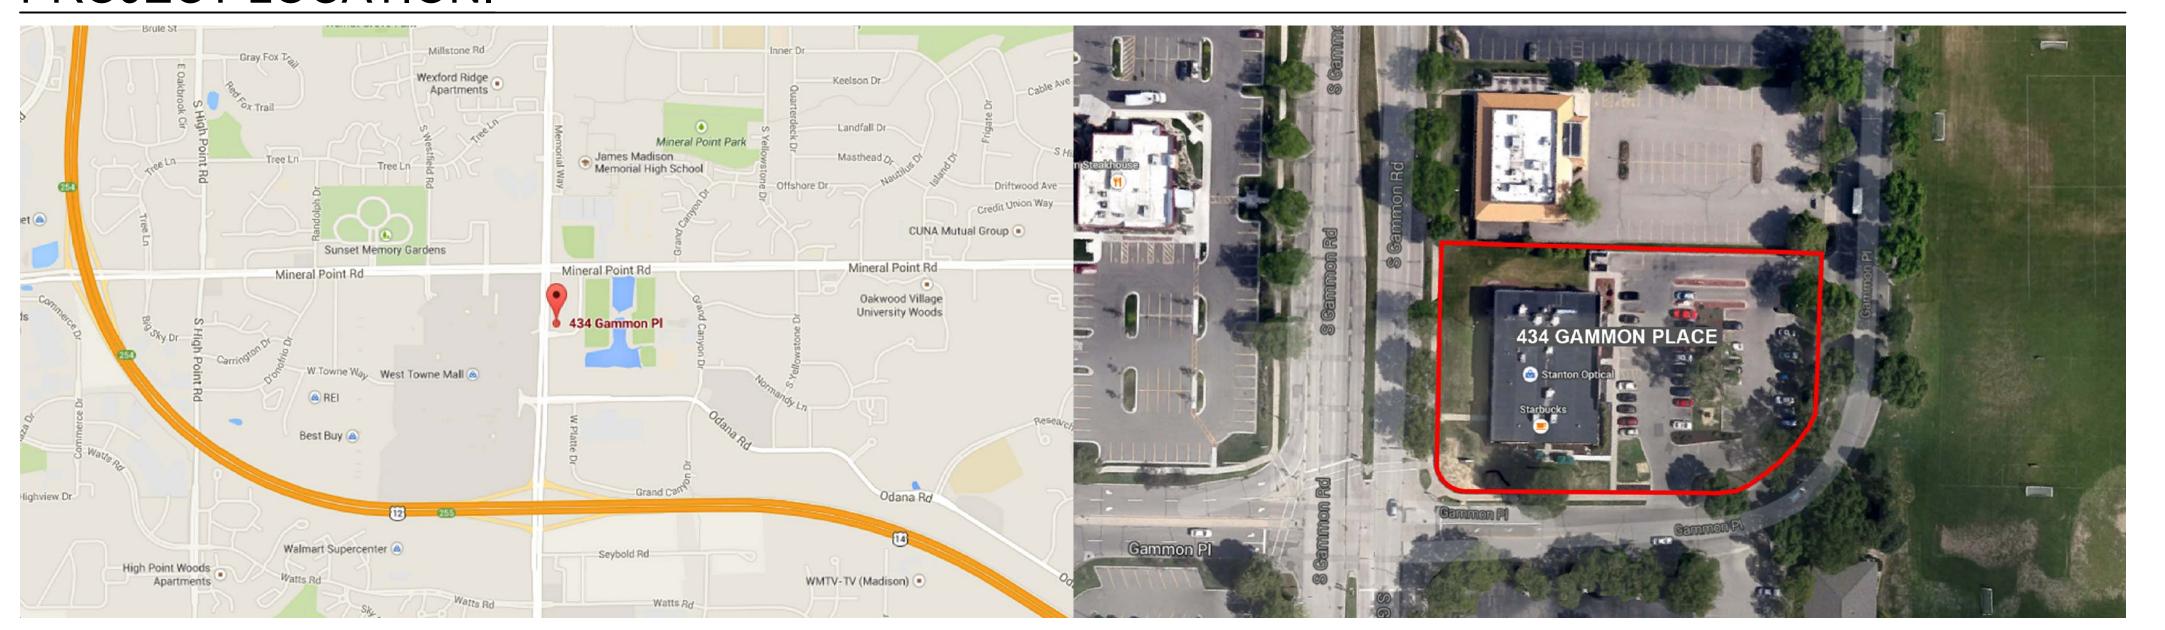

OWNER / DEVELOPER :

434 GAMMON INVESTORS, LLC 7601 UNIVERSITY AVENUE

SUITE 202

MIDDLETON, WISCONSIN 53562 PHONE: (608) 203-6174 CELL: (608) 334-4046

EMAIL: jeff@kraemerdevelopment.com

CONTACT: JEFF KRAEMER

ARCHITECT:

GARY BRINK & ASSOCIATES, INC. 7780 ELMWOOD AVENUE

SUITE 204

MIDDLETON, WISCONSIN 53562 PHONE: (608) 829-1750 CELL: (608) 695-3674 gary.brink@garybrink.com EMAIL:

CONTACT: GARY BRINK

LANDSCAPE DESIGNER

wade.wyse@wyserengineering.com

OLSON TOON LANDSCAPING, INC. 4387 SCHWARTZ ROAD

MIDDLETON, WISCONSIN 53562 PHONE: (608) 827-9401 brad@olsontoon.com CONTACT: BRAD FREGIEN

CIVIL ENGINEER

MOUNT HOREB, WISCONSIN 53572

(608) 843-3388

WYSER ENGINEERING

201 ½ EAST MAIN STREET

CONTACT: WADE WYSE

PHONE:

SHEET INDEX

T-1 COVER SHEET, PROJECT CONTACTS & SHEET INDEX

CIVIL DRAWINGS C100 SITE PLAN

C200 GRADING AND EROSION CONTROL PLAN


LANDSCAPE DRAWINGS L1.0 LANDSCAPE PLAN

ARCHITECTURAL DRAWINGS A2.02 FLOOR PLAN A6.01 PROPOSED EXTERIOR ELEVATIONS

P.C. SUBMITTAL

COVER SHEET PROJECT INFO. SHEET INDEX

14)

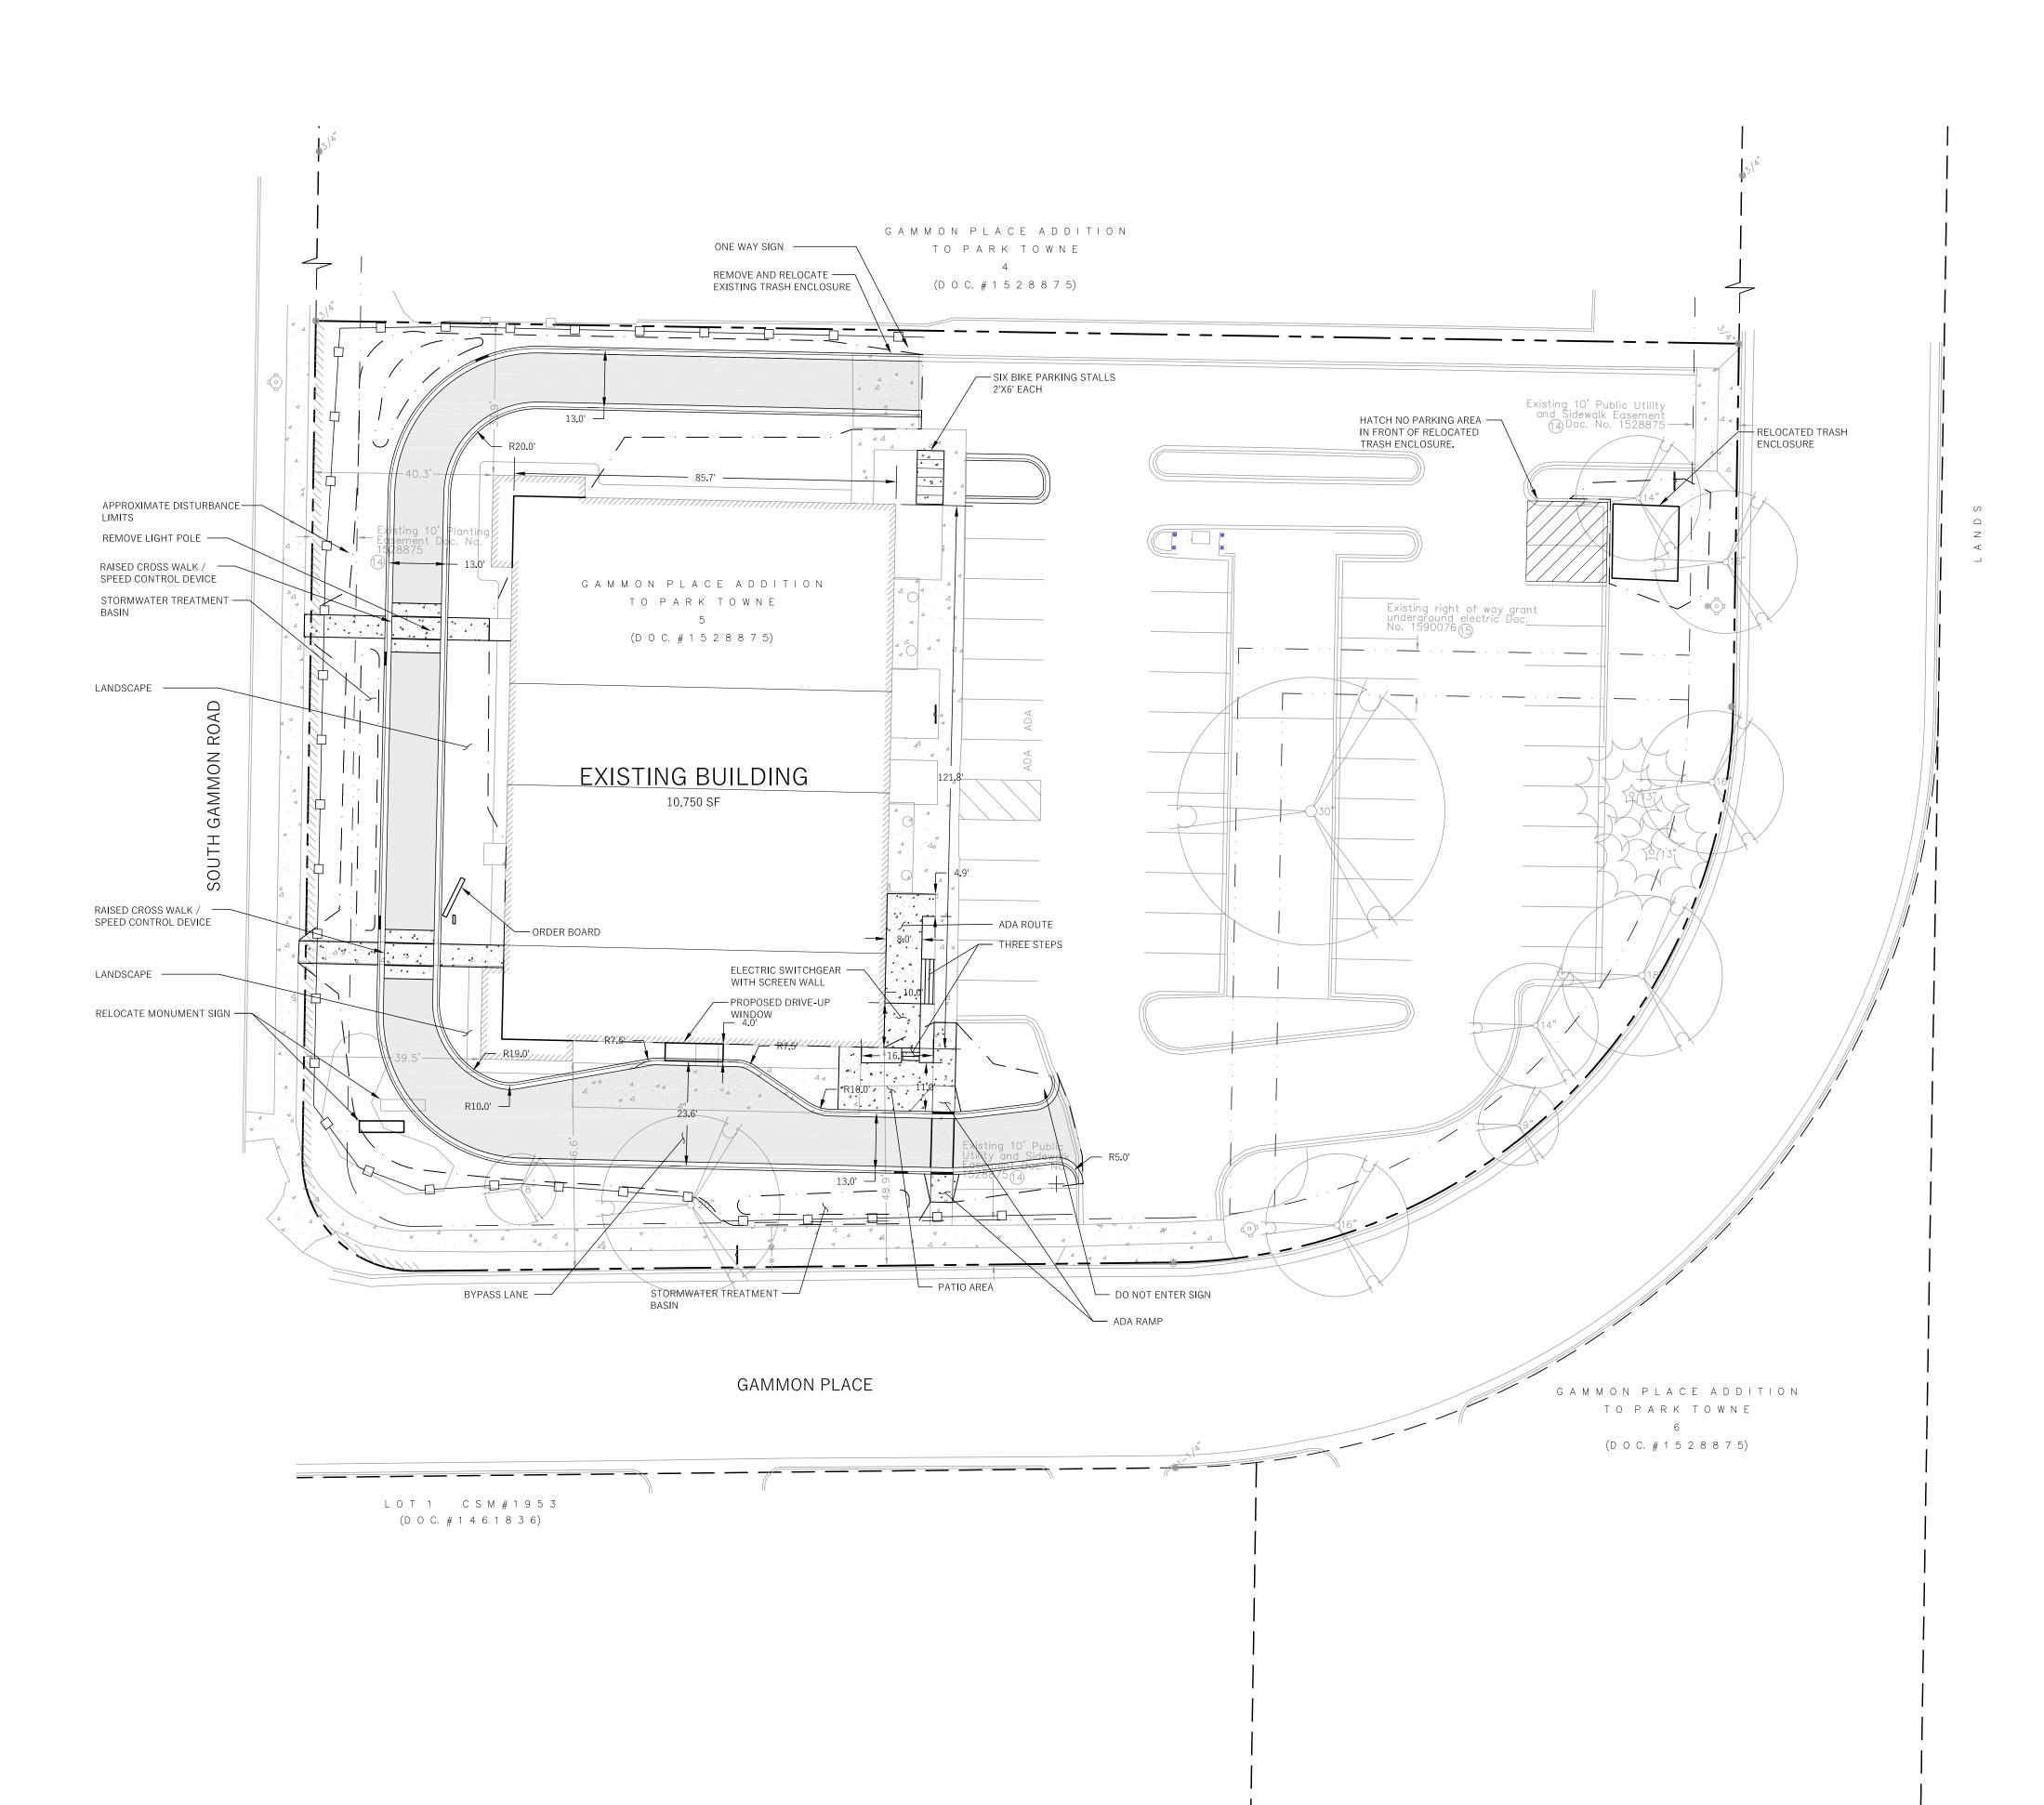

LEGEND (PROPOSED)

PROPOSED PROPERTY BOUNDARY

EASEMENT

BUILDING FOOTPRINT

18" CURB AND GUTTER

ASPHALT PAVEMENT

CONCRETE PAVEMENT

STORMWATER TREATMENT FACILITY

LIMITS OF DISTURBANCE



GENERAL NOTES

- 1. UNDERLYING SITE CONTOURS AND INFORMATION BASED ON TOPOGRAPHIC & UTILITY DATA AS PROVIDED TO WYSER ENGINEERING. WYSER ENGINEERING SHALL NOT BE HELD RESPONSIBLE FOR ANY ERRORS OR OMISSIONS THAT MAY ARISE AS A RESULT OF ERRONEOUS OR INCOMPLETE INFORMATION PROVIDED BY OTHERS. CONTRACTOR TO CONFIRM ALL ELEVATIONS, GENERAL DRAINAGE AND EARTHWORK REQUIREMENTS PRIOR TO CONSTRUCTION.
- 2. THE BENCHMARK LOCATIONS ARE SHOWN FOR REFERENCE ONLY ON THIS PLAN. THE BENCHMARKS SHALL BE VALIDATED BY REGISTERED LAND SURVEYOR PRIOR TO CONSTRUCTION. CONTRACTOR ASSUMES RISK ASSOCIATED WITH BENCHMARK ELEVATIONS UNTIL CONFIRMED.
- 3. CONTRACTOR TO OBTAIN APPROPRIATE PERMITS FOR STREET OPENINGS & TO WORK WITHIN CITY LANDS. A CONSTRUCTION MEETING IS REQUIRED A MINIMUM OF 48 HOURS PRIOR TO ANY CONSTRUCTION ACTIVITIES.
- 4. WYSER ENGINEERING SHALL BE HELD HARMLESS AND DOES NOT WARRANT ANY DEVIATIONS BY THE OWNER OR CONTRACTOR FROM THE APPROVED CONSTRUCTION PLANS THAT MAY RESULT IN DISCIPLINARY ACTIONS BY REGULATORY AGENCIES.
- 5. IF ANY ERRORS, DISCREPANCIES, OR OMISSIONS WITHIN THE PLAN BECOME APPARENT, IT SHALL BE BROUGHT TO THE ATTENTION OF THE ENGINEER PRIOR TO CONSTRUCTION SO THAT CLARIFICATION OR REDESIGN MAY OCCUR.
- 6. ALL MUNICIPAL UTILITY CONNECTIONS, WORK IN ROW, PUBLIC OUTLOTS AND PUBLIC EASEMENTS SHALL BE IN ACCORDANCE WITH CITY OF MADISON STANDARD SPECIFICATIONS.

SITE INFOMATION BLOCK:

SITE ADDRESS: 434 GAMMON PLACE SITE ACREAGE: 1.45 AC USE OF PROPERTY: COMMERCIAL

BUILDING SQUARE FOOTAGE: 10,750 SF

TOTAL NUMBER OF PARKING STALLS (EXISTING): 41 (43) NUMBER OF STALLS DESIGNATED ACCESSIBLE: 2

EXISTING IMPERVIOUS SURFACE AREA:
ROOFTOP: 10,750 SQ.FT.
PAVED: 26,000 SQ.FT.
PERCENT IMPERVIOUS: 58.1%

PERCENT IMPERVIOUS: 62.8%

PROPOSED SITE:
TOTAL DISTURBANCE LIMITS: 14,000 SQ. FT.
TOTAL IMPERVIOUS SURFACE AREA: 39,750 SQ.FT.
ROOFTOP: 10,750 SQ.FT.
PAVED: 29,000 SQ.FT.



RAEMER

DEVELOPMENT

GAMMON PLACE

SON, WI 53719

34 GAMMON PLACE
ITY OF MADISON, DANE COUNTY
t Title:


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C100

Sheet Number





LEGEND (PROPOSED)

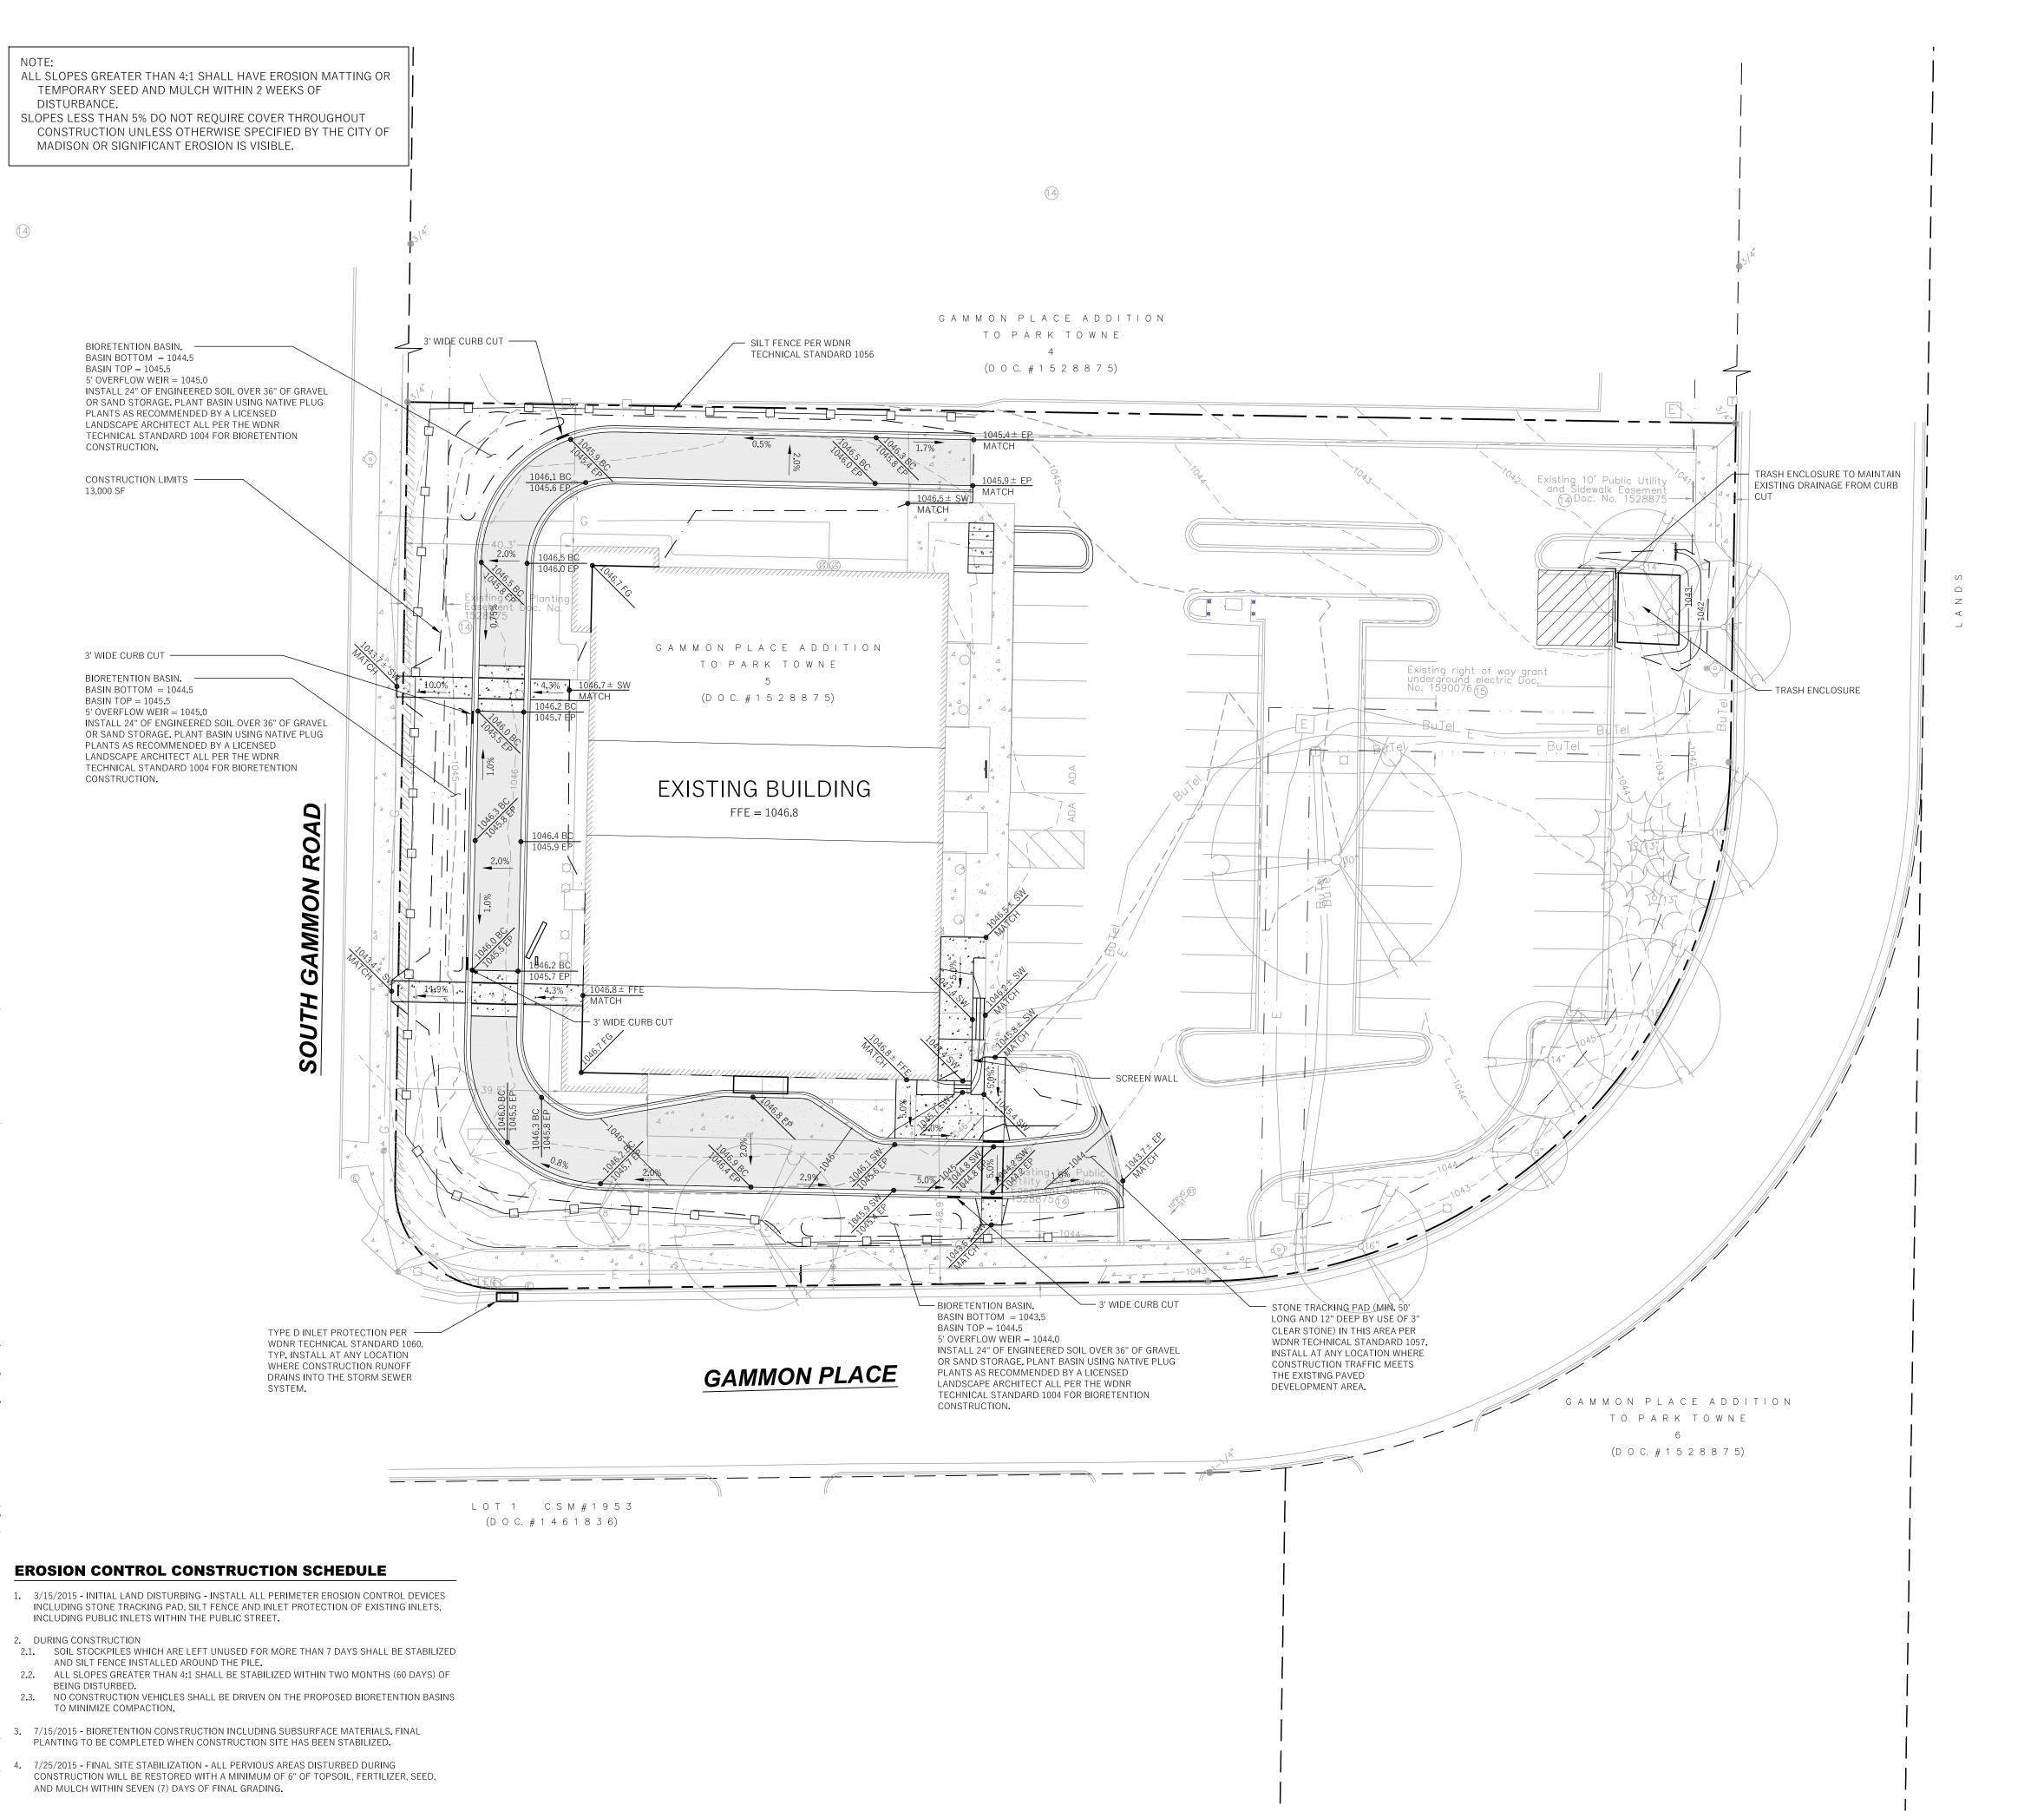	PROPERTY BOUNDARY
<u> </u>	EASEMENT
	BUILDING FOOTPRINT
	18" CURB AND GUTTER
	ASPHALT PAVEMENT
Δ Δ	CONCRETE PAVEMENT
1045	PROPOSED MAJOR CONTOUR
1046	PROPOSED MINOR CONTOUR
	SILT FENCE
	INLET PROTECTION
	DITCH CHECK
1045.25 EP	SPOT GRADE







NNO

GENERAL NOTES

UNDERLYING SITE CONTOURS AND INFORMATION BASED ON TOPOGRAPHIC & UTILITY DATA AS
PROVIDED TO WYSER ENGINEERING. WYSER ENGINEERING SHALL NOT BE HELD RESPONSIBLE
FOR ANY ERRORS OR OMISSIONS THAT MAY ARISE AS A RESULT OF ERRONEOUS OR INCOMPLETE
INFORMATION PROVIDED BY OTHERS. CONTRACTOR TO CONFIRM ALL ELEVATIONS, GENERAL
DRAINAGE AND EARTHWORK REQUIREMENTS PRIOR TO CONSTRUCTION.

DRAINAGE ARROW

- 2. THE BENCHMARK LOCATIONS ARE SHOWN FOR REFERENCE ONLY ON THIS PLAN. THE BENCHMARKS SHALL BE VALIDATED BY REGISTERED LAND SURVEYOR PRIOR TO CONSTRUCTION. CONTRACTOR ASSUMES RISK ASSOCIATED WITH BENCHMARK ELEVATIONS UNTIL CONFIRMED.
- 3. CONTRACTOR TO OBTAIN APPROPRIATE PERMITS FOR STREET OPENINGS & TO WORK WITHIN CITY LANDS. A CONSTRUCTION MEETING IS REQUIRED A MINIMUM OF 48 HOURS PRIOR TO ANY CONSTRUCTION ACTIVITIES.
- 4. WYSER ENGINEERING SHALL BE HELD HARMLESS AND DOES NOT WARRANT ANY DEVIATIONS BY THE OWNER OR CONTRACTOR FROM THE APPROVED CONSTRUCTION PLANS THAT MAY RESULT IN DISCIPLINARY ACTIONS BY REGULATORY AGENCIES.
- 5. IF ANY ERRORS, DISCREPANCIES, OR OMISSIONS WITHIN THE PLAN BECOME APPARENT, IT SHALL BE BROUGHT TO THE ATTENTION OF THE ENGINEER PRIOR TO CONSTRUCTION SO THAT CLARIFICATION OR REDESIGN MAY OCCUR.
- 6. ALL MUNICIPAL UTILITY CONNECTIONS, WORK IN ROW, PUBLIC OUTLOTS AND PUBLIC EASEMENTS SHALL BE IN ACCORDANCE WITH CITY OF MADISON STANDARD SPECIFICATIONS.

CONSTRUCTION SITE EROSION CONTROL REQUIREMENTS

- ALL EROSION AND SEDIMENT CONTROL PRACTICES SHALL BE IMPLEMENTED IN ACCORDANCE WITH THE CURRENT WISCONSIN DEPARTMENT OF NATURAL RESOURCES (WDNR) EROSION AND SEDIMENT CONTROL TECHNICAL STANDARDS (dnr.wi.gov).
- EROSION AND SEDIMENT CONTROL MEASURES SHALL BE INSTALLED PRIOR TO SITE DISTURBANCE.
- 3. ENGINEER / CITY OF MADISON HAS THE RIGHT TO REQUIRE CONTRACTOR TO IMPLEMENT ADDITIONAL EROSION CONTROL MEASURES AS NECESSARY.CONTRACTOR MUST NOTIFY THE CITY OF MADISON A MINIMUM OF TWO (2) WORKING DAYS IN ADVANCE OF ANY SOIL DISTURBANCE ACTIVITIES.
- 4. EROSION AND SEDIMENT CONTROL PRACTICES SHALL BE INSPECTED ONCE PER WEEK AND FOLLOWING EACH RAINFALL EVENT. INSPECTION REPORTING SHALL BE IN ACCORDANCE WITH MUNICIPAL REQUIREMENTS SHALL BE THE RESPONSIBILITY OF THE CONTRACTOR. A PRE -CONSTRUCTION MEETING IS REQUIRED TO GO OVER IMPLEMENTATION OF THIS EROSION CONTROL PLAN.
- 5. IT IS THE CONTRACTOR'S RESPONSIBILITY TO MAINTAIN EROSION AND SEDIMENT CONTROL PRACTICES IN WORKING ORDER. EROSION CONTROL MEASURES SHALL BE REMOVED ONLY AFTER SITE CONSTRUCTION IS COMPLETE WITH ALL SOIL SURFACES HAVING AN ESTABLISHED VEGETATIVE COVER.
- 6. DEWATERING PRACTICES SHALL COMPLY WITH TECHNICAL STANDARD 1061.
- 7. ALL SLOPES EXCEEDING 20% (5:1) SHALL BE STABILIZED WITH A CLASS I, TYPE B EROSION MAT.
- 8. DUST CONTROL SHALL BE MITIGATED IN ACCORDANCE WITH WDNR TECHNICAL STANDARD
- ALL DISTURBED AREAS SHALL BE SEEDED AND MULCHED IMMEDIATELY FOLLOWING FINAL GRADING ACTIVITIES.
- 10. SEED MIX AND RATE SHALL BE, AT A MINIMUM, IN ACCORDANCE WITH WDNR TECHNICAL STANDARD 1059.
- 11. PRIOR TO CONSTRUCTION, CONTRACTOR SHALL PROVIDE VEGETATION PLAN FOR ENGINEER / OWNER APPROVAL. VEGETATION PLAN AND BIORETENTION INSTALLATION SHALL BE IN ACCORDANCE WITH WDNR TECHNICAL STANDARD 1004.
- 12. CONTRACTOR TO PROVIDE SOLID LID OR METAL PLATE ON ALL OPEN MANHOLES DURING CONSTRUCTION TO MINIMIZE SEDIMENT FROM ENTERING THE STORM SEWER SYSTEM.

GRADING. SEEDING & RESTORATION NOTES

- 1. ALL GRADES SHOWN ARE FINAL FINISHED SURFACE GRADES.
- 2. AREAS TO BE SEEDED SHALL HAVE A MINIMUM 6 INCHES TOPSOIL UNLESS OTHERWISE NOTED.
- 3. RESTORATION SHALL OCCUR AS SOON AS PRACTICABLE AFTER THE DISTURBANCE, WITHIN 7 DAYS OF TOPSOILING.
- 4. AREAS NOT RESTORED WITH EROSION MATTING OR OTHER STABILIZATION MEASURES SHALL BE STABILIZED WITH MULCH.
- 5. APPLY ANIONIC POLYMER TO DISTURBED AREAS IF EROSION BECOMES PROBLEMATIC.
- 6. INSTALL EROSION CONTROLS ON THE DOWNSTREAM SIDE OF STOCKPILES AND PROVIDE TEMPORARY SEEDING ON STOCKPILES WHICH ARE TO REMAIN IN PLACE FOR MORE THAN 7
- DAYS.
 CONTRACTOR SHALL CHISEL-PLOW OR DEEP TILL WITH DOUBLE TINES THE STORMWATER

MANAGEMENT FACILITY JUST PRIOR TO SEEDING AND MULCHING TO PROMOTE INFILTRATION.

- 8. CONTRACTOR TO DEEP TILL ALL COMPACTED PERVIOUS SURFACES PRIOR TO SEEDING AND
- MULCHING.

 9. MULCH SHALL BE WEED-FREE STRAW AND SHALL BE INSTALLED AT THE RATE OF 2 TONS PER
- ACRE PER SECTION 627 OF "STANDARD SPECIFICATIONS FOR HIGHWAY AND STRUCTURE CONSTRUCTION" (WISDOT 2014)
- 10. PERMANENT SEEDING SHALL NOT OCCUR BETWEEN SEPTEMBER 15TH AND APRIL 15TH.
 ALTERNATE SEEDING/PLANTING METHODS AND/OR EROSION PROTECTION MAY BE NECESSARY
 FOR SEEDING/PLANTING THAT OCCURS DURING THAT TIME. COORDINATE WITH THE OWNER AS NECESSARY.
- 11. TEMPORARY STABILIZATION SHALL CONSIST OF ONE OR MORE OF THE FOLLOWING OPTIONS:

 a. TEMPORARY SEEDING CONSISTING OF ANNUAL RYE GRASS APPLIED AT A RATE OF 1.5 LBS

 PER 1000 SQUARE FEET,
- b. WISDOT PAL CLASS I TYPE B URBAN EROSION CONTROL MAT.
- 8. ALL SLOPES EXCEEDING 4:1 SHALL BE STABILIZED WITHIN 1-WEEK OF DISTURBANCE WITH TEMPORARY SEEDING AND CLASS I, TYPE B (URBAN) EROSION MATTING AND ALL DRAINAGE SWALES SHALL BE STABILIZED WITH CLASS II, TYPE B MATTING.



Revisions:

No. Date: Description:


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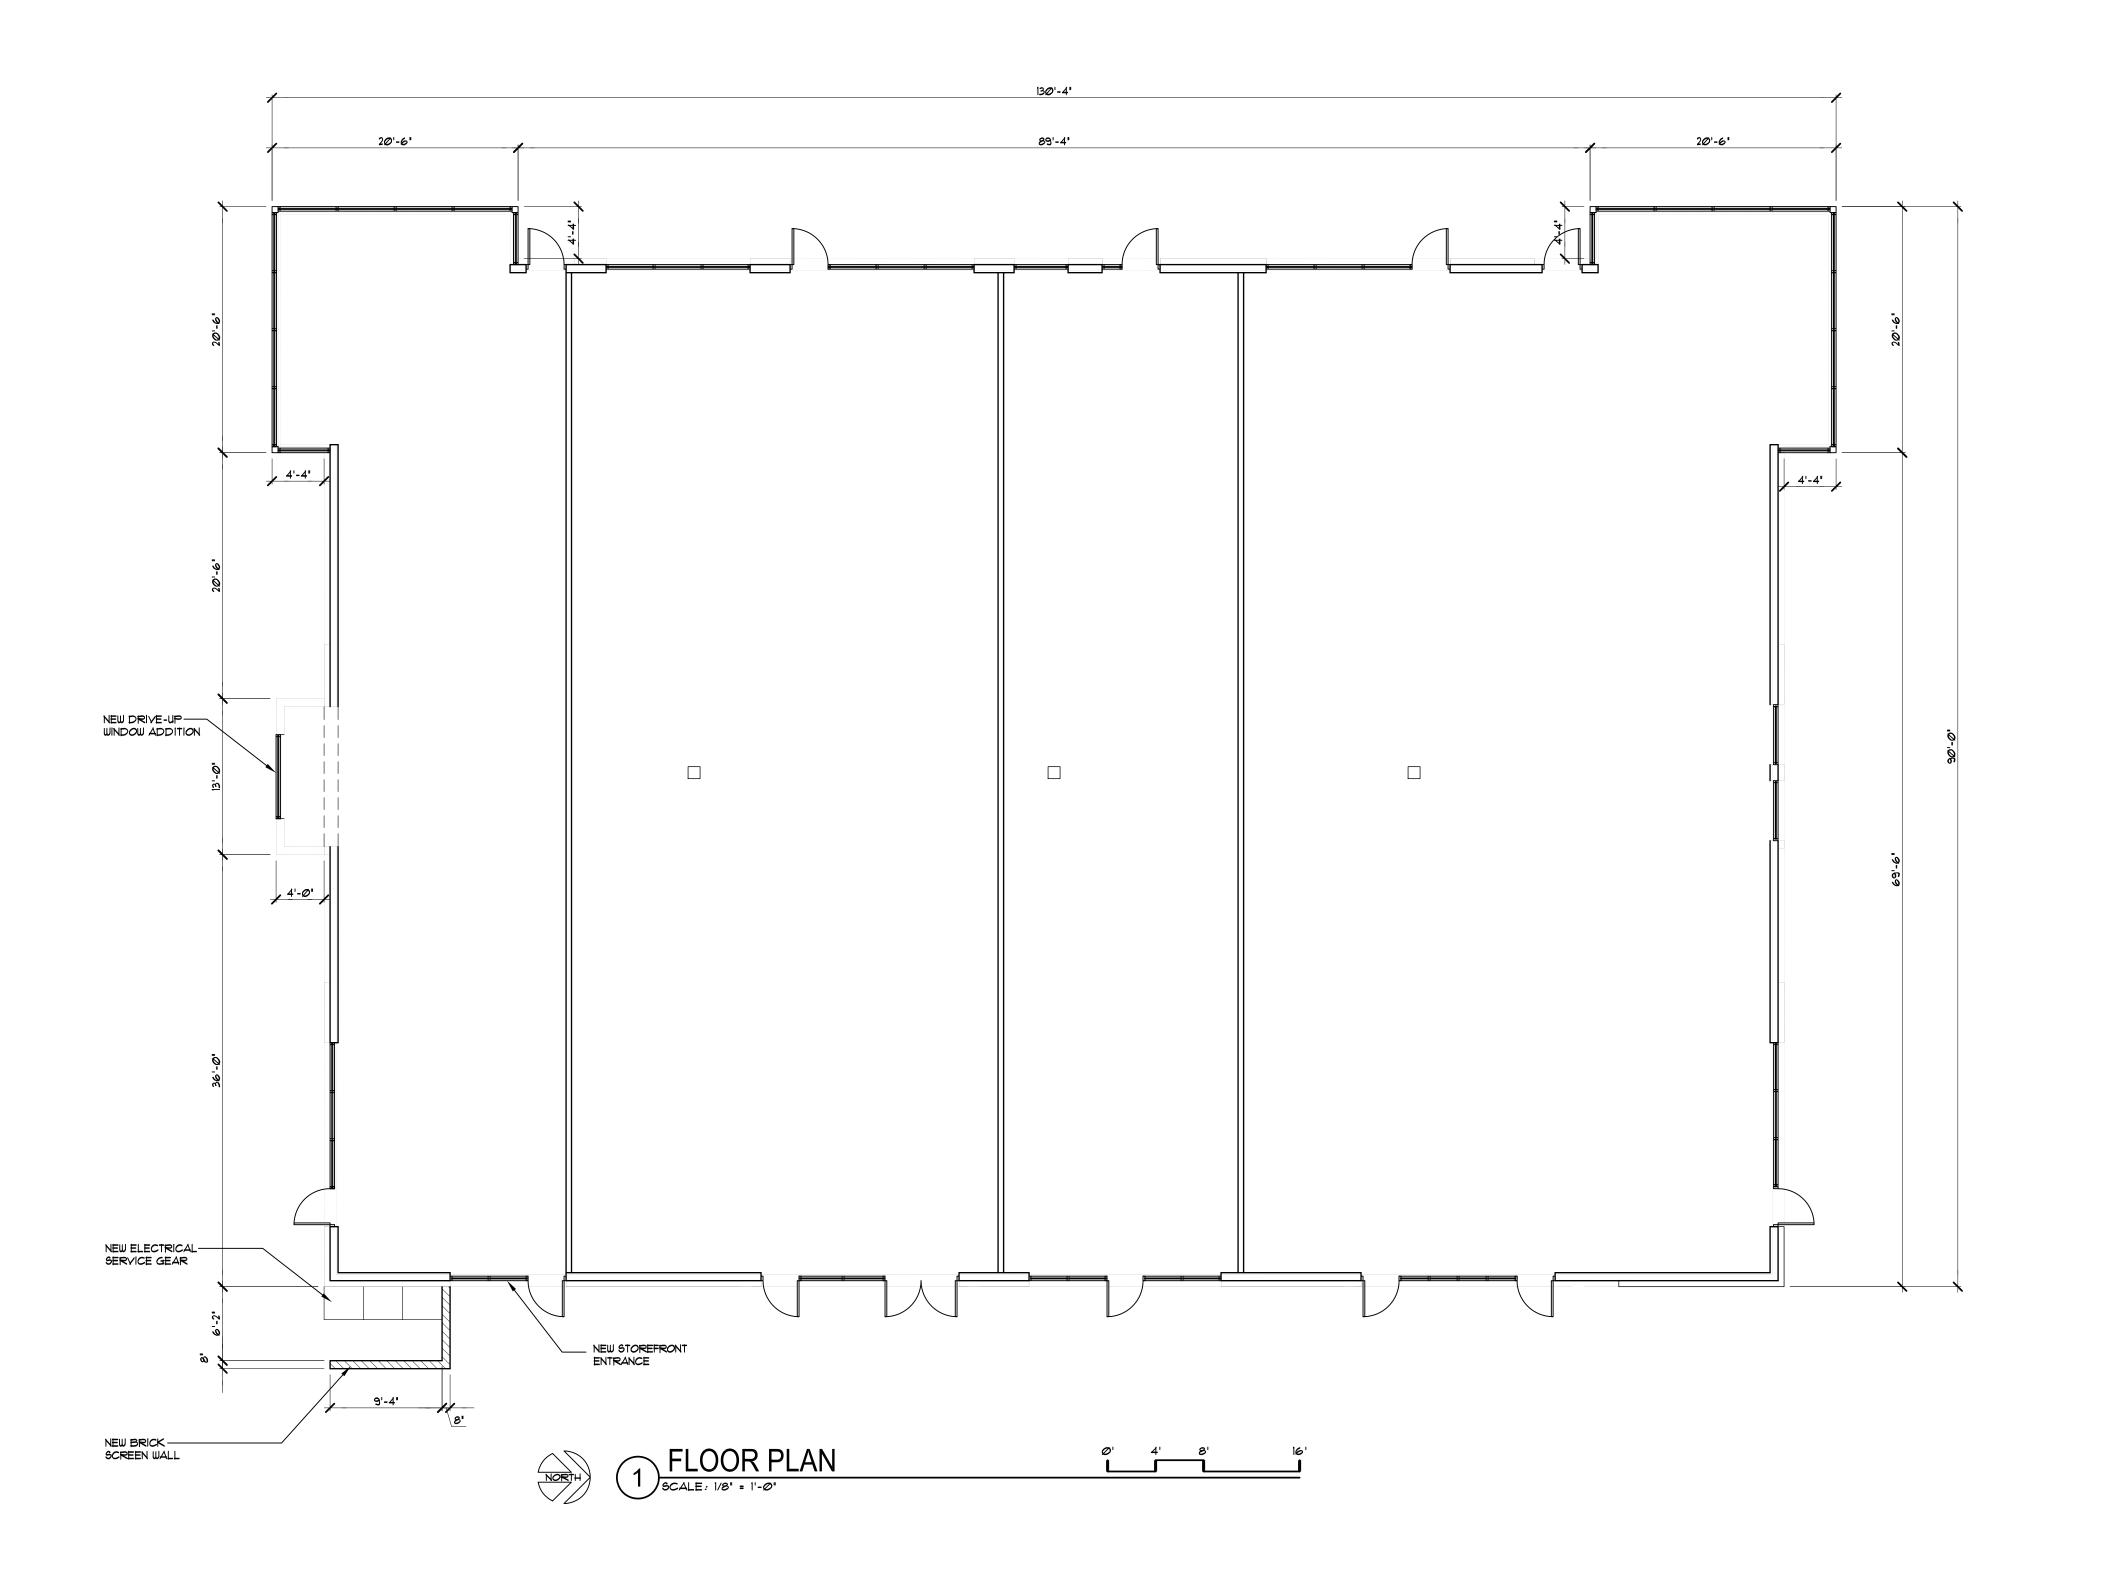
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Date Issued 04/08/2015

Sheet Number C200





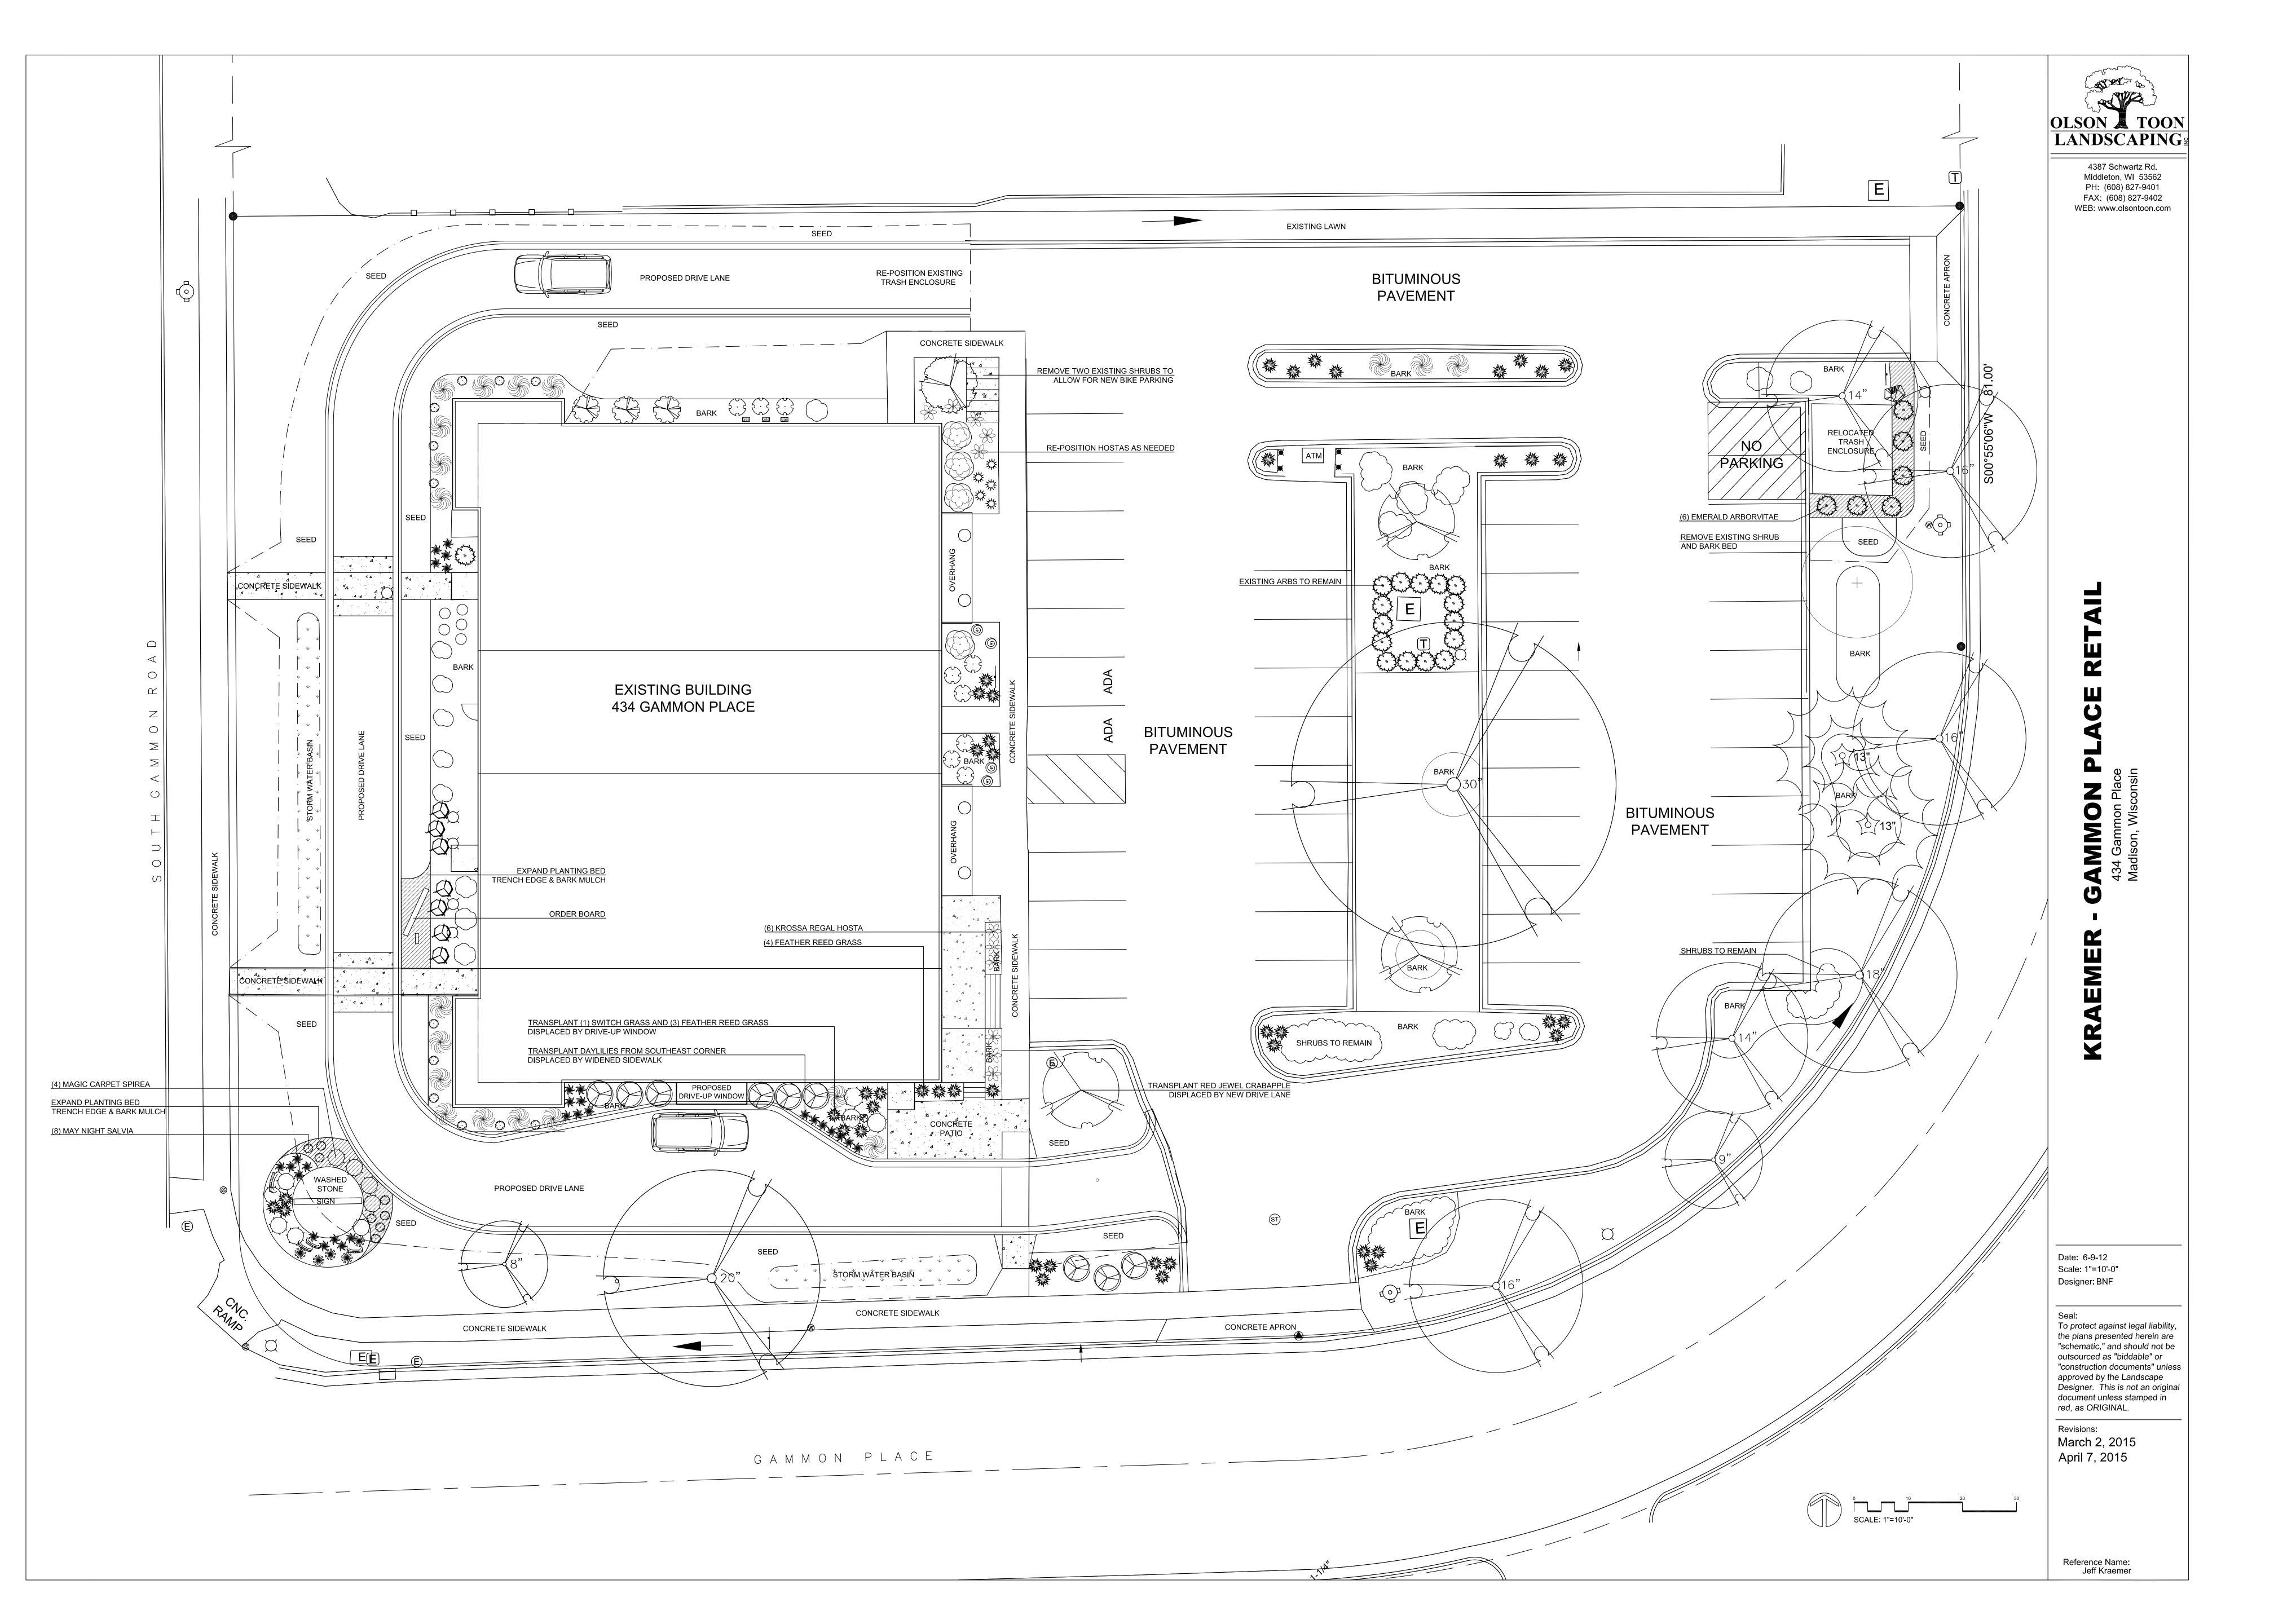

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 DATE:
 Ø4/Ø8/2Ø15

 SCALE:
 AS NOTED

PROJECT:

DRAWN BY:

INVESTORS,

 $134~\mathrm{GAMMON}$ 601 UNIVERSITY AVENUE, SUITE HIDDLETON, WISCONSIN 53562

 $^{\circ}_{MON\ PLACE}^{\circ}$, wisconsin 53719

FLOOR PLAN

A2.02



608-829-3056 (FAX)

434 GAMMON PLACE
434 GAMMON PLACE
MADISON, WISCONSIN 53719

DEVELOPER:
434 GAMMON INVESTORS, LLC
7601 UNIVERSITY AVENUE, SUITE 202
MIDDLETON, WISCONSIN 53562

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PROJECT: DRAWN BY:

DATE: 04/08/2015 SCALE: AS NOTED

PROPOSED ELEVATIONS

A6.01