KWIK TRIP STORE #187

CONDITIONAL USE PERMIT APPLICATION SUBMITTAL

OWNER

KWIK TRIP, INC
JEFF OSGOOD
1626 OAK STREET
LA CROSSE, WI 54602
PHONE: 608-793-5547
EMAIL: josgood@kwiktrip.com

CIVIL ENGINEER

SNYDER & ASSOCIATES SCOTT ANDERSON 5010 VOGES RD MADISON, WI 53718 PHONE: 608-838-0444

EMAIL: sanderson@snyder-associates.com

SURVEYOR

SNYDER & ASSOCIATES 5010 VOGES RD MADISON, WI 53718 PHONE: 608-838-0444

SHEET INDEX

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SWPPP1 EROSION CONTROL PLAN
L1 PRELIMINARY LANDSCAPE PLAN
A120A MAIN FLOOR PLAN - UNIT A
A120B MAIN FLOOR PLAN - UNIT B
A200 BUILDING ELEVATIONS

COLOR 1 COLORED BUILDING ELEVATIONS COLOR 2 COLORED CANOPY ELEVATIONS



KWIK TRIP, Inc.
P.O. BOX 2107
1626 OAK STREET
LA CROSSE, WI 54602-2107
PH. (608) 781-8988
FAX (608) 781-8960

COVER SHEET

CONVENIENCE STORE #187


WITH 2-BAY CARWASH

AMERICAN FAMILY DEVELOPMENT

SEC OF AM FAM PKWY & BUTTONWOOD DR

MADISON, WI

| # | DATE | DESCRIPTION |
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| | | LEGEND | | | | | |
|----------|-----|---|----------|---------------|-----------------|--------|------------------------------|
| 0 |) | 1" IRON PIPE (I.P.) FOR (UNLESS OTHERWISE NO | | | -11 | _ | STORM SEWER LINE |
| - 24 | | | | mar win | | | |
| | | 1-1/4" SOLID IRON RO | | | | | SANITARY SEWER LINE |
| 0 | 2 | 3/4" x 18" SOLID IRON WT. 1,50 lbs./ft. | / RE-ROD | SET, | | | |
| 23 | ě. | CHISELED CROSS SET | | | - Note: - | | BURIED TELEPHONE LINE |
| Δ | | SURVEY MARKER NAIL | SET | | -0 | | BURIED ELECTRIC LINE |
| (|) | INDICATES RECORDED A | ıs | | 0/19 | | BURIED CABLE TV LINE |
| | | DISTANCES ARE MEASU NEAREST HUNDREDTH (| | | -10 | | BURIED FIBER OPTIC LINE |
| — | | DRAINAGE ARROW FROM | I THE AN | IERICAN CENTI | ER PLAT FIRST A | ооттом | |
| 0 | SA | NITARY MANHOLE | Do | STREET LIGH | T | (tv) | CABLE TV BOX |
| 64 | WA | TER VALVE | DE3 | ELECTRIC TR. | ANSFORMER | (fV) | CABLE TV MANHOLE/VAULT |
| Ñ. | FIR | E HYDRANT | (E) | ELECTRIC MH | OR VAULT | 8 | HANDICAP PARKING STALL |
| 0 | ST | ORM SEWER MANHOLE | 10. | TRAFFIC SIGN | ν. | 0 | BENCHMARK |
| Ш | so | UARE INTAKE/INLET | (1) | TELEPHONE . | JUNCTION BOX | 0 | DECIDUOUS TREE (SIZE VARIES, |
| | H- | INLET | (I) | TELEPHONE I | WH OR VAULT | 0 | CONIFEROUS TREE (SIZE VARIES |
| 100 | FL | ARED END SECTION | 50 | GAS VALVE | | | |

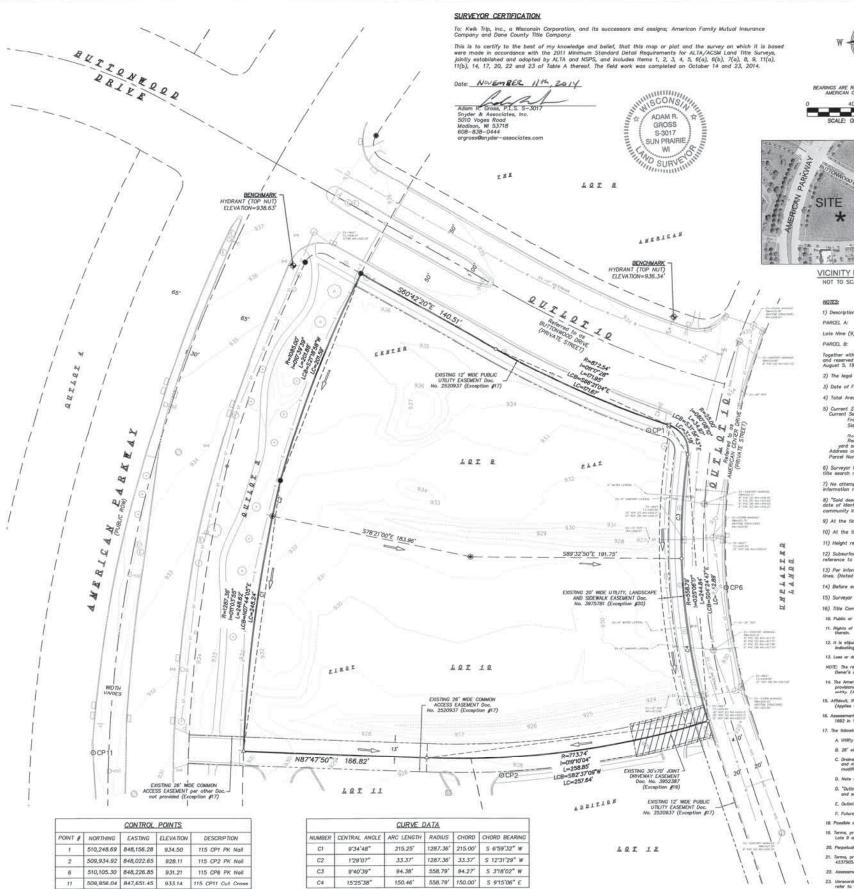1) Description from Title Commitment No. C-14071487 dated September 16, 2014 at 5:59 a.m. from Dane County Title Company.

Lots Nine (9) and Ten (10), The American Center Plat First Addition, in the City of Madison, Dane County, Wisconsin.

Together with a non-exclusive assement for largress and egress over Outlot Ten (10), The American Center Plot First Addition, in the City of Madison, Oane County, Wisconsin, as set forth and reserved on the recorded plot of The American Center Plot First Addition, recorded September 27, 1993 as Document Number 25/20937 and as described in instrument recorded August 5, 1992 in Volume 19869 of Records, Pope 1 as Document Number 27/20937.

- 2) The legal description referenced in the title commitment is the same property depicted on this survey.
- 3) Date of Field Survey: October 14 and 23, 2014.
- 4) Total Area of parcel surveyed = 136,420 Sq. Ft. (3.1318 Acres)
- Current Zoning: CC (Commercial Center District) (Per City of Wadson Assessor's Website) Current Setbacks:
- tl Selbocks:
 Front Yord: refer to Sec. 33.24(4)(7)8, of Madison General Ordinances
 Side Yord: (Where buildings abut residentially-zoned lots at side tot line) Minimum side yord required in the adjacent residential district
 (order coses) One-Story S, Time-Story or Iniplent S.
 Room York: The Tensor of 2014 of let depth or 20 feet
 Report Yord: The Tensor of 2014 of the depth or 20 feet
 Report Yord: The control fols, where all abutting property is in a nonresidential zoning district the required rear yard setback shall be the same as the required side
- yard setbock.
 Address of properties: 4701 American Parkway, 4802 American Center Drive
 Parcel Numbers: 251/0810-221-0102-6, 251/0810-221-0103-4

Surveyor has made no investigation or independent search for easements of record, encumbrances, restrictive covenants, ownership title evidence, or any other facts that the current title execution more displacement.

9) At the time this survey was performed there were no existing buildings on the property. (Noted to fulfill item 7(a) of Table A)

- 10) At the time this survey was performed, no parking areas have been constructed. (Noted to fulfill item 9 of Table A)
- 11) Height regulations are as follows: No Building shall exceed 5 stories or 68' in height unless conditionally approved
- 13) Per information provided the surveyor through a telephone conversation on 10-27-2014 with the City of Madison, no changes plan to be made to the public street right-of-way lines. (Noted to fulfill item 17 of Table A)
- 14) Before excavation, appropriate utility companies should be contacted. For exact location of underground utilities, contact Digger's Holline at 1-800-242-8511
- 15) Surveyor has been provided a copy of Title Commitment No. C-14071487 dated September 16, 2014 at 5:59 a.m. from Dane County Title Company.
- 16) Title Commitment references the following from Schedule B Section Two (Exceptions):
- 10. Public or private rights, If any, in such portion of the subject premises as may be presently used, laid out or dedicated in any manner shatsoever, for street, highway or alley purpose

- 13. Loss or domage, if any, arising from the granting of the easement described in Parcel B in Schedule A by American Family Mutual insurance Company.
- NOTE: The recorded plot of The American Center Plot First Addition, recorded as Document Number 2520957 contains a notation stating: Outlot 10 shall be sensed and mointained by the "American Center Owner's Association, inc." As of the affective data harvor we find no conveyance of record of sold Outlot 10 from American Family Mutual Insurance Company to The American Center Owner's Association, inc."
- 14. The American Center Owner's Association, Inc., as disclased by Non-Stock Articles of Incorporation recorded July 14, 1992 in Volume 19482 of Records, Page 1 as Document Number 2375210 and the terms, provisions and conditions contained thereis: and uneconded By-Lave of said settly and the terms, provisions and conditions contained thereis: and consenses only or charges, if any, levied by said world; Number to the surveyed provise, but plotticed, rater is documental? Affidinit, Resolution and revised Declarations of Protective Covenants and Conditions for The American Center recorded August 5, 1992 in Volume 19686 of Records, Page 1 on Document Number 2379020. (Applies to the surveyed parcels, Not plottoble, refer to document)

- A Utility easement(s) over Lots 9 and 10. (As shown on survey)
- 8. 26" side Common Access Easement over Lot 10. (As shown on survey)
- C. Drainage arrows and note stating: "Arrows indicate the direction of surface drainage seeds at individual property lines. Sold drainage seeds shall be graded with the construction of each principal structure and monitorined by the lot evener, unless modified with the approval of the City Englisheer. Devotions given are for property comers at ground level and shall be mointenaned by the lot owners, unless modified with the approval of the City Englisheer. See Association shall be monitorined by the lot owners, unless modified with the approval of the City Englisheer. See Association shall be monitorined by the lot owners, unless modified with the approval of the City Englisheer. See Association shall be monitorined by the lot owners, unless modified with the approval of the City Englisheer.
- D. Hote stating: "There shall be no vehicular access to American Center Boulevard or to American Parkway, except as by common access essements." (Applies to surveyed parcels
- D. "Outlet 10 is reserved for an egress and ingress exement for what is known as the "Commercial Sension Complex", described in Document number 3279020. Outlet 10 is also reserved for a public exter and sever assement. (Applies to surveyed parcels, Outlet 10 shown on survey.)
- E. Outlot 10 shall be owned and maintained by "American Center Owner's Association, inc."
- F. Future 26' side ingress/egress easement by other instrument.
- IB. Possible oxigation ecsement over lands in The American Center development as disclosed by instrument recorded May 8, 2002 as Document Number 3485666. (Not plottable, refer to document)
- 18. Terms, provisions, conditions, seasments, costs and all other matters as set firth in Joint Driveway and Parking Easment recorded August 9,2004 as Document Number 3952387. (That parties that diffects Lats 9 and 10 are above on survey)
 - 20. Perpetual Easement for Utility, Landscape and Sideralis Purposes and conditions as self forth in instrument recorded October 6,2004 as Document Number 3975781. (As shown an survey)
 - 21. Terms, provisions, conditions, essements, costs and all other motters as set forth in Joint Driveray, Common Access and Cross Parking Essements recorded September 22, 2006 as Doc 4337505. (Applies to the surveyed parcels, Not pictosis, refer to document)
 - 22. Assessments, fees and/or charges, if any, levied by Starkweather Drainage District
 - 22. Linecorded Height Limitation Zoning Map, Dane County Regional—Trans Flats, Modilson, Wileconain, Wileconain, Wileconain Bureau of Aeronautics, adopted October 2,2008. (Applies to the surveyed parcels, Not plottoble, refer to document)

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Inc. 2107 Street WI 546 SURVEYED Kwik Trip, P.O. Box 2 1626 Oak 3 LoCrosse,

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, DANE COUNTY, OF SECTION 2

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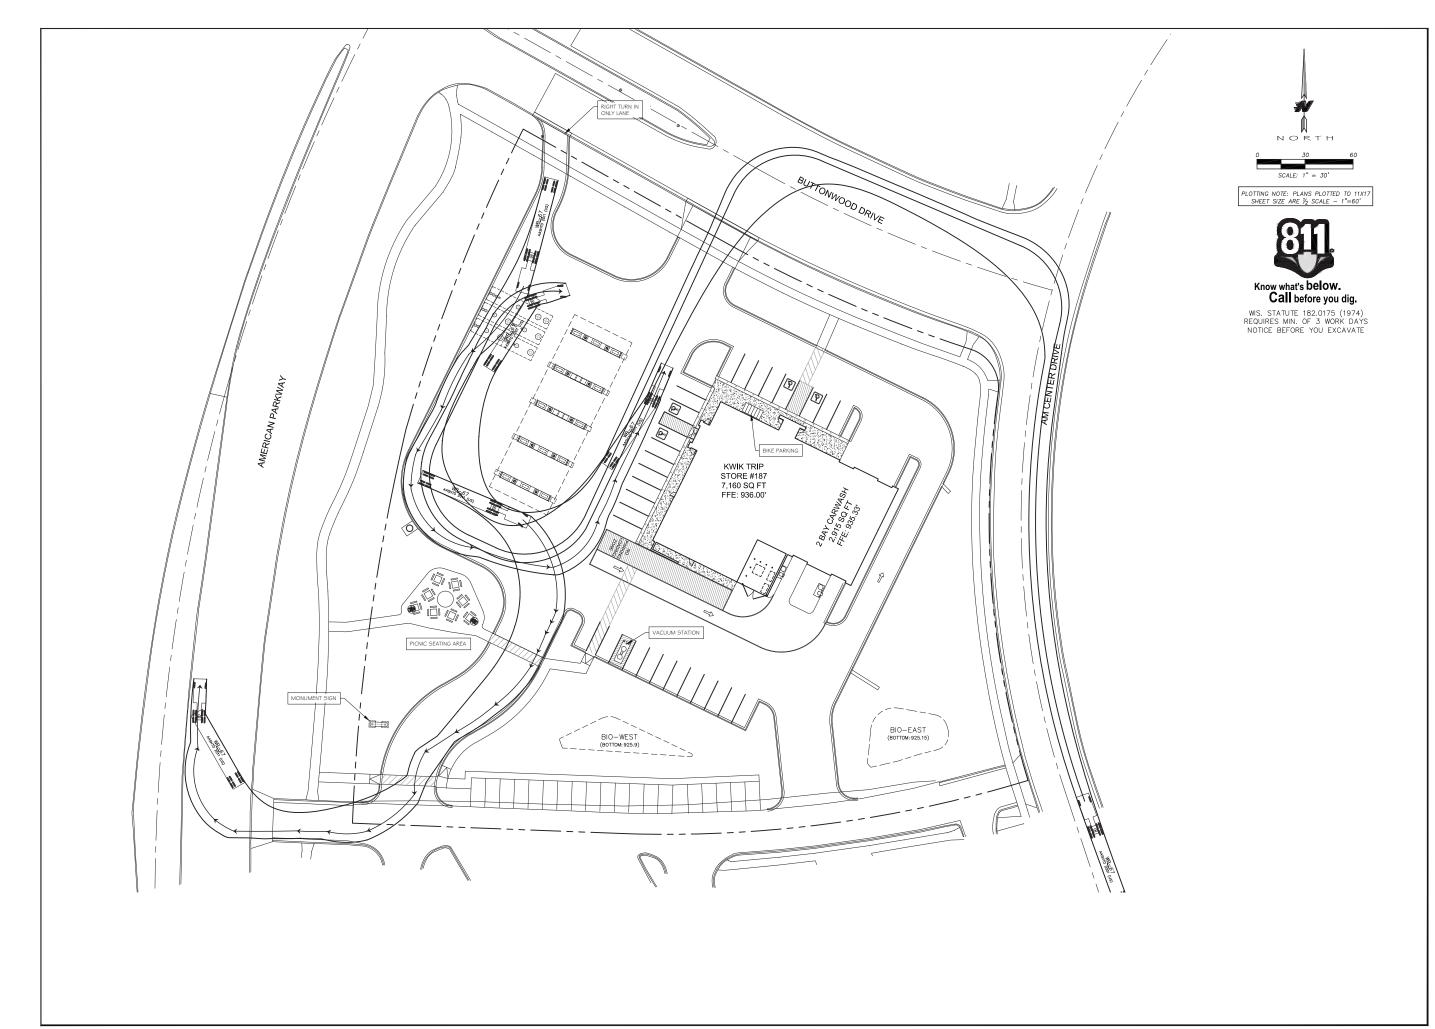
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STORES



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KWIK TRIP, Inc. P.O. BOX 2107 1626 OAK STREET LA CROSSE, WI 54602-2107 PH. (608) 781-8988 FAX (608) 781-8960



SNYDER & ASSOCIATES

5010 VOGES ROAD MADISON, WISCONSIN 53718 608-838-0444 KTS01 www.snyder-associates.com


TURNING MOVEMENTS

PLAN

187 STORE CONVENIENCE

4701 AMERICAN PARKWAY MADISON, WISCONSIN 53718 SITE

M. WAHL DRAWN BY PROJ. NO. KTS02 3-4-15 DATE SHEET SP

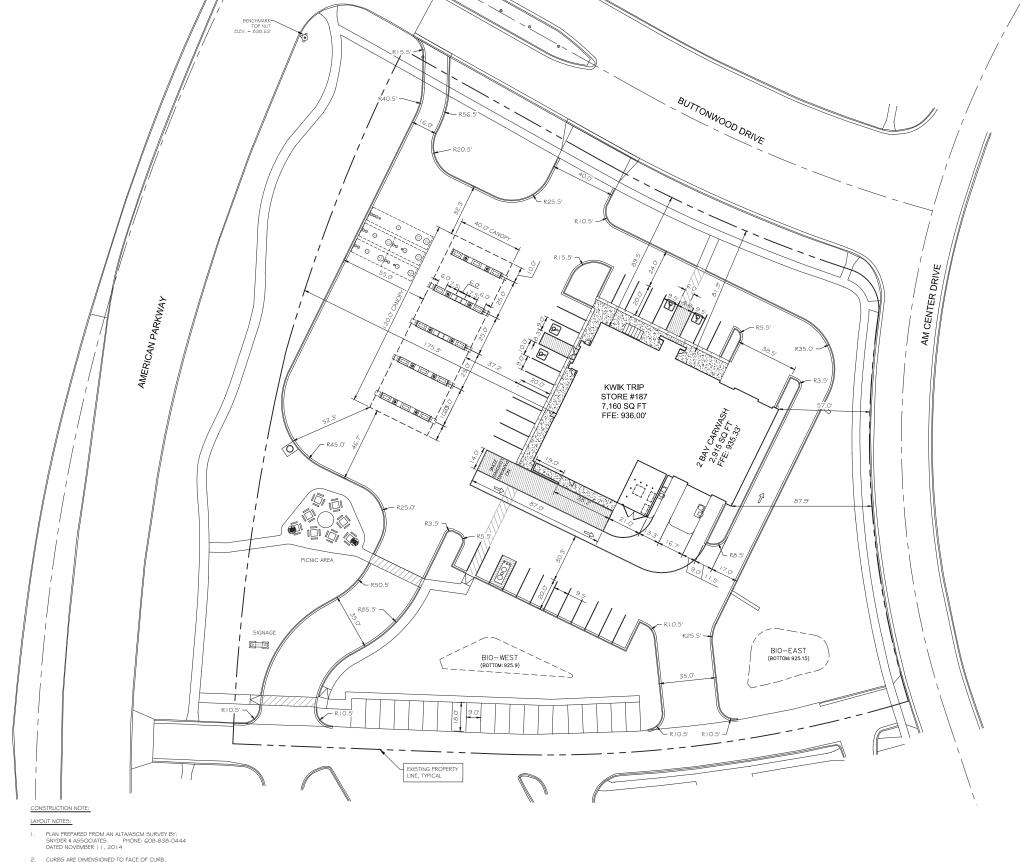

SITE DATA:

ZONING DISTRICT:

TOTAL SITE AREA:

PRO. PERVIOUS:

PARKING REQUIREMENTS

PARKING REQUIRED PARKING PROVIDED

30 EXCLUSIVE STALLS 20 SHARED STALLS

BUILDING HEIGHTS CONVENIENCE STORE
CAR WASH
CANOPY

23.5' ??? 14' ??? 20.0' ???

BUILDING SETBACKS R/W REAR SIDE YARD PARKING FUELING PUMPS

PROPOSED GREEN AREA PROPOSED HARD COVER PAVED AREA: BUILDING AREA: CANOPY AREA:

GAS/ ELECTRIC-

COMMUNICATIONS

SANITARY, WATER



PLOTTING NOTE: PLANS PLOTTED TO 11X17 SHEET SIZE ARE ½ SCALE - 1"=60'



Know what's below.
Call before you dig.

WIS. STATUTE 182.0175 (1974) REQUIRES MIN. OF 3 WORK DAYS NOTICE BEFORE YOU EXCAVATE



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187 STORE 11 AMERICAN PARKWAY ISON, WISCONSIN 53718 NVENIENCE

LAYOUT

PLAN

| SITE | CONV | 4701 A MADISON, |
|------------|-------------|--------------------|
| NO. DATE | DESCRIPTION | |
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| DD AWAL DV | | NA MIALI |

DRAW SCALE PROJ. NO. KTS02 DATE 3/4/15 SP1 SHEET

UNLESS SHOWN OTHERWISE ON THIS DRAWING, CONTRACTOR SHALL PROVIDE CONTROL JOINTS, CONSTRUCTION JOINTS, AND EXPANSION JOINTS IN SLAB ON GRADE, SIDEWALKS AND DRIVES.


CONTROL JOINT MAXIMUM DISTANCE: WALKS- 8' O.C., ALL OTHERS-10' O.C. SAW CUT CONTROL JOINTS MINIMUM ONE-QUARTER CONCRETE THICKNESS.

EXPANSION JOINT MAXIMUM DISTANCE: WALKS- 24' O.C., ALL OTHERS- 40' O.C. DOWEL ALL EXPANSION JOINTS- MAXIMUM 24" O.C.

3. CONCRETE IN ISLAND COMPLEX SHALL BE SMOOTH FINISHED.

4. EXTERIOR CONCRETE SURFACES TO BE SEALED. CONCRETE SEALER: APR 15- OCT 31 USE: TK-26UV NOV 1- DEC 31 USE: TK-290

5. EXPANSION JOINTS SHALL BE DECK-O-FOAMED AND CAULKED WITH SLI

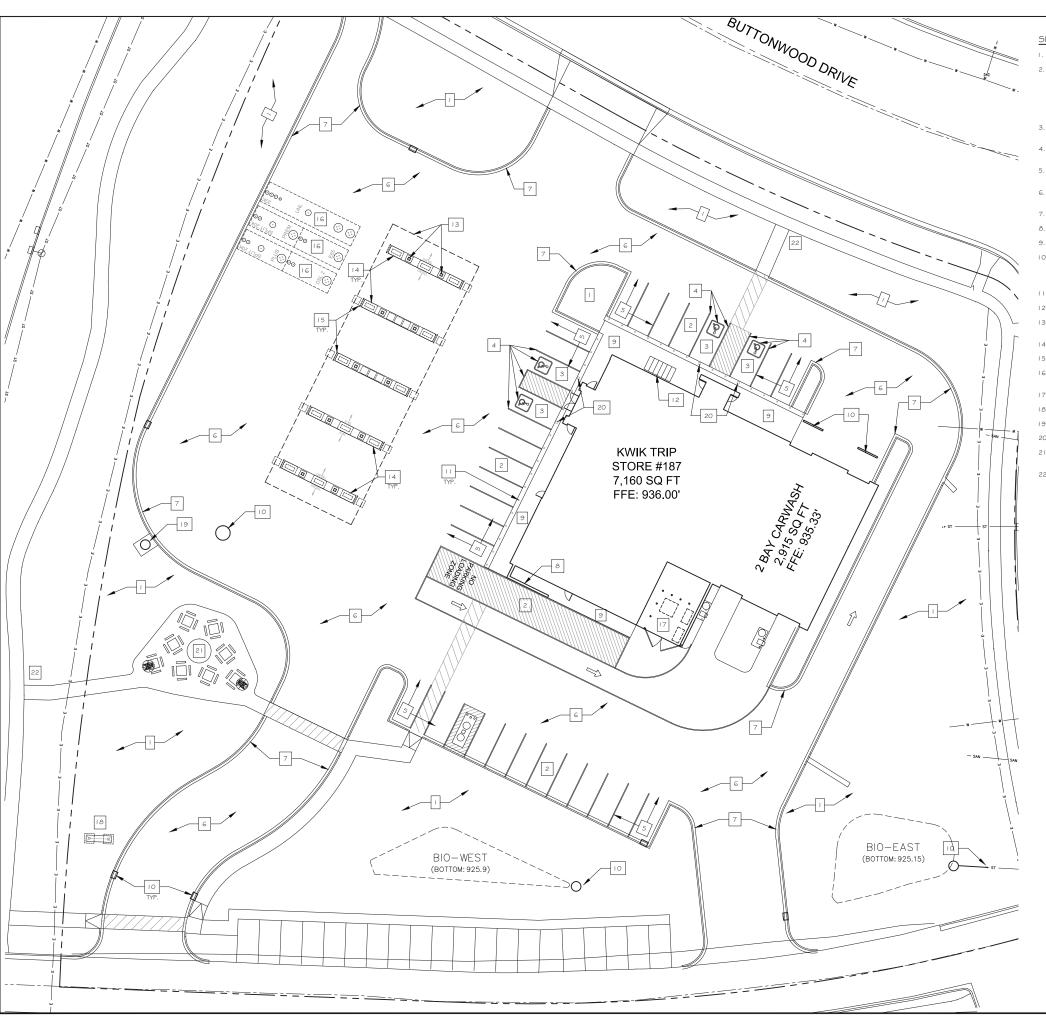

SITE PLAN KEYNOTES

- LANDSCAPE AREA. SEE SHEET LI
- OFF-STREET PARKING STALLS
 STRIPING 4" WIDE STALL LINES, USE HIGH VISIBILITY WHITE PAINT.
 SPACES PROVIDED
 (25) 9-0">
 20'-0" (MIN.) GENERAL PARKING
 (4) 9-0">
 20'-0" ACCESSBILE PARKING WITH
 (1) 14'-0"x 87'-0" LOADING ZONE
- A.D.A. ACCESSIBLE PARKING SPACE WITH LOADING ZONE. PROVIDE APPROPRIATE STRIPING AND PAVEMENT MARKINGS.
- 4. 4" WIDE, HIGH VISIBILITY, PAVEMENT STRIPING, LANE MARKINGS AND TEXT. COLOR: HC MARKINGS- BLUE,
- G" DEPTH (MIN.) CONCRETE SLAB-ON-GRADE WITH #3 REBAR. CONCRETE SEALER: TK-2GUV
- 8" DEPTH (MIN.) CONCRETE SLAB-ON-GRADE WITH #3 REBAR. CONCRETE SEALER: TK-26UV
- 7. CONCRETE CURB AND GUTTER PER DETAILS.
- 8. CONCRETE CURB WALL PER DETAILS.
- 9. 6" INTEGRAL CONCRETE CURB/ WALK, SEE DETAILS, CONCRETE SEALER; TK-2GUV
- I O. STORM STRUCTURE. SEE SHEETS SP2-SP4 FOR FURTHER STORM SEWER INFORMATION.
 A. CATCH BASIN CURB INLET PER DETAILS
 B. OIL SKIMMER PER DETAIL ON SHEET SP3 C. TRENCH DRAIN PER DETAIL
- 11. 30" HT., 6" DIA. CONCRETE FILLED PIPE BOLLARD PER DETAILS.
- 12. 6 STALL BIKE RACK WITH 5' CLEARANCE ALL AROUND.
- 13. 40-0'x 120'-0' DISPENSER ISLAND CANOPY. VERIFY SIZE, PLACEMENT, COLUMN AND FOOTING SIZE WITH CANOPY AND STRUCTURAL PLANS. CANOPY GRAPHICS PER OWNER.
- 14. 3'-6"x 6'-0" CONCRETE ISLANDS W/ 6" EXPOSURE WITH FUEL DISPENSERS. DISPENSER PER OWNER.
- 15. U-PIPE BOLLARD. 36" HT ABOVE GRADE. SLEEVE WITH DR-18, 4" BLUE PLASTIC WATERMAIN PIPE.
- 16. UNDERGROUND FUEL STORAGE TANKS PER OWNER. PROVIDE PIPING AND VENTING PER OWNER'S SPECIFICATIONS.
- 17. EXTERNAL TRASH ENCLOSURE TO MATCH BUILDING. SEE ARCHITECTURAL DETAILS.
- 18. KWIK TRIP TRADEMARK SIGN (VERIFY LOCATION WITH SIGN PERMIT)
- 19. 'FREE AIR' COMPRESSOR. PROVIDE SIGNAGE PER OWNER.
- 20. HC PVC BOLLARD SLEEVE PER OWNER. VAN ACCESS SIGNAGE AT 48" HT. STALL PARKING AT 60" HT.
- 21. PICNIC TABLE PER OWNER. PROVIDE 2 HC. ACCESS TABLE SPACE. PROVIDE TRASH CONTAINER PER OWNER.
- 22. EXISTING CONCRETE WALK TO REMAIN. REPAIR/ REPLACE AS NEEDED PER CITY.





Know what's below. Call before you dig.

WIS. STATUTE 182.0175 (1974) REQUIRES MIN. OF 3 WORK DAYS NOTICE BEFORE YOU EXCAVATE



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SNYDER & ASSOCIATES 5010 VOGES ROAD MADISON, WISCONSIN 53718

608-838-0444 KTS01 www.snyder-associates.com

> 187 STORE MERICAN P ONVENIENCE

PLAN KEYNOTE

4701 AMI MADISON, V SITE Ö

DRAWN BY M. WAHL PROJ. NO. KTS02 3-4-15 DATE SP1.1 SHEET



NOTE GRADING CONTRACTOR:

ANY PROPERTY IRONS THAT ARE DISTURBED IN THE GRADING PROCESS SHALL BE RESET BY A LICENSED LAND SURVEYOR AT NO ADDITIONAL COST TO THE OWNER.

- REFER TO OTHER PROJECT PLANS AND INFORMATION RELATED TO THIS PROJECT PRIOR TO BEGINNING ANY GRADING WORK.

- PLAN PREPARED FROM AN ALTAVASCM SURVEY BY:

SNYDER \$ ASSOCIATES PHONE: 608-838-0444 DATED NOVEMBER | | , 20 | 4

CONSTRUCTION NOTES:

-CONSTRUCTION FENCING TO BE INSTALLED AROUND ENTIRE CONSTRUCTION SITE.
COORDINATE WITH OWNER FOR FENCING AND GATE LOCATIONS AND APPROPRIATE SIGNAGE INSTALLATION.

-CONTRACTOR SHALL OBTAIN AN EXCAVATION IN THE RIGHT-OF-WAY PERMIT FROM THE CITY ENGINEER PRIOR TO PERFORMING ANY WORK WITHIN THE RIGHT-OF-WAY.

- CONTRACTOR SHALL LOCATE ALL UTILITIES WHICH MAY AFFECT THIS WORK AND NOTIFY OWNER OF ANY CONFLICTS.

- CONTRACTOR SHALL VERIFY ALL EXISTING AND PROPOSED ELEVATIONS PRIOR TO START OF CONSTRUCTION. VERIFY CRITICAL ELEVATIONS TO ENSURE CONFORMANCE WITH GRADING FLAN, PRATICULARLY WITH WALK AND/ OR PAVEMENTS TO REMAIN. MEET EXISTING GRADES ALONG STREETS, PROPRETY LINES AND DRIVEWAY FUNFANCES. RESTORE ALL EXISTING PAVEMENTS THAT REMAIN TO THEIR ORIGINAL, IF NOT BETTER CONDITION. NOTIFY OWNER OF ANY CONFLICTS.

- AREAS NOT PAVED AND TO BE LANDSCAPED SHALL RECEIVE MINIMUM OF 4" DEPTH COMPACTED TOPSOIL.

- CONTRACTOR SHALL COORDINATE GRADING AND INSTALLATION OF DRIVES IN R.O.W. WITH APPROPRIATE GOVERNMENT AGENCIES. OBTAIN APPROPRIATE PERMITS FOR GRADING AND DRAINAGE IN ALL R.O.W.

- REFER TO OWNER'S SPECIFICATIONS FOR CURB, APPROACH, BITUMINOUS, AND CONCRETE PROFILES, AS WELL AS ADDITIONAL SITE STANDARDS RELATED TO THIS PROJECT.

ELEVATION NOTES:

PROPOSED FINISHED FLOOR ELEV. STORE = 936.00 FEET & CAR WASH = 935.33 FEET

BENCHMARK (AS SURVEYED)
TOP NUT ON HYDRANT @ SE CORNER OF AMERICAN PARKWAY AND BUTTONWOOD AVENUE ELEVATION = 838.63 FEET



PLOTTING NOTE: PLANS PLOTTED TO 11X17 SHEET SIZE ARE 1/2 SCALE - 1"=60"



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SNYDER & ASSOCIATES 5010 VOGES ROAD


MADISON, WISCONSIN 53718 608-838-0444 KTS01 www.snyder-associates.com

187 STORE 01 AMERICAN PARKWAY DISON, WISCONSIN 53718 ONVENIENCE

PLAN

| GRADING | CONVENIEN | 4701 AMERIC, MADISON, WISCON |
|---------|-------------|------------------------------|
| O. DATE | DESCRIPTION | |
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M. WAHL DRAWN BY PROJ. NO. KTS02 DATE 3-4-15 SP2 SHEET

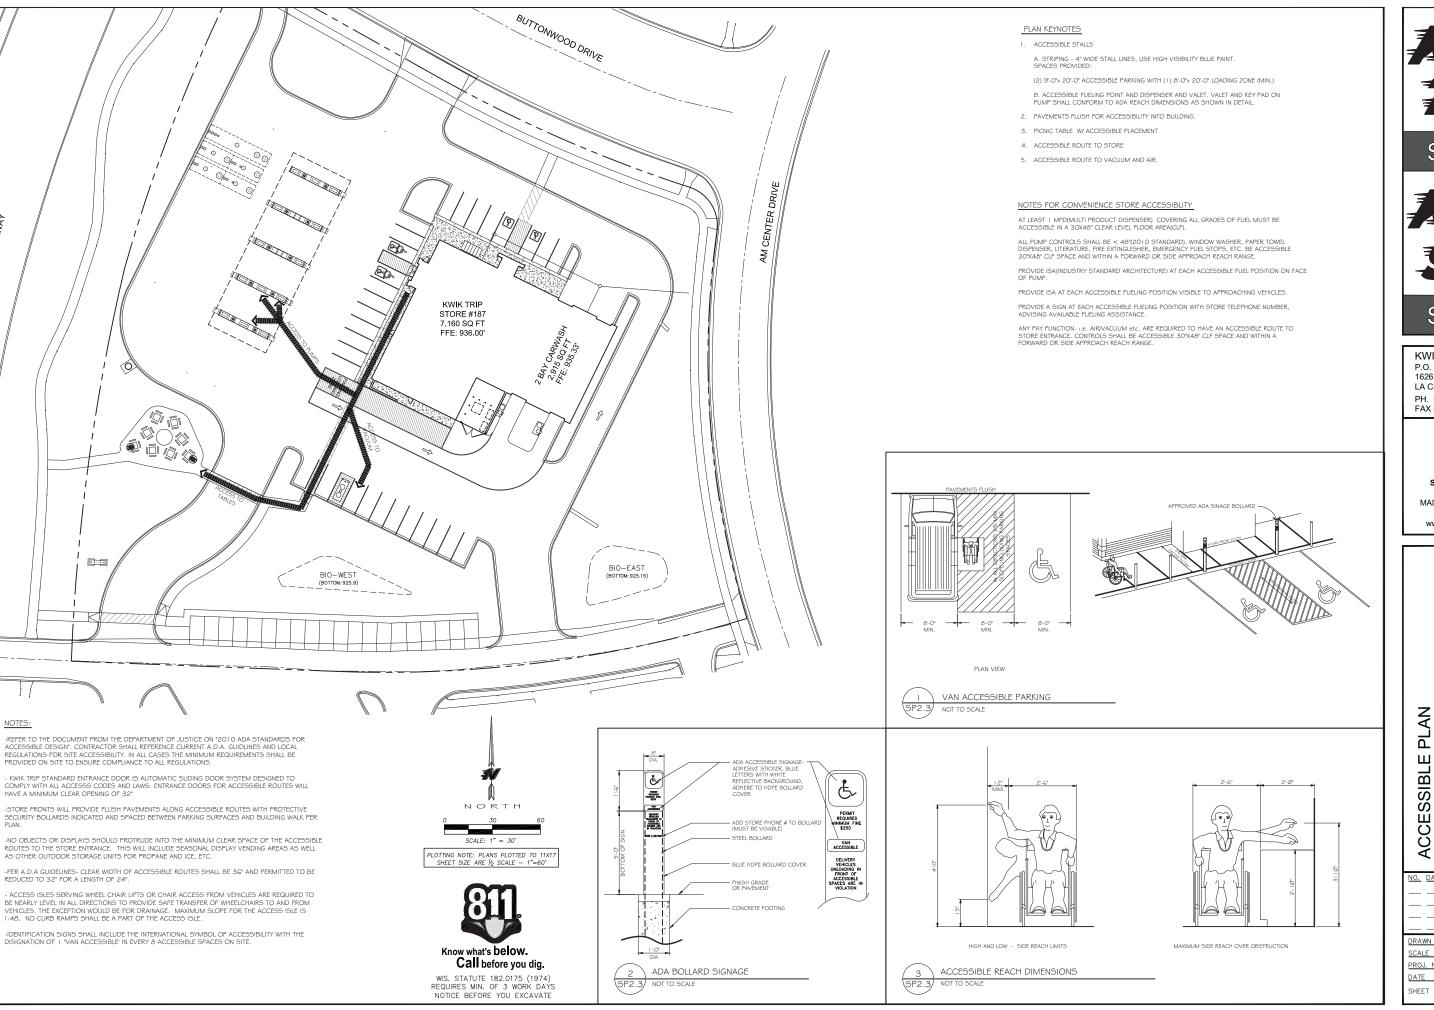

XW/X TRIP

STORES



STORES

KWIK TRIP, Inc. P.O. BOX 2107 1626 OAK STREET LA CROSSE, WI 54602-2107 PH. (608) 781-8988 FAX (608) 781-8960



SNYDER & ASSOCIATES 5010 VOGES ROAD MADISON, WISCONSIN 53718 608-838-0444 KTS01

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RE 187

ONVENIENCE STORE 1

O1 AMERICAN PARKWAY
DISON, WSCONSIN 53718

| NO. DATE DESCRIPTION | 1 | ၁ | 4 X |
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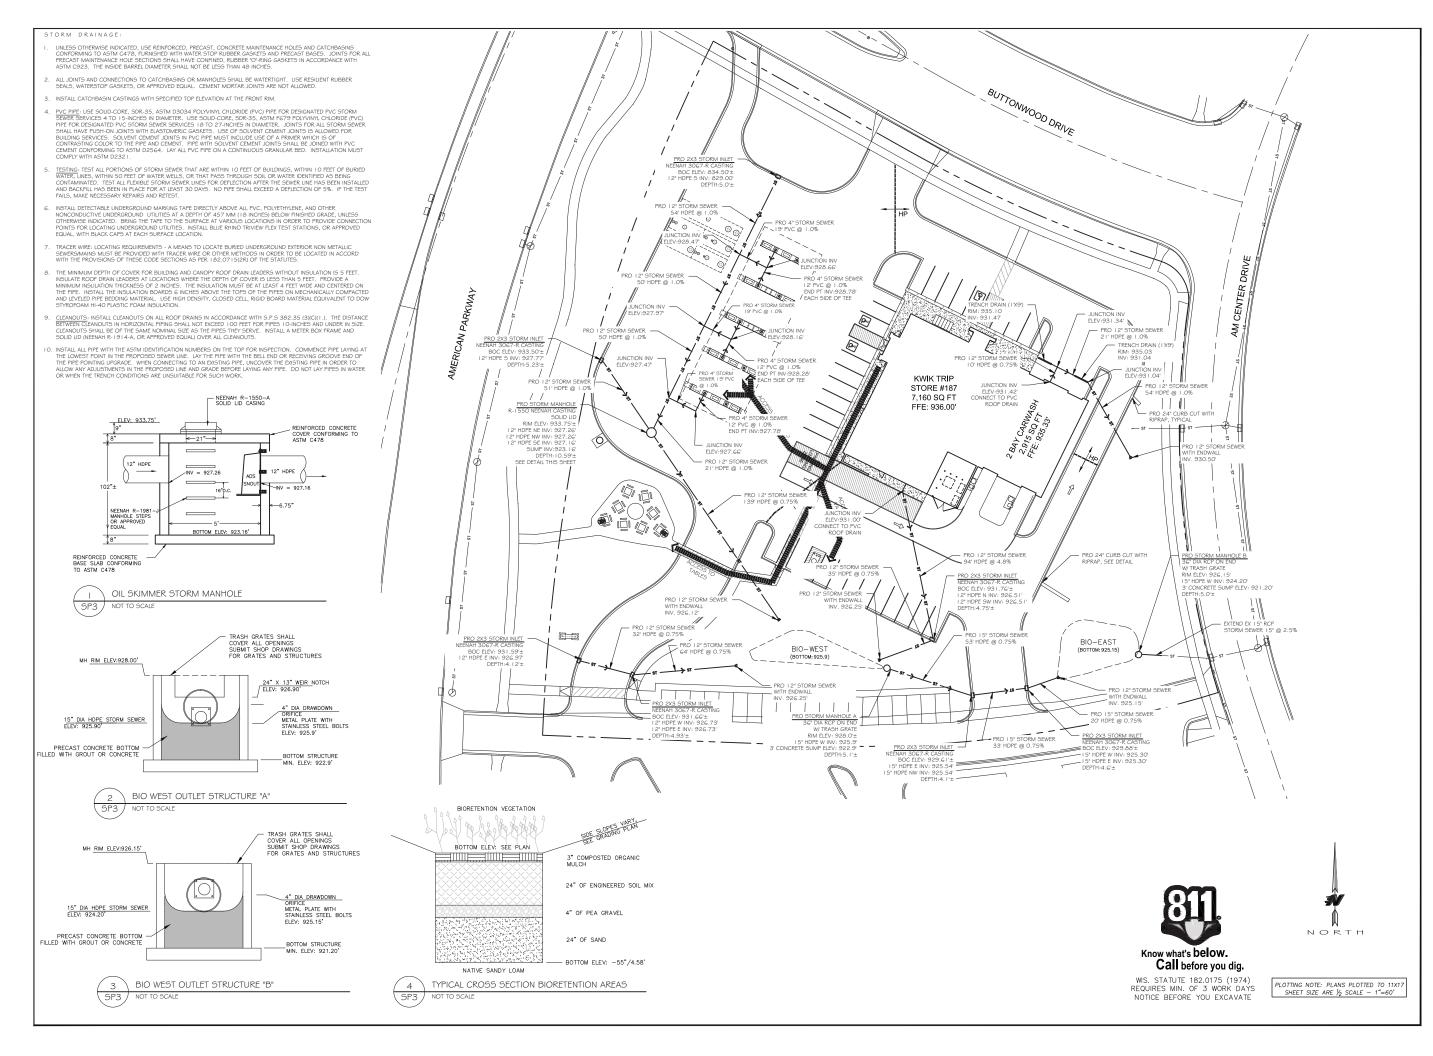
 DRAWN BY
 M. WAHL

 SCALE
 1" = 30"

 PROJ. NO.
 KTS02

 DATE
 3-4-15

 SHEET
 SP2.3





STORES



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STORM SEWER PLAN

ONVENIENCE STORE 187

O1 AMERICAN PARKWAY
DISON, WISCONSIN 53718

| STORM | CONVEN | 4701 AMEF MADISON, WIS |
|---------|-------------|---------------------------|
| O. DATE | DESCRIPTION | |
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| RAWN BY | | M. WAHL |
| CALE | | 1" = 30 |


 DRAWN BY
 M. WAHL

 SCALE
 1" = 30'

 PROJ. NO.
 KTS02

 DATE
 3-4-15

 SHEET
 SP3

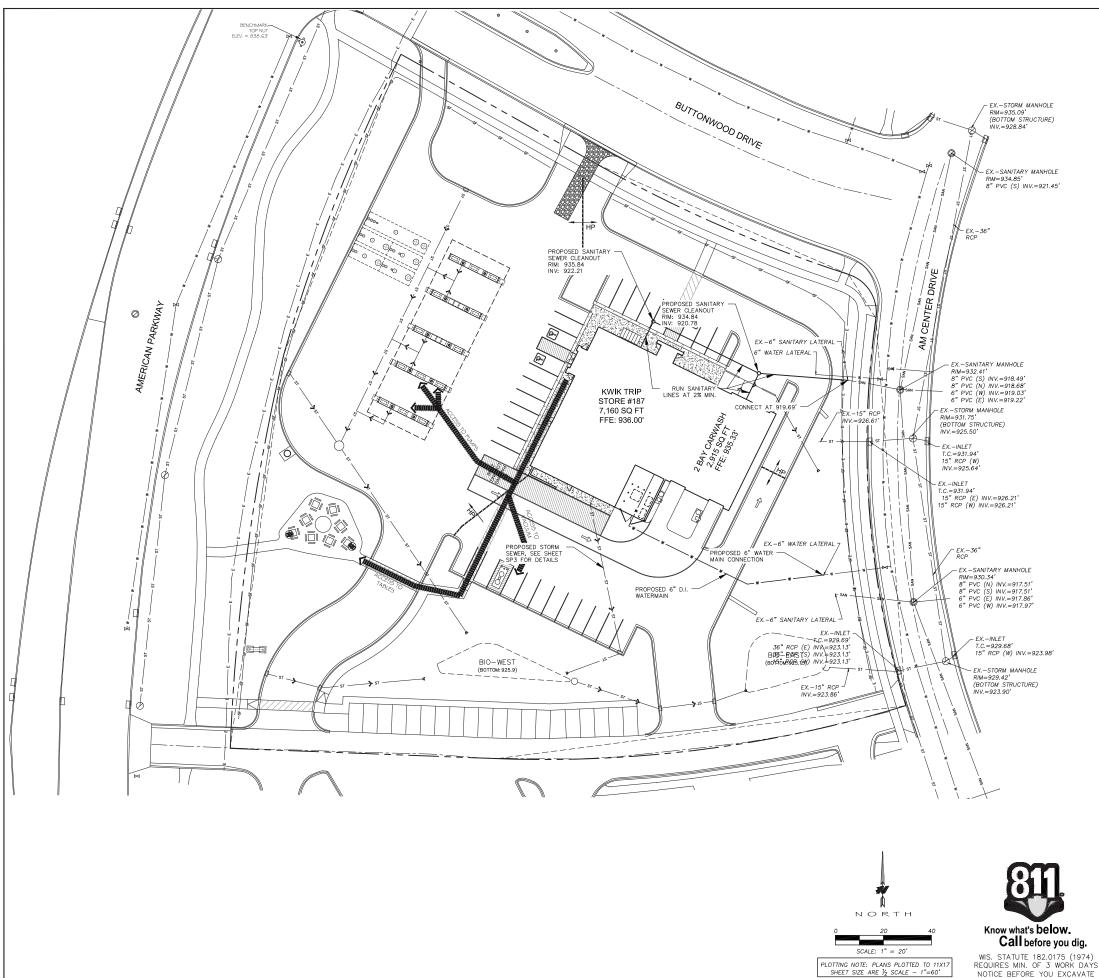

- WATER DISTRIBUTION SYSTEM
- BRING ALL SITE UTILITIES TO 5' OUTSIDE OF THE BUILDING LINE WITH THE EXCEPTION OF THE WATER SERVICE. EXTRED WATER SERVICE INTO THE BUILDING AND UP TO THE FLANGE FOR THE WATER METER.
- SEPARATION OF WATER AND SEWER: PROVIDE A MINIMUM HORIZONTAL SEPARATION OF 10 FEET BETWEEN ALL WATER AND SEWER LINES. PROVIDE A MINIMUM SEPARATION OF 18 INCHES AT ALL WATER LINE AND SEWER LINE CROSSINGS.
- 3. WATERMAIN DEPTH: MAINTAIN 7.5 FEET OF COVER OVER THE TOP OF THE WATER LINES TO THE FINISHED GRADE. VERIFY ELEVATION OF PROPOSED AND EXISTING WATER LINES AT ALL UTILITY CROSSIONS. INSTALL THE WATER LINES AT GREATER DEPTHS IN ORDER TO CLEAR STORM SEWERS, SANITARY SEWERS, OR OTHER UTILITIES AS REQUIRED. INCLUDE COSTS TO LOWER WATER LINES IN THE BASE
- 4. TESTING: PRESSURE TEST AND PERFORM BACTERIOLOGICAL TESTS ON ALL WATER LINES UNDER THE SUPERVISION OF THE CITY OF MADISON. NOTIFY THE CITY AT LEAST 24 WORKING HOURS PRIOR TO ANY TESTING. PRESSURIZE THE WATERLINE TO 1034—KPA (150—PSI) GAUGE PRESSURE (MEASURED AT THE POINT OF LOWEST ELEVATION) BY MEANS OF A PUMP CONNECTED TO THE PIPE IN A SATISFACTORY MANNER. MAINTAIN THE TEST PRESSURE FOR A MINIMUM OF 2 HOURS. DO NOT ADD WATER TO THE WATERMAIN IN ORDER TO MAINTAIN THE REQUIRED PRESSURE DURING THE WATER MAIN PRESSURE FOR A THE TEST SECTION OF PIPE IS ACCEPTABLE WITH A PRESSURE DROP OF 14 KPA (2 PSI) OR LESS.
- 5. USE MECHANICAL JOINT RESTRAINT DEVICES FOR JOINT RESTRAINT ON ALL USE MECHANICAL JOINT RESTRAINT DEVICES FOR JOINT RESTRAINT ON ALL WATERMAIN BERNDS HAVING A VERTICAL OR HORIZONTAL DEFLECTION OF 22-1/2 DEGREES OR GREATER, ALL VALVES, STUBS, EXTENSIONS, TEES, CROSSES, PLUGS, ALL HYDRAINT VALVES, AND ALL HYDRAINTS IN ACCORDANCE WITH CITY REQUIREMENTS. USE "SERIES 1100 MEGALUG" MANUFACTURED BY EBAA IRON INC., EASTLAND, TEXAS, OR APPROVED EQUAL, INSTALLED IN ACCORDANCE WITH MANUFACTURER'S RECOMMENDATIONS FOR RESTRAINT ON DUCTILE IRON PIPE.
- 6. AT ALL VALVE LOCATIONS WHICH REQUIRE A 12" OR SMALLER VALVE, INSTALL GATE VALVES WHICH ARE OF THE COMPRESSION RESILIENT SEATED (CRS) TYPE. USE AMERICAN FLOW CONTROL'S SERIES 2500 DUCTILE IRON RESILIENT WEDGE CATE VALVE SHALL CONFORM TO AWWA C509. INSTALL CAST IRON VALVE BOXES CONFORMING TO ASTM A48 AT EACH VALVE LOCATION. VALVE BOXES SHALL BE THE THREE-PIECE TYPE WITH 5-1/4" SHAFTS. USE TYLER 6860-G WITH NO. 6 BASE, OR EQUIVALENT. VALVE BOXES SHALL HAVE AT LEAST 6" OF ADJUSTMENT ABOVE AND BELOW FINISHED GRADE. DROP COVERS ON VALVE BOXES SHALL BE ROUND AND BEAR THE WORD "WATER" CAST ON THE TOP. USE TYLER 6860-G "STAYPUT" COVERS WITH EXTENDED SKIRT, OR EQUIVALENT.
- USE MUELLER H 10300 OR FORD EM 2 7057, OR APPROVED EQUAL, AT ALL CURB STOP LOCATIONS. STATIONARY ROD IS REQUIRED ON ALL CURB STOPS.
- POLYVINYL CHLORIDE (PVC) BUILDING WATER SERVICES: ASTM D2241 OR ASTM D1785: PRESSURE RATED FOR WATER.
- 9. POLYVINYL CHLORIDE (PVC) WATERMAIN: USE AWWA C900 FOR ALL PVC WATERMAIN FURNISHED WITH INTEGRAL ELASTOMERIC BELL AND SPIGOT JOINTS; MINIMUM PRESSURE CLASS 150; DIMENSION RATIO NOT GREATER THAN 18; LYMPG LENGTH 20 FEET. USE EBAA IRON, INC., SERIES 2000 PV MEGALUG, OR APPROVED EQUAL FOR RESTRAINT ON C900 PVC WATERMAIN. LAY TRACE WIRE WITH ALL C900 PVC WATERMAIN.
- 10. <u>TRACER WIRE</u>: LOCATING REQUIREMENTS A MEANS TO LOCATE BURIED UNDERGROUND EXTERIOR NON METALLIC SEWERS/MAINS MUST BE PROVIDED WITH TRACER WIRE OR OTHER METHODS IN ORDER TO BE LOCATED IN ACCORD WITH THE PROVISIONS OF THE WISCONSIN STATUTES 182.0175(2R) AND THE WISCONSIN DEPARTMENT OF COMMERCE COMM 82.30(11)(H).
- 11. WHERE EXISTING GAS, ELECTRIC, CABLE, OR TELEPHONE UTILITIES CONFLICT WITH THE WORK, COORDINATE THE ABANDONMENT, RELOCATION, OFFSET, OR SUPPOR OF THE EXISTING UTILITIES WITH THE APPROPRIATE LOCAL UTILITY COMPANIES. COORDINATE NEW GAS METER AND GAS LINE INSTALLATION, ELECTRIC METER AND ELECTRIC SERVICE INSTALLATION, CABLE SERVICE, AND TELEPHONE SERVICE INSTALLATION WITH THE LOCAL UTILITY COMPANIES.
- 12. COORDINATE BUILDING UTILITY CONNECTION LOCATIONS AT 5 FT. OUT FROM THE PROPOSED BUILDING WITH THE WITH THE INTERIOR PLUMBING CONTRACTOR PRIOR TO CONSTRUCTION. VERIFY WATER AND SEWER SERVICE LOCATIONS AND ELEVATIONS WITH THE MECHANICAL ENGINEER PRIOR TO CONSTRUCTION.
- 13. THE LOCATIONS OF EXISTING UTILITIES SHOWN ON THIS PLAN ARE FROM RECORD INFORMATION. THE ENGINEER DOES NOT GUARANTEE THAT ALL EXISTING UTILITIES ARE SHOWN OR, IF SHOWN, EXIST IN THE LOCATIONS INDICATED ON THE PLAN. IT IS THE CONTRACTOR'S RESPONSIBILITY TO ASCERTAIN THE FINAL VERTICAL AND HORIZONTAL LOCATION OF ALL EXISTING UTILITIES (INCLUDING WATER AND SEWER LINES AND APPURTENANCES). NOTIFY THE ENGINEER OF ANY DISCREPANCIES

SANITARY SEWER:

NOTICE BEFORE YOU EXCAVATE

- 1. PIPE: USE SOLID-CORE, SDR-35, ASTM D3034 (OR APPROVED EQUAL) POLYVINYL CHLORIDE (PVC) PLASTIC PIPE FOR ALL DESIGNATED PVC SANITARY SEWER SERVICES. JOINTS FOR ALL SANITARY SEWER SHALL HAVE PUSH-ON JOINTS WITH ELASTOMERIC GASKETS. USE OF SOLVENT CEMENT JOINTS IS ALLOWED FOR BUILDING SERVICES. SOLVENT CEMENT JOINTS IN PC PIPE MUST INCLUDE USE OF A PRIMER WHICH IS OF CONTRASTING COLOR TO THE PIPE AND CEMENT. PIPE WITH SOLVENT CEMENT JOINTS SHALL BE JOINED WITH PVC CEMENT CONFORMING TO ASTM D2564. LAY ALL PVC PIPE ON A CONTINUOUS GRANULAR BED. INSTALLATION MUST COMPLY WITH ASTM D2321.
- 2. CLEANOUTS: INSTALL CLEANOUTS ON ALL SANITARY SEWER SERVICES. THE DISTANCE BETWEEN CLEANOUTS IN HORIZONTAL PIPING SHALL NOT EXCEED 100 FEET FOR PIPES 4—INCH AND OVER IN SIZE. CLEANOUTS SHALL BE OF THE SAME NOMINAL SIZE AS THE PIPES THEY SERVE. INCLUDE FROST SLEEVES AND CONCRETE FRAME AND PIPE SUPPORT. INSTALL A METER BOX FRAME AND SOLID LID (NEENAH R-1914-A, OR APPROVED EQUAL) OVER ALL CLEANOUTS.
- 3. TESTING: PRESSURE TEST ALL SANITARY SEWER LINES. TEST ALL FLEXIBLE SANITARY SEWER LINES FOR DEFLECTION AFTER THE SEWER LINE HAS BEEN INSTALLED AND BACKFILL HAS BEEN IN PLACE FOR AT LEAST 30 DAYS. NO PIPE SHALL EXCEED A DEFLECTION OF 5%. IF THE TEST FAILS, MAKE NECESSARY REPAIRS AND RETEST.
- 4. UNLESS OTHERWISE INDICATED, USE REINFORCED, PRECAST, CONCRETE MAINTENANCE HOLES CONFORMING TO ASTM C478, FURNISHED WITH PRECAST BASES. SANITARY SEWER MAINTENANCE HOLES SHALL BE SUPPLIED WITH PRE-FORMED INVERTS AND FLEXIBLE NEOPRENE SLEEVE CONNECTIONS FOR ALL LATERAL LINES 375 MM (15 INCHES) IN DIAMETER OR LESS, UNLESS OTHERWISE INDICATED. JOINTS FOR ALL PRECAST MAINTENANCE HOLE SECTIONS SHALL HAVE CONFINED, RUBBER "O"-RING GASKETS IN ACCORDANCE WITH ASTM C923. THE INSIDE BARREL DIAMETER SHALL NOT BE LESS THAN 48 INCHES.
- INSTALL FLEXIBLE WATERTIGHT FRAME/CHIMNEY SEALS ON ALL SANITARY SEWER MAINTENANCE HOLES. USE EITHER MANUFACTURED MAINTENANCE HOLE FRAME/CHIMNEY SEALS OR ELASTOMERIC WATERPROOFING FRAME/CHIMNEY SEALS.
- USE NEENAH FOUNDRY CO. R-1642 CASTING WITH SELF-SEALING, SOLID, TYPE B LID, OR APPROVED EQUAL, ON ALL SANITARY SEWER MAINTENANCE HOLES. COVERS SHALL BEAR TIE! "SANITARY SEWER" LABEL.
- 7. THE MINIMUM DEPTH OF COVER FOR SANITARY SEWER WITHOUT INSULATION IS 5
 FEET. INSULATE SANITARY SEWER SERVICES AT LOCATIONS WHERE THE DEPTH OF
 COVER IS LESS THAN 5 FEET. PROVIDE A MINIMUM INSULATION THICKNESS OF 2
 INCHES. THE INSULATION MUST BE AT LEAST 4 FEET WIDE AND CENTERED ON THE
 PIPE. INSTALL THE INSULATION BOARDS 6 INCHES ABOVE THE TOPS OF THE PIPES
 ON MECHANICALLY COMPACTED AND LEVELED PIPE BEDDING MATERIAL. USE HIGH
 DENSITY, CLOSED CELL, RIGID BOARD MATERIAL EQUIVALENT TO DOW STYROFOAM
 HI-40 PLASTIC FOAM INSULATION.
- 8. TRACER WIRE: LOCATING REQUIREMENTS A MEANS TO LOCATE BURIED UNDERGROUND EXTERIOR NON METALLIC SEWERS/MAINS MUST BE PROVIDED WITH TRACER WIRE OR OTHER METHODS IN ORDER TO BE LOCATED IN ACCORD WITH TH PROVISIONS OF THE WISCONSIN STATUTES 182.0175(ZR) AND THE WISCONSIN DEPARTMENT OF COMMERCE COMM 82.30(11)(H).



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KWIK TRIP, Inc. P.O. BOX 2107 1626 OAK STREET LA CROSSE, WI 54602-2107 PH. (608) 781-8988 FAX (608) 781-8960



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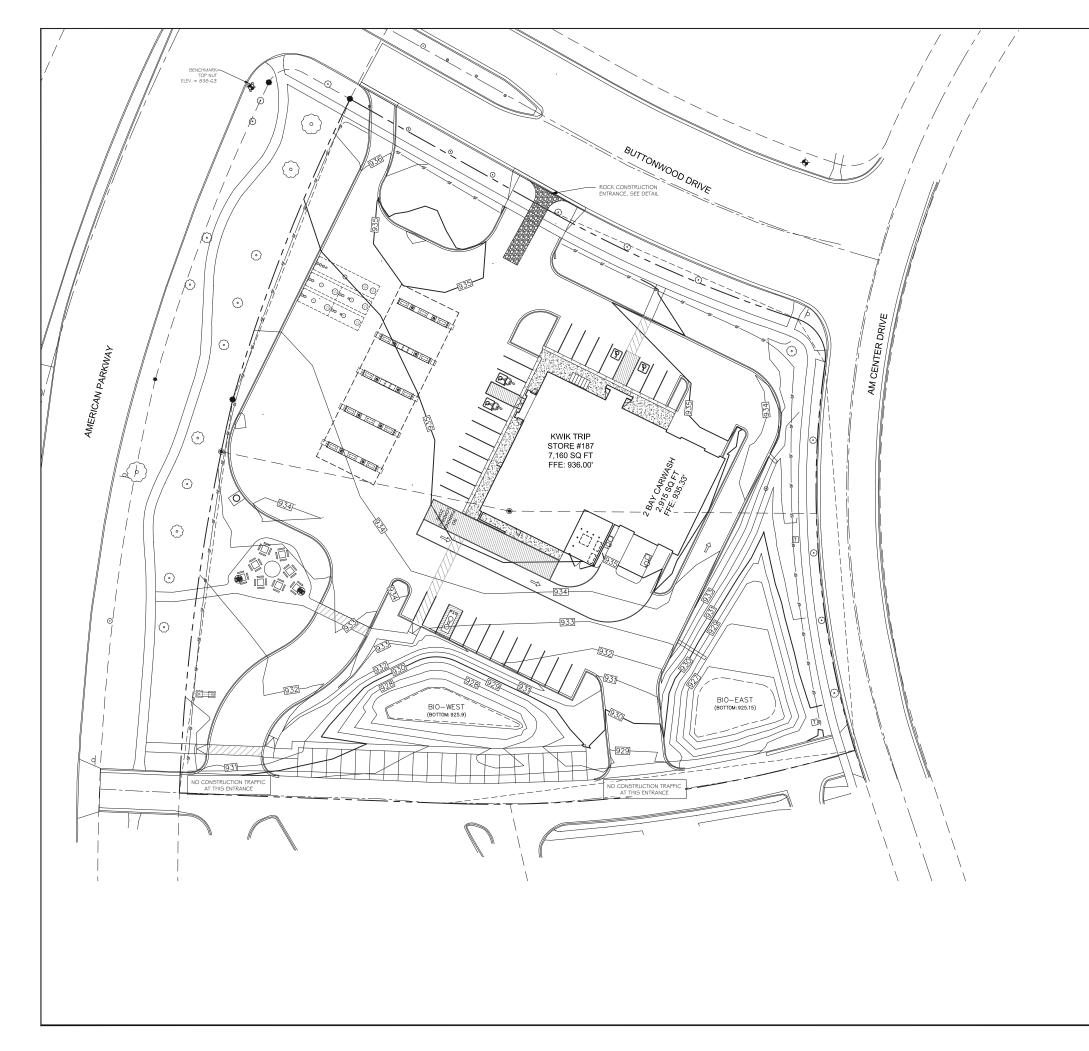
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PLAN

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| DRAWN BY | | М. | WAHL |

PROJ. NO. KTS02 DATE 3-4-15 SHEET

SP4



-ALL SILT FENCE MUST BE INSTALLED BY THE CONTRACTOR AND INSPECTED BY THE CITY PRIOR TO ANY SITE WORK.

-SITE EROSION CONTROL MEASURES MUST BE IN PLACE AT ALL TIMES. SHOULD DEVICES BE REMOVED FOR WORK ACCESS, THEY SHALL BE REINSTALLED AT THE END OF EACH WORK DAY UNTIL PAVEMENTS HAVE BEEN INSTALLED AND ALL LANDSCAPE AREAS HAVE BEEN MULCHED AND SODDED. SEEDED AREAS MUST EXHIBIT MINIMUM OF 70% SOIL COVERAGE.

-REFER TO THE SWPPP PLAN NOTES AND DETAIL SHEETS SWPPP2-4 FOR MORE INFORMATION.

CONTACT BRAD FRY KWIK TRIP, INC PO BOX 2107 LACROSSE, WI 54602 G08-783-8020

CONSTRUCTION SEQUENCE

*INSTALL EROSION/SEDIMENT CONTROL MEASURES

*INSTALL STORMWATER MANAGEMENT SEDIMENT BASINS

*INSTALL STORM SEWER

*INSTALL PAVEMENTS

*FLUSH STORM SEWER

*REMOVE EROSION CONTROL MEASURES ONLY AFTER ALL PAVEMENTS HAVE BEEN INSTALLED AND ALL SOILS HAVE BEEN STABILIZED

PROJECT DATA

SITE AREA DATA
DISTURBED AREA
PRE-CONSTRUCTION IMPERVIOUS AREA
POST-CONSTRUCTION IMPERVIOUS AREA
APPROX. AREA OF LAND DISTURBANCE

SOIL DATA SURFACE SOIL

CONCRETE W/ GRAVEL BASE OVER FILL

| ESTIMATED PRELIMINARY EROSION CONTROL QUANTITIES (ACTUAL QUANTITIES SUBJECT TO CHANGE) | | | |
|--|------------|--|--|
| ITEM | QUANTITY | | |
| ROCK CONSTRUCTION ENTRANCE | ??? 5Q.YD. | | |
| EROSION CONTROL BLANKET(BASIN) | AS NEEDED | | |
| RIP RAP | 222 | | |
| SILT FENCE | ??? L.F. | | |

NOTE: FOR MAINTENANCE PURPOSES CONTRACTOR SHALL ALL SUFFICIENT QUANTITIES FOR REPAIR AND REPLACEMENT OF EROSION CONTROL DEVICES THROUGHOUT ALL PHIASES OF THIS PROJECTS CONSTRUCTION.



PLOTTING NOTE: PLANS PLOTTED TO 11X17 SHEET SIZE ARE 1/2 SCALE - 1"=60"



WIS. STATUTE 182.0175 (1974) REQUIRES MIN. OF 3 WORK DAYS NOTICE BEFORE YOU EXCAVATE



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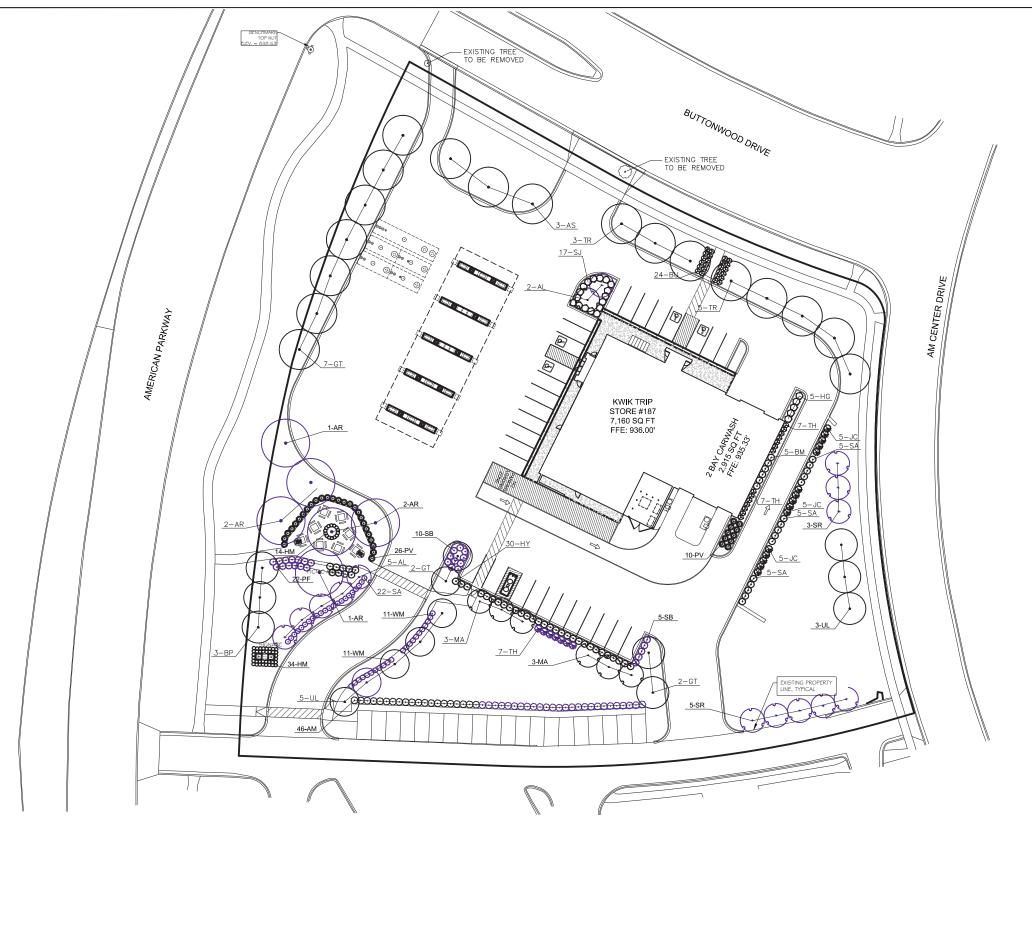
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CONTROL PLAN EROSION

701 AMERICAN PARKWAY ADISON, WISCONSIN 53718 CONVENIENCE

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| DATE | DESCRIPTION | |
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SCALE 1" = 30 PROJ. NO. KTS02 DATE 3-4-15 SWP1 SHEET



PLANT SCHEDULE COMMON NAME BRANDYWINE MAPLE ENDOWMENT SUGAR MAPLE ALLEGANY SERVICEBERRY PAPER BIRCH Gleditisia triacanthos var. inermis 'imperial' 6 MA Malus 'Adams' 8 SR Syringa refoulata 'Nory Silk' 21 TH Thuja occidental's 'Holmstrup' 8 TR Tilla 'Greenspire' 8 UL Ulmus 'New Horizon' IROQUOIS BEAUTY BLACK CHC GREEN VELVET BOXWOOD LITTLE LIME HYDRANGEA OLD GOLD JUNIES JACKMAN POTENTILLA TOR BIRCHLEAF SPIREA ANTHONY WATERER SPIREA GOLDMOUND JAPANESS SPIRE MINISTER MEGEL A GOLDMOUND JAPANESE SPIREA MINUET WEIGELA MIDNIGHT FALSE INDIGO 'PRARIEBLUES' MIGHTY CHESTNUT DAYLLLY GUACAMOLE HOSTA PRAIRIE FIRE SWITCH GRASS

PLANTING PLAN REQUIREMENTS

TOTAL DEVELOPED AREA
TOTAL AREA: 136,420 SQ. FT.
REQUIREMENT: 136,420300 = 455 LANDSCAPE UNITS X 5 = 2275 TOTAL POINTS REQUIRED
(2312 PROVIDED)
EXISTING PLANT MATERIAL ON SITE: 210 PTS.
LANDSCAPE FURNITURE: 32 SEATS X 5 = 160 OR 5% OF TOTAL POINTS = 114
(114 PROVIDED)
PROPOSED PLANT MATERIAL: 1988 PTS.

5 EXT-07 OVERSTORY TREE (FRONTAGE REQUIREMENT

STREET FRONTAGES LINEAR FEET: 539 LF REQUIREMENT: 1 TREE AND 5 SHRUBS/30 LF REQUIRED: 18 TREES (5 - EXISTING) AND 90 SHRUBS (130 PROVIDED)

INTERIOR PARKING LOT LANDSCAPING
TOTAL STALLS: 38
REQUIREMENT: 8% OF TOTAL PARKING LOT AREA TO BE INTERIOR PLANTING AREA
79,097 SF OF PARKING LOT X 8% = 6,328 SF DIV. 160 SF = 40 TREES REQUIRED (41 PROVIDED)

AMERICAN CENTER CANOPY TREE REQUIREMENTS TOTAL STALLS: 50 REQUIREMENT: 1 TREE PER 12 STALLS OR FRACTION THEREOF REQUIRED: 4 TREES (4 PROVIDED)

AMERICAN CENTER LANDSCAPE REQUIREMENTS TOTAL STALLS: 50 REQUIREMENT: 15 POINTS/STALL = 15 X 50 = 750 POINTS REQUIRED (751 PROVIDED)

TWO EXISTING TREES WITH AN APPROXIMATE 2° CALIPER SHALL BE REMOVED DURING CONSTRUCTION AND ARE NOTED ON THE DEMOLITION PLAN. TWO (2) 2 12° CALIPER TREES ARE PROPOSED ON THE LANDSCAPE PLAN THE REPLACE THESE EXISTING TREES. NO POINTS HAVE BEEN ADDED TO THE POINTS FOR THE AMERICAN CENTER REQUIREMENTS OR THE CITY OF MADISON REQUIREMENTS

PLANTING PLAN CONSTRUCTION NOTES

- SEED ALL OTHER AREA'S DISTURBED FROM CONSTRUCTION WITH GRASS SEED MIX IN ACCORDANCE WITH PROPOSED EROSION CONTROL PLAN; UNLESS, OTHERWISE NOTED.
- PLANTING BEDS TO BE MULCHED WITH SHREDDED BARK OR STONES PER THE OWNER'S INSTRUCTION



PLOTTING NOTE: PLANS PLOTTED TO 11X17 SHEET SIZE ARE ½ SCALE - 1"=60'



Call before you dig.

WIS. STATUTE 182.0175 (1974) REQUIRES MIN. OF 3 WORK DAYS NOTICE BEFORE YOU EXCAVATE



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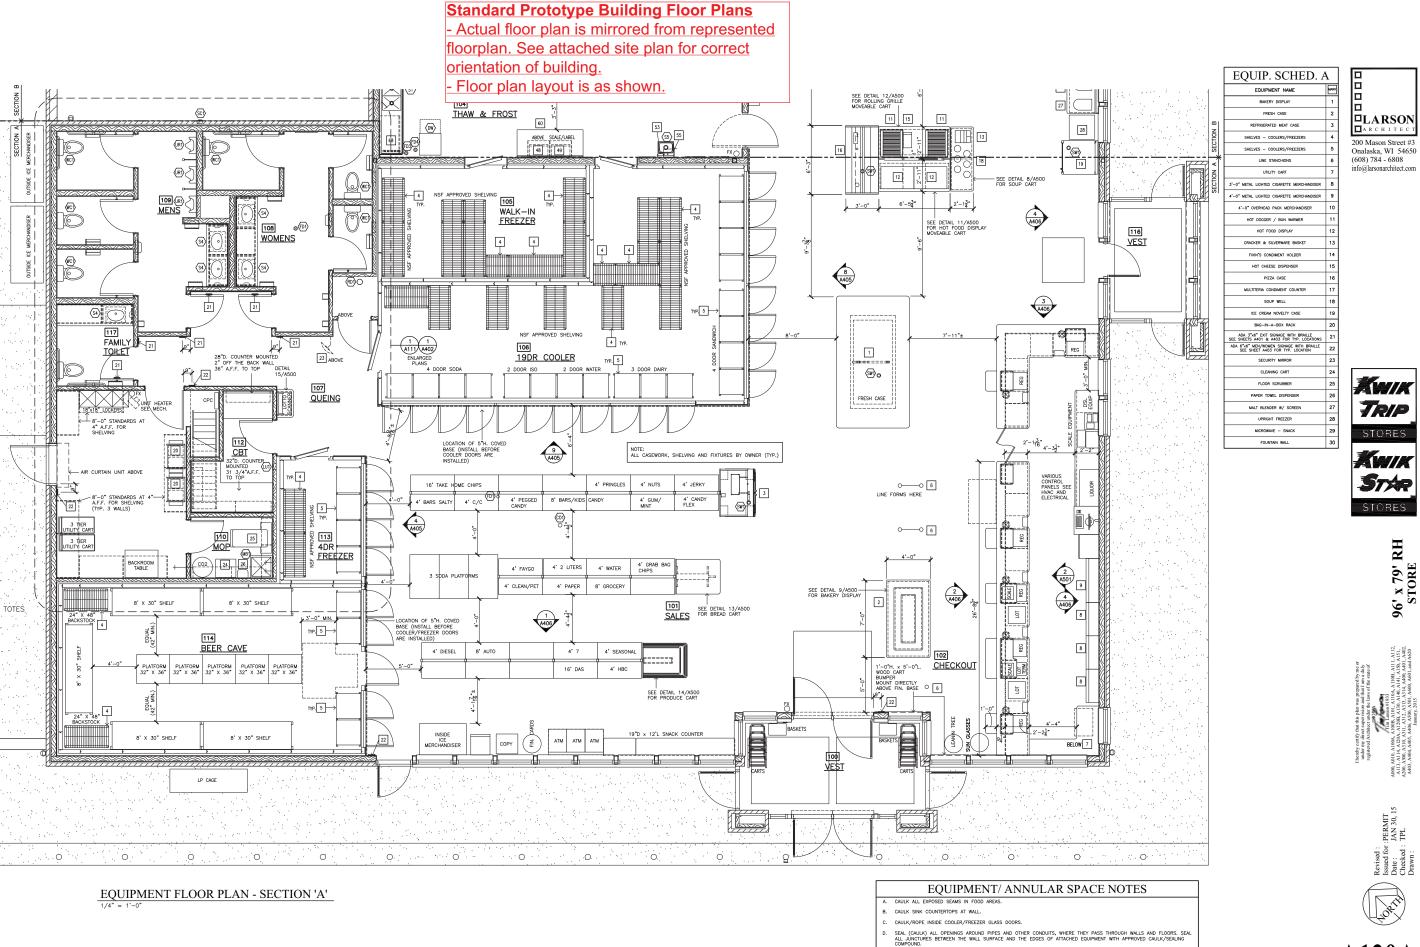
STORE **VENIENCE**

PLAN

<u>NO.</u> !

| LANDSCAPING PLA | CONVENIENCE STOR | 4701 AMERICAN PARKWAY MADISON, WISCONSIN 53718 |
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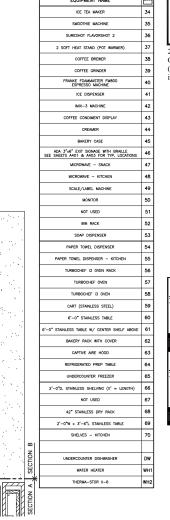
DRAWN BY M. WAHL 1" = 30' SCALE PROJ. NO. KTS02 DATE L1 SHEET



A120A

Standard Prototype Building Floor Plans

- Actual floor plan is mirrored from represented floorplan. See attached site plan for correct orientation of building.
- Floor plan layout is as shown.



EQUIP. SCHED. B

200 Mason Street #3 Onalaska, WI 54650 (608) 784 - 6808 info@larsonarchitect.com




96' x 79' RH STORE




Revised:
| Issued for:PERMIT | Date: JAN 30, 15 | Checked: TPL



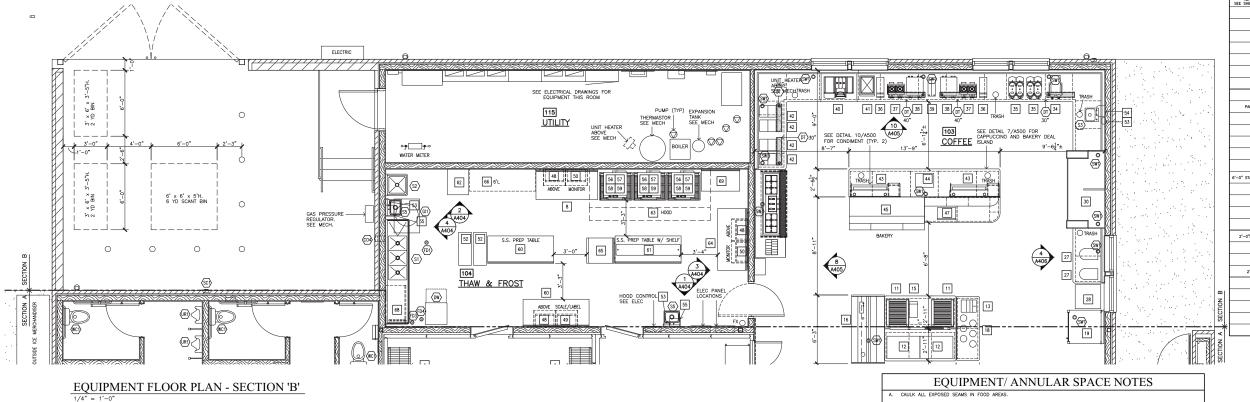

- B. CAULK SINK COUNTERTOPS AT WALL.
- CAULK/ROPE INSIDE COOLER/FREEZER GLASS DOORS.
- D. SEAL (CAULK) ALL OPENINGS AROUND PIPES AND OTHER CONDUITS, WHERE THEY PASS THROUGH WALLS AND FLOORS. SI ALL JUNCTURES BETWEEN THE WALL SURFACE AND THE EDGES OF ATTACHED EQUIPMENT WITH APPROVED CAULK/SEALING COMPOUND.
- EXTEND CONDUIT PIPES FOR BEVERAGE LINES AT LEAST FOUR INCHES ABOVE THE FINISHED FLOOR ELEVATION AT BOTH ENDS. THE SPACE BETWEEN THE BEVERAGE LINES AND THE CONDUIT PIPE MUST BE SEALED WITH A HARD MATERIAL AN PROVIDE A CLEANBREE FINISH.

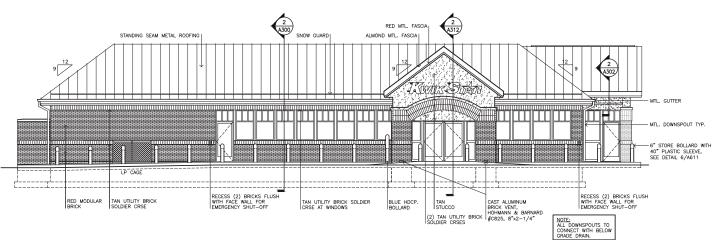


 $\frac{RIGHT\ SIDE\ ELEVATION}{1/8" = 1'-0"}$


| EXT. COLOR SCHED. | | |
|-------------------------------|--------------------|-------------------------------|
| MATERIAL | MANUF. | COLOR |
| BOLLARDS | - | BLACK, GLOSS |
| FASCIA | UNA-CLAD 24 GA. | REGAL RED ALMOND |
| METAL GUTTERS & DOWNSPOUTS | - | ALMOND |
| METAL ROOF | UNI-CLAD | HEMLOCK GREEN |
| MORTAR | | GREY |
| RED BRICK | SIOUX CITY | CABERNET BURGUND |
| STUCCO | TOTAL WALL | MORNING MIST SWIRL TEXTURE |
| TAN BRICK | SIOUX CITY | CLEAR BUFF |
| TRASH ENCLOSURE | UNI-CLAD | BURGUNDY |



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$\frac{FRONT}{1/8"} = \frac{1'-0"}{1'-0"}$



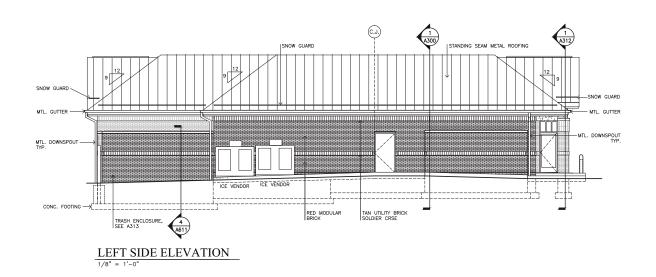


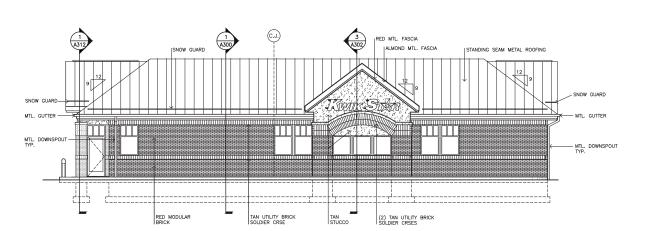






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FRONT ELEVATION

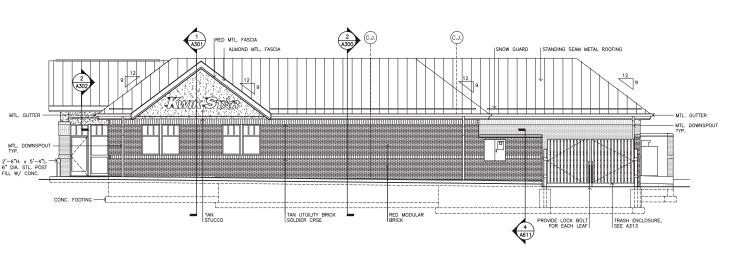

SIDE ELEVATION

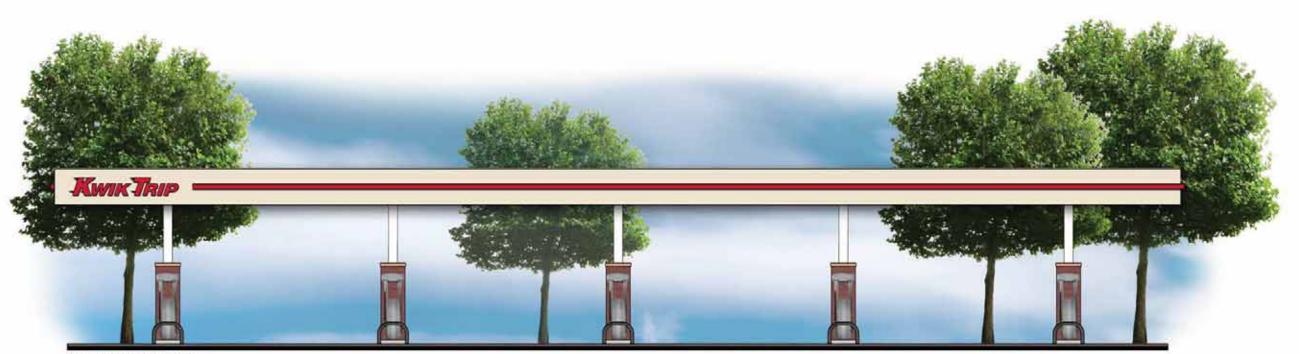Flat Canopy w/ Brick

10 MPD

