

PARKING LOT SITE PLAN INFORMATION - NORTH SIDE OF ROAD

SITE ADDRESS: 4902 & 4908 HAMMERSLEY ROAD, MADISON WISCONSIN, 5371 SITE ACREAGE: 0.806 ACRES NUMBER OF BUILDING STORES (ABOVE GRADE): 2
BUILDING HEIGHT: 29-8-8
DUIRT TYPE OF CONSTRUCTION: TYPE II-B CONSTRUCTION ON THE ADDITION
TOTAL SQUARE FOOTAGE OF BUILDINGS: 29,937 S.F.

NUMBER OF PARKING STALLS

PARRING STALES

STANDARD C. CRE: 104
ACCESSBILE: 5
TOTAL: 109 (ADDITIONAL STALLS PROPOSED ACROSS HAMMERSLEY ROAD — SEE BELOW) NUMBER OF TREES SHOWN: SEE LANDSCAPE PLAN

SITE ADDRESS: 4817 HAMMERSLEY ROAD, MADISON WISCONSIN, 53711 SITE ACREAGE: 0.594 ACRES NUMBER OF BUILDING STORIES (ABOVE GRADE): N/A BUILDING HEIGHT: N/A DILHR TYPE OF CONSTRUCTION: N/A TOTAL SQUARE FOOTAGE OF BUILDINGS: N/A

NUMBER OF BICYCLE STALLS SHOWN: SEE ABOVE NUMBER OF PARKING STALLS

STANDARD CAR: 56 ACCESSIBLE: 0 TOTAL: 56

NUMBER OF TREES SHOWN: SEE LANDSCAPE PLAN


1 ICONICA PACIFIC CYCLE

4902 HAMMERSLEY ROAD
MADISON, WISCONSN, 33711

Midwest Equity Properties, LLC
7719 GREENWOOD ROAD
VERONAN, WISCONSN, 35360 ISSUE DATES: This drawing indicates the scale and relationship of the project components.
This drawing is not for construction. PROJECT #: 20120410 SHEET NUMBER

A101



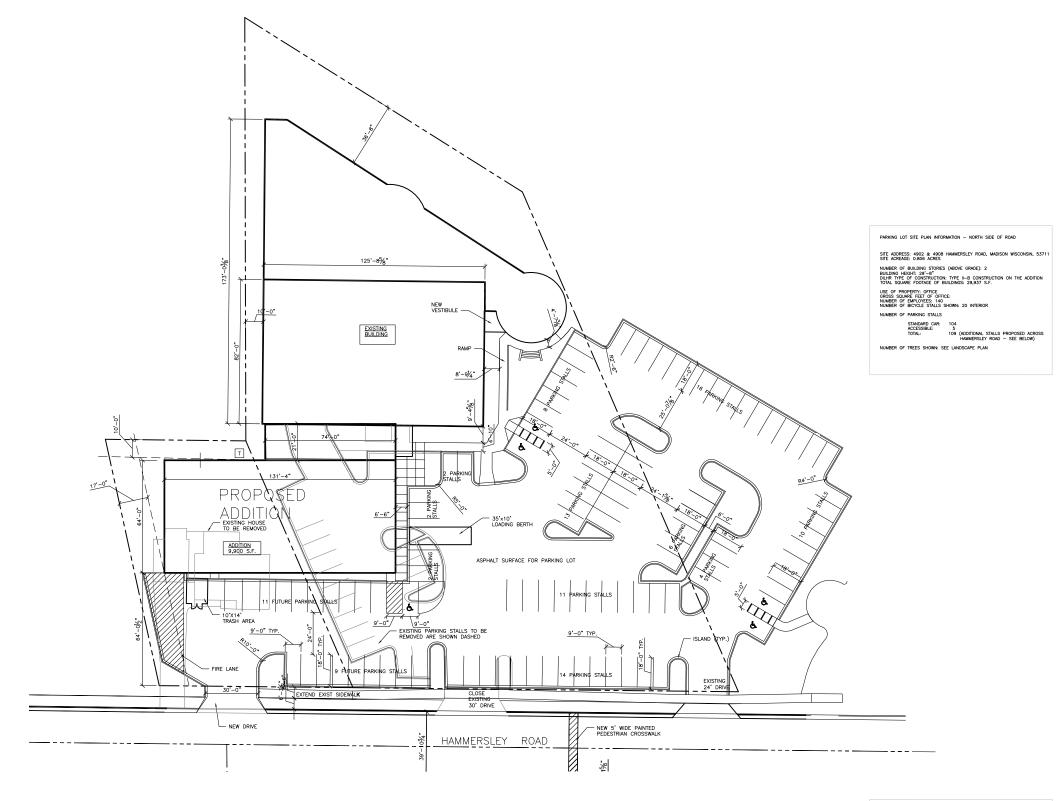





SITE ADDRESS: 4817 HAMMERSLEY ROAD, MADISON WISCONSIN, 53711 SITE ACREAGE: 0.594 ACRES


NUMBER OF BICYCLE STALLS SHOWN: SEE ABOVE
NUMBER OF PARKING STALLS
STANDARD CAR: 56
ACCESSBIE: 0
TOTAL: 56

NUMBER OF TREES SHOWN: SEE LANDSCAPE PLAN

True Desi	Madison, WI 53717 Fx: 608.664.3535
PACIFIC CYCLE 4902 HAMMERSLEY ROAD MADISON, WISCONSIN, 53711	Midwest Equity Properties, LLC 7719 GREEWINGOD ROAD VERONA, WISCONSIN, 53583
ISSUE DATES	:
RFI/SI DATE:	
Schematic De This drawing scale and rel the project c This drawing constru	Indicates the atlonship of omponents. g is not for


PROJECT#: 20120410 SHEET NUMBER

A101

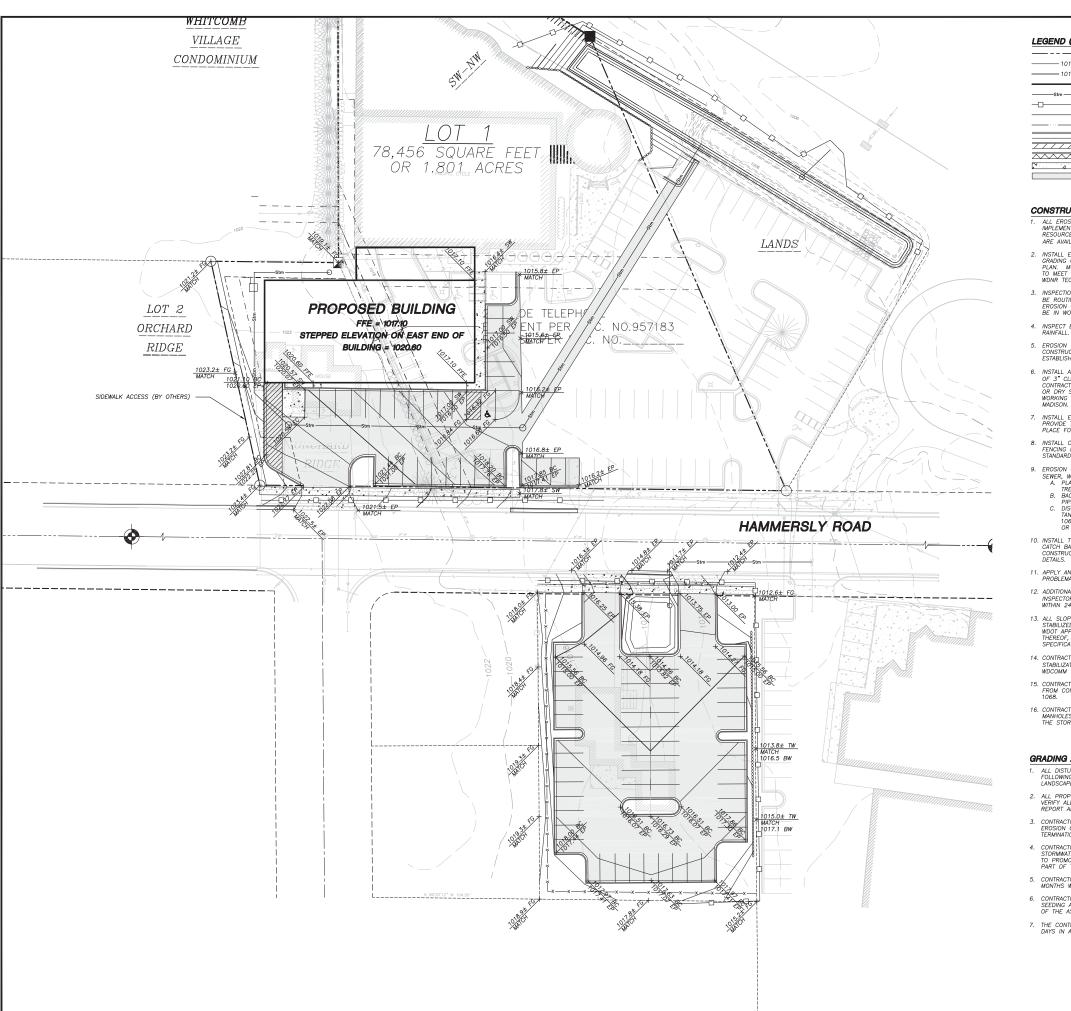

LEGEND (PROPOSED)

- PROPERTY LINE - 1011- PROPOSED 1 FOOT CONTOUR - PROPOSED 5 FOOT CONTOUR BUILDING LINE — STORM SEWER SILT FENCE EDGE OF CONCRETE STORMWATER AREA 18" CONCRETE CURB & GUTTER /////// 18" REJECT CONCRETE CURB & GUTTER 18" MOUNTABLE CONCRETE CURB & GUTTER

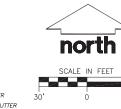

CONSTRUCTION SITE EROSION CONTROL REQUIREMENTS

ALL EROSION AND SEDIMENT CONTROL PRACTICES SHALL BE DESIGNED AND IMPLEMENTED IN ACCORDANCE WITH THE CURRENT DEPARTMENT OF NATURAL RESOURCES EROSION AND SEDIMENT CONTROL TECHNICAL STANDARDS WHICH ARE AVAILABLE AT: http://www.dnr.state.wi.us/runoff/stormwater/techstds.htm

_____ PROPOSED CONCRETE PAVEMENT

PROPOSED ASPHALT PAVEMENT

- INSTALL EROSION CONTROL MEASURES PRIOR TO ANY SITE WORK, INCLUDING GRADING OR DISTURBANCE OF EXISTING SURFACE MATERIALS AS SHOWN ON PLAN. MODIFICATIONS TO SEDIMENT CONTROL DESIGN MAY BE CONDUCTED TO MEET UNFORESEEN FIELD CONDITIONS IF MODIFICATIONS CONFORM TO WORN TECHNICAL STANDARDS.
- 3. INSPECTIONS AND MAINTENANCE OF ALL EROSION CONTROL MEASURES SHALL BE ROUTINE (ONCE PER WEEK MINIMUM) TO ENSURE PROPER FUNCTION OF EROSION CONTROLS AT ALL TIMES. EROSION CONTROL MEASURES ARE TO BE IN WORKING ORDER AT THE END OF EACH WORK DAY.
- INSPECT EROSION CONTROL MEASURES AFTER EACH 1/2" OR GREATER RAINFALL. REPAIR ANY DAMAGE OBSERVED DURING THE INSPECTION.
- EROSION CONTROL MEASURES SHALL BE REMOVED ONLY AFTER SITE CONSTRUCTION IS COMPLETE WITH ALL SOIL SURFACES HAVING AN ESTABLISHED VEGETATIVE COVER.
- 6. INSTALL A TRACKING PAD, 50' LONG AND NO LESS THAN 12" THICK BY USE OF 3" CLEAR STONE. TRACKING PADS ARE TO BE MAINTAINED BY THE CONTRACTOR IN A CONDITION WHICH WILL PREVENT THE TRACKING OF MUD OR DRY SEDIMENT ONTO THE ADJACENT PUBLIC STREETS AFTER EACH WORKING DAY OR MORE FREQUENTLY AS REQUIRED BY THE CITY OF MADISON.
- INSTALL EROSION CONTROLS ON THE DOWNSTREAM SIDE OF STOCKPILES AND PROVIDE TEMPORARY SEEDING ON STOCKPILES WHICH ARE TO REMAIN IN PLACE FOR MORE THAN 7 DAYS.
- 8. INSTALL CHECK DAMS WITHIN DRAINAGE DITCHES AND IN FRONT OF SILT FENCING IN ANY LOW AREA ALL IN ACCORDANCE WITH WDNR TECHNICAL STANDARDS.
- 9. EROSION CONTROL FOR UTILITY CONSTRUCTION (STORM SEWER, SANITARY
- EROSION CONTROL FOR UTILITY CONSTRUCTION (STORM SEWER, SANITARY SEWER, WATER MAIN, ETC.):

 A. PLACE EXCAVATED TRENCH MATERIAL ON THE HIGH SIDE OF THE TRENCH.

 B. BACKFILL, COMPACT, AND STABILIZE THE TRENCH IMMEDIATELY AFTER PIPE CONSTRUCTION.

 C. DISCHARGE TRENCH WATER INTO A SEDIMENTATION BASIN OR FILTERING TANK IN ACCORDANCE WITH THE DEWATERING TECHNICAL STANDARD NO. 1061 PRIOR TO RELEASE INTO THE STORM SEWER, RECEIVING STREAM, OR DRAINAGE DITCH.
- 10. INSTALL TYPE D INLET PROTECTION AROUND ALL STORM SEWER INLETS AND CATCH BASINS THAT MAY RECEIVE RUNOFF FROM AREAS UNDER CONSTRUCTION. REFER TO CITY OF MADISON STANDARD SPECIFICATIONS FOR DETAILS.
- 11. APPLY ANIONIC POLYMER TO DISTURBED AREAS IF EROSION BECOMES PROBLEMATIC.
- 12. ADDITIONAL EROSION CONTROL MEASURES, AS REQUESTED BY STATE INSPECTORS, LOCAL INSPECTORS, AND/OR ENGINEER SHALL BE INSTALLED WITHIN 24 HOURS OF REQUEST.
- 13. ALL SLOPES EXCEEDING 5:1 (20%) AND DRAINAGE SWALES SHALL BE STABILIZED WITH CLASS I, TYPE B ERGSION MATTING OR APPLICATION OF A WOOT APPROVED POLYMER SOIL STRAILIZATION TESTAMENT OR A COMBINATION THEREOF, AS REQUIRED. CONTRACTOR SHALL PROVIDE PRODUCT SECIFICATIONS TO PROJECT ENGINEER FOR APPROVAL.
- 14. CONTRACTOR/OWNER SHALL FILE A NOTICE OF TERMINATION UPON VEGETATIVE STABILIZATION AND/OR PROPERTY SALE IN ACCORDANCE WITH WIDNE AND WIDCOMM REQUIREMENTS.
- CONTRACTOR SHALL TAKE ALL NECESSARY STEPS TO CONTROL DUST ARISING FROM CONSTRUCTION OPERATIONS. REFER TO WDNR TECHNICAL STANDARD 1068.
- 16. CONTRACTOR TO PROVIDE SOLID LID OR METAL PLATE ON ALL OPEN MANHOLES DURING CONSTRUCTION TO MINIMIZE SEDIMENT FROM ENTERING THE STORM SEWER SYSTEM.

GRADING AND SEEDING NOTES

- ALL DISTURBED AREAS SHALL BE SEEDED AND MULCHED IMMEDIATELY FOLLOWING GRADING ACTIVITIES. SEED MIX TO BE IN ACCORDANCE WITH LANDSCAPE PLAN.
- CONTRACTOR SHALL PROTECT ADJACENT PROPERTIES WITH SILT FENCING FOR EROSION CONTROL UNTIL CONSTRUCTION IS COMPLETED AND NOTICE OF TERMINATION FILED.
- CONTRACTOR SHALL CHISEL-PLOW OR DEEP TILL WITH DOUBLE TINES THE STORMWATER MANAGMENT FACILITY JUST PRIOR TO SEEDING AND MULCHING TO PROMOTE INFLITATION. THIS MUST BE VERIFIED BY THE ENGINEER AS PART OF THE AS-BUILT CERTIFICATION.
- CONTRACTOR SHALL WATER ALL NEWLY SEEDED AREAS DURING THE SUMMER MONTHS WHENEVER THERE IS A 7 DAY LAPSE WITH NO SIGNIFICANT RAINFALL.
- 6. CONTRACTOR TO DEEP TILL ALL COMPACTED PERVIOUS SURFACES PRIOR TO SEEDING AND MULCHING. THIS MUST BE VERIFIED BY THE ENGINEER AS PART OF THE AS-BUILT CERTIFICATION.
- THE CONTRACTOR SHALL NOTIFY THE CITY OF MADISON TWO (2) WORKING DAYS IN ADVANCE OF ANY SOIL DISTURBING ACTIVITY.



"BUILDING RELATIONSHIPS WITH A COMMITMENT TO CLIENT SATISFACTION ROUGH TRUST, QUALITY AND EXPERIENCE

- CIVIL ENGINEERING
- SURVEYING & MAPPING CONSTRUCTION SERVICES
- WATER RESOURCES
- PLANNING & DEVELOPMENT
- TRANSPORTATION ENGINEERING
- STRUCTURAL ENGINEERING
- LANDSCAPE ARCHITECTURE MADISON REGIONAL OFFICE

161 HORIZON DRIVE, SUITE 101 VERONA, WISCONSIN 53593 608.848.5060 PHONE 608.848.2255 FAX

MADISON MILWAUKEE KENOSHA APPLETON www.jsdinc.com

SERVICES PROVIDED TO: ICONICA

901 Deming Way, Suite 102

Madison, WI 53717

PROJECT:

PACIFIC CYCLE EXPANSION

PROJECT LOCATION: CITY OF MADISON DANE COUNTY, WI

SEAL/SIGNATURE

ALTHOUGH EVERY EFFORT HAS BEEN MADE N PREPARING THESE PLANS AND CHECKING THEM FOR ACCURACY. THE CONTRACTOR AND SUBCONTRACTORS MUST CHECK ALL DETAIL AND DIMENSIONS OF THEIR TRADE AND BE RESPONSIBLE FOR THE SAME.

12-5318

DRAWN: DOS	11-21-12
APPROVED: WD	
PLAN MODIFICATIONS:	DATE:
CITY OF MADISON	11-28-12




Toll Free (800) 242-8511 Hearing Impaired TDD (800) 542-2289

www.DiggersHotline.com

GRADING & EROSION CONTROL PLAN



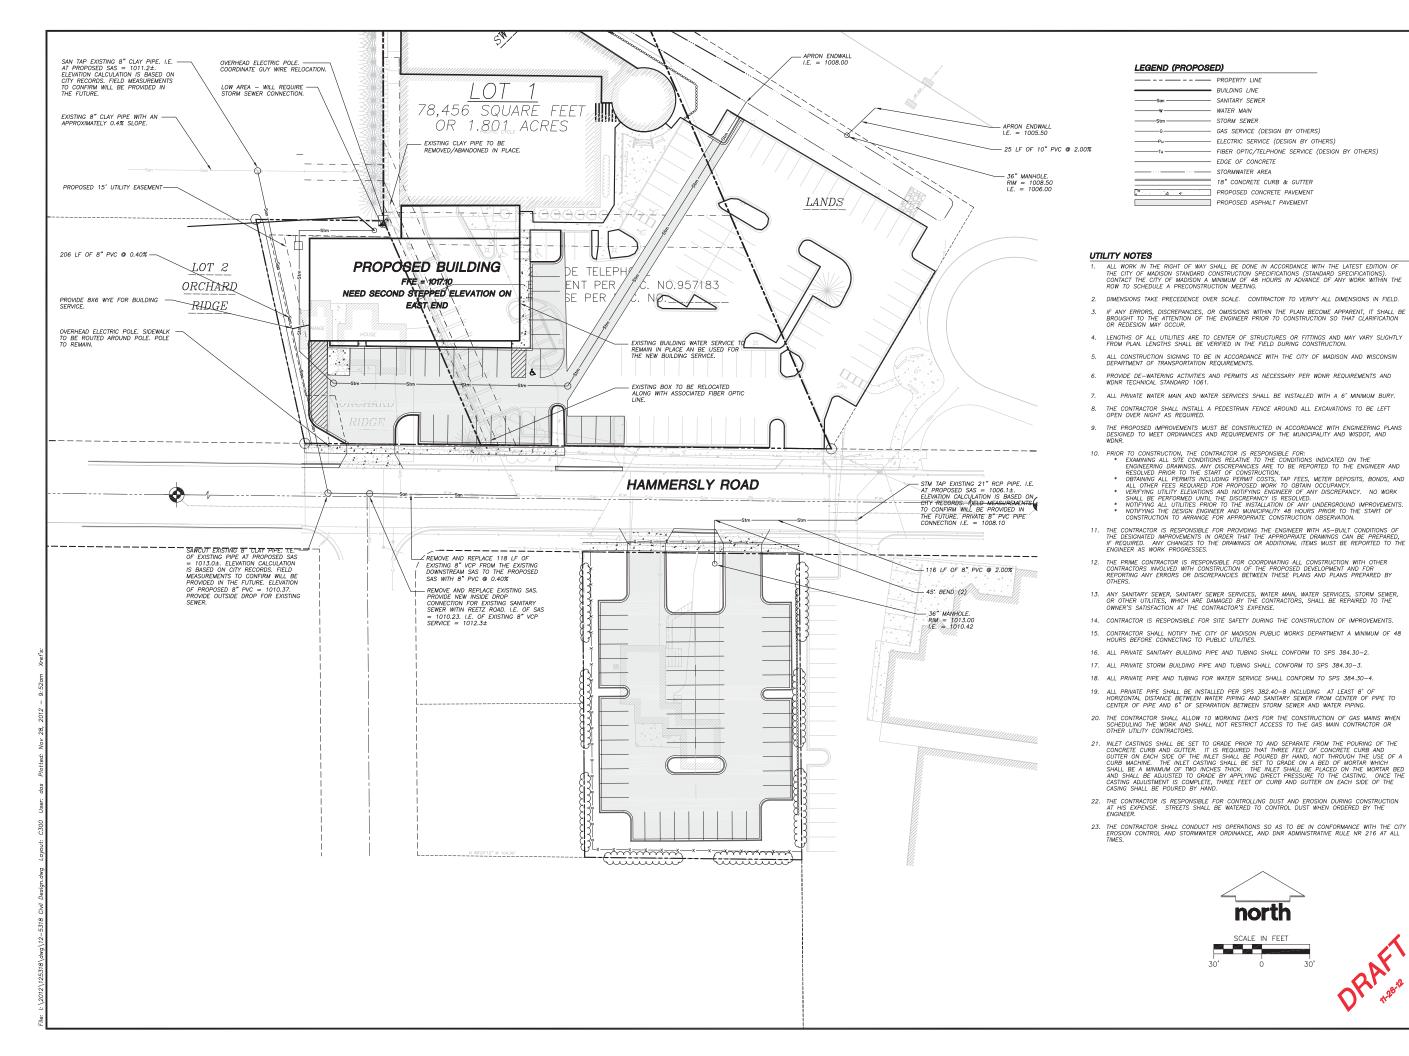



"BUILDING RELATIONSHIPS WITH A COMMITMENT TO CLIENT SATISFACTION ROUGH TRUST, QUALITY AND EXPERIENCE

- CIVIL ENGINEERING
- SURVEYING & MAPPING
- CONSTRUCTION SERVICES
- WATER RESOURCES
- PLANNING & DEVELOPMENT
- TRANSPORTATION ENGINEERING
- STRUCTURAL ENGINEERING
- LANDSCAPE ARCHITECTURE MADISON REGIONAL OFFICE 161 HORIZON DRIVE, SUITE 101 VERONA, WISCONSIN 53593

608.848.5060 PHONE 608.848.2255 FAX MADISON MILWAUKEE KENOSHA APPLETON

www.jsdinc.com

SERVICES PROVIDED TO: ICONICA

901 Demin Way, Suite 102 Madison, WI 53717

PROJECT:

PACIFIC CYCLE **EXPANSION**

PROJECT LOCATION: CITY OF MADISON DANE COUNTY, WI

SEAL/SIGNATURE

ALTHOUGH EVERY EFFORT HAS BEEN MADE N PREPARING THESE PLANS AND CHECKING THEM FOR ACCURACY. THE CONTRACTOR AND SUBCONTRACTORS MUST CHECK ALL DETAIL AND DIMENSIONS OF THEIR TRADE

12-5318

DESIGN: DOS DRAWN: DOS 11-27-12 PPROVED: WD

AND BE RESPONSIBLE FOR THE SAME.

PLAN MODIFICATIONS: DATE:

Toll Free (800) 242-8511

Hearing Impaired TDD (800) 542-2289 www.DiggersHotline.com

UTILITY PLAN

C300

4902 & 4908 HAMMERSLEY ROAD - PARKING LOT

				CRE	DITS		
ELEMENT	POINT VALUE	QUANTITY	POINTS ACHIEVED	QUANTITY	POINTS		
CANOPY TREE: 2"-21/2"	35	9	315	1	35		
DECIDUOUS SHRUB	2			60	120		
EVERGREEN SHRUB	3						
DECORATIVE WALL OR FENCE (PER 10 L.F.)	5						
EARTH BERM AVG. HEIGHT 30" AVG. HEIGHT 15"							
EVERGREEN TREES	15	3	45	1	15		
CANOPY TREE OR SMALL TREE	15	4	60	1	15		TOTAL
SUB TOTALS			420	+	185	-	605
ABM 5 2" Autu STC 4 2" SST 6 4 2" SST 6 1 5 1 5 1 5 1 5 1 5 1 5 1 5 1 5 1 5 1	PLANT MATE MON NAME mon Hackben mn Blaze Ma eant Tina Crc k Hills Spruce ne Honeylocu JMN BRILLIANO NBERRY COTO OF F BURNING I OF FLAME SPIR JMN JOY SED LLA DEORO D.	ry ple bb st st ce service NEASTER BUSH EA	BERRY		ROOT BB BB BB BB BB BP POT POT POT CON CON	(550.1	Req'd)


4817 HAMMERSLEY ROAD - PARKING LOT

					CRE	DITS		
ELEMENT		POINT VALUE	QUANTITY	POINTS ACHIEVED	QUANTITY	POINTS		
CANOPY TREE: 2"-21/2"		35	2	70				
DECIDUOUS SHRUB		2	30	60				
EVERGREEN SHRUB		3					i	
DECORATIVE WALL OR FENC	E (PER 10 L.F.)	5	48	240			1	
EARTH BERM AVG. HEIGHT 30" AVG. HEIGHT 15"								
EVERGREEN TREES		15					1	
CANOPY TREE OR SMALL TO	REE	15	8	120				TOTAL
SUB TOTALS				490	+		-	490
		PLANT MATE	RIALS LIST				(28	3 Req'd)
KEY QL	JAN SIZE COM		_			ROOT		
CH 4 ABM 3 RBC 3	2" Autu	mon Hackber mn Blaze Ma Birch Clump	ple			88 88 88		
CP 5 DCV 30		ry Pear f Cranberry E	Bush Viburnu	ım		BB Pot		
RPG 1,4	Comi Bottle Obed Colur Swite Foxe	ention Planting mon Blue Sto e Gentine ient Plant minie hgrass edge t Eyed Susan	or Wild Swam White Cardi Turk's Little Canad		,	Plug		

NOTES:


- Lawn areas to receive a minimum of 4" of topsoil, starter fertilizer, straw mulch and Madison Parks seed.

- 5) infiltration basin plants (RGP) to be installed 12" on center.

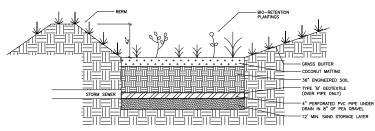

- NOTES:

 70% SULDA SAND, DOX COMPOST of THE FOLLOWING:
 70% SULDA SAND, DOX COMPOST of THE 5.5-6.5
 COMPOST SMALL MEET WORK SPECIFICATION STORE OF SAND AS FOLLOWS:
 2 STORME/INTERFACE LAYER SHALL DONSIST OF SAND AS FOLLOWS:
 SAND. WASHED QUARTZ OR SULDA 0.0.2 0.0.4 INCHES IN DA.
 3) BIO-RENITATION PLANTINGS TO BE PLANTED AT ONE FLUO FER SQUARE FOOT, FLUOS TO BE PLANT STOKK MANDE IN THE WET PRANCE SHORT STATUTE MIKE FROM THE AGRECOL CONTOCATION OF AMPROVED EQUIVALENT. A MINIMUM OF 10 DIFFERENT PLANT STOCK NAMES IN THE BE FLANTED.
- TO PREVENT COMPACTION OF ENGINEERED SOIL AND SUBSOILS. CONTRACTOR SHALL PROTECT AGAINST MACHINERY ENTERING OR COMPACTING THE BIO-RETENTION AREA.

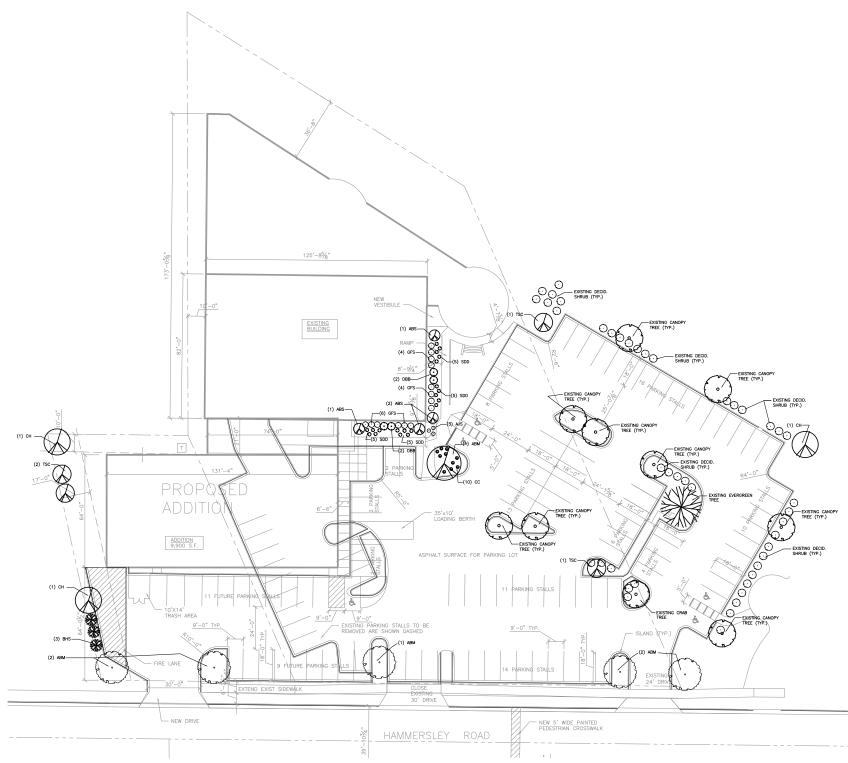





BIO-RETENTION BASIN DETAIL

100 (2) SCALE: N.T.S.

This drawing indicates the scale and relationship of the project components. This drawing is not for construction. PROJECT #: 20120410 SHEET NUMBER

ICONICA

PACIFIC CYCLE
4902 HAMMERSLEY ROAD
MADISON, WISCONSIN, 53711

ISSUE DATES:

L100 (2)

4902 & 4908 HAMMERSLEY ROAD - PARKING LOT CREDITS ELEMENT POINTS ACHIEVED 1 35 CANOPY TREE: 2"-21/2" DECODOUS SHRUB EVERGREEN SHRUB DECORATIVE WALL OR FENCE (PER 10 LF.) EARTH BERM ANG. HEIGHT 30". EVERGREEN TREES CANOPY TREE OR SMALL TREE SUB TOTALS PLANT MATERIALS LIST KEY QUAN SIZE COMMON NAME CH 3 2" Common Hackberry ABM 5 2" Autumn Blaze Maple AJS 3 1G AUTUMN JOY SEDUM SDD 20 1G STELLA DEORO DAYLILY CON


4817 HAMMERSLEY ROAD - PARKING LOT

					CRE	DITS		
ELEMENT		POINT VALUE	QUANTITY	POINTS ACHIEVED	QUANTITY	POINTS		
CANOPY TREE: 2"-2½"		35	2	70				
DECIDUOUS SHRUB		2	30	60			1	
EVERGREEN SHRUB		3					ĺ	
DECORATIVE WALL OR FENCE (PER 1	0 L.F.)	5	48	240			1	
EARTH BERM AVG. HEIGHT 30" AVG. HEIGHT 15"								
EVERGREEN TREES		15					1	
CANOPY TREE OR SMALL TREE		15	8	120				TOTAL
SUB TOTALS				490	+		-	490
KEY QUAN SIZE CH 4 2" ABM 3 2" RBC 3 10'	Comr	PLANT MATE MON NAME mon Hackben nn Blaze Ma Birch Clump	ry ple			ROOT BB BB BB		
CP 5 2" Callery Pear BB DCV 30 24" Dwarf Cranberry Bush Viburnum Pot								
RPG 1,4001"	Comr Bottle Obed Colur Switc Foxse	ntion Planting mon Blue Sto e Gentine ient Plant nbine hgrass edge . Eyed Susan	r Wild Swam White Cardi Turk's Little Cana		,	Plug		


NOTES:


- Lawn areas to receive a minimum of 4" of topsoil, starter fertilizer, straw mulch and Madison Parks seed.

- 5) infiltration basin plants (RGP) to be installed 12" on center.
- 6) Infiltration basin to be constructed per WDNR specifications.

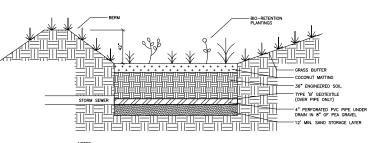


- BIO-RENEMTON PLANTINGS TO BE PLANTED AT ONE PILLO PER SQUARE FOOT, PLIGS TO BE PLANT STOCK NAMED IN THE WET PRAIRE SHORT STATURE MIX FROM THE AGRECOL CORPORATION OR APPROVED EQUIVALENT. A MINIMUM OF 10 DIFFERENT PLANT STOCK NAMES TO BE PLANTED.
- TO PREVENT COMPACTION OF ENGINEERED SOIL AND SUBSOILS. CONTRACTOR SHALL PROTECT AGAINST MACHINERY ENTERING OR COMPACTING THE BIO-RETENTION AREA.

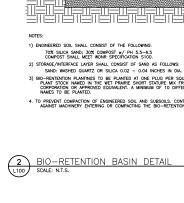

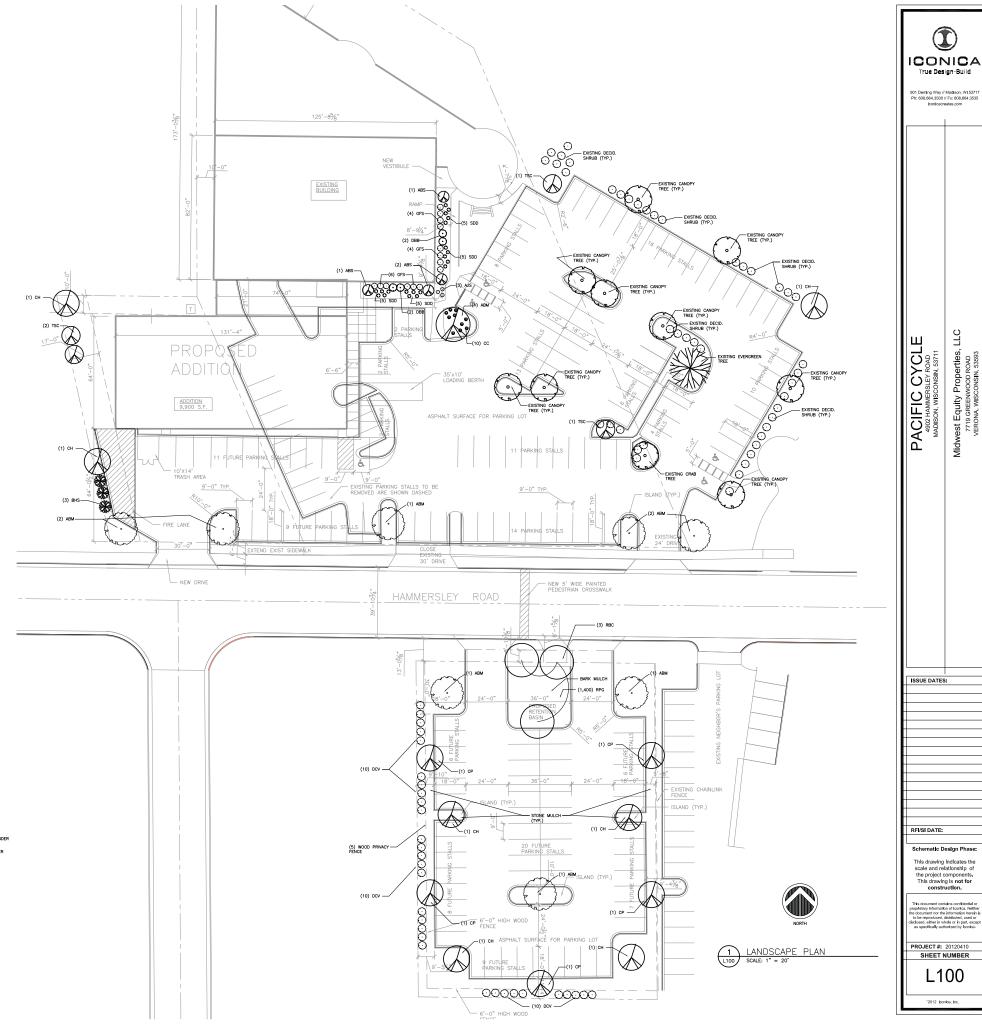


L100



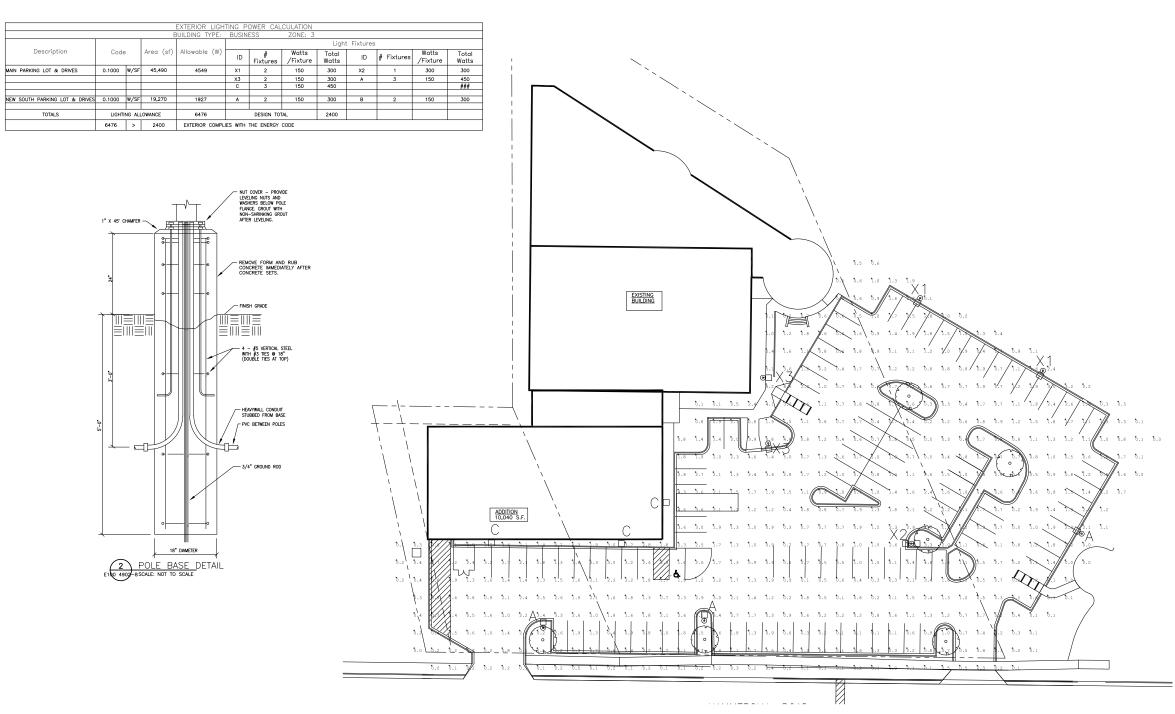



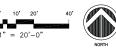

PACIFIC CYCLE 4902 HAMMERSLEY ROAD MADISON, WISCONSIN, 53711	Midwest Equity Properties, LLC 7719 GREENWOOD ROAD VERONA, WISCONSIN, 53893								
ISSUE DATES	:								
RFI/SI DATE:									
This document conta	ains confidential or n of loonics, Neither								
This document contorproprietary information the document nor the to be reproduced, disclosed, either in which as specifically authors as pecifically authors. PROJECT #: SHEET N									

ICONICA

True Design-Build

	LIGHT FIXTURE SCHEDULE											
ID	Description	Size	Series	Manufacturer	Model #	Voltage	Lamps	Mounting	Remarks			
Α	POLE MOUNT FULL CUTOFF	12"x17"	ARCHETYPE	KIM	1SA SAR2 150HPS208 CGL -SVSF-1SA KSS25-4120-SA-DB	208	150W HPS	25' POLE	DARK BRONZE TO MATCH EXISTING			
В	POLE MOUNT FULL CUTOFF	12"x17"	ARCHETYPE	KIM	1SA SAR4 150HPS208 CGL -SVSF-1SA KSS25-4120-SA-DB	208	150W HPS	25' POLE	DARK BRONZE TO MATCH EXISTING			
С	WALL MOUNT FULL CUTOFF	12"x17"	ARCHETYPE	KIM	1W SAR2 150HPS208 CGL -SVSF-1SA	208	150W HPS	WALL AT 20"	DARK BRONZE TO MATCH EXISTING			
X1	POLE MOUNT SINGLE HEAD	EXISTING	FULL CUT OFF	EXISTING	EXISTING	208	150W HPS	25' POLE				
X2	POLE MOUNT TWO HEAD	EXISTING	FULL CUT OFF	EXISTING	EXISTING	208	(2) 150W HPS	25' POLE				
Х3	POLE MOUNT SINGLE HEAD	EXISTING	FULL CUT OFF	EXISTING	EXISTING	208	150W HPS	15' POLE				

				EXTERIOR LIGH	TING P	OWER CAL	CULATION					
			Е	UILDING TYPE:	BUSIN	ESS	ZONE: 3					
								Light	Fixtures			
Description	tion Code			Allowable (W)	ID	# Fixtures	Watts /Fixture	Total Watts	ID	# Fixtures	Watts /Fixture	Total Watts
MAIN PARKING LOT & DRIVES	0.1000	W/SF	45,490	4549	X1	2	150	300	X2	1	300	300
					Х3	2	150	300	A	3	150	450
					С	3	150	450				###
NEW SOUTH PARKING LOT & DRIVES	0.1000	W/SF	19,270	1927	A	2	150	300	В	2	150	300
TOTALS	LIGHTI	NG ALI	OWANCE	6476 DESIGN TOTAL 2400								
	6476	>	2400	EXTERIOR COMPL	EXTERIOR COMPLIES WITH THE ENERGY CODE							

