# Midvale Plaza Redevelopment

A Mixed Use Project at 505-550 Midvale Blvd.

Madison, Wisconsin

May, 17 2006

Site

# Owner • Developer

Midvale Plaza Joint Venture L.L.P.
120 East Lakeside Street
Madison, Wisconsin 53711

# Architects • Planners • Landscape Architects

SIMONSON GERMANY NONEMAKER + ASSOCIATES, INC.

1190 West Druid Hills Drive, Suite T-65

Atlanta, Georgia 30329

Telephone (404) 634-4466

# Civil Engineers

BURSE SURVEYING & ENGINEERING, INC. 1400 East Washington Avenue, Suite 158 Madison, Wisconsin 53703 Telephone (608) 250-9263

## Total Site Data GDP

Site Area: 156,248 s.f. Site Area per Bedroom

789 square feet per bedroom

Density: 3.58 acres

Total Usable Open Space: 74,789 s.f.
Usable Open Space per Unit: 526 s.f. / unit
Usable Open Space per Bedroom: 377 s.f. / bedroom

Site Area per Unit: Parking Data

1100 square feet per unit

Enclosed Parking: 226 stalls
[1 vas secentide stalls provided]
[3 secentide stalls provided]
Surface Parking: 98 stalls
[5 secentide stall provided]

# Total Building Data GDP

Proposed New Construction: 306,701 s.f.

Parking - 81,914 square feet Retail/Library - 39,133 Residential - 185,654 square feet

Total Dwelling Units: 142
Total No. of Bedrooms: 198

One Bedrm. Two Bedrm. Two Bedrm.+ Study
hase I: A: 22 B-I: 15 C-I: 6
hase II: A: 64 B-I: 35 C-I: -

86 50 6

# Site Data Phase I

Site Area: 81,229 s.f. Site Area per Bedroom
1269 square feet per bedroom

Density: 1.86 acres 23.1 units per acre

Total Usable Open Space: 33,029 s.f.
Usable Open Space per Unit: 768 s.f. / unit
Usable Open Space per Bedroom: 516 s.f. / bedroom

Site Area per Unit: Parking Data
1889 square feet per unit Enclosed Parking: 88 stalls

[I van accessible stall provided]
[I secessible stall provoded]
Surface Parking: 98 stalls
[5 accessible stall provided]

# Building Data Phase I

Location Map

Proposed New Construction: 125,657 s.f.

Parking - 30,799 square feet
Retail/Library - 28,793
Residential - 66,065 square feet

Total Dwelling Units: 43


Total No. of Bedrooms: 64

One Bedrm. Two Bedrm. Two Bedrm.+ Study

A-1: 6 B-1: 2 C-1: 1
A-2: 6 B-2: 2 C-2: 1
A-3: 4 B-3: 1 C-3: 1
A-4: 2 B-4: 4 C-4: 1
A-5: 2 B-5: 2 C-5: 1
A-6: 2 B-6: 1 C-6: 1
B-7: 1
B-8: 1
B-8: 1
B-8: 1

# Index of Drawings


Sheet No. Sheet Title Sheet No. Sheet Title Existing Condition: A2.1 Parking Level Plan A2.2 First Floor Building Plan Cla Existing Photo Erosion Control Plan A2.3 Second Floor Plan Grading Plan A2,4 Third Floor Plan A2.5 Fourth Floor Plan A2.6 Midvale Blvd. Elevation Fire Protection Plan Library Entry Elevation Landscape Plan Spccs., Details & Plant List A2.7 Tokay Blvd. Elevation Total Site Landscape Plan Hardscape Plan Hardscape Details

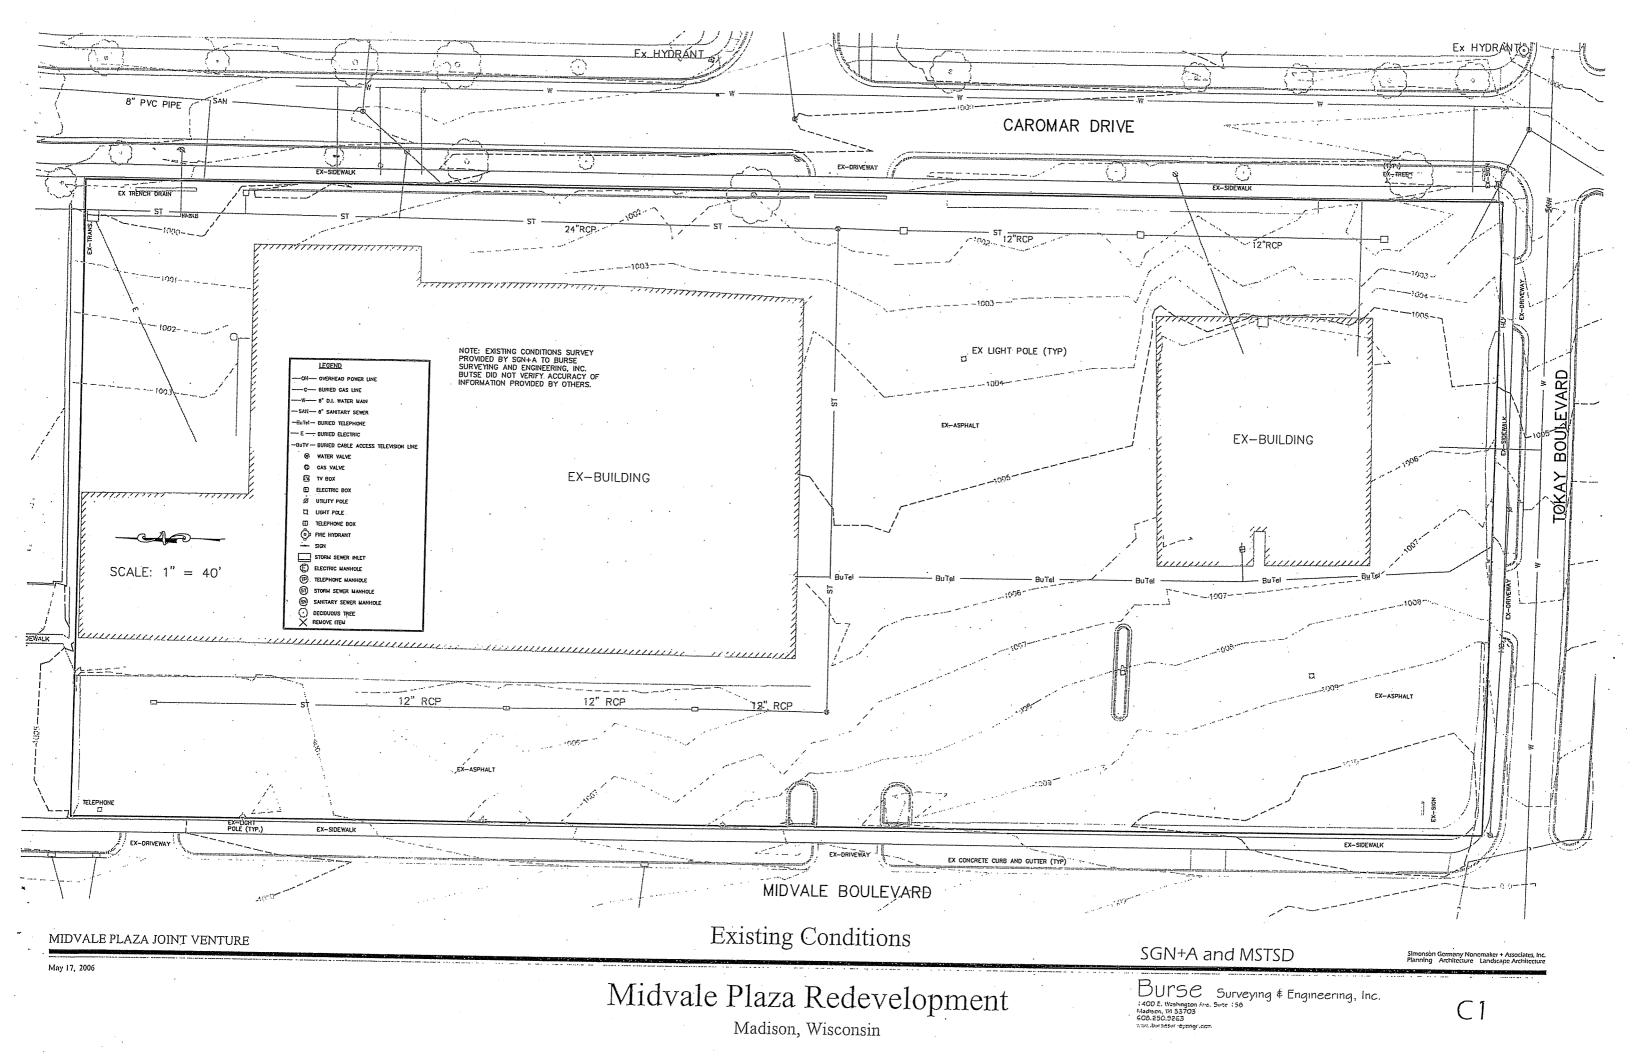





**Existing Photos** 

SGN+A and MSTSD Simonson Germany Nonemaker + Associates, Inc. Planning Architecture Landscape Architecture

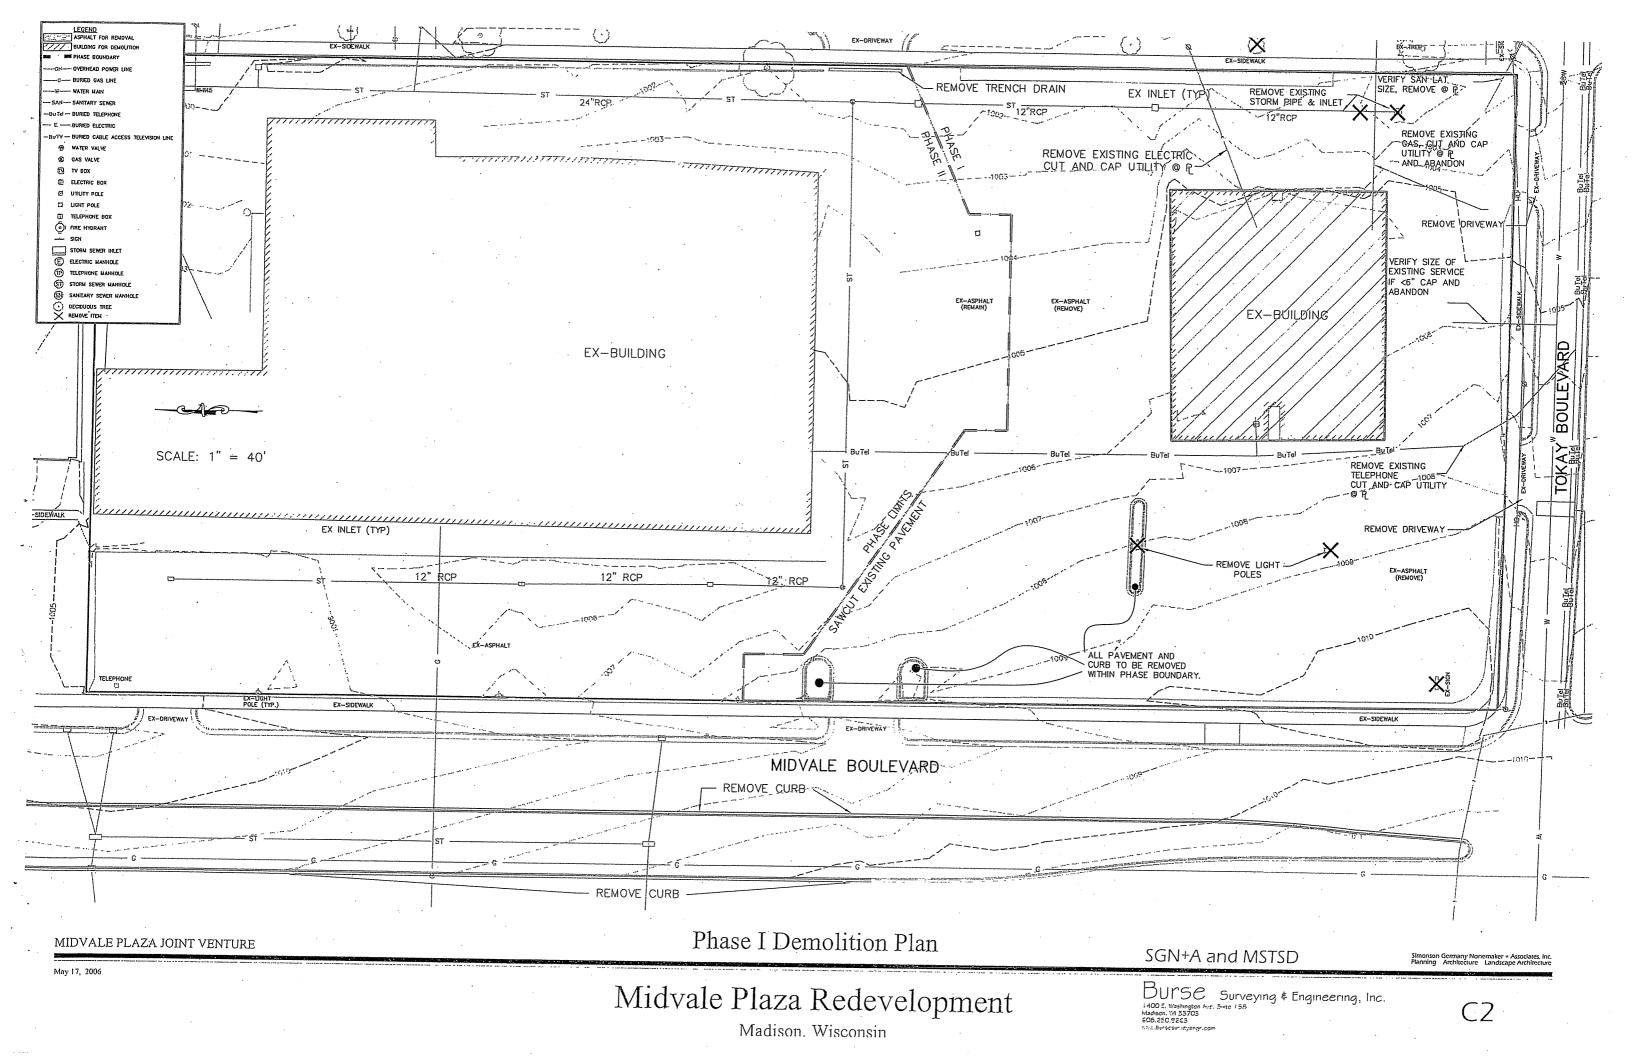

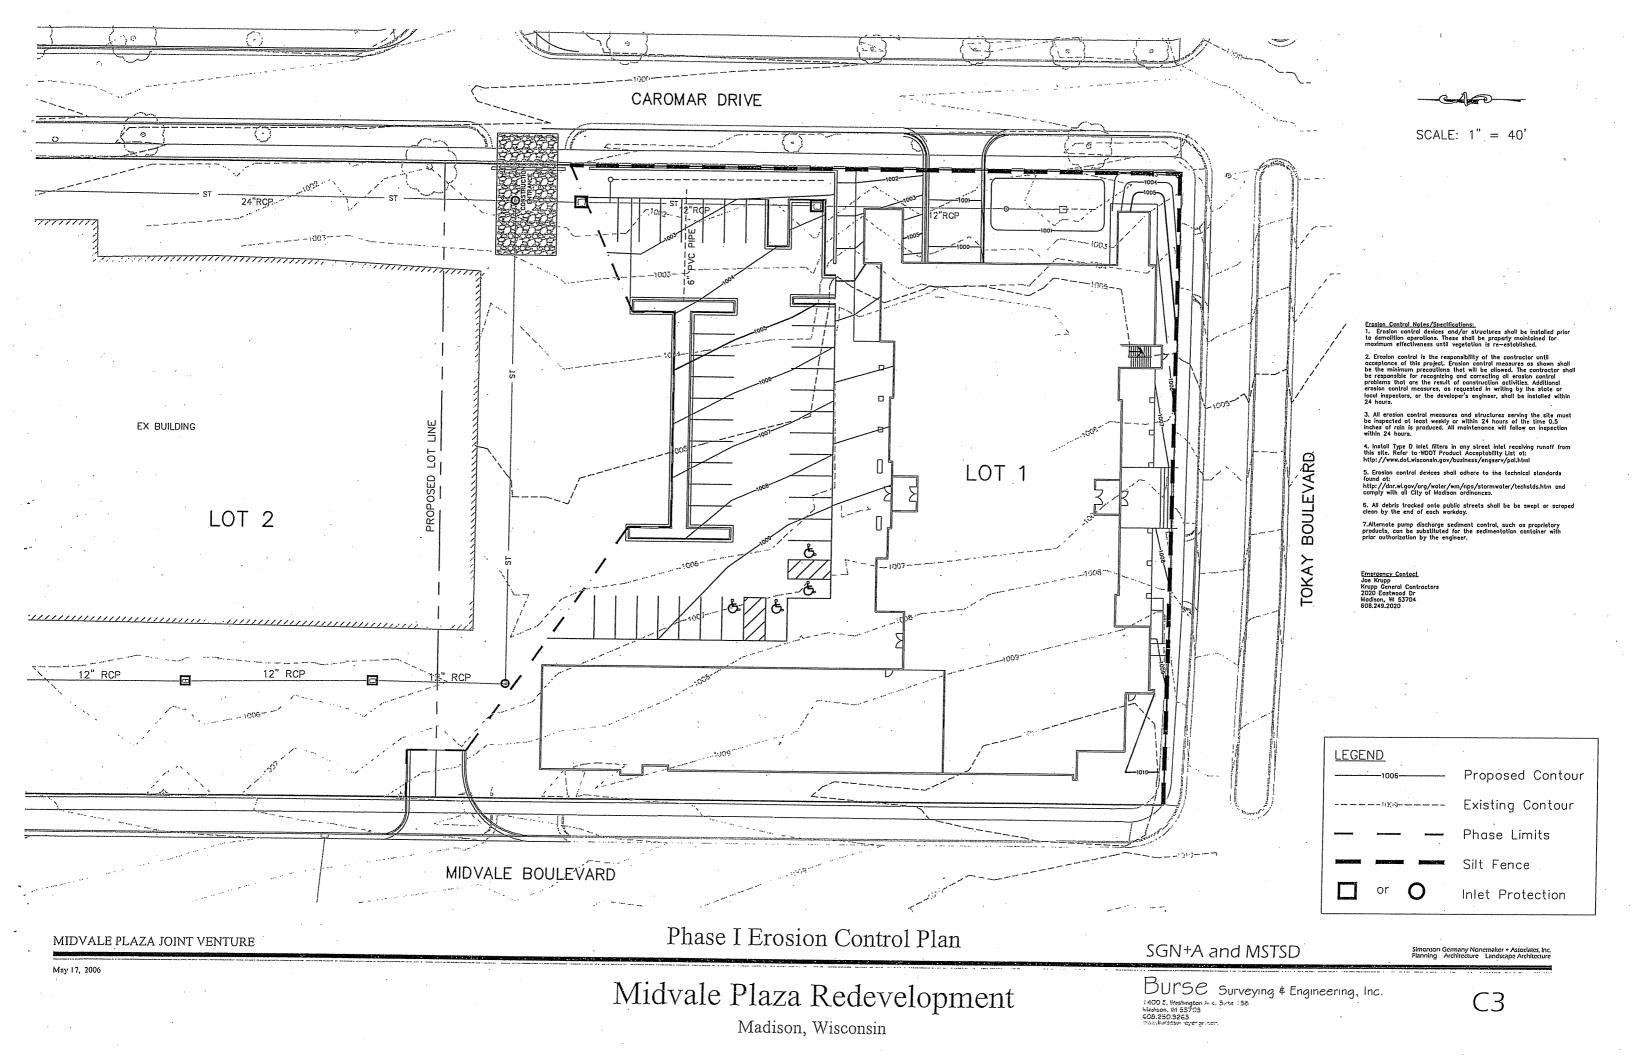

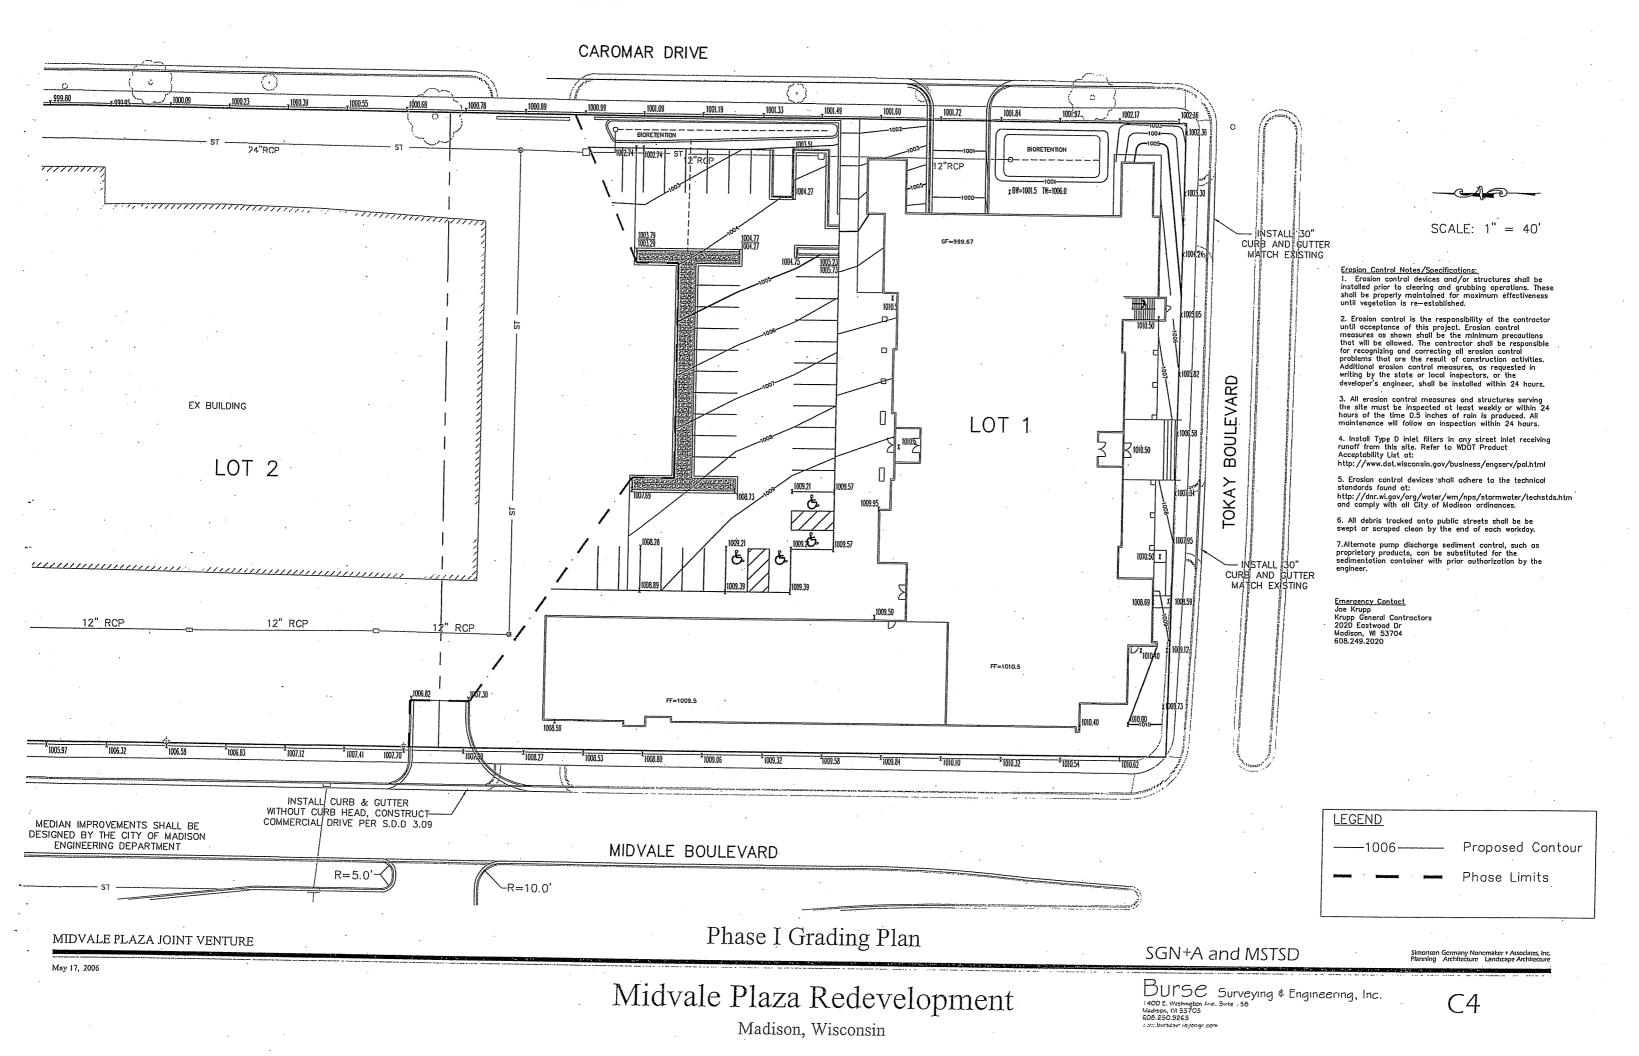



TDD(FOR THE HEARING IMPAIRED)(800)542-2289

WIS. STATUTE 182.0175 (1974) REQUIRES MIN. OF 3 WORK DAYS NOTICE BEFORE YOU EXCAVATE


## LEGEND PHASE BOUNDARY G---- BURIED GAS LINE W----- 8" D.I. WATER MAIN - SAR- 8" SANITARY SEWER E --- BURIED ELECTRIC BUTY --- BURIED CABLE ACCESS TELEVISION IT WATER VALVE CAS VALVE TV BOX ELECTRIC BOX & . UTILITY BOLE U UGHT POLE TELEPHONE BOX FIRE HYDRANT STORM SEWER INLET TELEPHONE MANHOLE STORM SEWER MANHOLE SANITARY SEVER MANHOLF

## SITE UTILITY NOTES:

- 1. The location of existing utilities shown on the plans are approximate. Verification and protection of existing utilities is the Contractor's
- 2. All utilities serving the proposed building shall be stubbed 5 feet outside of the building and marked using a 4" x 4" hardwood post.
- 3. Inlets shall include an inlet filter system. This inlet filter system shall be the Catch—All HR, with overflow as furnished by MarMac Manufacturing Co. or approved equal. After installation, the Contractor shall inspect each inlet bag every 2 weeks or after a rainfall of 1 inch or more and clean bags as necessary. At the completion of construction, the engineer and contractor shall inspect each bag and either clean or replace the bags as necessary.
- 4. Contractor to coordinate with MG&E, Charter Communications and AT&T for gas, electric, telephone, cable extensions and connectionds.
- 5. Water main shall be laid with a minimum of 6.5' of bury to top of
- 6. Following utility line placement, backfilling to restore site grades can be completed. On—site soils can be used as backfill to within 3 ft of finished subgrade levels provided that: (1) they are temporarily stockpiled and allowed to dry as much as practical; (2) they contain no peat material; (3) some compactive effort is applied to achieve densification/consistency similar to adjacent soils; and (4) provisions are made to utilize some of the surcharge granular soils in the event backfilling with the excavation spail becomes impractical.

## STORM SEWER AND SANITARY SEWER ELEVATION TABLE


|         |         |            | - VEILE    | TAUDIN I  | SOLL.        |
|---------|---------|------------|------------|-----------|--------------|
|         | RIM/TC  | INV        | INV        | INV       | INV          |
| INL 1   | 997.00  | N 992.70   | W 993.40   | S 992.75  |              |
| INL 2   | 999.80  | W 996.60   |            |           |              |
| INL 3   | 1005.34 | S-1001.34  | N 1001.44  |           | <del> </del> |
| INL 4   | 1005.37 | S 1002.12  | N 1002.22  | 1         | 1            |
| INL 5   | 1005.08 | UNMEASUR   | EABLE      |           |              |
| INL 6   | 1001.23 | S 996.38   | N 996.28   | <b> </b>  |              |
| INL 7 · | 1001.14 | S 997.24   | N 997.19   | 1         |              |
| INL 8   | 1001.38 | N 998.38   |            |           | 1            |
| INL 9   | 1006.87 | E 999.79   | · ·        |           | 1            |
| INL 10  | 1006.37 | E 1003.27  |            |           | <u> </u>     |
| INL 11  | 1004.42 | W 1001.22  |            | 1         | · ·          |
| INL 12  | 1004.48 | W 1001.13  |            | 1         | <u> </u>     |
| INL 13  | 1006.54 | W 1003.04  |            |           |              |
| INL 14  | 1008.94 | W 1003.24  | E 1003.14  |           | <u> </u>     |
| MH 1    | 1001.57 | N 996.02   | W 996.12   | S 996.07  | l .          |
| MH 2    | 1006.27 | N 1000.52  | E 1000.42  |           |              |
| MH 3    | 1006.30 | WATER LEV  | EL 999.64  | -         |              |
| MH 4    | 1008.80 | WATER LEV  | EL 1002.10 |           | <del></del>  |
| MH 5    | 1011.91 | N 1004.21  | W 1004.51  | S 1004.63 |              |
| MH 6    | 1002.77 |            | NE 993.89  |           |              |
| MH 7    | 1001.44 |            |            | E 992.87  | S 993.06     |
| MH 8    | 999.92  | FLOOR 991. | 43         |           | 200.00       |
| MH 9    | 999.05  | N 988.85   | E 996.07   | SW 990.55 |              |
| MH 10   | 996.07  |            |            | E 985.52  | S 985.30     |
|         |         |            |            |           |              |

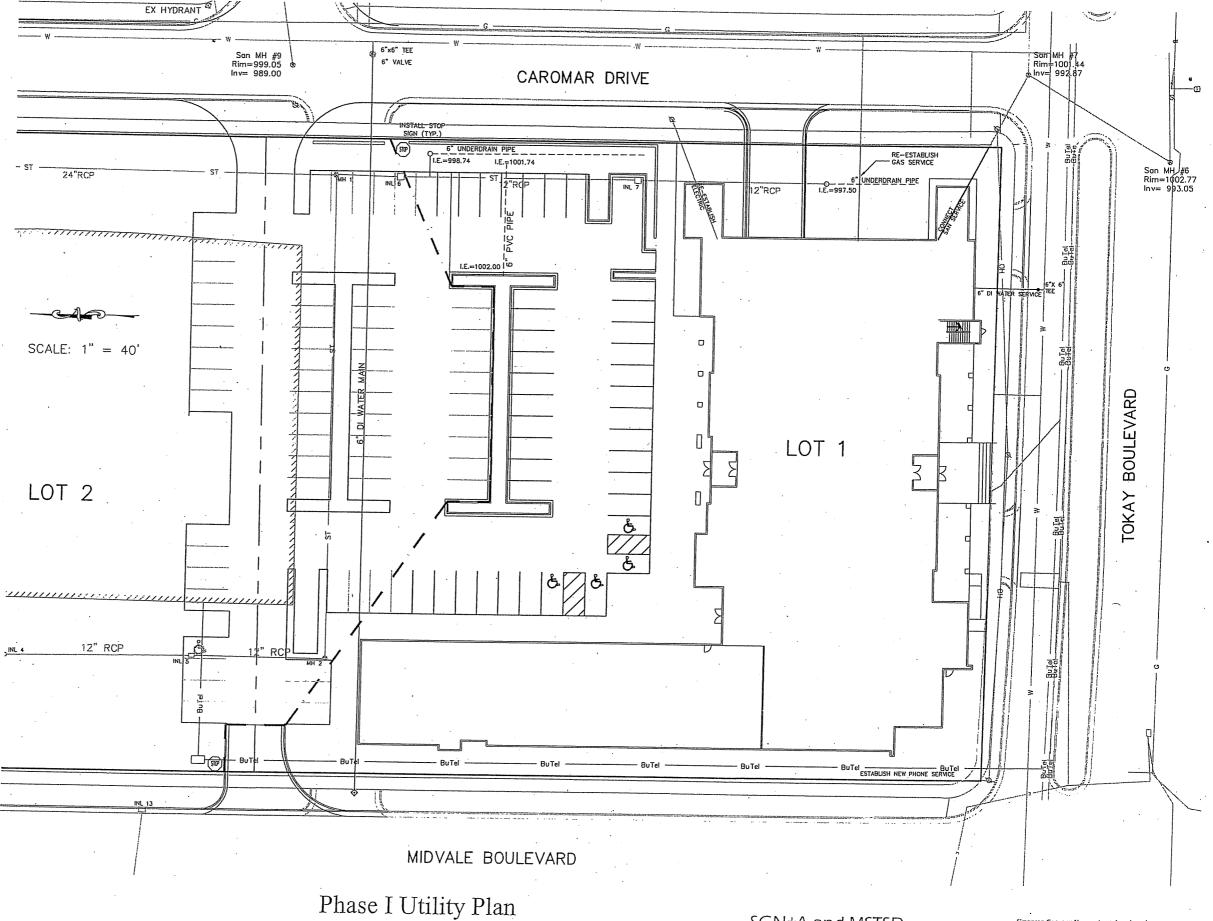

MIDVALE PLAZA JOINT VENTURE

SGN+A and MSTSD


Simonson Germany Nonemaker + Associates, Inc. Planning Architecture Landscape Architecture

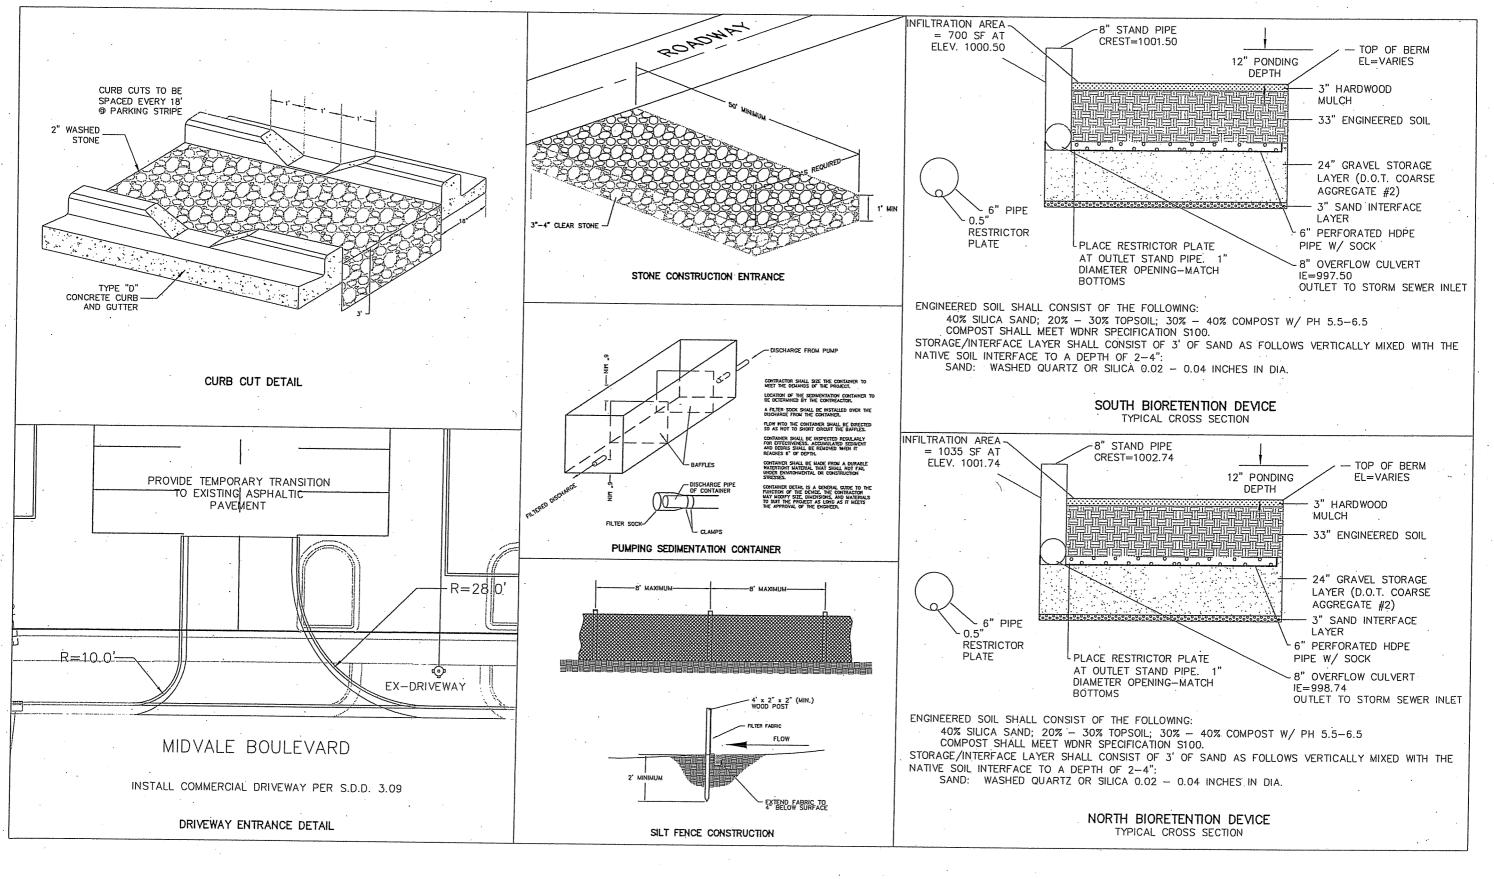

Phase I Details Sheet

SGN+A and MSTSD

Planning Architecture Landscape Architecture

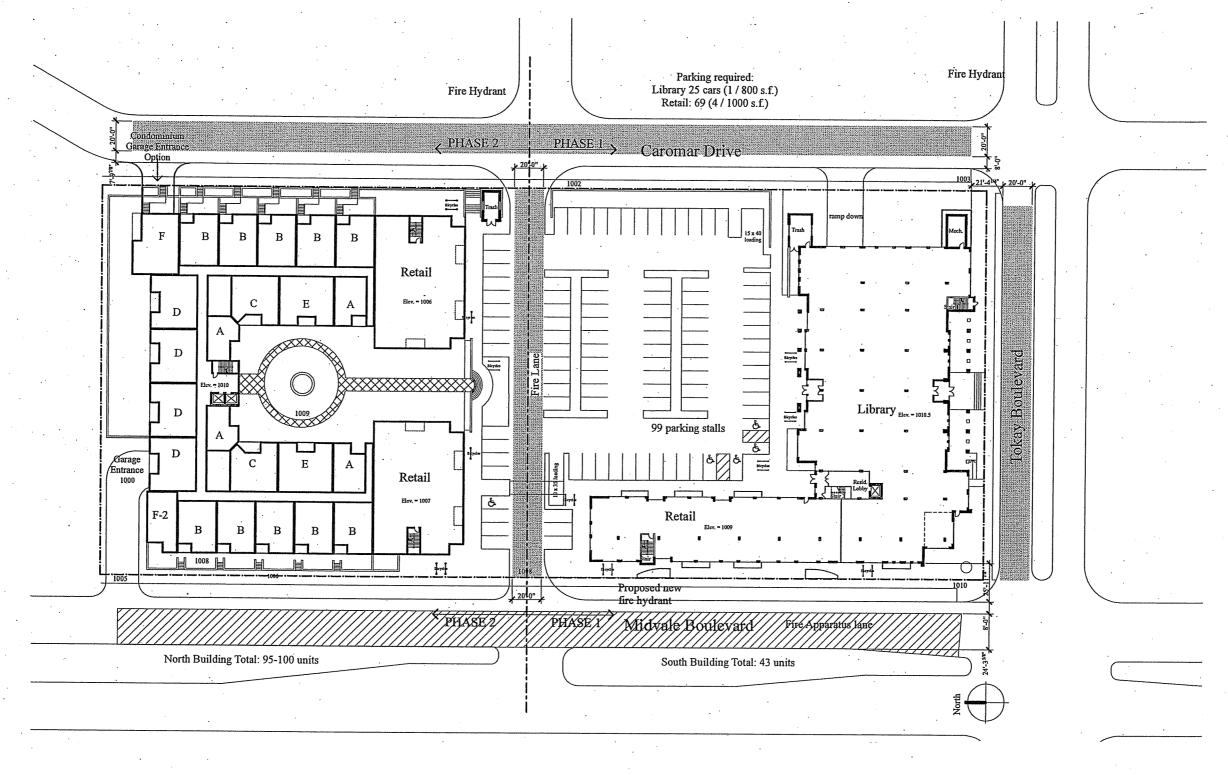


Scale: 1" = 30'-0"

Fire Protection Plan

MIDVALE PLAZA JOINT VENTURE

SGN+A and MSTSD Simonson Germany Nonemaker + As Planning Architecture Landscape

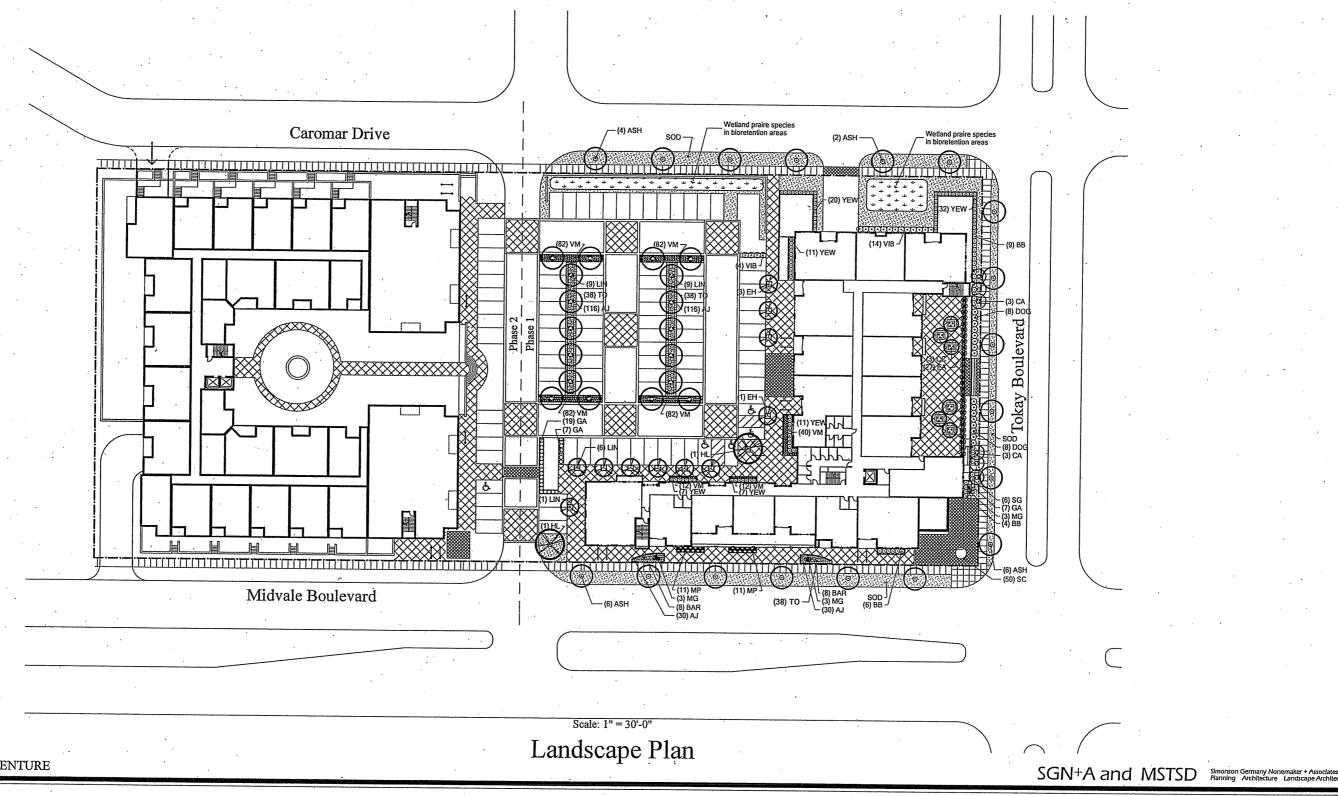

Midvale Plaza Joint Venture, LLP Planting Specifications

General Information

is hereinafter referred to as the <u>Owner</u> and may be represented by an approved representative. Simonson Germany Nonemaker + Associates hereinafter referred to as the <u>Landscape Architect</u>.

The contractor signing this Agregment, or his deligning presentative is hereinafter referred to as the Contractor.

Bidding is based on sheets and specifications.

The competency and responsibility of Bidders will be considered in making the award. The Owner reserves the right to reject any or all bids, and to waive informality in bids received.

Laws and Ordinances: The Contractor and all Subcontractors shall bind themselves to comply with all laws and ordinances and requirements of all authorities having jurisdiction over this property, and shall protect the owners from damage arising from violation thereof.

The Contractor shall give his personal supervision to the work, and have a responsible superintendent continuously on the job to act for him.

Terms of payment will be as established by the Owner.

Public liability and property damage insurance will be as determined by the

Approval and Rejection of Materials

<u>Approval</u>: The selection of all materials and execution of all operations required under these drawings and specifications are subject to approval of the Landscape Architect or Owner.

Rejection: The Landscape Architect or Owner shall have the right to reject all material and all work which in his opinion does not meet the requirements of the drawings and specifications at any stage of the operation, All rejected material shall be removed by the Contractor as directed.

The Contractor shall layout his work and set necessary markers and stakes, and be responsible for the corrections. The Landscape Architect, or Owner, reserves the right to relocate shrubs and trees from positions on the plans prior to planting. The Contractor shall notify the Landscape Architect, Owner at least three (3) days in advance that the locations are staked and ready for approval prior to

## Extra or Omitted Work

While no new or unforeseen items are anticipate, they shall be classed as extra work in they cannot be covered by any of the specifications or drawings. The Contractor shall submit detailed prices for any extras to the Landscape Architect, and shall perform extras upon written acceptance from the Owner or Landscape Architect, in the absence of such written order, he shall not be entitled to

The Landscape Architect shall have authority to order minor changes in the work no linvolving an adjustment in the contract sum or and extension of the contract documents. Such changes may be rejected by field order or by written order. Such changes shall be binding on the Owner and Contractor.

The Owner without invalidating the contract, may order changes in the work consisting of additions, deletions or other revisions, with the contract time being adjusted accordingly. All changes in the work shall be authorized by change order and shall be executed under the applicable conditions to the contract

## Landscape Architect's Status

The Landscape Architect is the agent of the Owner. He has authority to stop work whenever such stoppage may be necessary to insure the proper execution

The Landscape Architect is the interpreter of the conditions of the contract and the judge of its performance; he shall side neither with the Owner nor with the Contractor, but shall use his powers under the Contract to enforce its faithful

Should there be anything shown on the drawings but not described in the specifications, or not shown on the drawings but described in specifications, the same shall be fully executed and carried out as if drawn, shown, or described in both. The Contractor is not be make any alterations or corrections on the drawings or in the specifications. Should any error appear, the same is to be

referred to the Landscape Architect before the bids are submitted, or the work is commenced, or as otherwise specified herein.

Landscape Contractor to verify all plant quantities prior to bid.

## Measurements, Layouts and Levels

All lines and levels necessary for the location and erection of the landscape construction and for the excavation, filling, and grading work shall be established by the Contractor. The Contractor shall take his own measurements of the sile, verifying it with the drawings, and shall be responsible for the proper fit of his portion of the completed work.

Extra changes or compensation will not be allowed on the account of differences between actual measurements and the dimensions shown on the drawings, but any such differences that may be found shall be submitted to the Landscape Architect for adjustment before proceeding with the work.

## Substitution of Materials

Substitutes will be permitted only upon admission of proof that specified plants are not obtainable, and with the authorization of the Landscape Architect. Written requests with nearest available size, and variety of plant, and price adjustments, are to be submitted to the Landscape Architect.

The Landscape Architect will not engage in any way to superintend so as to relieve the Contractor of responsibility for the consequences of neglect or carelessness by him or his subordinates.

Perform all work required to complete the landscape installation including all labor, materials, services, and equipment necessary and described herein a

## Applicable Standards

American Standard for Nursery Stock, latest edition.

American Joint Committee on Horticultural Nomenclature, edition of Standardized Plant Names

All plants shall conform to the standards as given in Grades and Standards of Nursery Plants, published by the AAN.

The Landscape Contractor is responsible for verification of all quantities. Any discrepancies shall be brought to the attention of the Landscape Architect however, it's the Contractor's responsibility to provide all trees as shown on the plans, and plant beds so that each has the proper quantity of shrubs for the areas designated.

Proposed trees are to be located either completely in or completely out of the planting beds.. <u>Bedlines are not to be obstructed</u>.

The Landscape Contractor is responsible for all staking and guying of trees.

## Existing Trees & Areas Outside of Grading Limits

Trees and vegetation to be saved shall be protected from damage by a wood fence barricade prior to or during clearing operations. Trees to be saved will be designated by the Owner. No trees are to be removed from areas outside the limits of grading from specifically designated undisturbed areas within the constitutions area. If, in the opinion of the Landscape Architect, a contractor damages a tree not to be removes, the Contractor will be fined \$100.00 per caliper inch for each damaged tree. The Contractor will also be responsible for all costs in removing the damaged tree from the site.

Water will be available on the site at no expense to the Contractor. Hoses and other watering equipment required for the work shall be furnished by the Contractor at his expense.

The Contractor is responsible for the construction of all berms shown on the landscape planting plans or berm plans. Berms may be built of excavated soil from bed preparation and/or stockpile material, should follow contour according to plans. If more material is necessary for berm construction, Contractor is responsible for additional material. All grades should be smooth slopes to allow for mowing without scalping laws areas. Setting and refilling should be accomplished before planting grass, or other plant materials.

During the work, the premises are to be kept neat and orderly at all times. Storage areas for plants and other materials shall be so organized that they too are neat and orderly. All trash including debris resulting from removing weeds or from planting areas, preparing beds, or planting plants shall be removed from the site daily as the work progresses. All walks and drives shall be kept clean by sweeping and/or hosing. Excavated soil may be distributed on the site as directed by the Owner.

Acceptance for all landscape work shall be given after final inspection by the Owner and/or Landscape Architect, provided the job is in a completed, undamaged condition, and there is grass (substantial coverage) in all grass areas. At this time, the Owner will assume maintenance on the accepted work.

The Contractor shall maintain all trees, shrubs, and groundcover under this Contract until acceptance, by watering, moving, spraying and replacing as necessary to keep plants in a healthy, vigorous condition, and shall rake beds areas as may be required to keep neat.

The Contractor shall maintain all <u>orass</u> areas under this Contract until accept by watering, mowing, spraying, etc. Occasional weeding may be required; however, it is anticipated that mowing will be sufficient to control weeds.

Cultivating: Shall consist of scarifying the two inches so lumps of soil are less the 2" diameter, and all weeds are removed

<u>Weeding:</u> Shall consist of digging out all plant material other than the desired shrubs and groundcovers every two weeks. Weeding may be handled by herbicide spraying at the Contractor's expense if it is acceptable to all parties

All plants shall be guaranteed by the Contractor, for a twelve (12) month perioafter date of acceptance. The Contractor shall replace all dead materials and materials not in a vigorous, thirving condition, as soon as weather permits and notification by the Landscape Architect. Plants, including trees, which have partially died so that shape, size, or symmetry have been damaged, shall be considered subject to replacement. In such cases, the opinion of the Landscape

Plants used for replacement shall be of the same kind of size as those originally planted, and shall be planted as originally specified, replacements shall carry a twelve (12) month guarantee from date of replacement. Any demage, including runs in lawn and bed areas, incurred in making replacements shall be

The Owner agrees for the guarantee to be effective, he will water plants at least twice a week during dry periods and cultivate beds once a month after final

To insure that proper maintenance is being performed by the Owner during the guarantee period, the Contractor shall:

- Make at least one site inspection every month to ascertain any
- maintenance deficiencies.

  Inform Owner's maintenance supervisor of any maintenance deficiencies.

  Prepare written documentation of the site inspection noting all deficiencies concurrent, maintenance personnel who are made aware of deficiencies, suggested remedy methods, and any other pertinent comments on
- maintenance.
  Submit this written documentation of the monthly inspection to the iscape Architect as well as to the Owner.

The Above guarantee shall not apply where plants die after acceptance because of Injury by storms, drowning from floods, hail, freeze, insects, disease, injury by humans, machines or theft. These Items are to be negotiated between the Owner and Contractor.

Plant material shall be delivered to the site only after the beds are prepared and are ready for planting. All shipments of nursery materials shall be thoroughly are ready for planting. All shipments of nursery materials shall be thoroughly protected from the sun and from drying winds during transit. All plants that

cannot be planted at once, after delivery to the site, shall be well protected against the possibility of drying by wind and sun. Ball of earth on 888 plants shall be kept covered with soil or other acceptable material. All plants remain properly of the Contractor until final acceptance.

Plants shall be nursery grown, healthy, vigorous, bushy, well balanced, of norma habit of growth for the species, and shall be free from disease, insect eggs and larvae. They shall have crown and roto ball sizes that meet or exceed the standards set forth in "Grades & Standards for Nursery Plants" by the AAN. The specified sizes shall be before pruning and plants shall be measured with their branches in normal position. Plants shall not be pruned prior to delivery, except upon special approval. All pruning of new trees and strubs, as directed by the Landscape Architect, shall be executed by the Contractor at no additional cost to

Trees shall be healthy, vigorous, full-branched, single leader, well shaped, and shall meet the trunk diameter, height, and spread requirements of the plant list, and meet the standards of Yardade & Standards for Nursery Plants\*. Balls shall be firm, neat, slightly tapered and well burlapped. Any tree loose in the ball or with broken ball at time of planting will be rejected. Balls shall be sized in accordance with the AAN Standards.

All shrubs and groundcovers shall be of "specimen" quality, full and bushy to the ground, and of compact growth.

All plants shall be hardy under climatic conditions similar to those in locality of the

Should the Contractor encounter soil condition that is inhospitable to nom planting, it is his responsibility to modify the soil so that the plants will thin These modifications may include providing any extra soil as may be requi

## Tree & Shrub Planting

Plant deciduous trees in tree-pit 2-0" greater in diameter than ball and at a height that assures roper drainage and vigorous growth. Plant evergreen trees in tree-pits 2-0" greater in diameter than all at a height for proper drainage and vigorous growth. Fill bottom of pit (to depth of not ball) with a mixture of soil that shall be one (1) part exat most, to one part clean sand. After settling the tree, the pit shall be backfilled with soil mix, then carefully settled by watering to prevent air pockets. Form a 4" watering ring for each tre Fertilize with Osmacote at the rate recommended by the manufacturer.

Plant shrubs in beds 8" larger than the root ball and at a height which assures proper drainage and vigorous growth. Backfill with soil mixture in the same

proportions as for tree planting. Osmacote fertilizer shall be applied at the rate


All plant beds plus an area three feet greater in diameter than the ball around each tree shall be mulched with 3° of clean organic mulch.


## Groundcover / Seasonal Color

Groundcover beds shall be excavated to a depth of 6°. Remove all stones, roots, hardpan, debris, etc., Roto-ill excavated bed to a depth of 6°. Add sufficient pantings soil (f) pant organic. I pant sand, 2 part bps soil) to raite entire bed 6° above original grade. Fertilize with Osmacote fertilizer at the rate of four pounds per 100 square feet. Add 1 lb. of bonemeal per 50 square feet, rake in top 2° of planting soil, rake smoothly. Mutch with 3° mini bank chips.


All areas to be sodded shall be raked to a depth of 2" below finished grade of seed or sod beds and raked smoothly. Areas next to sidewalks and curbs shall be graded down one inch below finish grade to allow for thickness of grass build-up. All grass areas shall be fertilized with a commercial fertilizer at the rate as recommended by grass seed supplier.


Landscape Details and Specifications

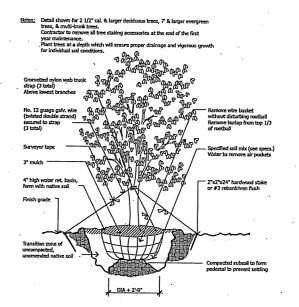

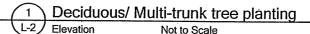

Note: Plant shrub at a depth which will ensure proper drainage and vigorous growth for individual soil conditions.

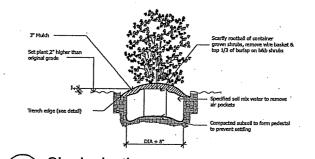


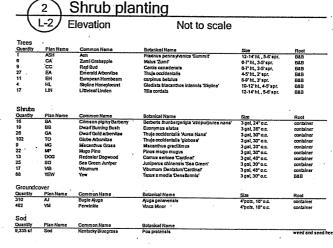


| Quantity     | Common Name        | Botanical Name          |  |
|--------------|--------------------|-------------------------|--|
| 2 az seed    | Swamp Milloweed    | As deplas incamela      |  |
| Z oz. seed " | Blue joint grass   | Clamagnostis conadensis |  |
| Z oz. seed   | Switch grass       | panicum virgatum        |  |
| 2 oz seed    | Prairie cord grass | spartina pectinata      |  |
| 2 oz, seed   | prairie phiox      | phloxpliosa             |  |
| 2 az seed    | Black eyed susay   | Rudbecida hirta         |  |
| (3)          | Plant              | List                    |  |


SGN+A and MSTSD Simonson Germany Nonemaker + Associates, Inc. Planning Architecture Landscape Architecture


MIDVALE PLAZA JOINT VENTURE

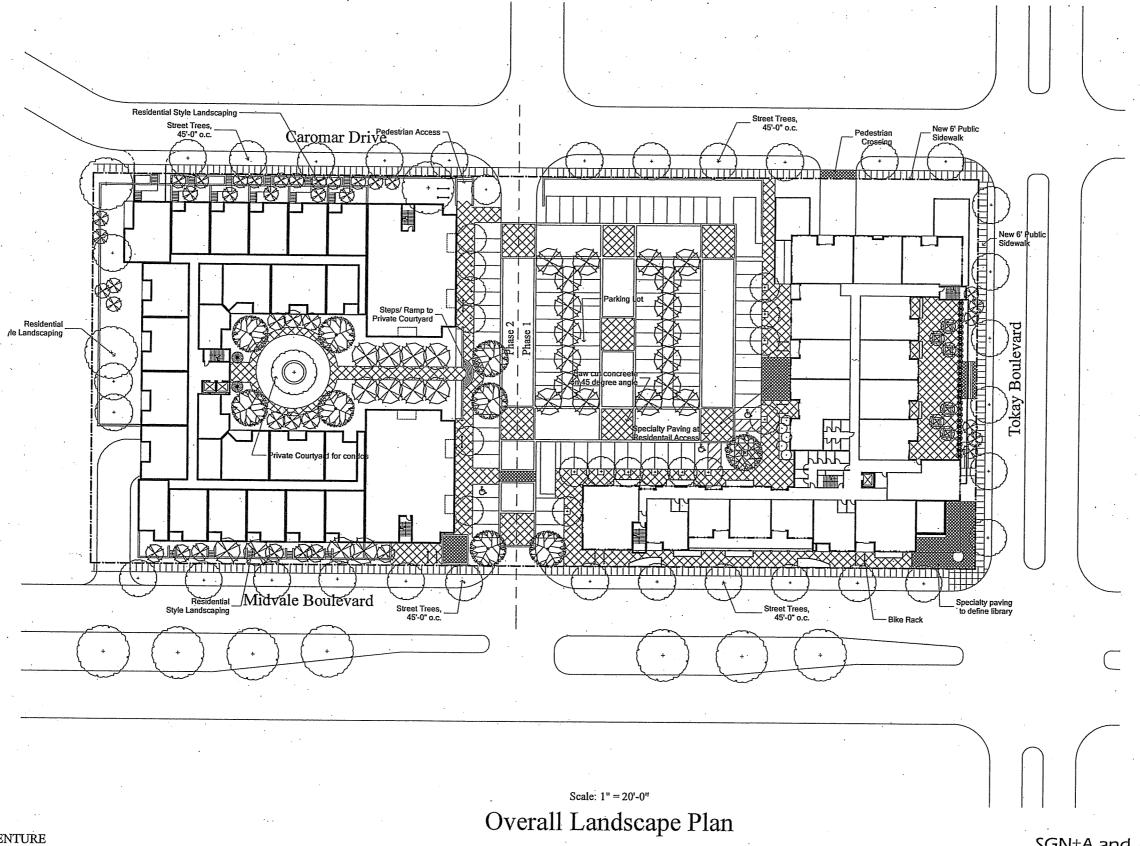


SGN+A and MSTSD Simonson Germany Nonemaker Planning Architecture Landso

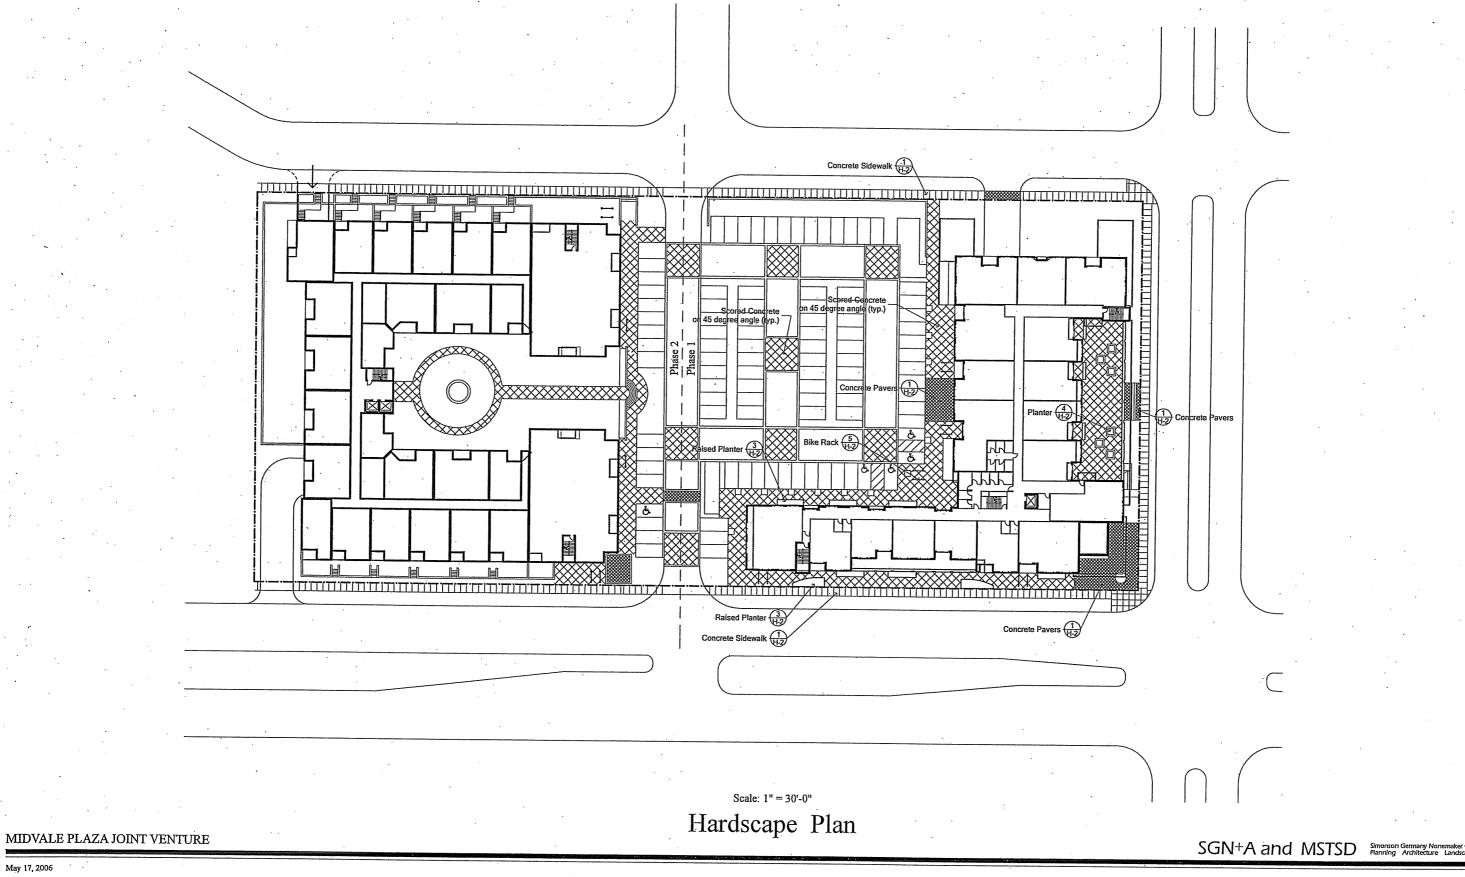


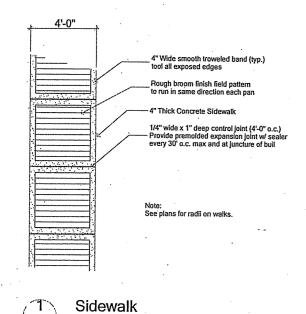


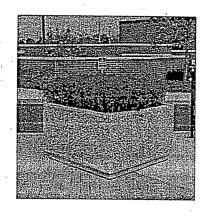





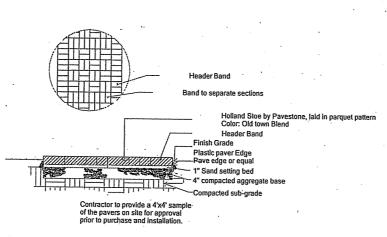

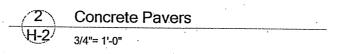

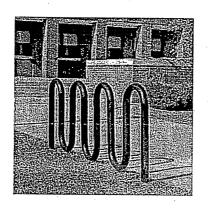

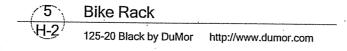

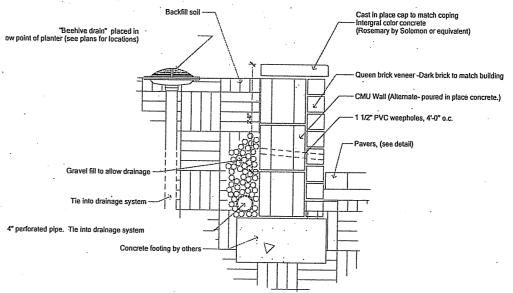




Hardscape Details

MIDVALE PLAZA JOINT VENTURE


SGN+A and MSTSD Simonson Germany Nonemake

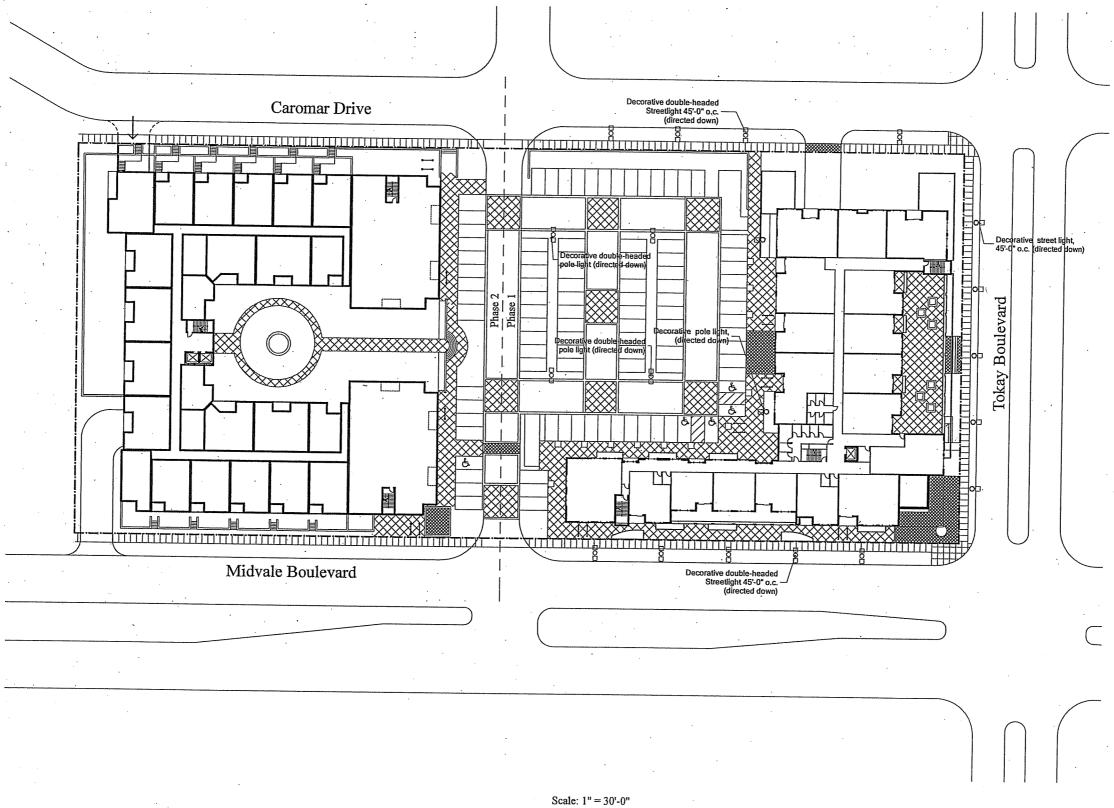


Lighting Plan

MIDVALE PLAZA JOINT VENTURE


SGN+A and MSTSD SImonson Germany Nonemaker + A Planning Architecture Landscape

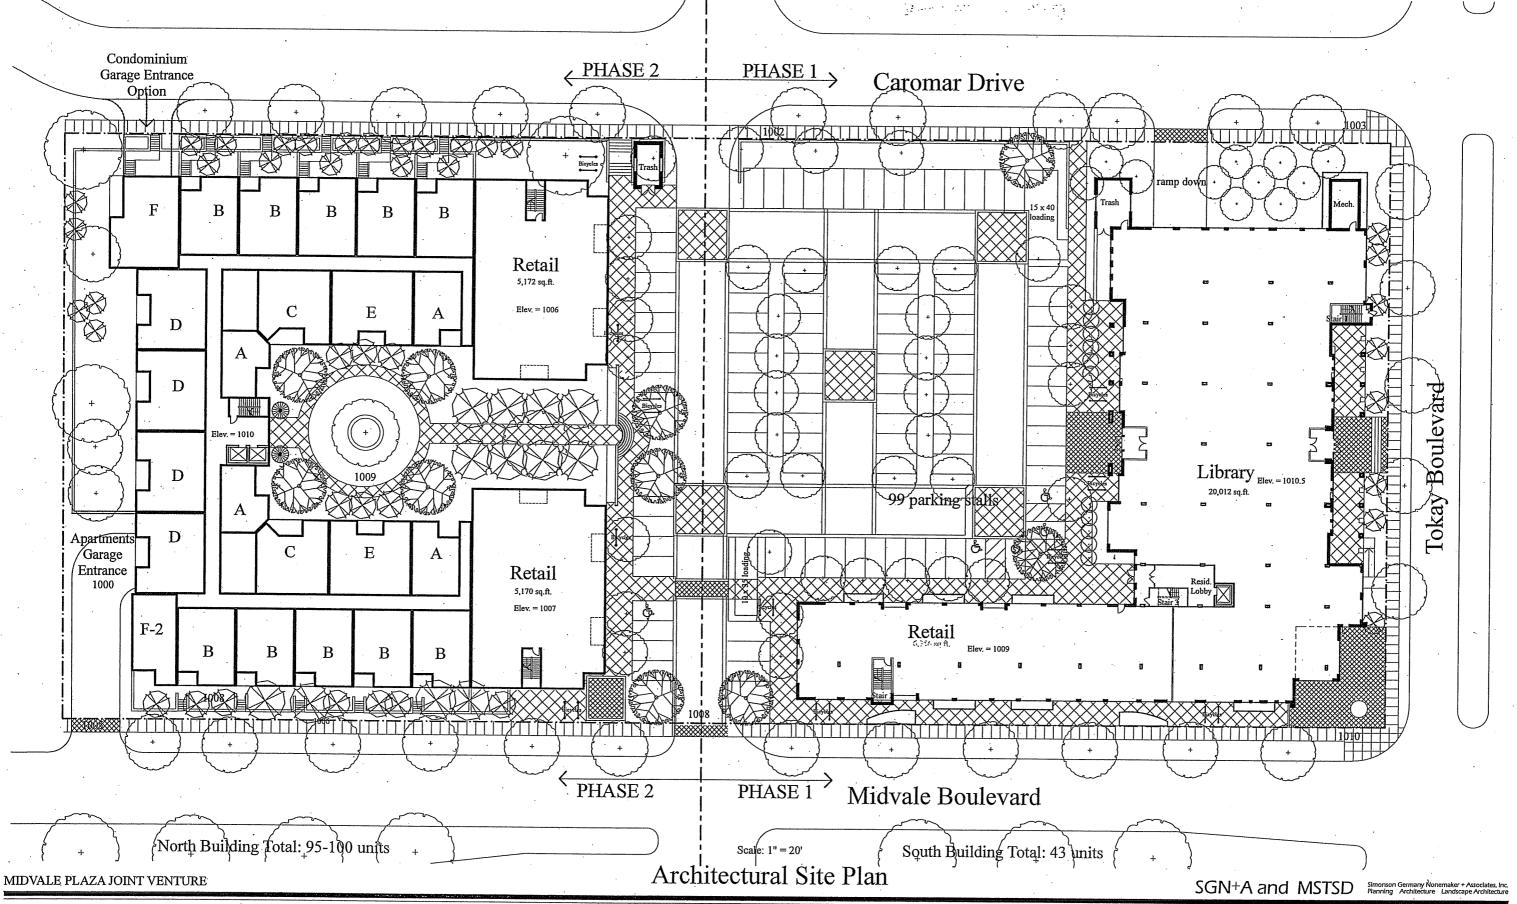


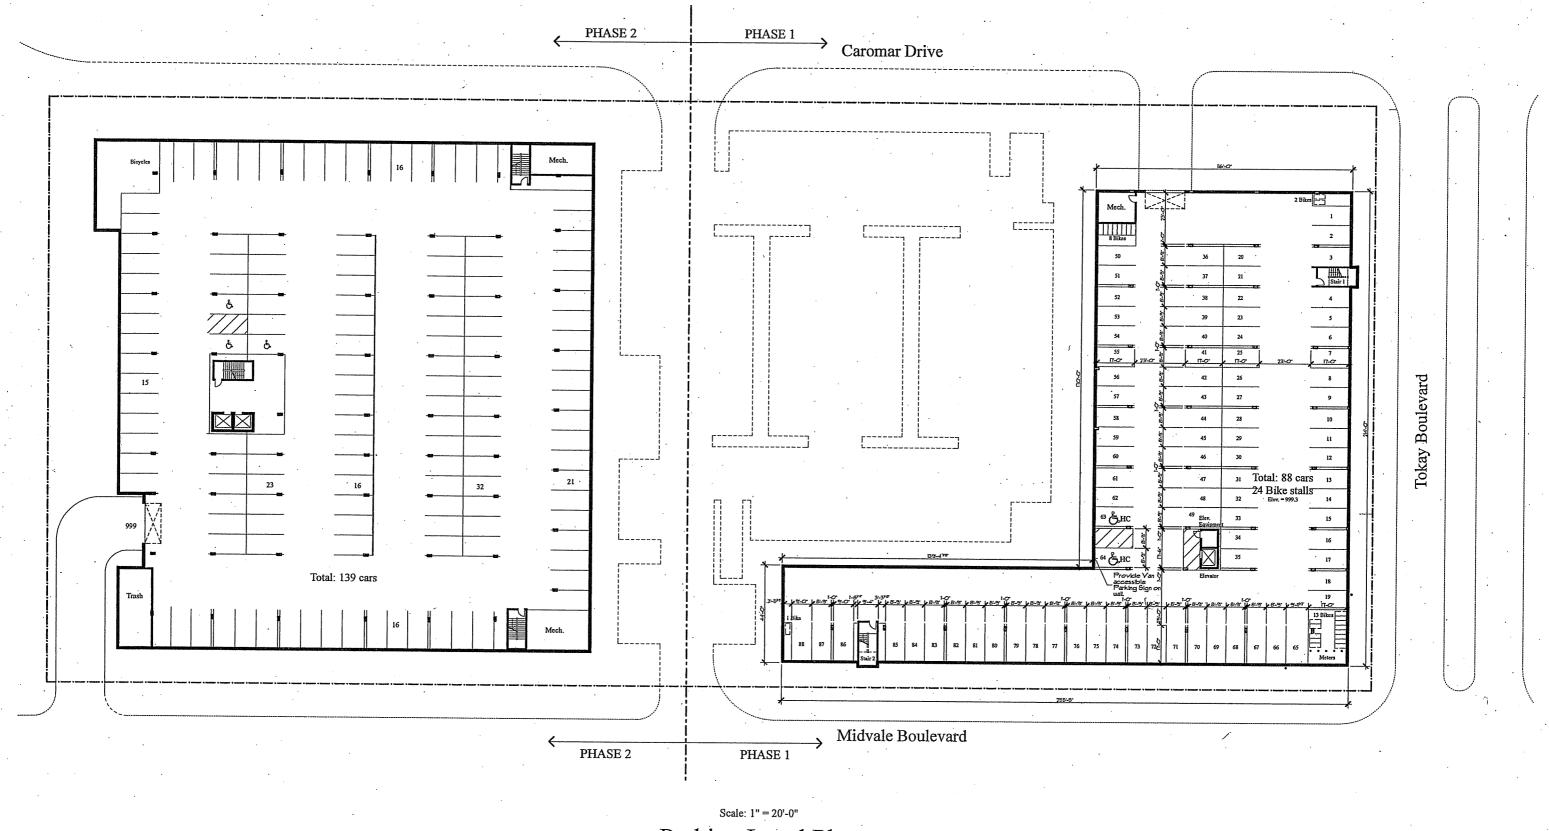



Parking Level Plan


SGN+A and MSTSD Simonson Germany Nonemaker + As Planning Architecture Landscape.

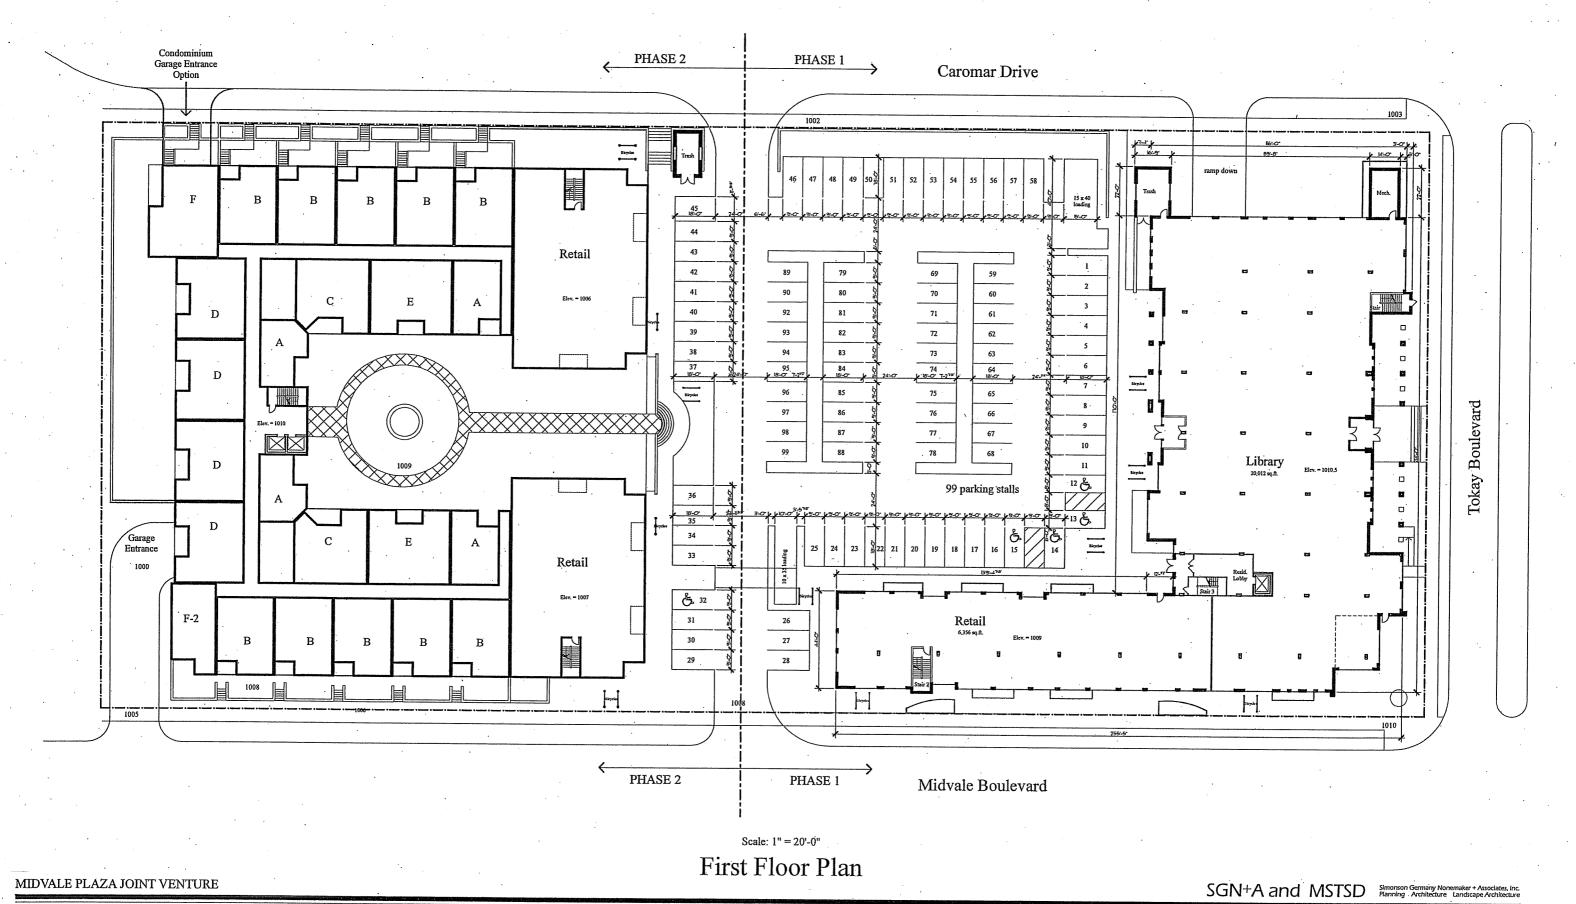


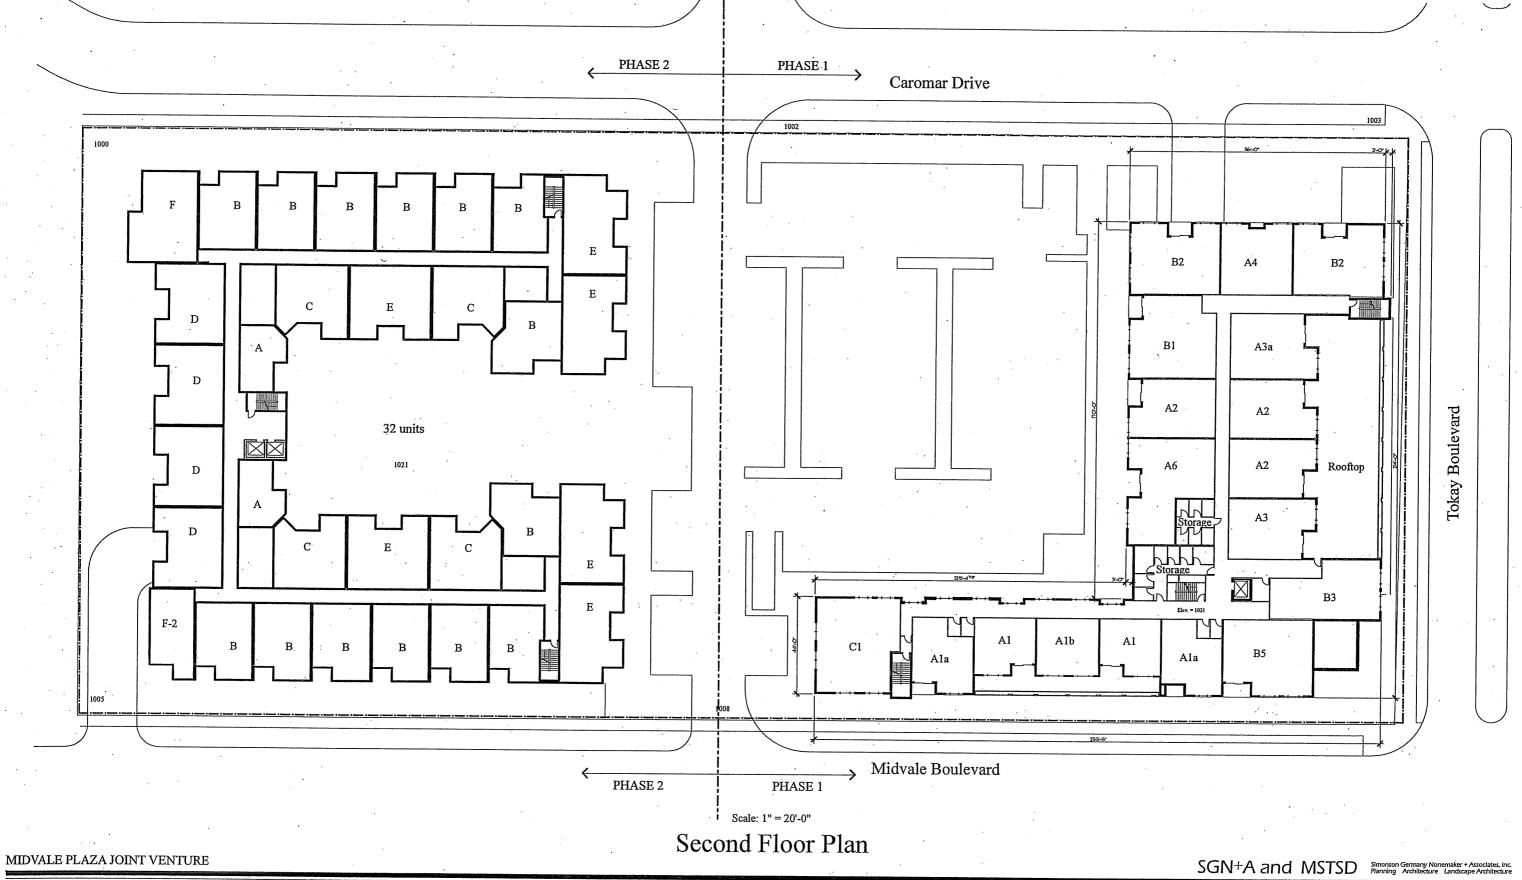

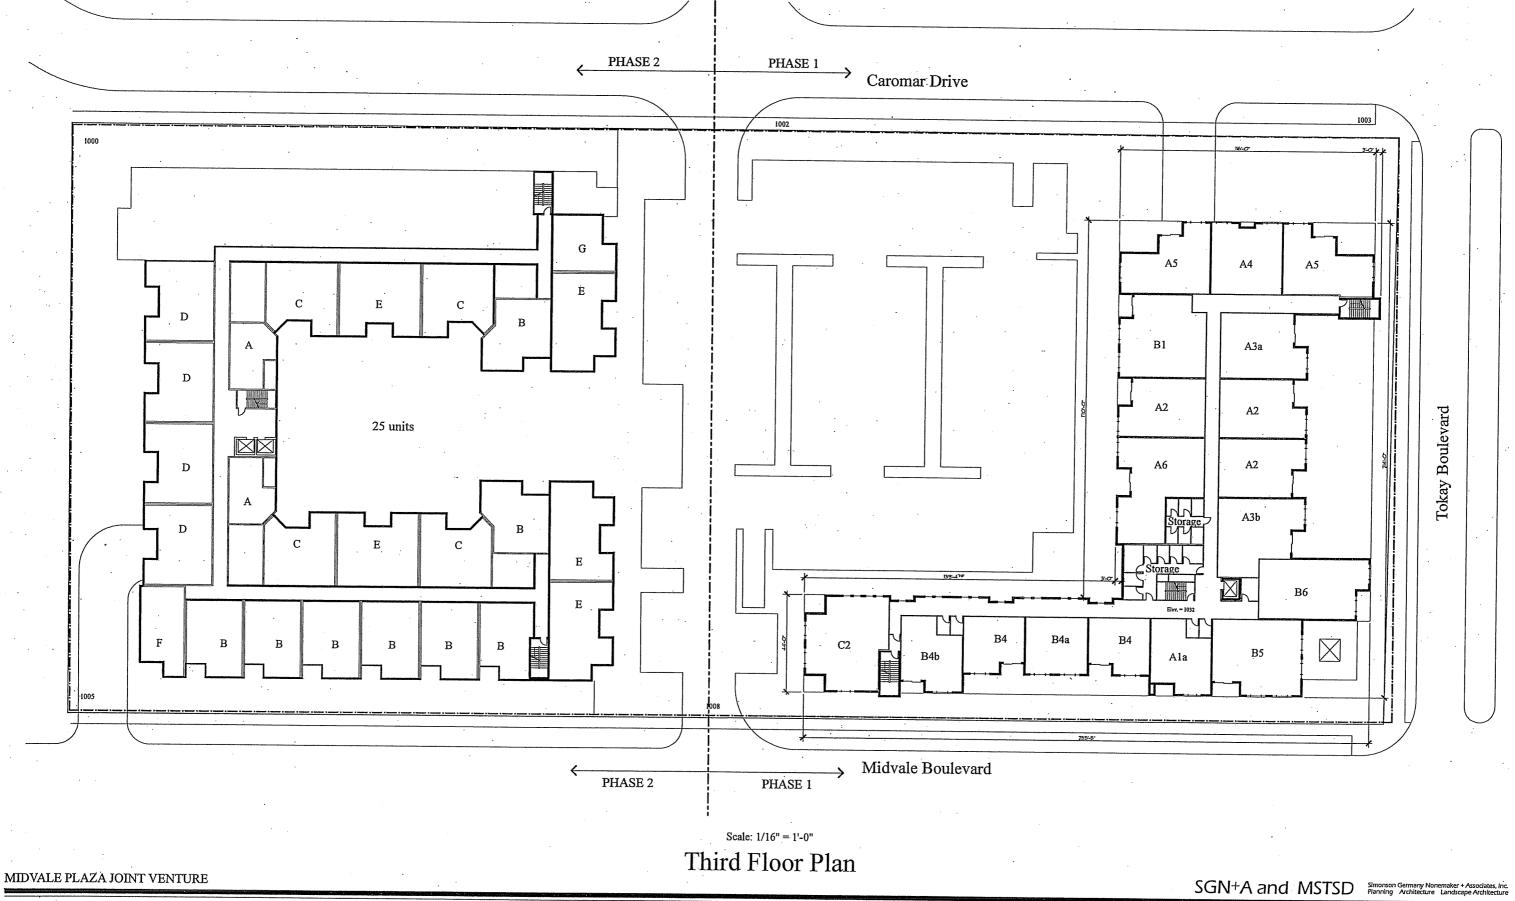

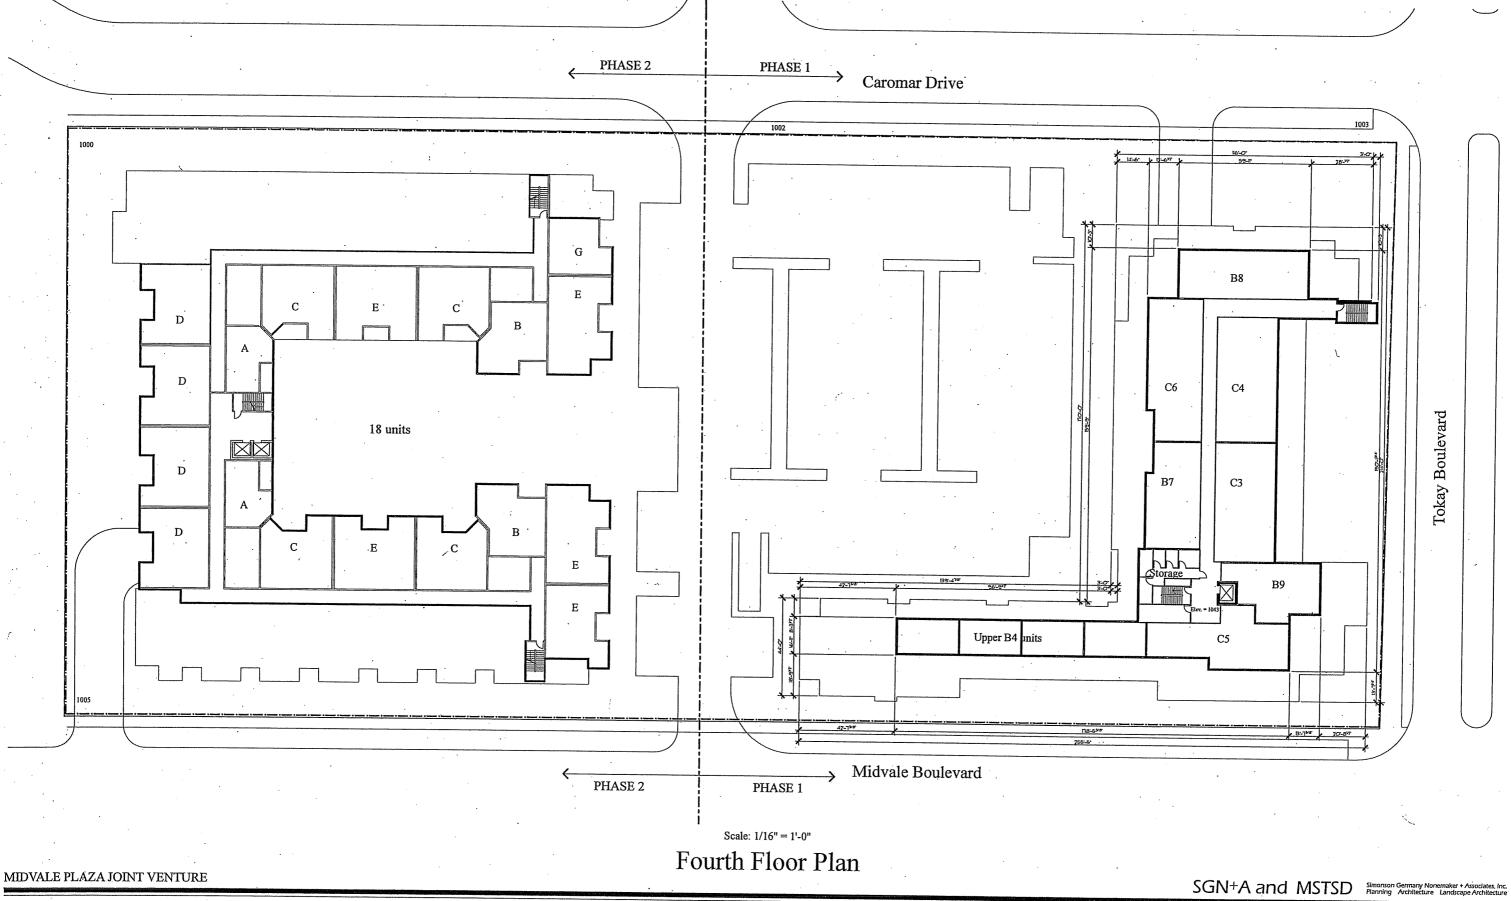

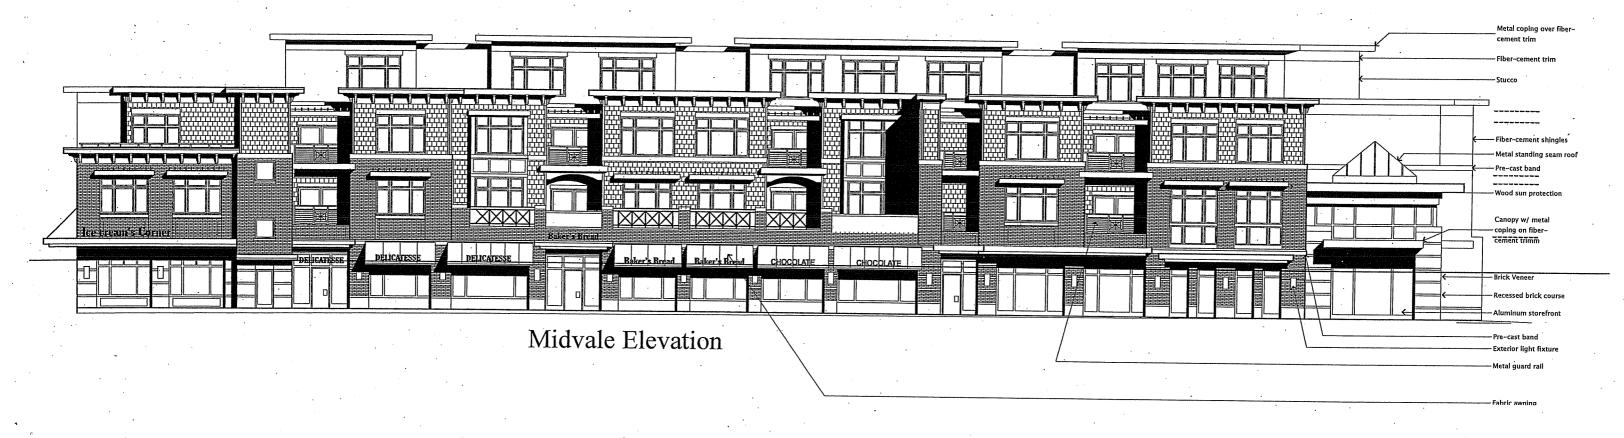

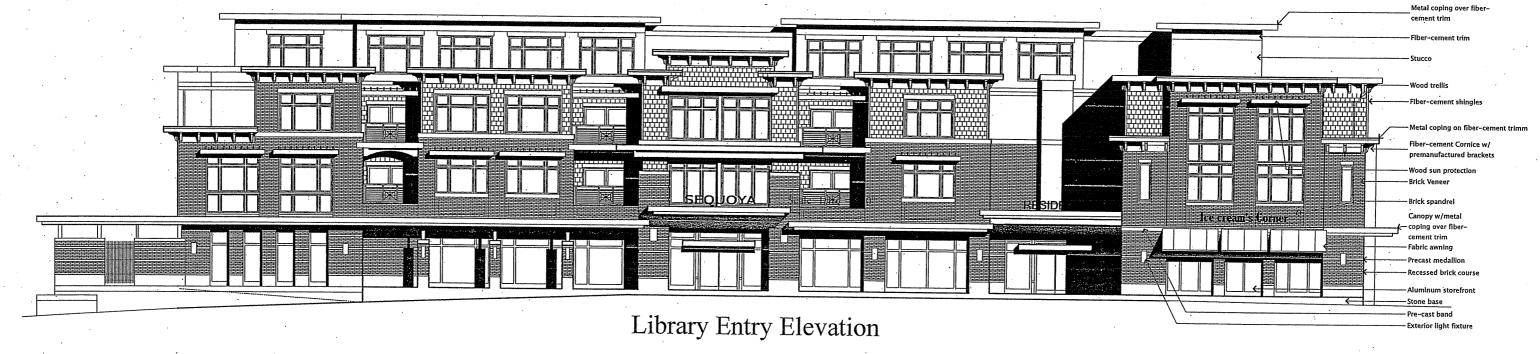

Scale: 1/8" = 1'-0"

**Building Elevations** 

MIDVALE PLAZA JOINT VENTURE

Midvale Plaza Redevelopment

A2.6

SGN+A and MSTSD Simonson Germany Nonemaker + Associates, Inc. Planning Architecture Landscape Architecture






Caromar Drive Elevation

Scale: 1/8" = 1'-0"


**Building Elevations** 

MIDVALE PLAZA JOINT VENTURE

SGN+A and MSTSD Simonson Germany Nonemaker + Associates, In-Flanning Architecture Landscape Architecture

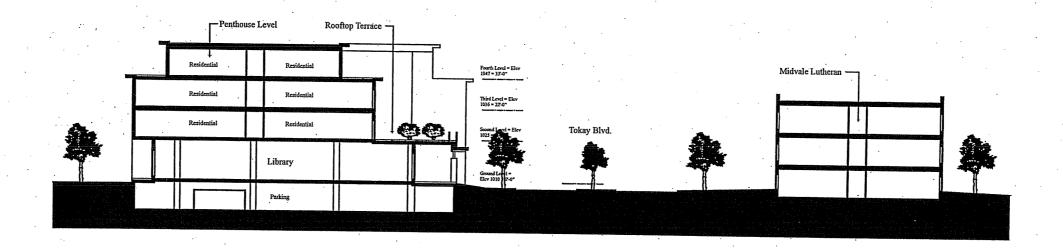

Section at Building Phase 1

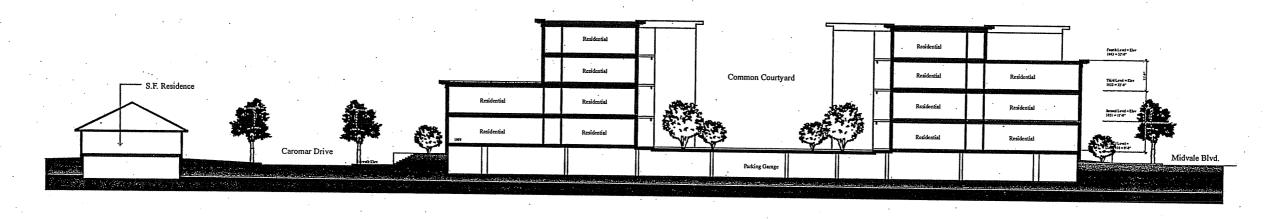

Section at Building Phase 2

1/16"=1'-0"

**Building Sections** 

MIDVALE PLAZA JOINT VENTURE

SGN+A and MSTSD Simonson Germany Nor Planning Architecture