

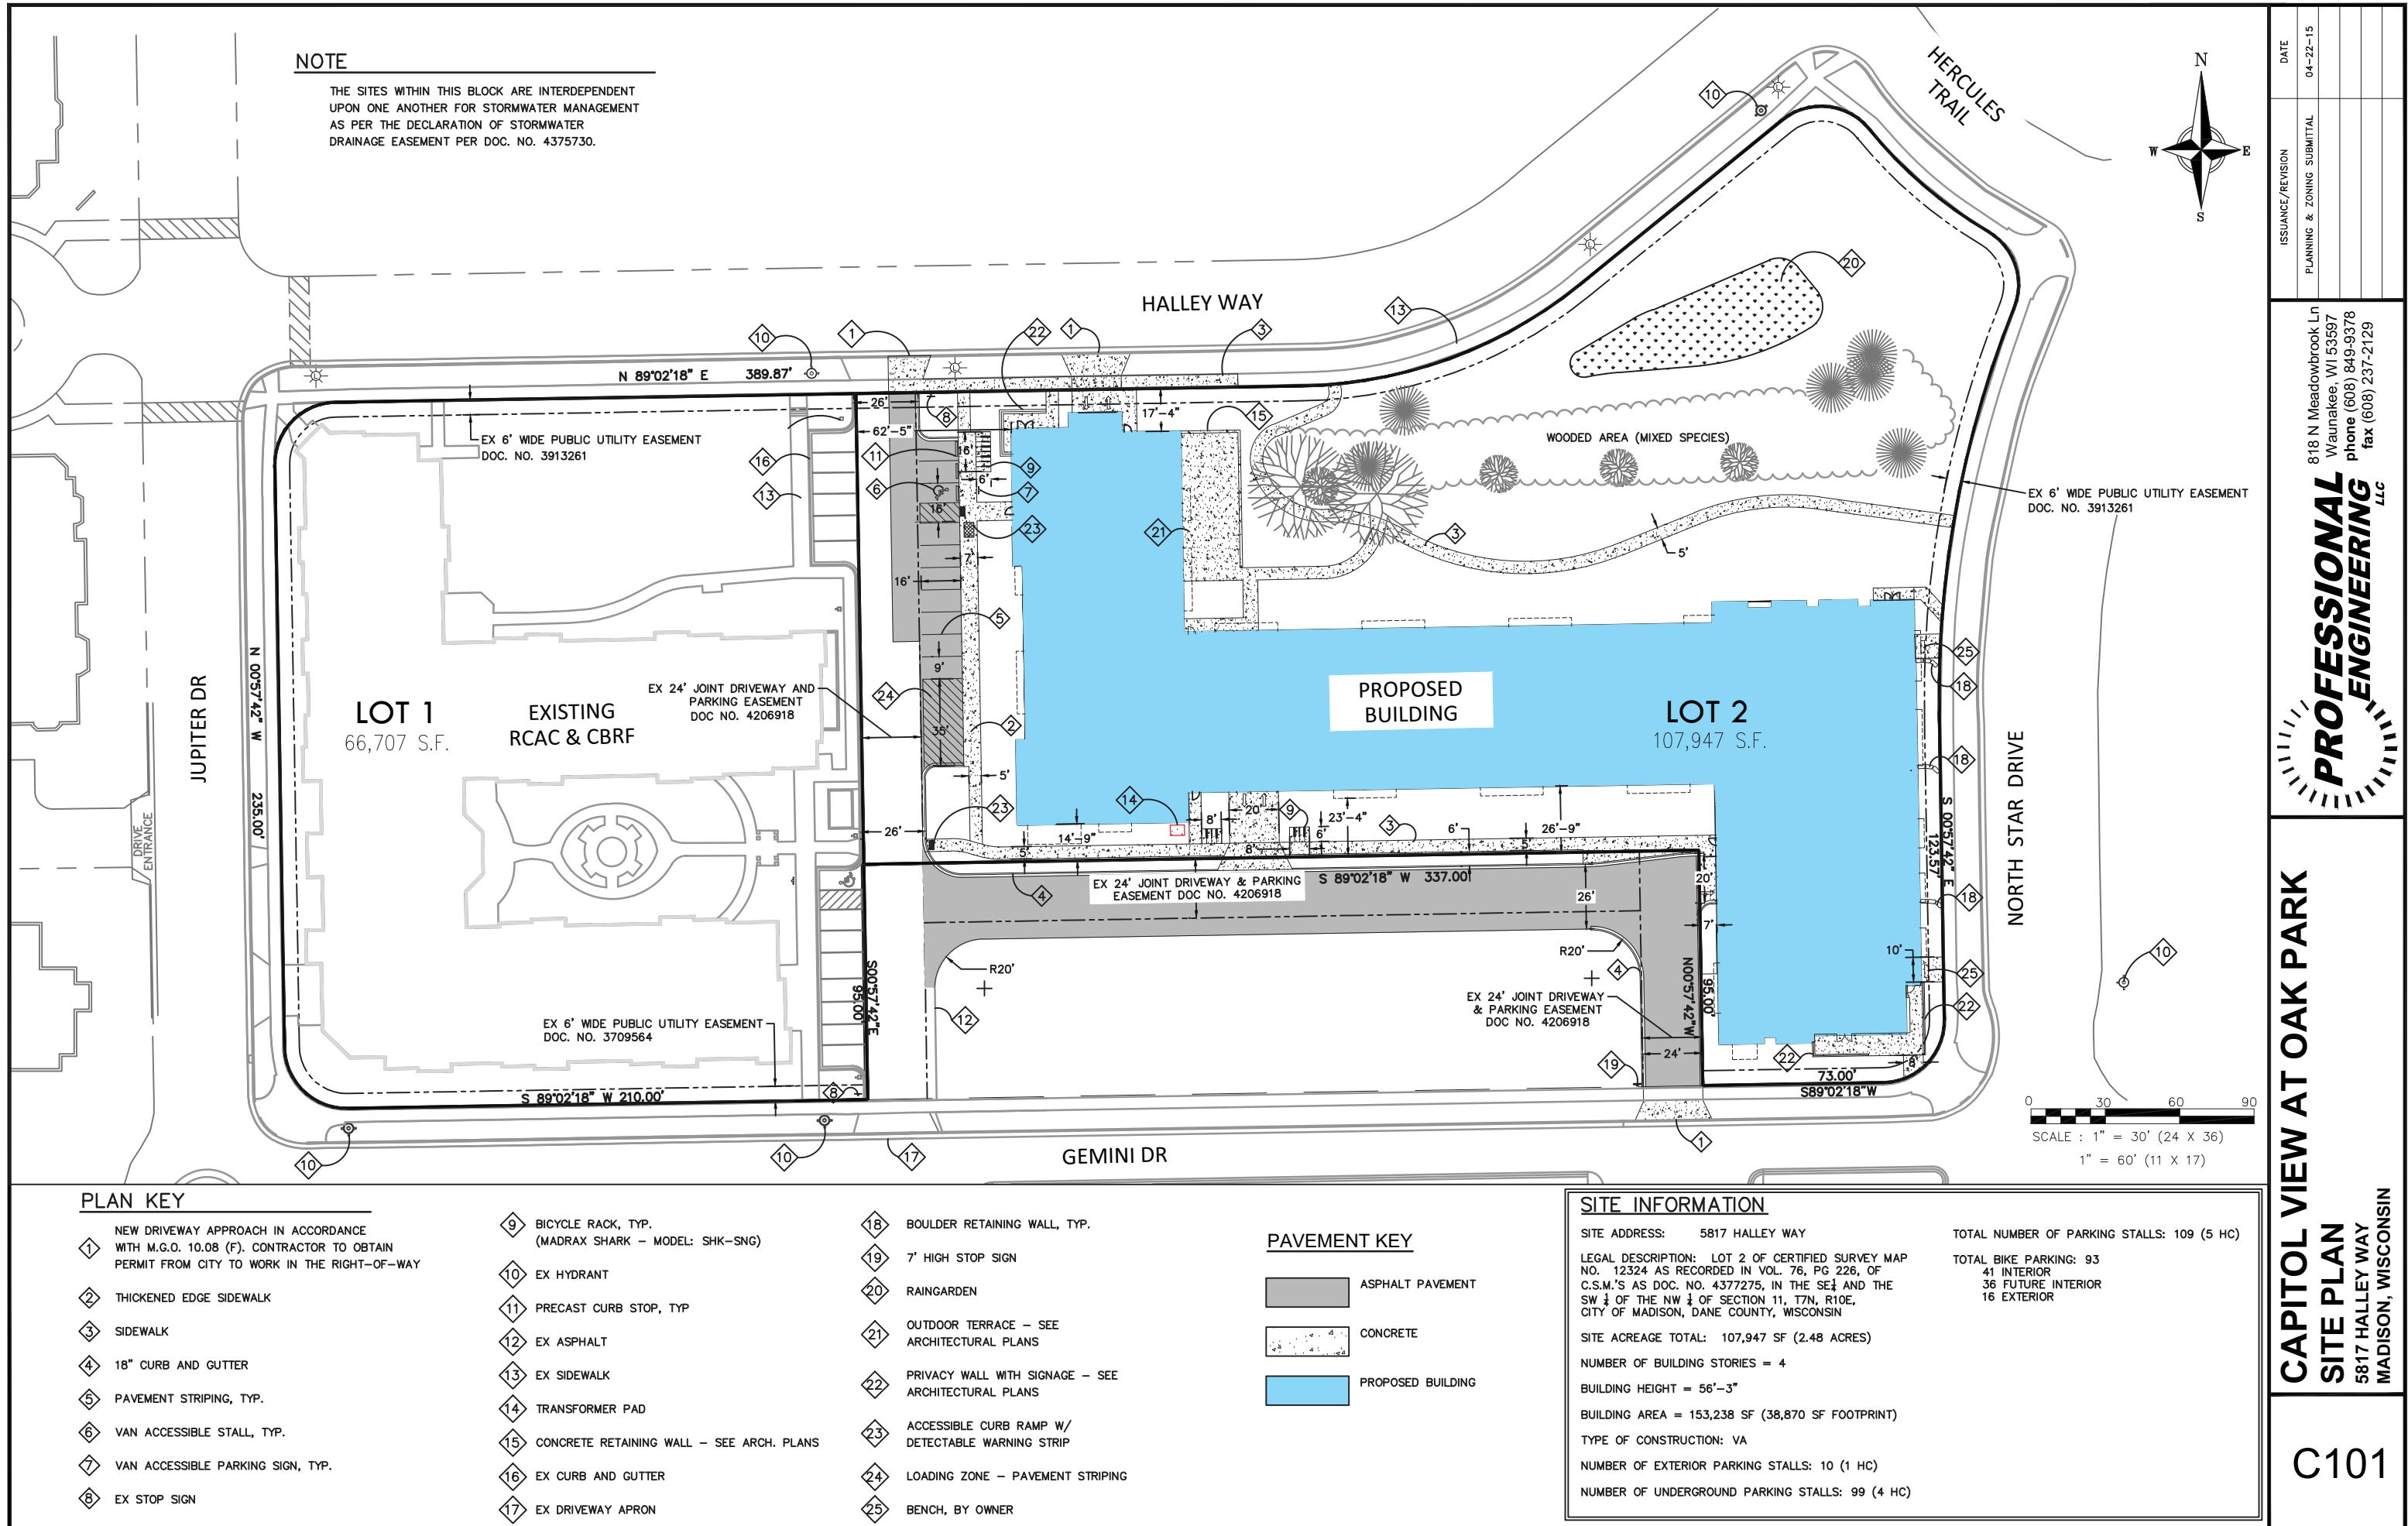


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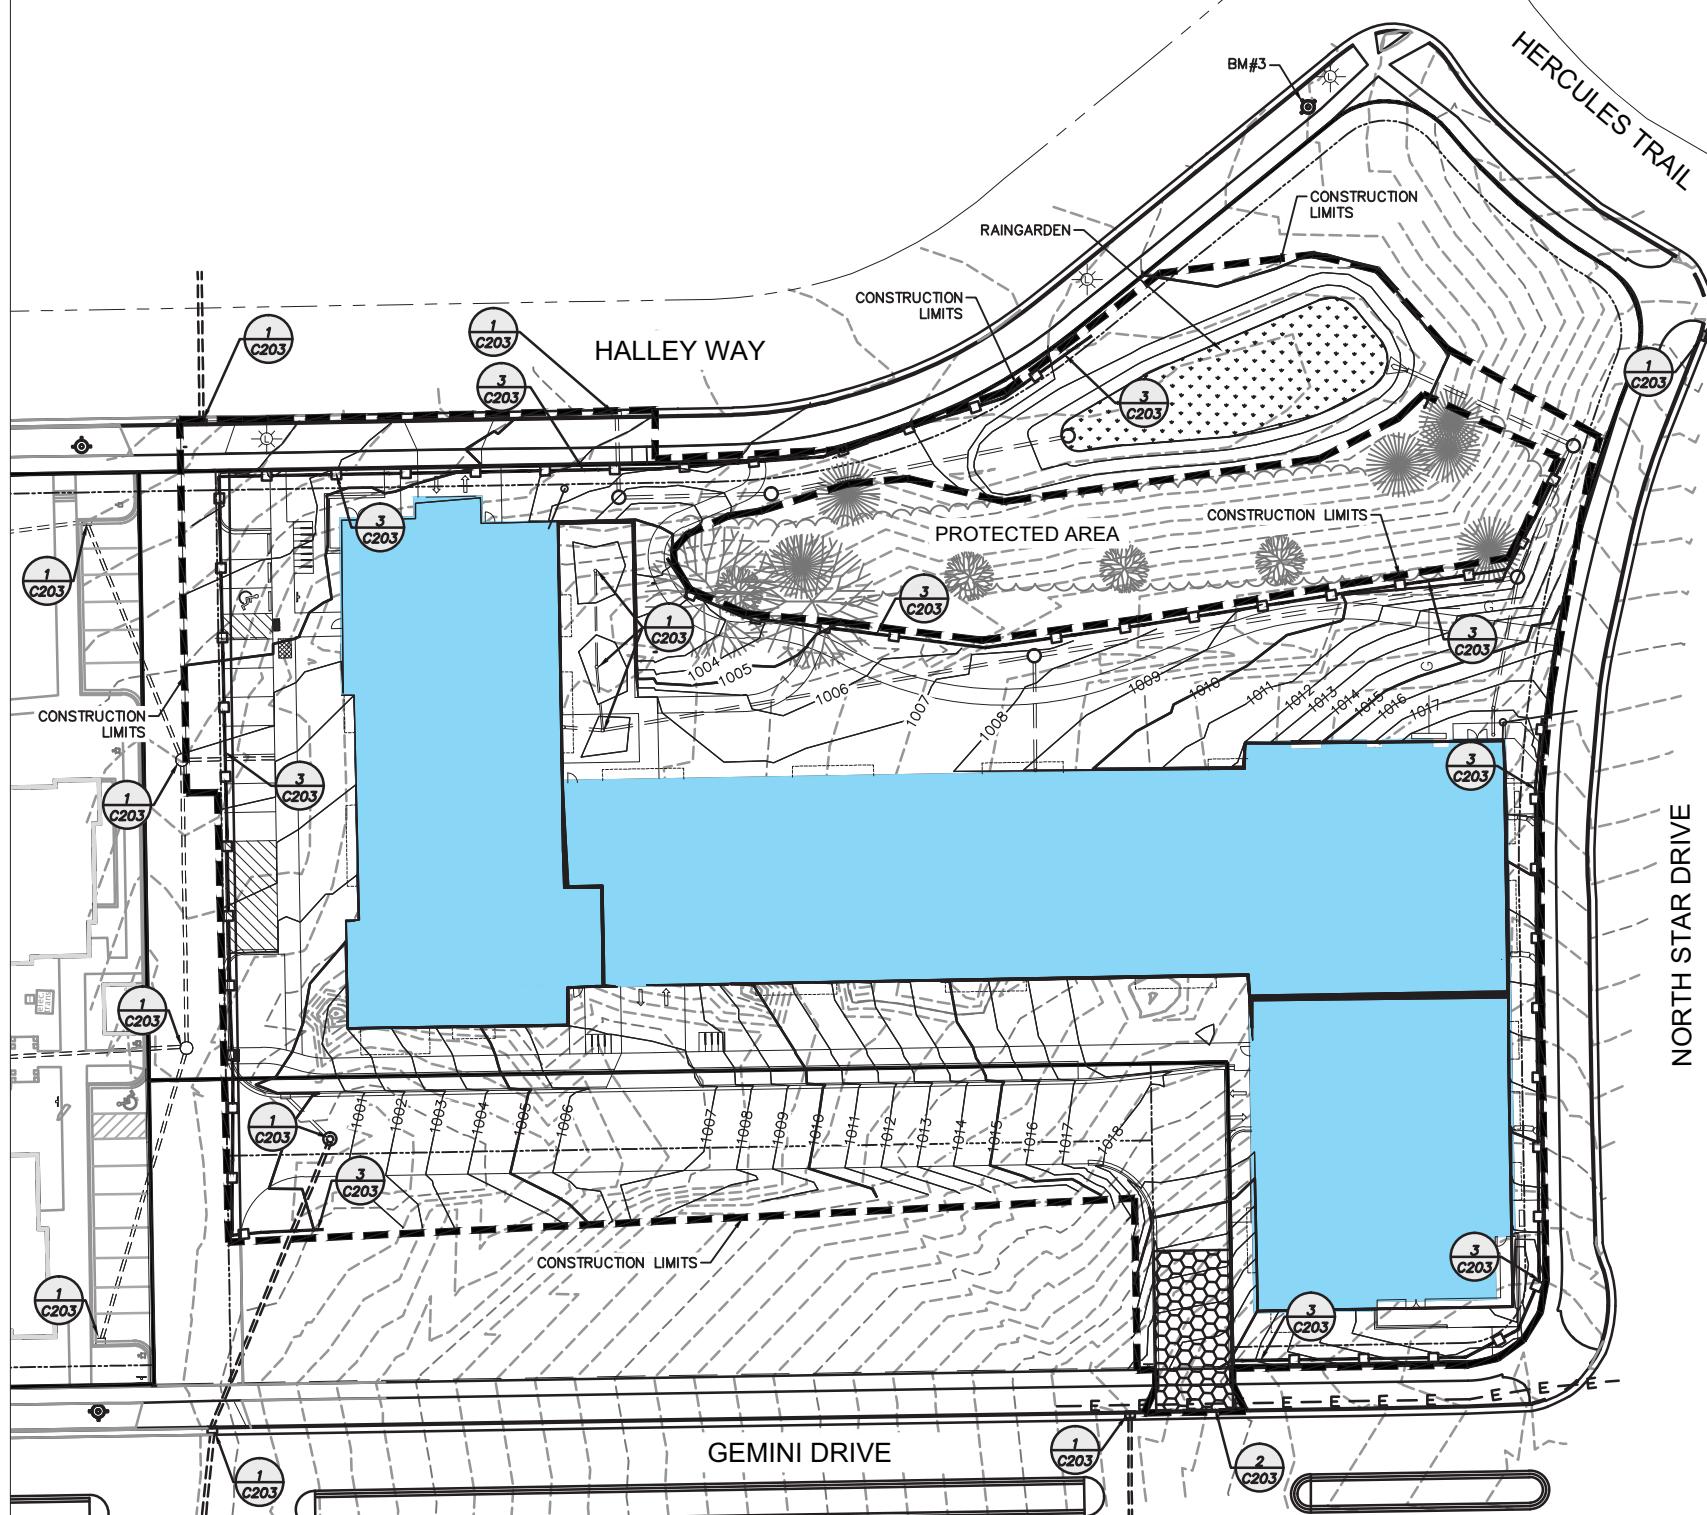
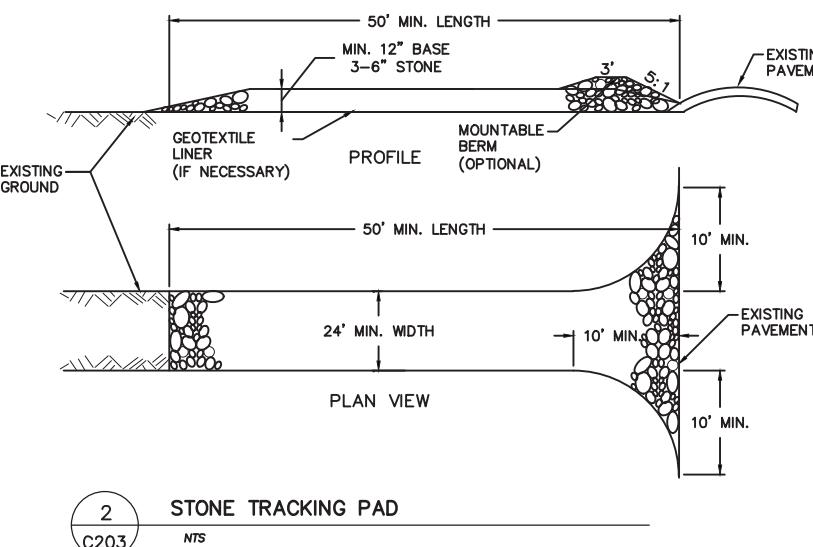
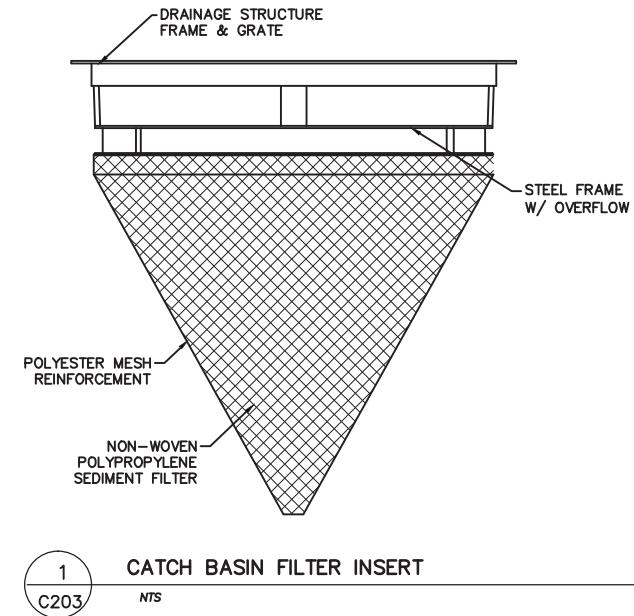


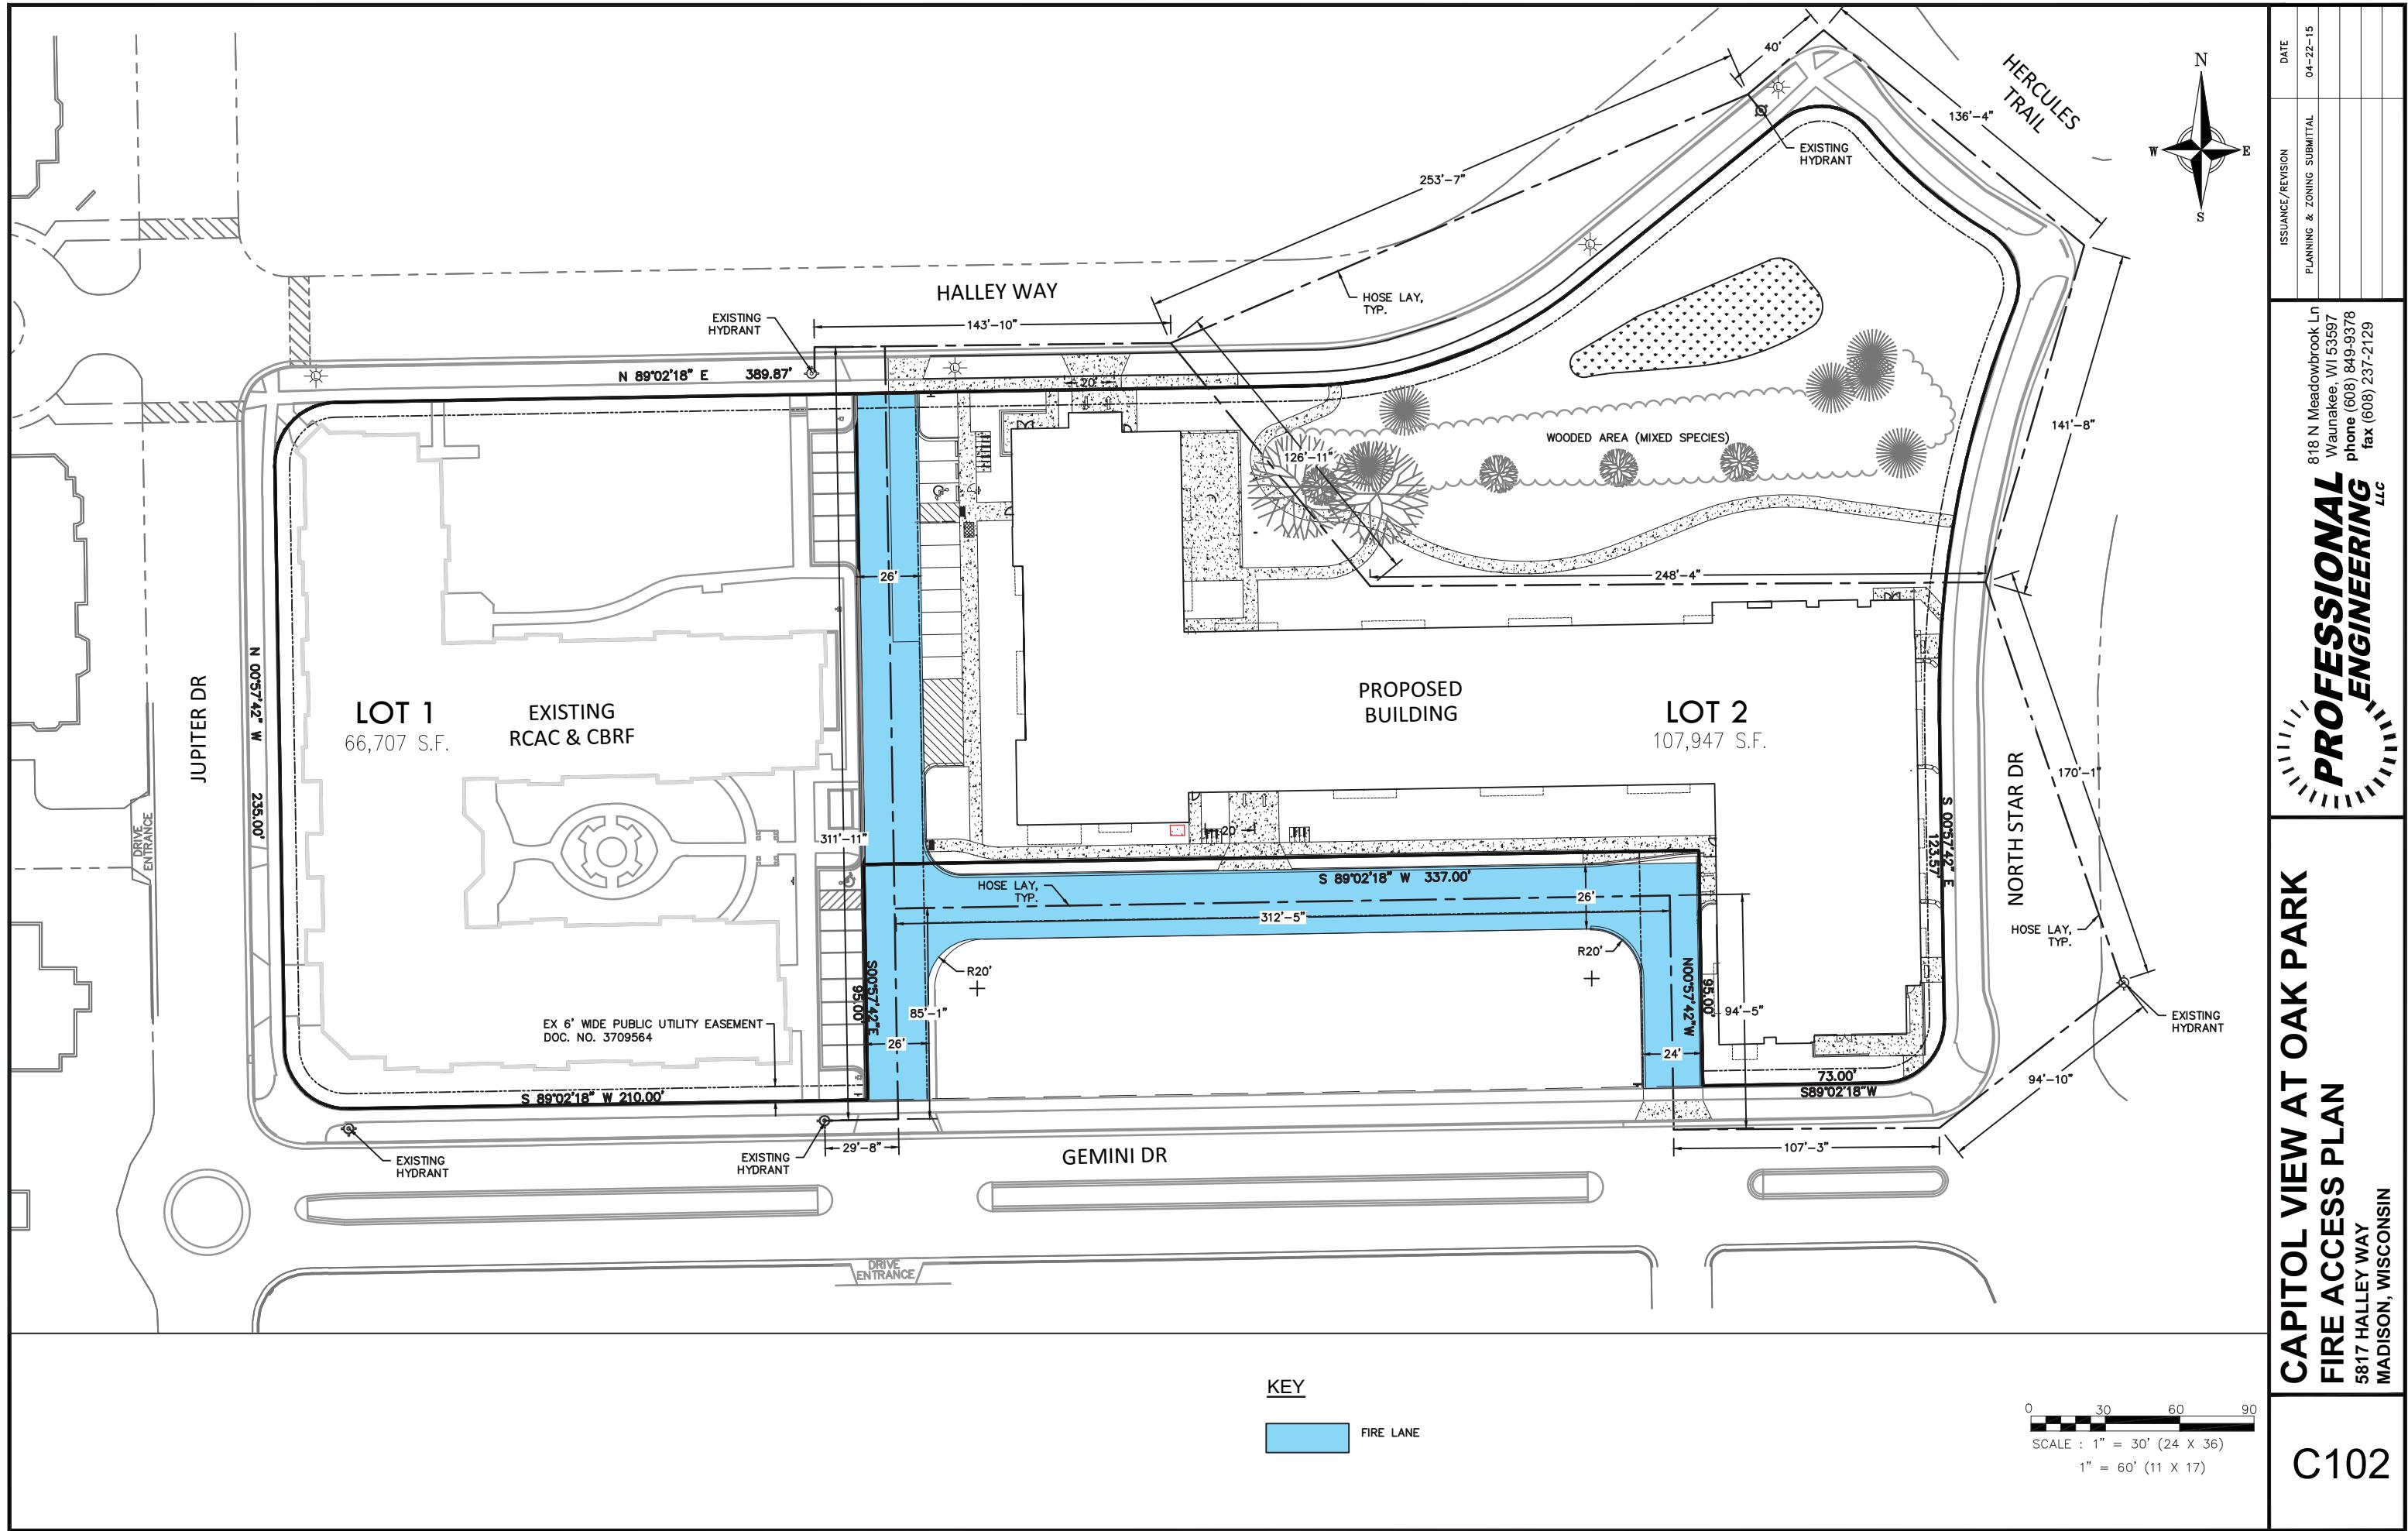

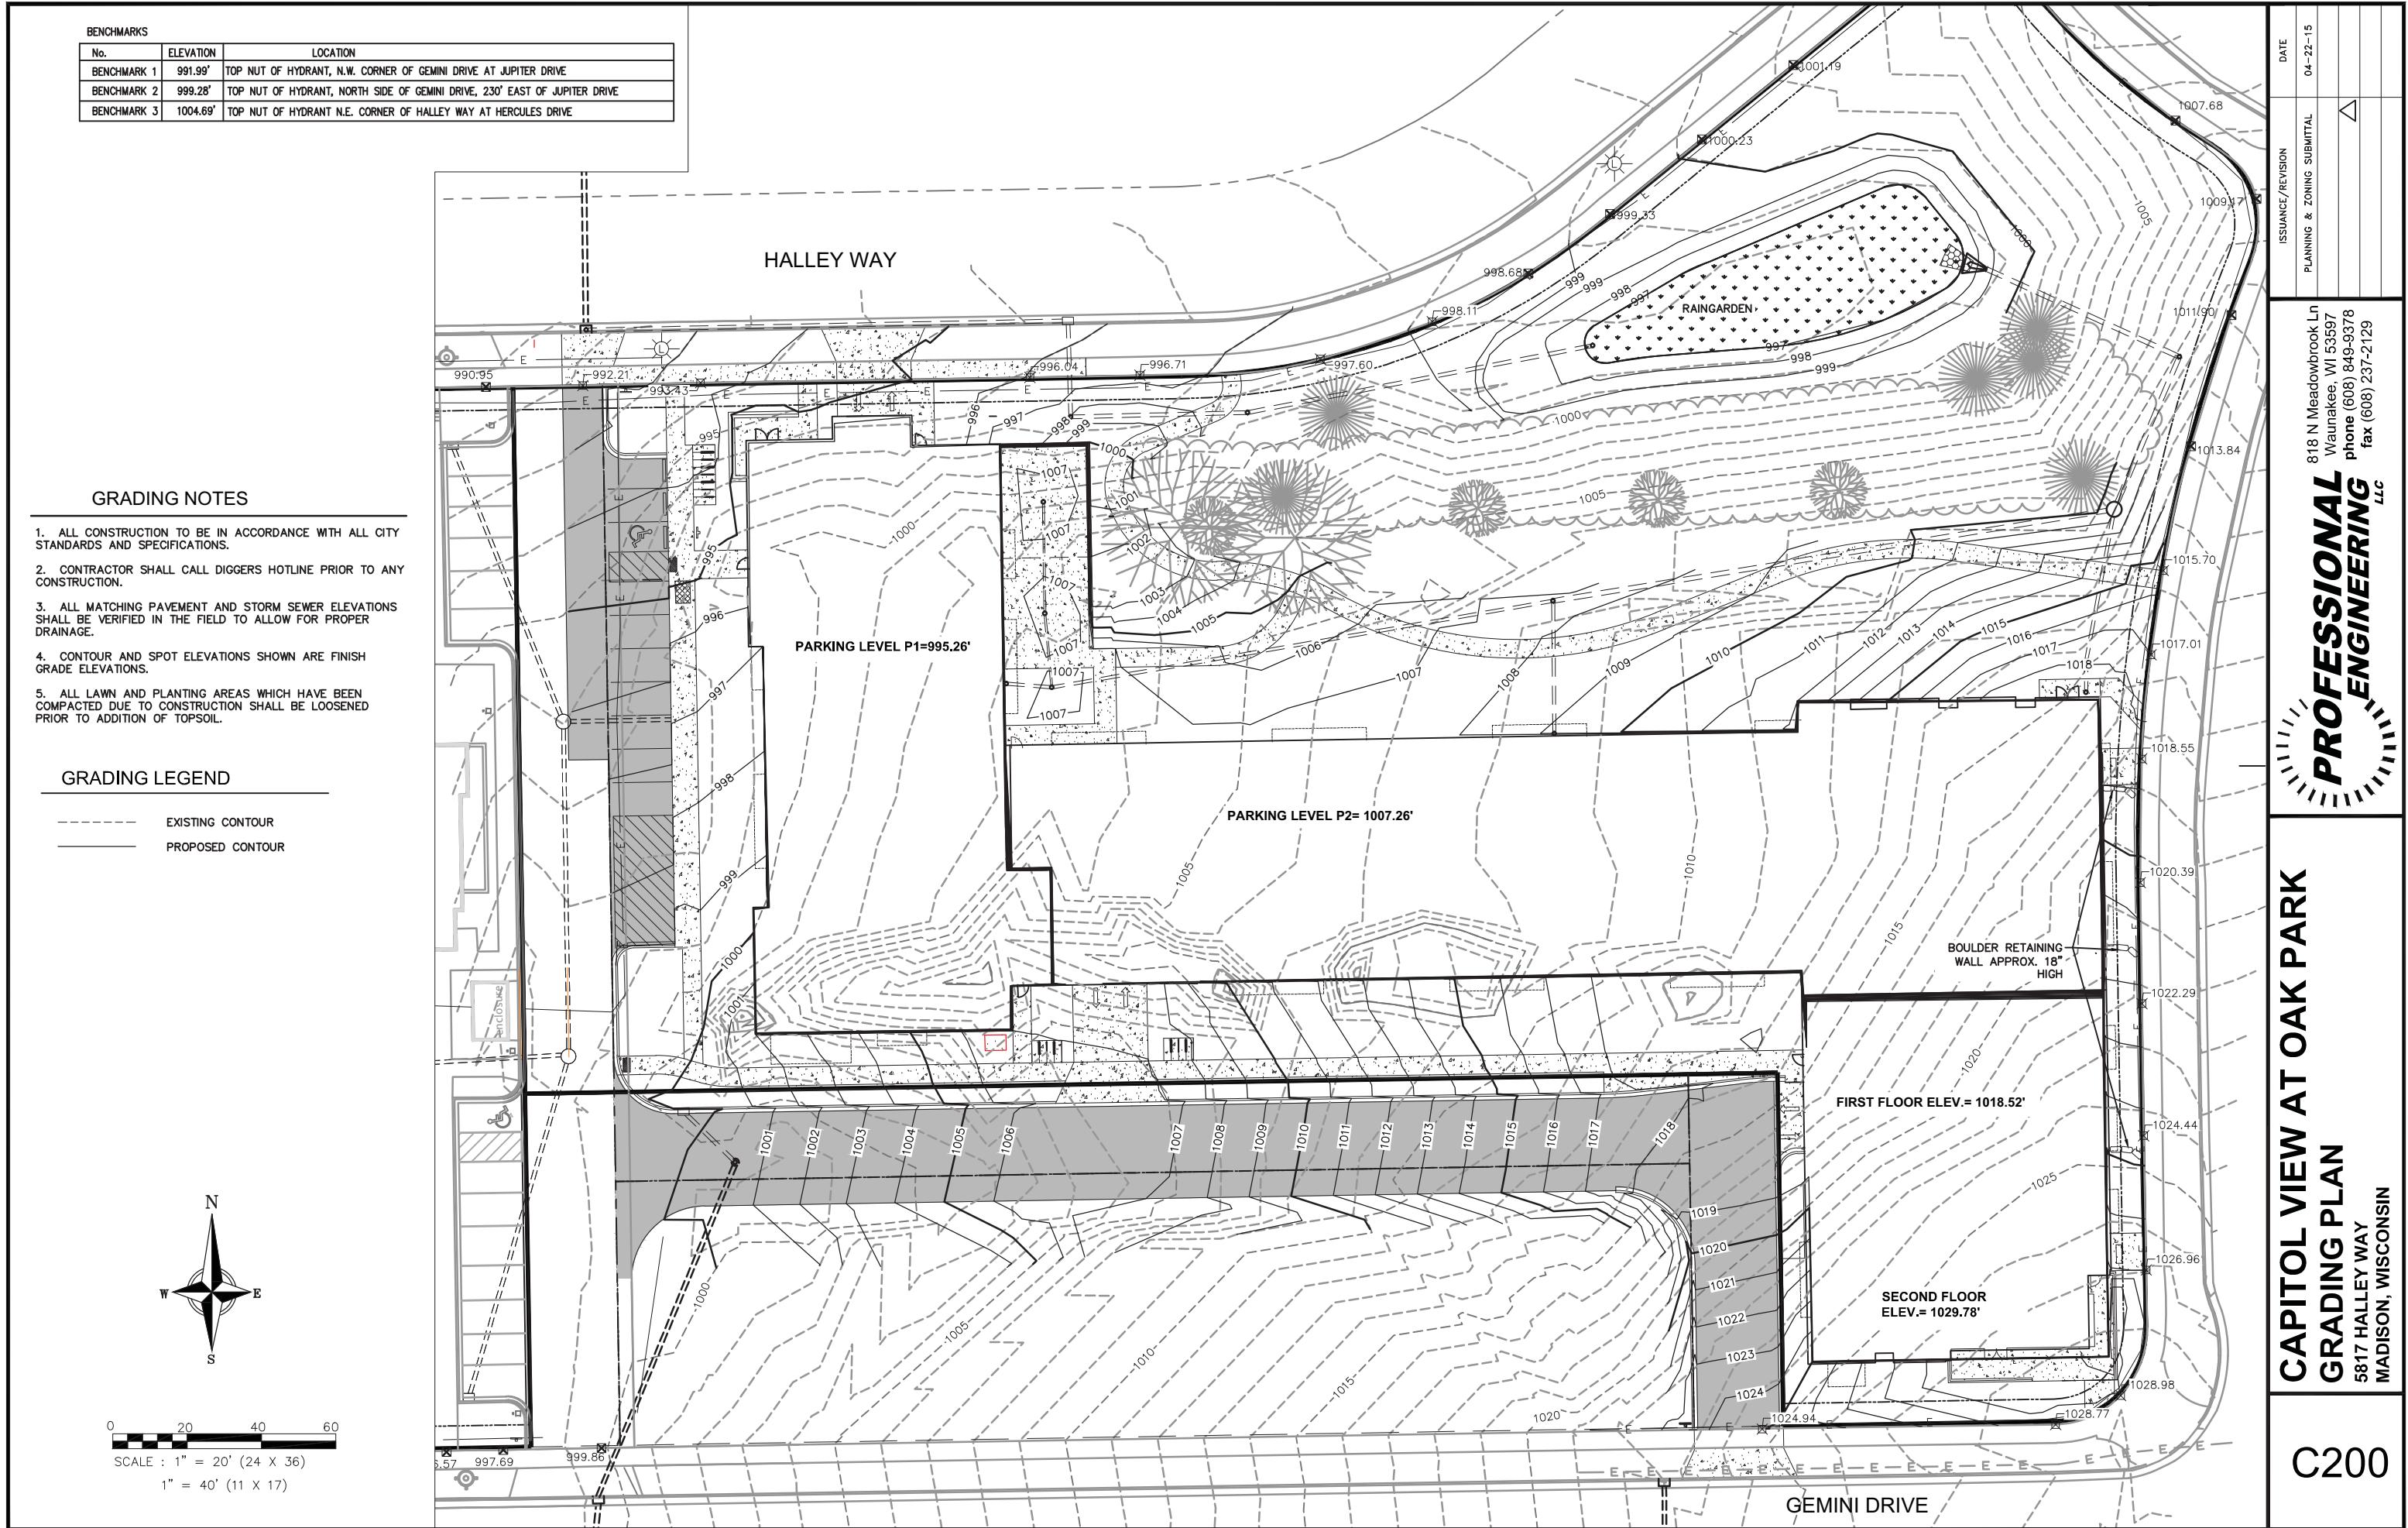

EROSION CONTROL NOTES

- (1) THE CONTRACTOR SHALL IMPLEMENT AND MAINTAIN EROSION CONTROL DEVICES FROM THE START OF LAND DISTURBING CONSTRUCTION ACTIVITIES UNTIL FINAL STABILIZATION OF THE CONSTRUCTION SITE.
- (2) ALL EROSION CONTROL MEASURES SHALL BE INSTALLED IN ACCORDANCE WITH THE CITY EROSION CONTROL AND STORMWATER ORDINANCE AND THE DANE COUNTY EROSION CONTROL AND STORMWATER MANAGEMENT MANUAL. THE CITY RESERVES THE RIGHT TO REQUIRE ADDITIONAL EROSION CONTROL MEASURES AS CONDITIONS WARRANT.
- (3) CLEANING. RIGHT-OF-WAY SURFACES SHALL BE THOROUGHLY CLEANED BEFORE THE END OF EACH WORKING DAY.
- (4) RESTORATION. RESTORATION SHALL BE COMPLETED AS NOTED IN THE CONSTRUCTION SCHEDULE UNLESS OTHERWISE AUTHORIZED BY THE CITY.
- (5) INSPECTION. THE CONTRACTOR SHALL INSPECT EROSION AND SEDIMENT CONTROL PRACTICES WEEKLY, AND WITHIN 24 HOURS FOLLOWING A RAINFALL OF 0.5 INCHES OR GREATER. DOCUMENTATION OF EACH INSPECTION SHALL BE ENTERED INTO THE CITY EROSION CONTROL PERMIT TRACKING WEBSITE AND SHALL INCLUDE THE TIME, DATE AND LOCATION OF INSPECTION, THE PHASE OF LAND DISTURBANCE AT THE CONSTRUCTION SITE, PERSON CONDUCTING THE INSPECTION, ASSESSMENT OF CONTROL PRACTICES, AND A DESCRIPTION OF ANY EROSION OR SEDIMENT CONTROL MEASURE INSTALLATION.
- (6) STONE TRACKING PAD. BEFORE BEGINNING CONSTRUCTION, CONTRACTOR SHALL INSTALL A STONE TRACKING PAD AT EACH POINT WHERE VEHICLES ENTERS/EXITS THE CONSTRUCTION SITE. STONE TRACKING PADS SHOULD BE AT LEAST 24 FEET WIDE AND 50 FEET LONG, AND CONSTRUCTED OF 3-6 INCH WASHED STONE WITH A DEPTH OF AT LEAST 12 INCHES. ON SITES WITH CLAY SOILS, STONE TRACKING PADS MUST BE UNDERLAIN WITH A GEOTEXTILE LINER TO PREVENT THE STONE FROM SINKING INTO THE SOIL.
- (7) INLET PROTECTION. ALL INLETS SUBJECT TO DRAINAGE SHALL BE PROTECTED WITH WISCONSIN DOT TYPE B INLET PROTECTION. ANY DEPOSITS OF DIRT, MUD, ROCK, DEBRIS, OR OTHER MATERIAL ENTERING THE STORM SEWER SYSTEM SHALL BE PROMPTLY AND THOROUGHLY CLEARED OUT.
- (8) EROSION MAT. AREAS OR EMBANKMENTS HAVING SLOPES GREATER THAN OR EQUAL TO 4H:1V SHALL BE STABILIZED WITH WISCONSIN DOT CLASS 1, URBAN, TYPE B, EROSION MAT.
- (9) TEMPORARY EROSION CONTROL. ALL TEMPORARY EROSION AND SEDIMENT CONTROL MEASURES SHALL BE REMOVED WITHIN 30 DAYS AFTER FINAL SITE STABILIZATION IS ACHIEVED OR AFTER THE TEMPORARY MEASURES ARE NO LONGER NEEDED.
- (10) STABILIZATION. ALL DISTURBED AREAS SHALL BE SEADED & MULCHED AS SPECIFIED WITHIN 14 WORKING DAYS OF FINAL GRADING.
- (11) TOPSOIL. A MINIMUM OF 4 INCHES OF TOPSOIL MUST BE APPLIED TO ALL AREAS TO BE SEADED OR SODDED.
- (12) SEEDING. REFER TO LANDSCAPING PLANS FOR MIXTURE AND APPLICATION REQUIREMENTS.
- (13) STOCKPILES. ANY SOIL STOCKPILED THAT REMAINS FOR MORE THAN 30 DAYS SHALL BE COVERED OR TREATED WITH STABILIZATION PRACTICES SUCH AS TEMPORARY OR PERMANENT SEEDING AND MULCHING.



CAPITOL VIEW AT OAK PARK
EROSION CONTROL PLAN
5817 HALLEY WAY
MADISON, WISCONSIN

C203


**PROFESSIONAL
ENGINEERING**
LLC

ISSUANCE & ZONING SUBMITTAL	DATE 04-22-15
PLANNING	

818 N Meadowbrook Ln
Waunakee, WI 53597
phone (608) 849-9378
fax (608) 237-2129

0 30 60 90
SCALE : 1" = 30' (24 X 36)
1" = 60' (11 X 17)



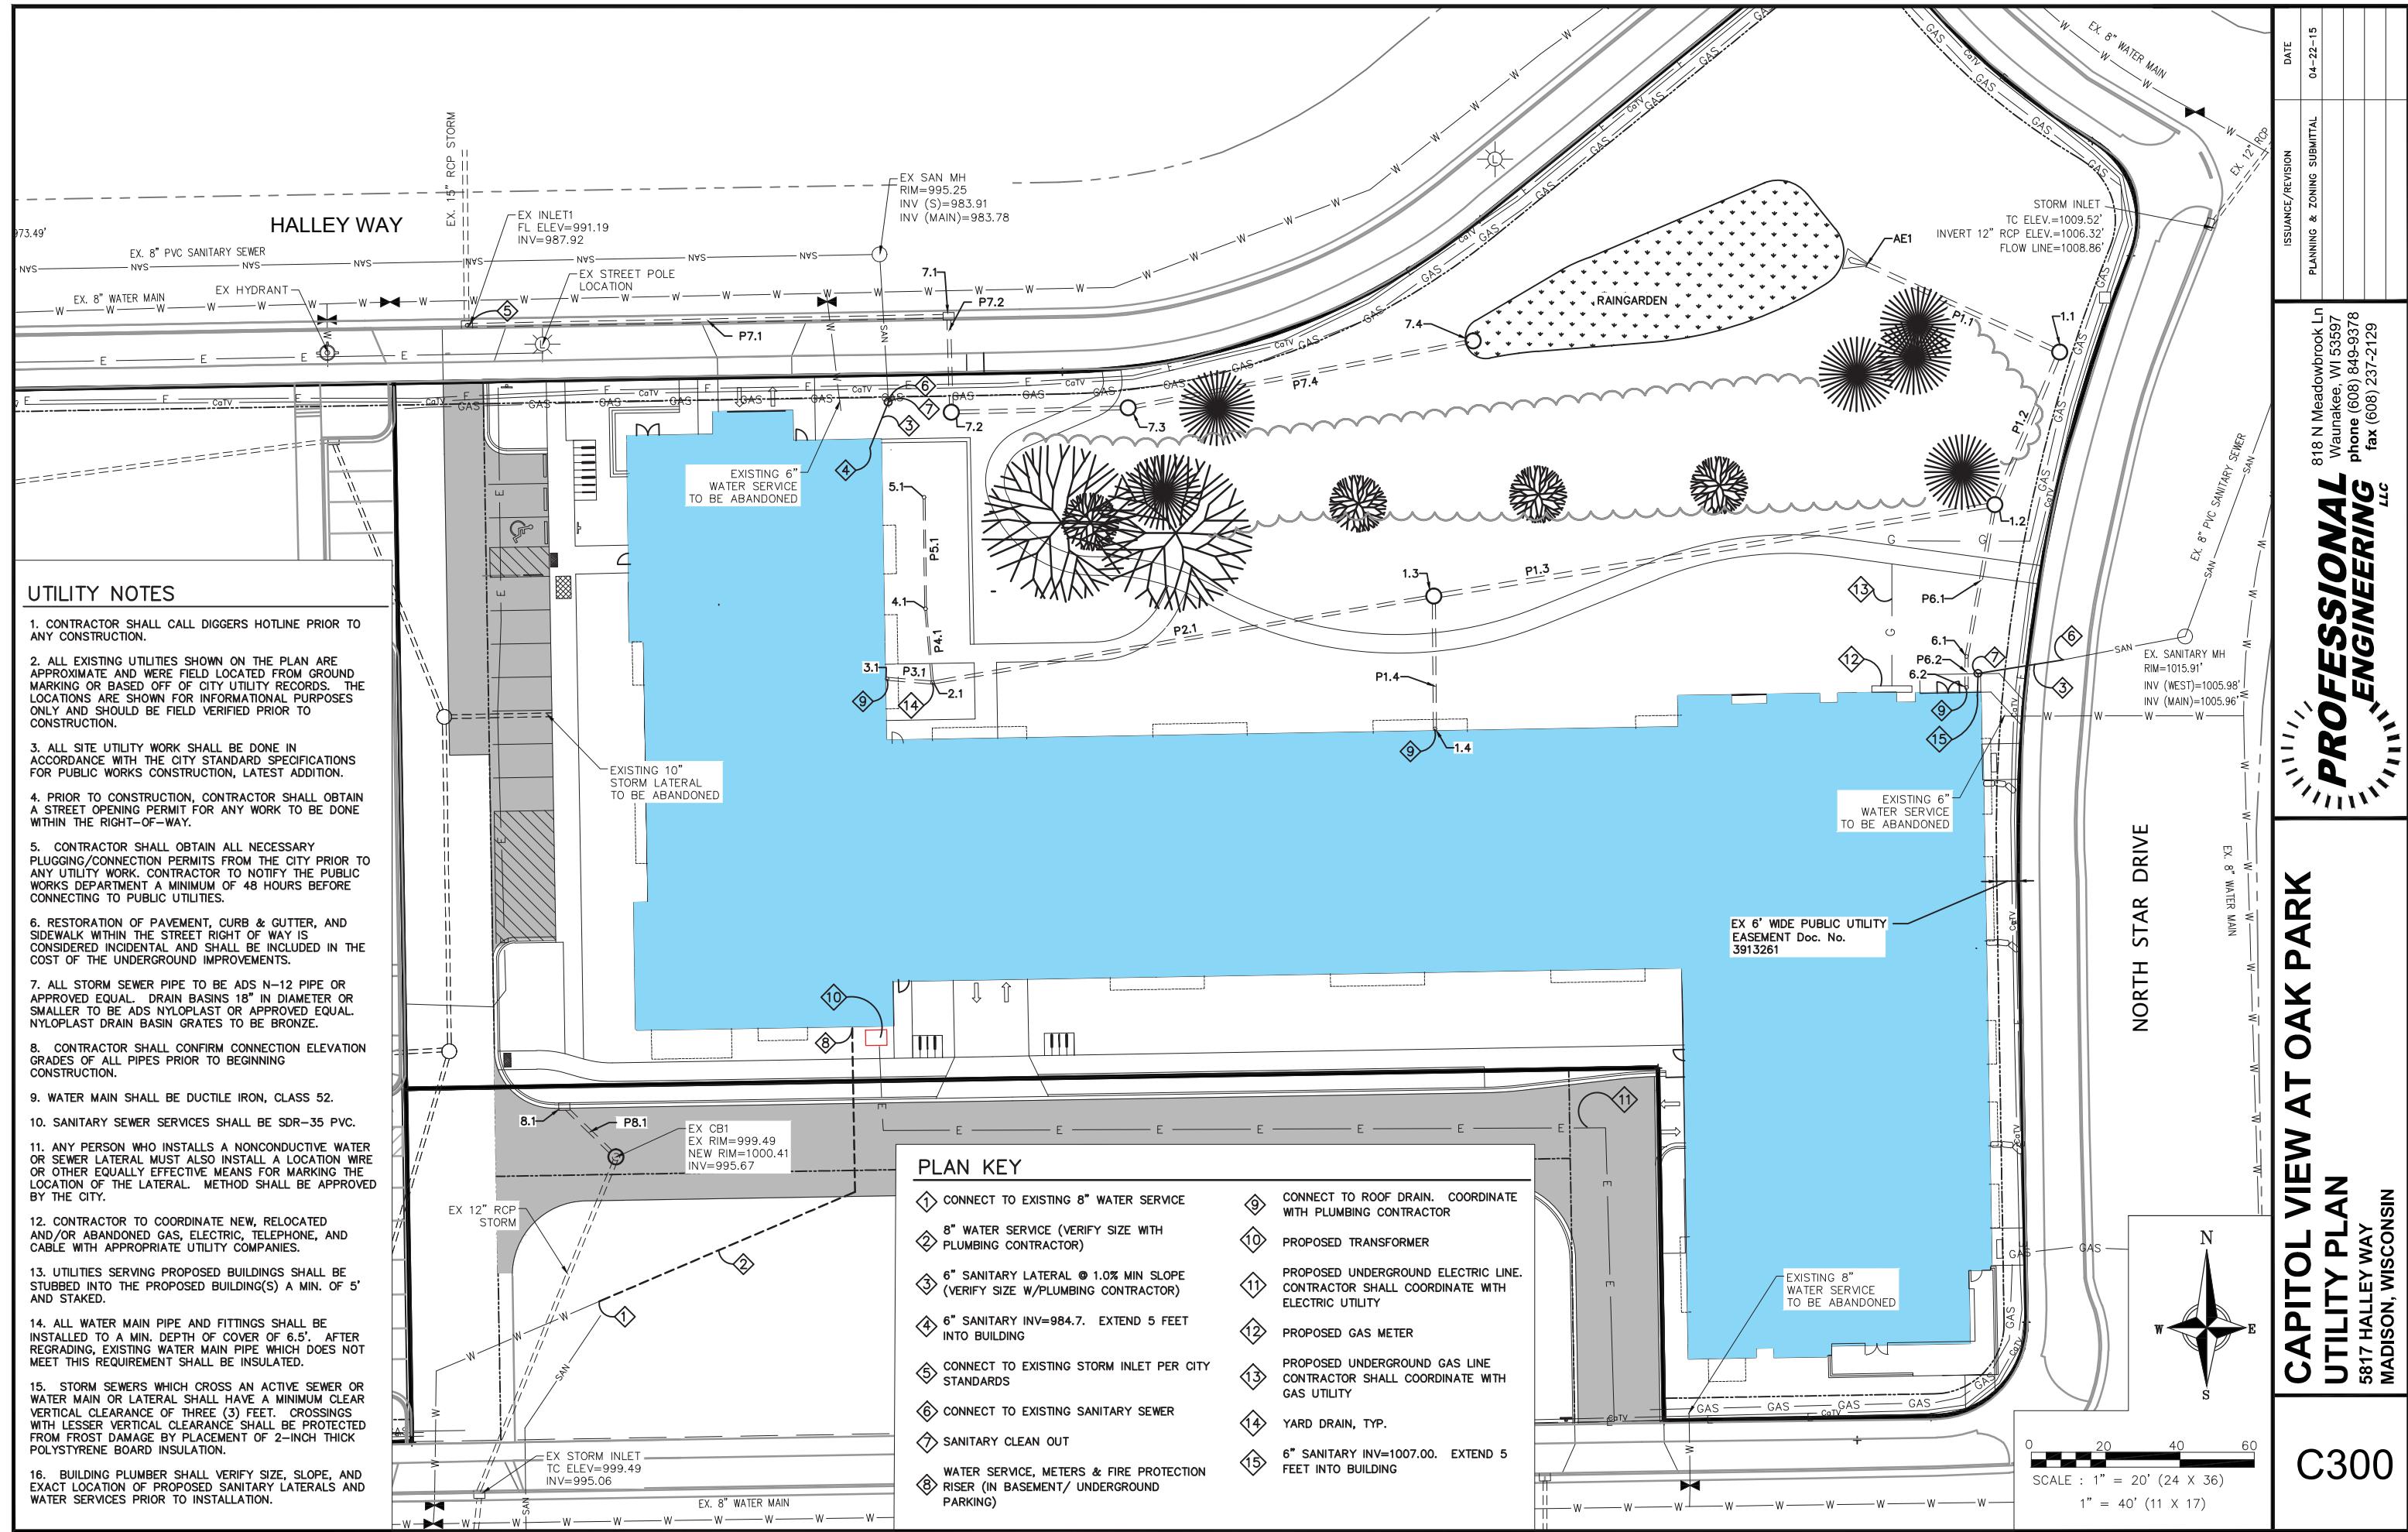

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STRUCTURE TABLE					
STRUCTURE NAME:	SIZE	TOP OF CASTING	PIPES IN:	PIPES OUT	CASTING:
1.1	4-FT DIA. CB	1010.00	P1.2, 15" INV IN =1001.70	P1.1, 15" INV OUT =1000.00	NEENAH R-1550
1.2	4-FT DIA. CB	1011.06	P1.3, 15" INV IN =1001.92 P6.1, 10" INV IN =1007.00	P1.2, 15" INV OUT =1001.92	NEENAH R-1550
1.3	4-FT DIA. CB	1007.28	P2.1, 10" INV IN =1002.86 P1.4, 10" INV IN =1004.85	P1.3, 15" INV OUT =1002.70	NEENAH R-1550
1.4	CONNECT TO ROOF DRAIN	1008.78		P1.4, 10" INV OUT =1005.12	CONNECT TO ROOF DRAIN
2.1	15" BASIN	1006.70	P4.1, 6" INV IN =1004.10 P3.1, 10" INV IN =1003.48	P2.1, 10" INV OUT =1003.47	15" GRATE
3.1	CONNECT TO ROOF DRAIN	1007.23		P3.1, 10" INV OUT =1003.72	CONNECT TO ROOF DRAIN
4.1	8" BASIN	1006.80	P5.1, 6" INV IN =1004.35	P4.1, 6" INV OUT =1004.34	8" GRATE
5.1	8" BASIN	1006.80		P5.1, 6" INV OUT =1004.51	8" GRATE
6.1	10" BASIN	1017.90	P6.2, 10" INV IN =1013.75	P6.1, 10" INV OUT =1011.00	10" GRATE
6.2	CONNECT TO ROOF DRAIN	1018.49		P6.2, 10" INV OUT =1014.00	CONNECT TO ROOF DRAIN
7.1	2X3-FT	995.75	P7.2, 12" INV IN =990.65	P7.1, 12" INV OUT =990.65	NEENAH R-3067
7.2	3-FT DIA. CB	998.05	P7.3, 12" INV IN =990.90	P7.2, 12" INV OUT =990.90	NEENAH R-1550
7.3	3-FT DIA. CB	998.50	P7.4, 12" INV IN =991.34	P7.3, 12" INV OUT =991.34	NEENAH R-1550
7.4	3-FT DIA. CB	997.50		P7.4, 12" INV OUT =992.31	HAALA INDUSTRIES CG36TM
8.1	2X3-FT	1000.23		P8.1, 12" INV OUT =996.95	NEENAH R-3067
AE1	12" RCP A.E.	1000.52	P1.1, 15" INV IN =999.00		-
EX CB1	EX STRUCTURE	1000.41	P8.1, 12" INV IN =996.80		ADJUST CASTING RIM HEIGHT
EX INLET1	EX STRUCTURE	992.56	P7.1, 12" INV IN =988.25		-

PIPE TABLE						
NAME	SIZE	LENGTH	SLOPE	MATERIAL	START INVERT ELEVATION	END INVERT ELEVATION
P1.1	15"	57'	1.76%	ADS N-12	1000.00'	999.00'
P1.2	15"	45'	0.50%	ADS N-12	1001.92'	1001.70'
P1.3	15"	153'	0.51%	ADS N-12	1002.70'	1001.92'
P1.4	10"	36'	0.76%	ADS N-12	1005.12'	1004.85'
P2.1	10"	137'	0.44%	ADS N-12	1003.47'	1002.86'
P3.1	10"	13'	1.98%	ADS N-12	1003.72'	1003.48'
P4.1	6"	20'	1.20%	ADS N-12	1004.34'	1004.10'
P5.1	6"	30'	0.53%	ADS N-12	1004.51'	1004.35'
P6.1	10"	42'	9.63%	ADS N-12	1011.00'	1007.00'
P6.2	10"	9'	2.99%	ADS N-12	1014.00'	1013.75'
P7.1	12"	130'	1.85%	RCP	990.65'	988.25'
P7.2	12"	26'	0.97%	ADS N-12	990.90'	990.65'
P7.3	12"	48'	0.92%	ADS N-12	991.34'	990.90'
P7.4	12"	95'	1.03%	ADS N-12	992.31'	991.34'
P8.1	12"	20'	0.76%	ADS N-12	996.95'	996.80'

CAPITOL VIEW AT OAK PARK
STORM SEWER SCHEDULE
5817 HALLEY WAY
MADISON, WISCONSIN

**PROFESSIONAL
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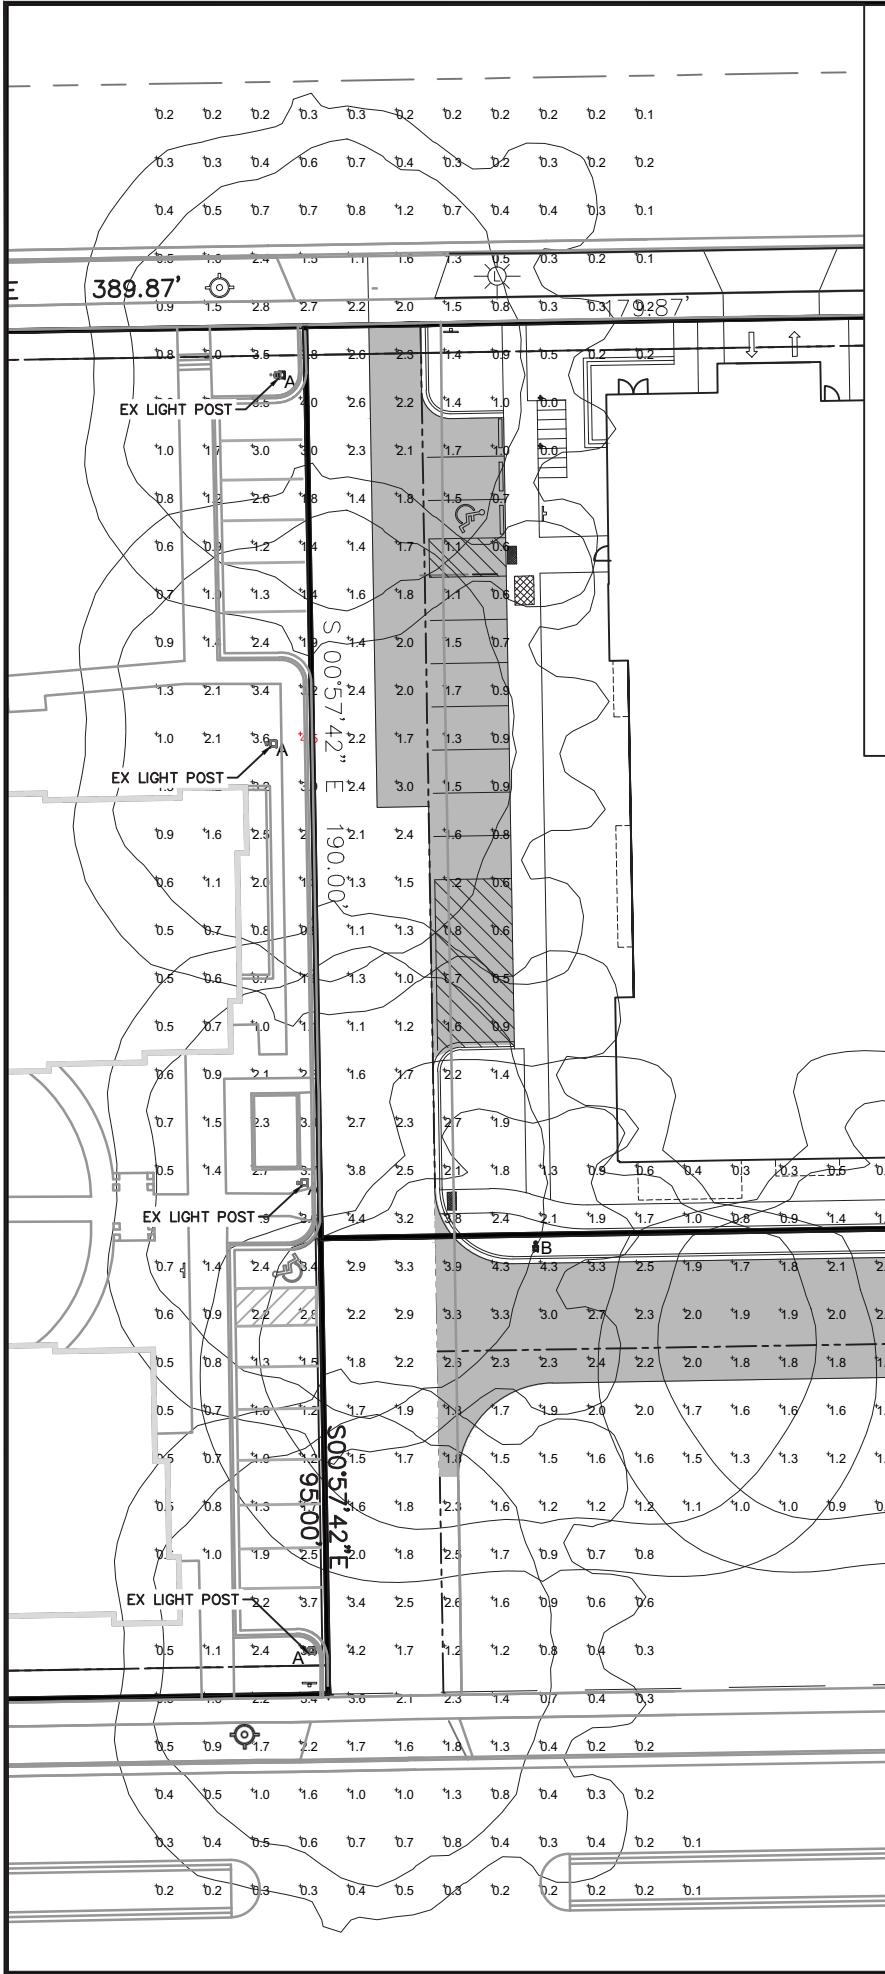
818 N Meadowbrook Ln
Waunakee, WI 53597
phone (608) 849-9378
fax (608) 237-2129

DATE

04-22-15



ISSUANCE/REVISION

PLANNING & ZONING SUBMITTAL




LUMINAIRE SCHEDULE									
Symbol	Label	Qty	Catalog Number	Description	Lamp	File	Lumens	LLF	Watts
	A	4	AS2 250M SR4W (PULSE START)	ARCHITECTURAL ARM-MOUNTED CUT-OFF LUMINAIRE WITH SR4W REFLECTOR. MEETS THE 'NIGHTTIME FRIENDLY' CRITERIA	ONE 250-WATT ED28 PULSE START METAL HALIDE, HORIZONTALPOS.	AS2_250M_SR4W_(PULSE_START).ies	25000	0.72	288
(EXISTING LIGHT POSTS)									
	B	5	DSX1 LED 40C 1000 40K T4M MVOLT	DSX1 LED WITH (2) 20 LED LIGHT ENGINES, TYPE T4M OPTIC, 4000K, @ 1050mA	LED	DSX1 LED 40C 1000 40K T4M MVOLT.ies	Absolute	0.95	138

LUMINAIRE LOCATIONS										
No.	Label	Location			MH	Orientation	Tilt	Aim		
		X	Y	Z				X	Y	Z
1	A	406.3	341.3	22.0	22.0	90.0	0.0	407.6	341.3	0.0
2	A	404.5	264.5	22.0	22.0	92.0	0.0	405.9	264.5	0.0
3	A	411.0	173.0	22.0	22.0	90.0	0.0	412.4	173.0	0.0
4	A	412.5	75.5	22.0	22.0	90.0	0.0	413.9	75.5	0.0
5	B	460.5	160.5	22.0	22.0	178.8	0.0	460.5	159.3	0.0
6	B	544.0	162.0	22.0	22.0	180.0	0.0	544.0	160.8	0.0
7	B	642.5	163.0	22.0	22.0	180.0	0.0	642.5	161.8	0.0
8	B	728.0	170.5	22.0	22.0	180.0	0.0	728.0	169.3	0.0
9	B	757.0	84.5	22.0	22.0	269.2	0.0	755.8	84.5	0.0

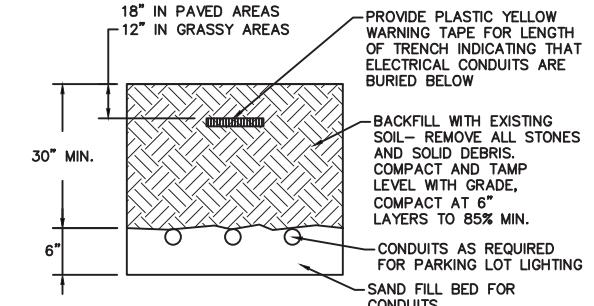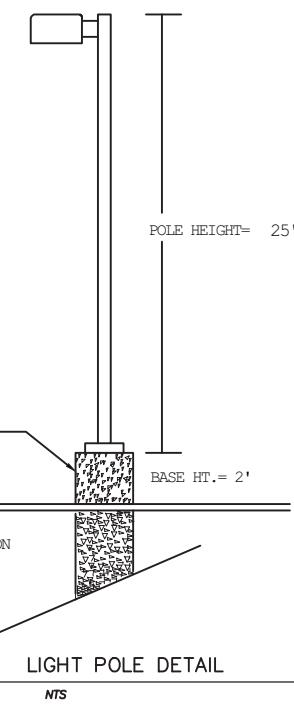


1 CONDUIT TRENCH DETAIL
100 NTS

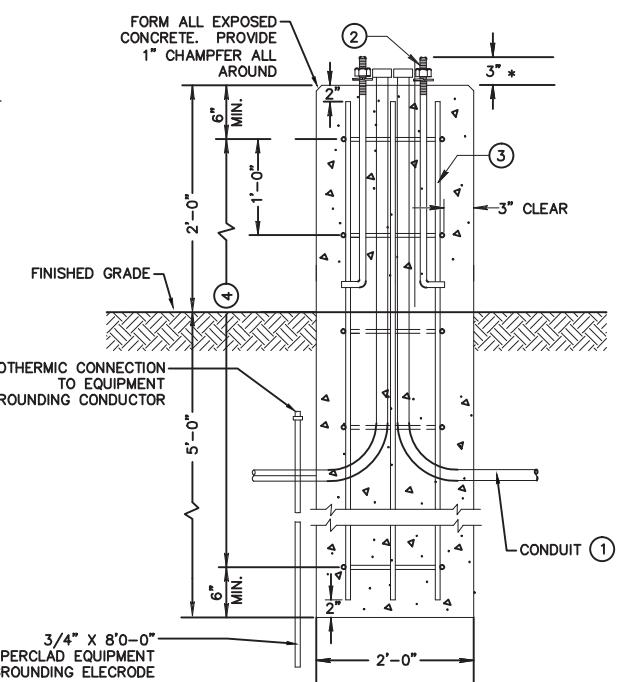

- ① THE MINIMUM DEPTH OF CONDUIT EXITING THE CONCRETE BASE AND INSTALLED BELOW THE TRAVELED WAY SHALL BE 24 INCHES. THE MINIMUM DEPTH OF CONDUIT EXITING THE CONCRETE BASE THAT IS NOT INSTALLED BELOW THE TRAVELED WAY SHALL BE 18 INCHES. THE MAXIMUM DEPTH OF ALL CONDUIT SHALL BE 36 INCHES EXCEPT WITH WRITTEN APPROVAL BY THE ENGINEER.
 - ② ANCHOR BOLTS PER MANUFACTURER'S INSTRUCTIONS
 - ③ (6) NO.4 X 4'-8" BAR STEEL REINFORCEMENT.
 - ④ (5) NO.4 X 5'-1" BAR STEEL REINFORCEMENT @ 1'-0"

CONCRETE BASE DETAIL

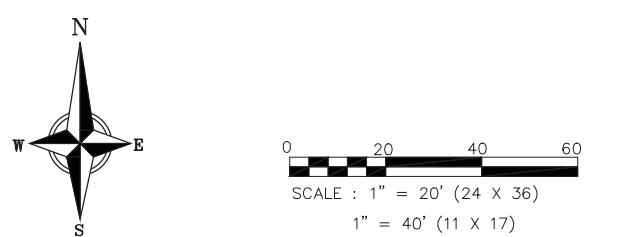

CAPITOL VIEW AT OAK PARK LIGHTING PLAN


5817 HALLEY WAY
MADISON, WISCONSIN

818 N Meadowbrook Ln
Waunakee, WI 53597
phone (608) 849-9378
fax (608) 237-2129

三

**PROFESSIONAL
ENGINEERING**

E100

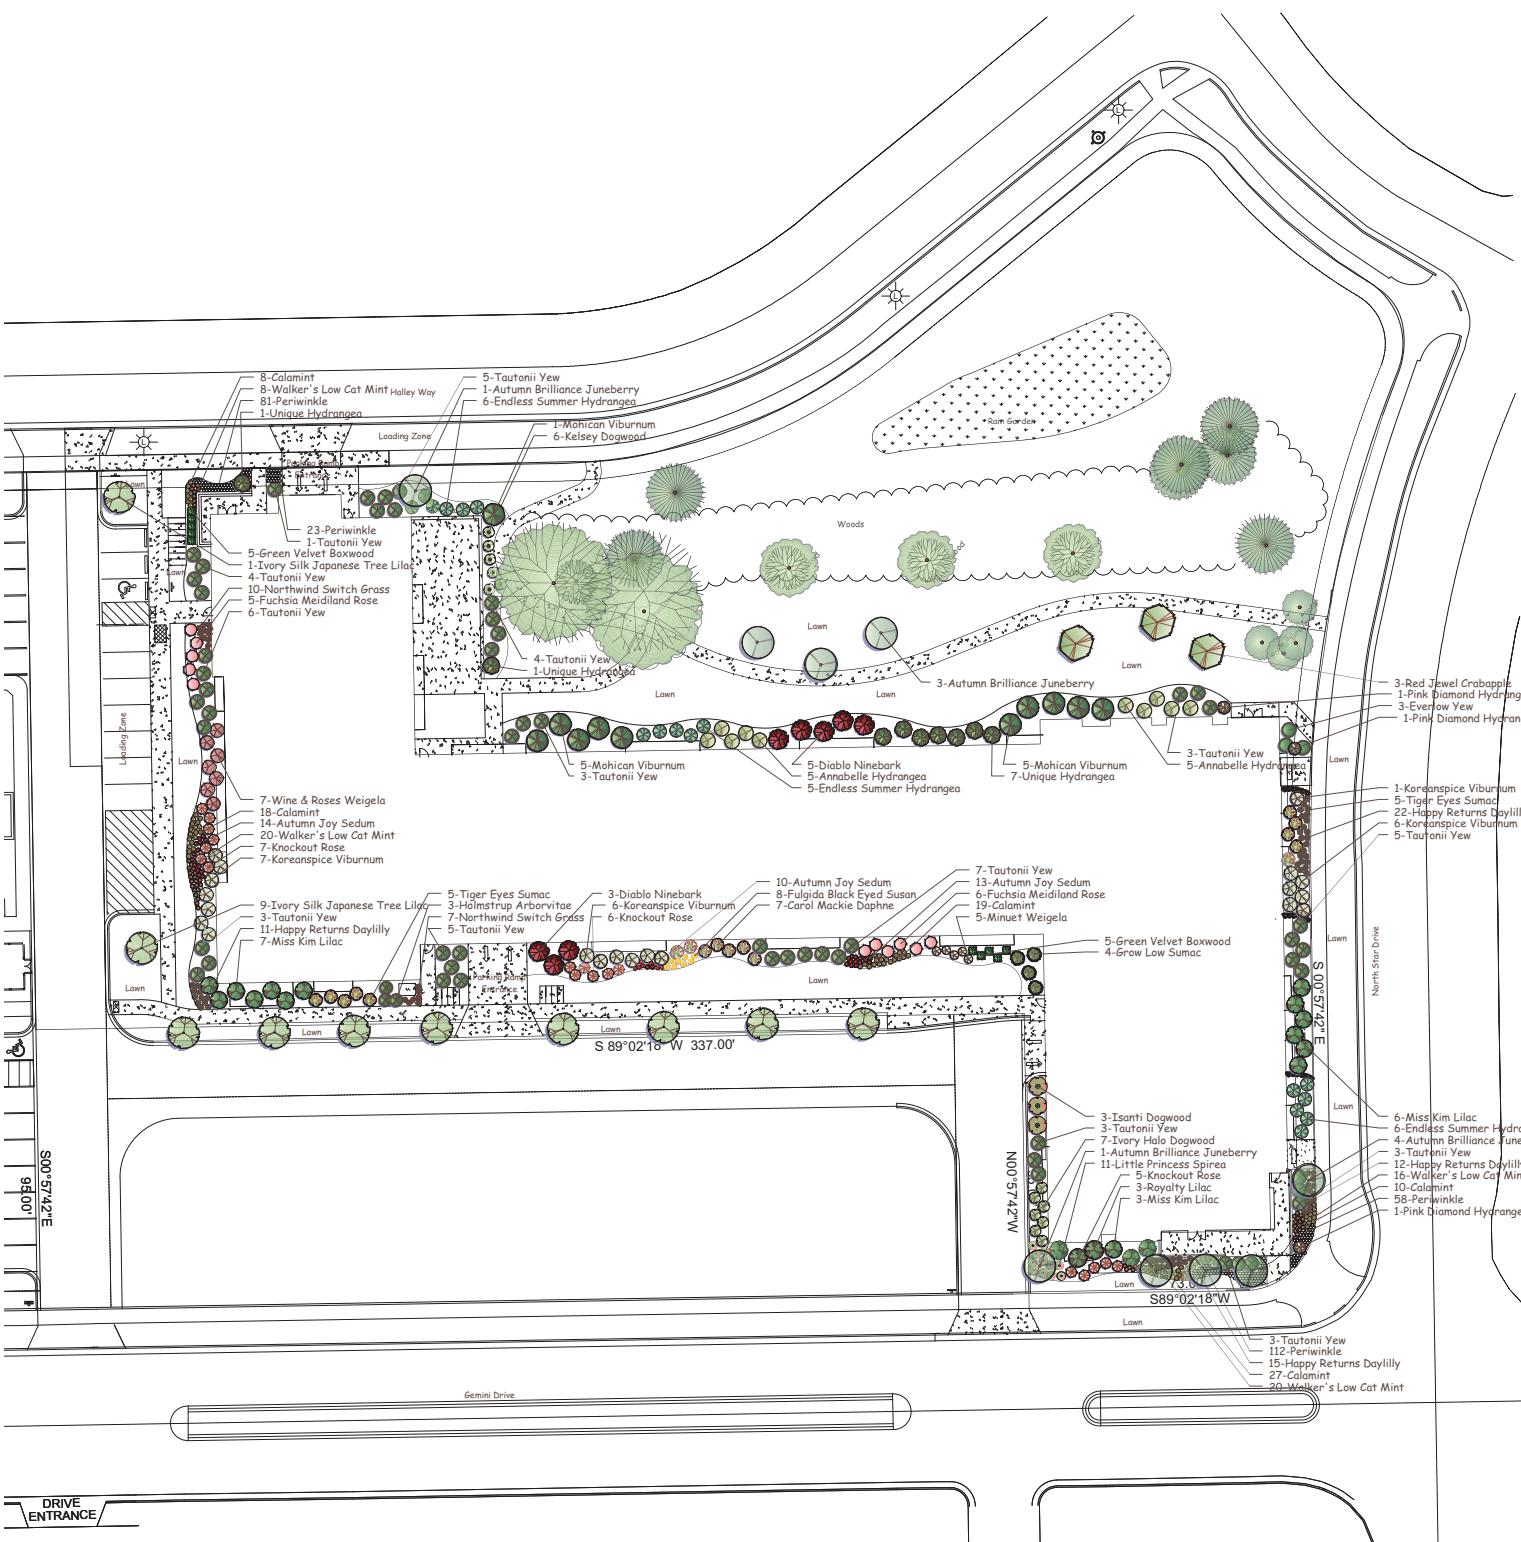

PLANT LIST					
Latin Name	Common Name	Quantity	Scheduled Size	Points Per Plant	Total Points
Existing Plants					
	Existing Overstory Trees	10		35	350
	Existing Evergreen Trees	7		15	105
	Existing Points:				
					455
Proposed Plants					
<i>Amelanchier x grandiflora 'Autumn Brilliance'</i>	Autumn Brilliance Juneberry	9	2in BB	15	135
<i>Buxus x sempervirens 'Green Velvet'</i>	Green Velvet Boxwood	10	#2	3	30
<i>Calamintha nepeta 'Montrose White'</i>	Calamint	82	4.5in Pot	2	164
<i>Cornus alba 'Bailey'</i>	Ivy Halo Dogwood	7	18-24in	2	14
<i>Cornus sericea 'Isanti'</i>	Isanti Dogwood	3	2-3ft	2	6
<i>Cornus sericea 'Kelseyi'</i>	Kelsey Dogwood	6	3-4ft	2	12
<i>Daphne x burkwoodii 'Carol Mackie'</i>	Carol Mackie Daphne	7	12-15in	2	14
<i>Hemerocallis 'Happy Returns'</i>	Happy Returns Daylily	60	4.5in Pot	2	120
<i>Hydrangea 'Endless Summer'</i>	Endless Summer Hydrangea	17	#1 Grade	2	34
<i>Hydrangea aborescens 'Annabelle'</i>	Annabelle Hydrangea	10	#1 Grade	2	20
<i>Hydrangea paniculata 'Pink Diamond'</i>	Pink Diamond Hydrangea	3	18in	2	6
<i>Hydrangea paniculata 'Unique'</i>	Unique Hydrangea	9	2ft	2	18
<i>Malus 'Red Jewel'</i>	Red Jewel Crabapple	3	2in BB	15	45
<i>Nepea x faassenii 'Walker's Low'</i>	Walker's Low Cat Mint	64	4.5in Pot	2	128
<i>Panicum virgatum 'Northwind'</i>	Northwind Switch Grass	17	1 Gal	2	34
<i>Physocarpus opulifolius 'Diablo'</i>	Diablo Ninebark	8	2-3ft	2	16
<i>Rhus aromatica 'Gow Low'</i>	Grow Low Sumac	4	15-18in	2	8
<i>Rhus typhina 'Baltiger'</i>	Tiger Eyes Sumac	10	2-3ft	2	20
<i>Rosa 'Knockout'</i>	Knockout Rose	18	2 Gal	2	36
<i>Rosa 'Meidiland Fuchsia'</i>	Fuchsia Meidiland Rose	11	2 Gal	2	22
<i>Rudbeckia fulgida var. fulgida</i>	Fulilda Black Eyed Susan	8	4.5in Pot	2	16
<i>Sedum 'Autumn Joy'</i>	Autumn Joy Sedum	37	4.5in Pot	2	74
<i>Spiraea japonica 'Little Princess'</i>	Little Princess Spirea	11	15-18in	2	22
<i>Syringa 'Miss Kim'</i>	Miss Kim Lilac	16	2-3ft	2	32
<i>Syringa 'Royalty'</i>	Royalty Lilac	3	3-4ft	2	6
<i>Syringa reticulata 'Ivory Silk'</i>	Ivory Silk Japanese Tree Lilac	10	2in BB	15	150
<i>Taxus x media 'Everlow'</i>	Everlow Yew	3	#5	3	9
<i>Taxus x media 'Tautonii'</i>	Tautonii Yew	55	#5	3	165
<i>Thuya occidentalis 'Holmstrup'</i>	Holmstrup Arborvitae	3	#15	5	15
<i>Viburnum carlesii</i>	Koreanspice Viburnum	20	#5	2	40
<i>Viburnum lantana 'Mohican'</i>	Mohican Viburnum	11	3ft	2	22
<i>Vinca minor</i>	Periwinkle	274	2.5in Pot	0	0
<i>Weigela florida 'Minuet'</i>	Minuet Weigela	5	12in	2	10
<i>Weigela florida 'Wine and Roses'</i>	Wine & Roses Weigela	7	2ft	2	14
	Proposed Points:				
					1457
	Total Points:				
					1912

General Notes

- All plant beds to be edged with aluminum or steel edging.
- Plant beds to be mulched with 3" of double shredded hardwood bark mulch.
- All trees in lawn areas to receive a 6' diameter shredded hardwood bark mulch. Dish mulch at tree trunk to avoid contact with the tree.
- Contractor is responsible for verifying all plant quantities. Plan shall preside over the plant list.
- 53,700 total square feet of developed area (impermeable area) divided by 300 equals 179 landscape units required.
- 179 landscape units required times 5 points per unit equals 895 total points required.

LANDSCAPE PLAN UDC Submittal

CAPITOL VIEW AT OAK PARK


MADISON, WISCONSIN



SCALE	1" = 30'
DATE	10-20-13
DESIGN	jch
REVISION	11-4-13

L-100

PRELIMINARY PLANS NOT FOR CONSTRUCTION

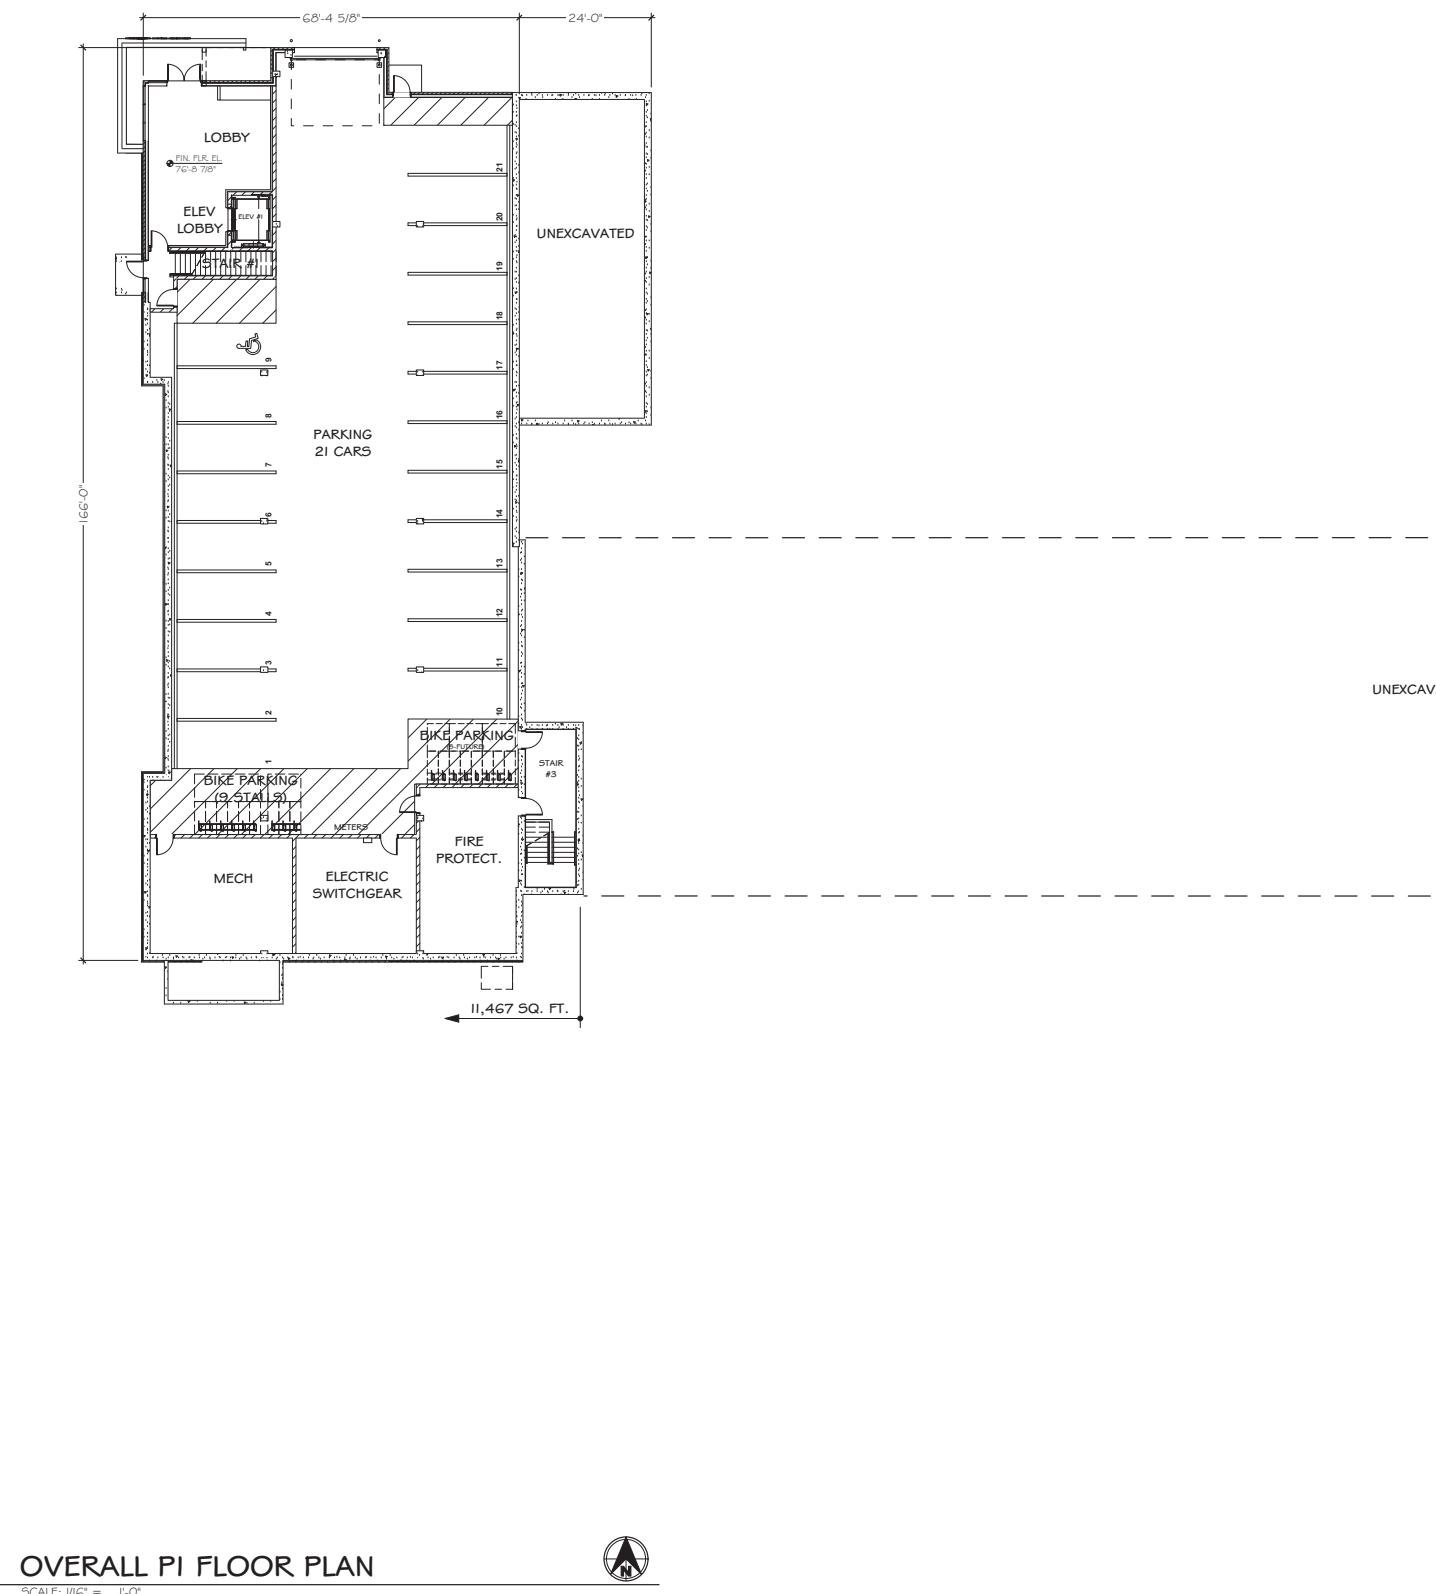

ADCI Architectural Design Consultants, Inc.
30 Wisconsin Dells Parkway • P.O. Box 580
Lake Delton, WI 53940
Phone: (608) 254-6181 Fax: (608) 254-2139

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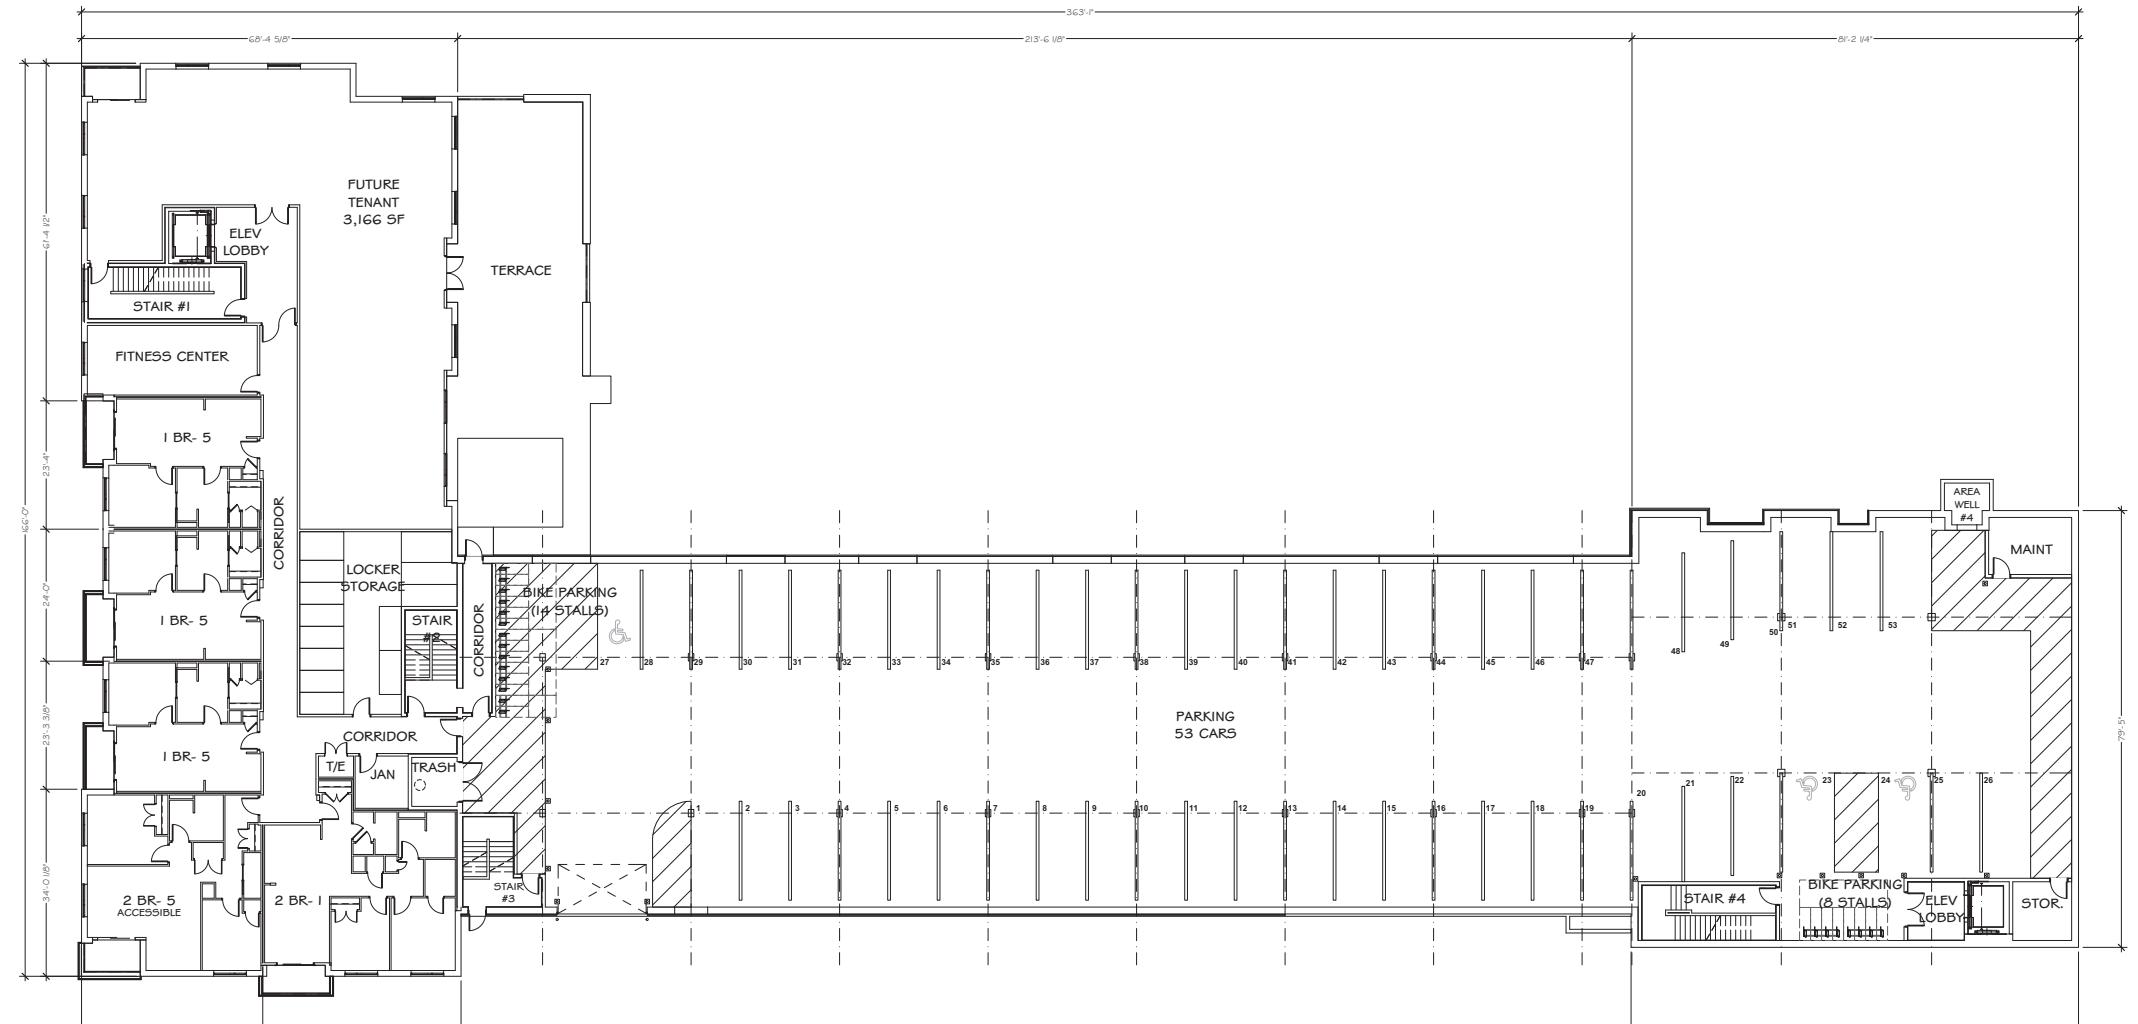
Capitol View at Oak Park
WISCONSIN
MADISON

OVERALL PI FLOOR PLAN

Drawn By: D.DUJEWEL
 Architect: M.KRUSER
 Date: 04-21-2015
 Scale: AS NOTED
 Job Number: I2-I00

SHEET NUMBER
A1.0

PRELIMINARY PLANS NOT FOR CONSTRUCTION



ADCI Architectural Design Consultants, Inc.

30 Wisconsin Dells Parkway • P.O. Box 580
Lake Delton, WI 53940
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Capitol View at Oak Park

Wisconsin
Madison

OVERALL P2 PLAN

Drawn By: D. Duewel
Architect: Mark Kruser
Date: 05/14/2015
Scale: AS NOTED
Job Number: 12-100

SHEET NUMBER
A2.0

REVISED MAY 15, 2015

PRELIMINARY PLANS NOT FOR CONSTRUCTION

Architectural Design Consultants
30 Wisconsin Dells Parkway • P.O. Box 580
Lake Delton, WI 53940
Phone: (608) 254-6181 Fax: (608) 254-2139

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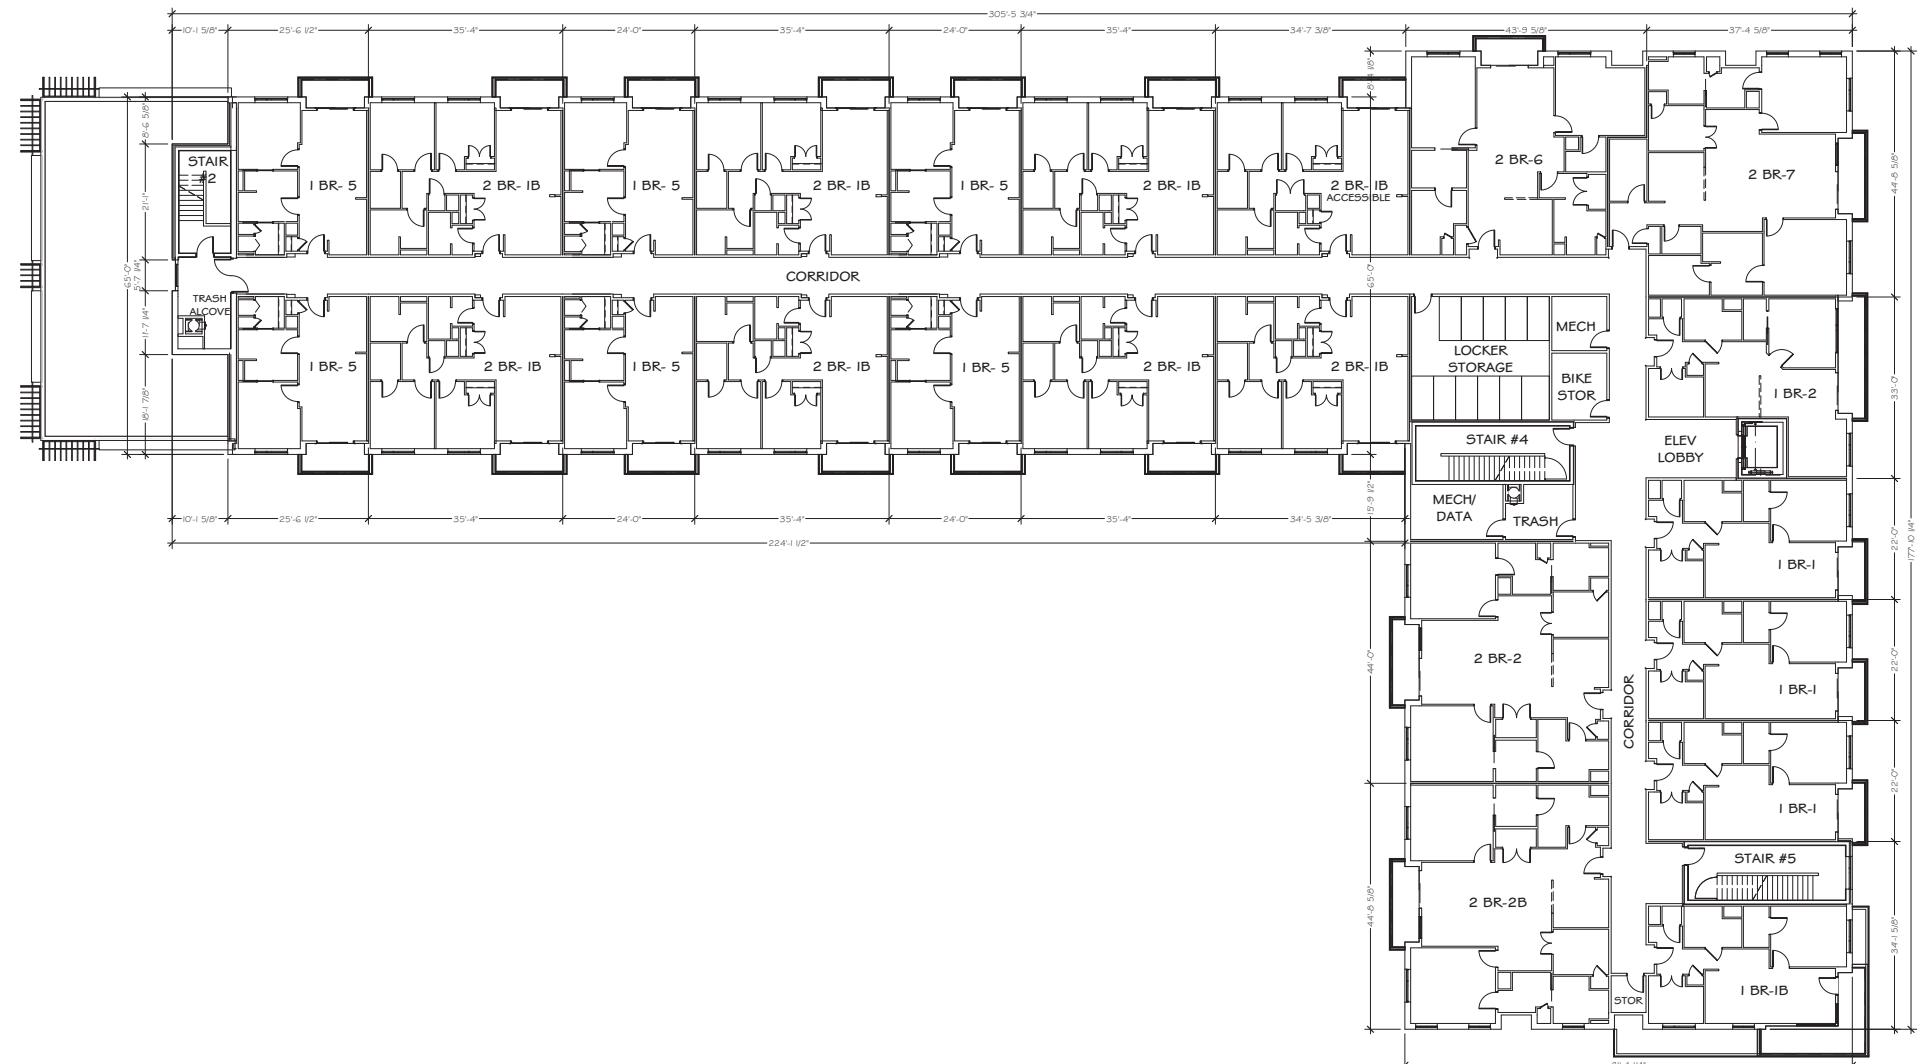


Capitol View at Oak Park

Madison Wisconsin

OVERALL THIRD FLOOR PLAN

By: D. Duewel
ект: Mark Kruser
05/14/2015
: A5 NOTED
лумер: 12-100



OVERALL THIRD FLOOR PLAN


SCALE: 1/16" = 1'-0"

REVISED MAY 15, 2015

PRELIMINARY PLANS NOT FOR CONSTRUCTION

OVERALL FOURTH FLOOR

SCALE: 1/16" = 1'

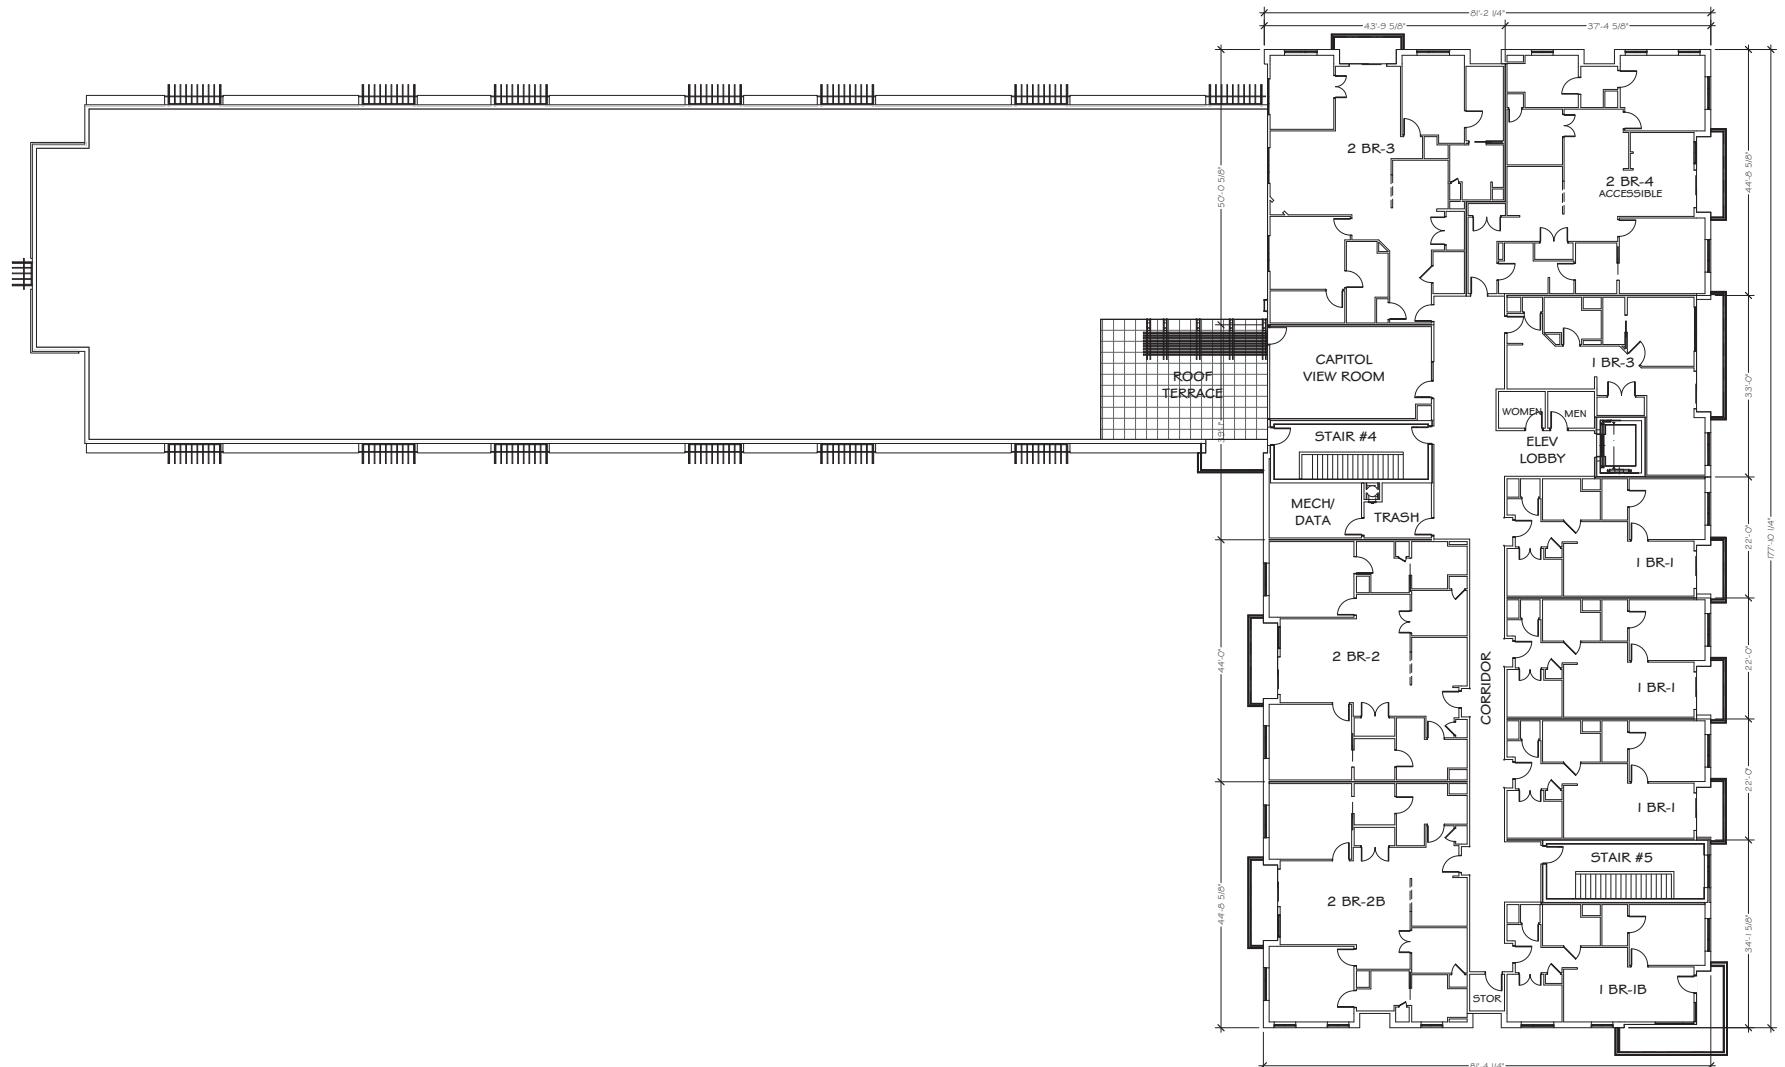

REVISED MAY 15, 2015

SHEET NUMBER
A6.0

SHEET NUMBER
A6.0

v: D. Duewel
::: Mark Kruser
05/14/2015
AS NOTED
per: 12-100

SHEET NUMBER
A6.0

OVERALL FOURTH FLOOR PLAN

OVERALL FOURTH FLOOR PLAN


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Capitol View at Oak Park
 WISCONSIN
 MADISON

OVERALL ROOF PLAN

Drawn By: D.DUJEWEL
 Architect: M.KRUSER
 Date: 04-21-2015
 Scale: AS NOTED
 Job Number: I2-100

SHEET NUMBER
A7.0

PRELIMINARY PLANS NOT FOR CONSTRUCTION

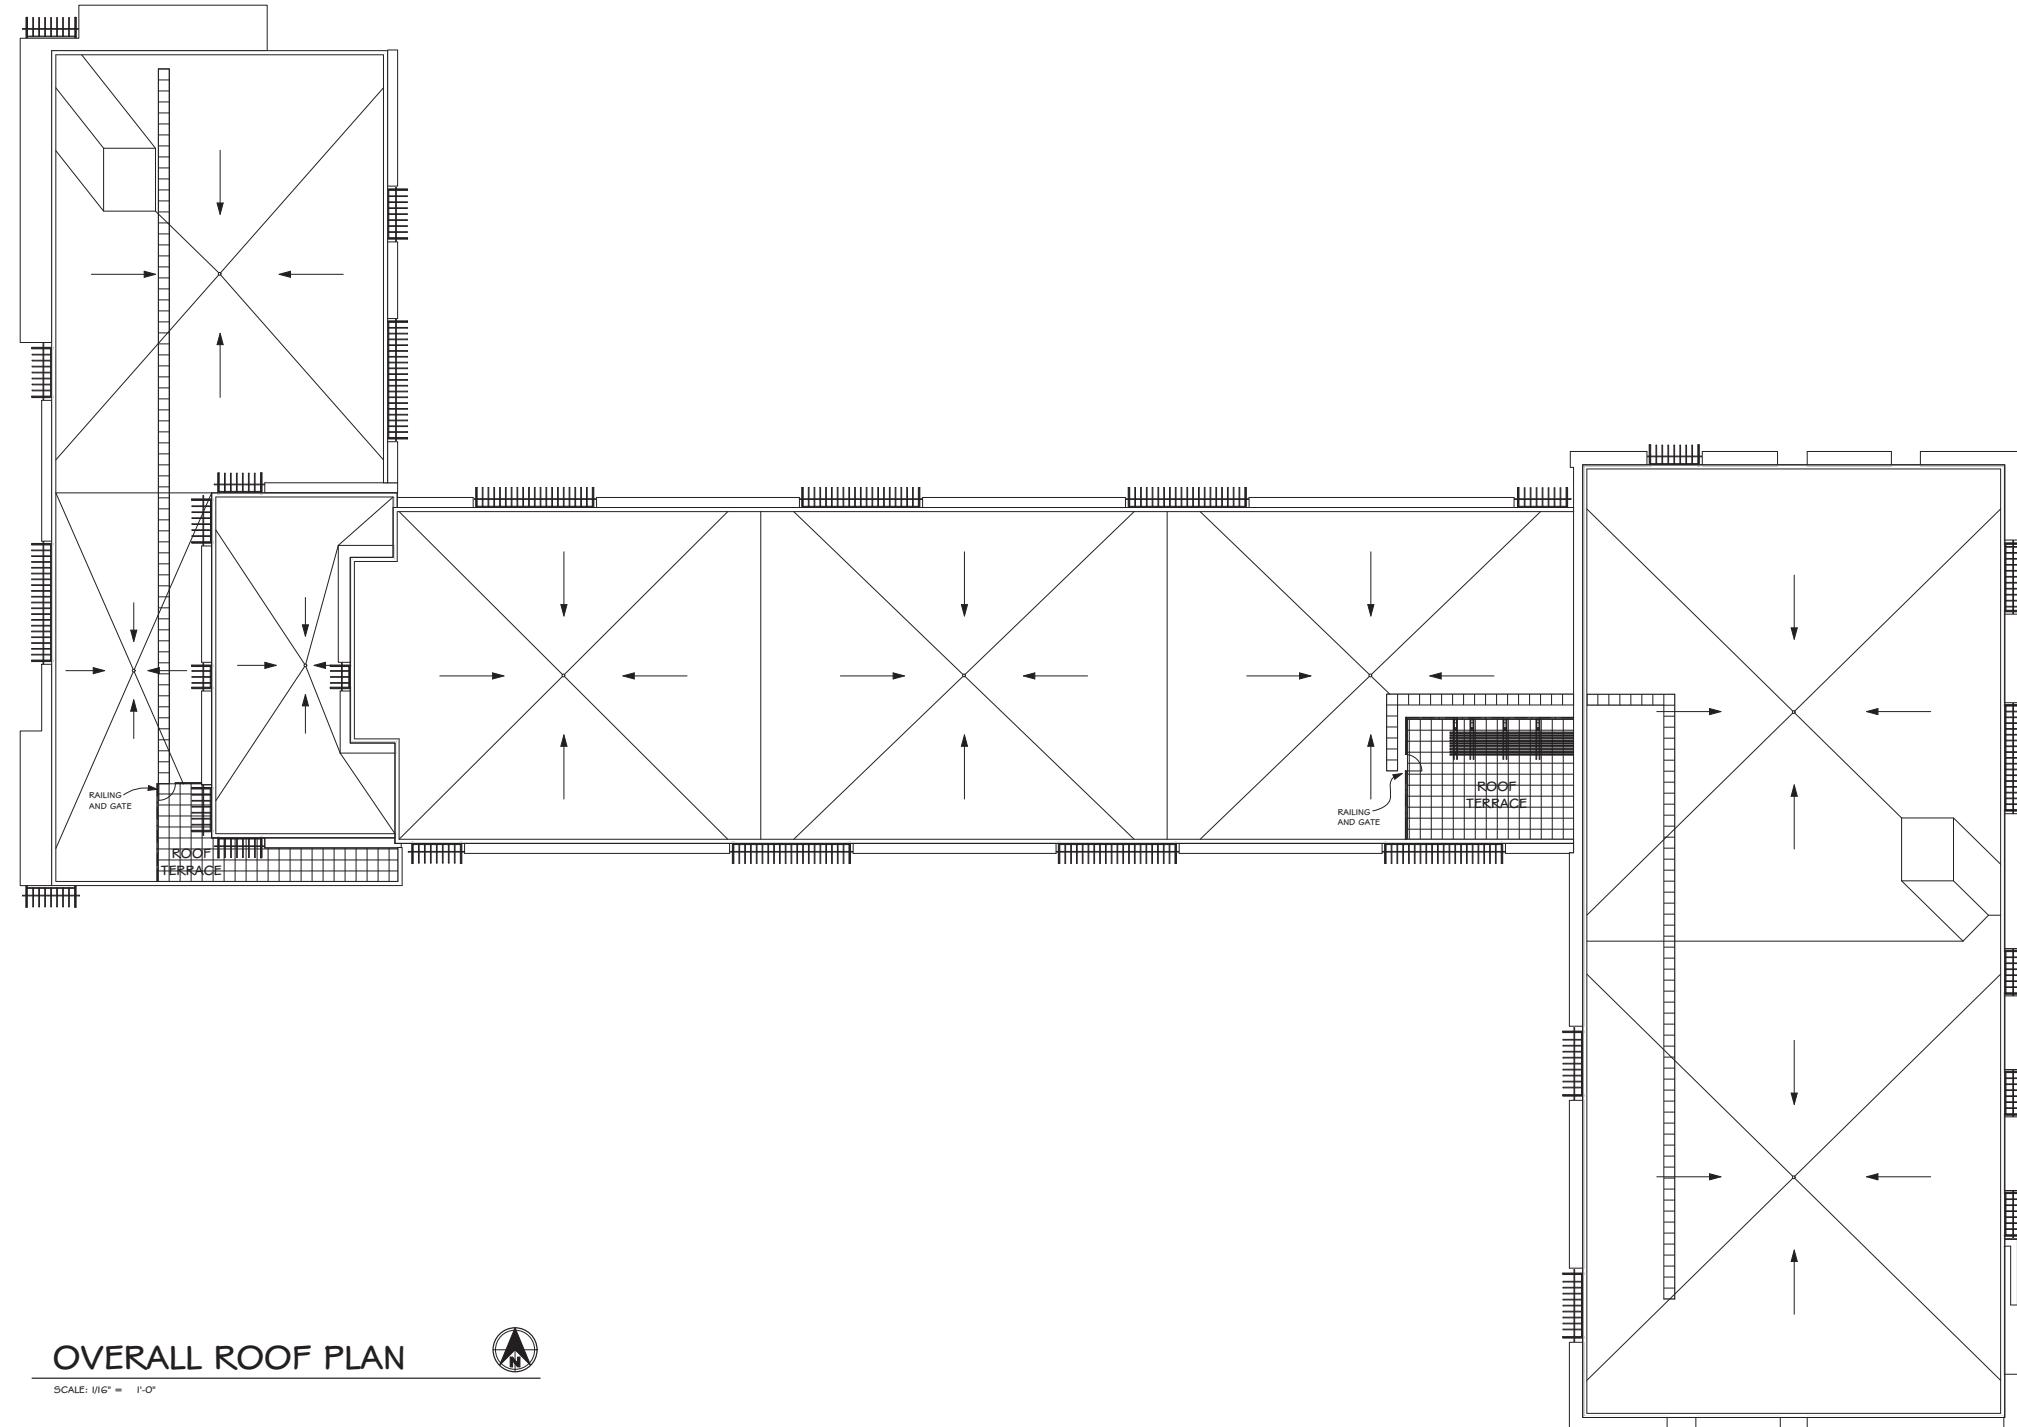

NORTH ELEVATION

SCALE: 1/16" = 1"



EAST ELEVATION

SCALE: 1/16" = 1'-0"

Client By:	D. Duewel
Architect:	Mark Kruse
Date:	05/14/2015
Scale:	AS NOTED
Job Number:	12-100
SHEET NUMBER	
A11.0	

ADCI 
Architectural Design Consultants, Inc.
30 Wisconsin Dellis Parkway • P.O. Box 580
Lake Delton, WI 53940
Phone: (608) 254-6181 Fax: (608) 254-2139

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PRELIMINARY PLANS NOT FOR CONSTRUCTION

ADCI **Architectural Design Consultants, Inc.** 30 Wisconsin Dells Parkway • P.O. Box 580

Capitol View at Oak Park

Number: 123

SHE



Wisconsin Madison

Duew
ark Kn
5/14/20
S NOT
-100

NET NUM



SOUTH ELEVATION

SCALE: 1/16" = 1'-0"



WEST ELEVATION

SCALE: 1/16" = 1'-0"

REVISED MAY 15, 2015



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VIEW ALONG NORTH STAR DRIVE

Capitol View at Oak Park, Madison, WI

November 4, 2013

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ENTRY AT NORTH STAR DRIVE

Capitol View at Oak Park, Madison, WI

November 4, 2013

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South View

Capitol View at Oak Park, Madison, WI

April 16, 2015

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ENTRY AT HALLEY WAY

Capitol View at Oak Park, Madison, WI

April 16, 2015

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