



REVISIONS

REZONING APPLICATION -FEBRUARY 19 2014

REVISED REZONING APPLICATION -APRIL 11, 2014


PROJECT TITLE 617 SEGOE RD

Madison, WI SHEET TITLE

Site Plan

SHEET NUMBER

PROJECT NO.

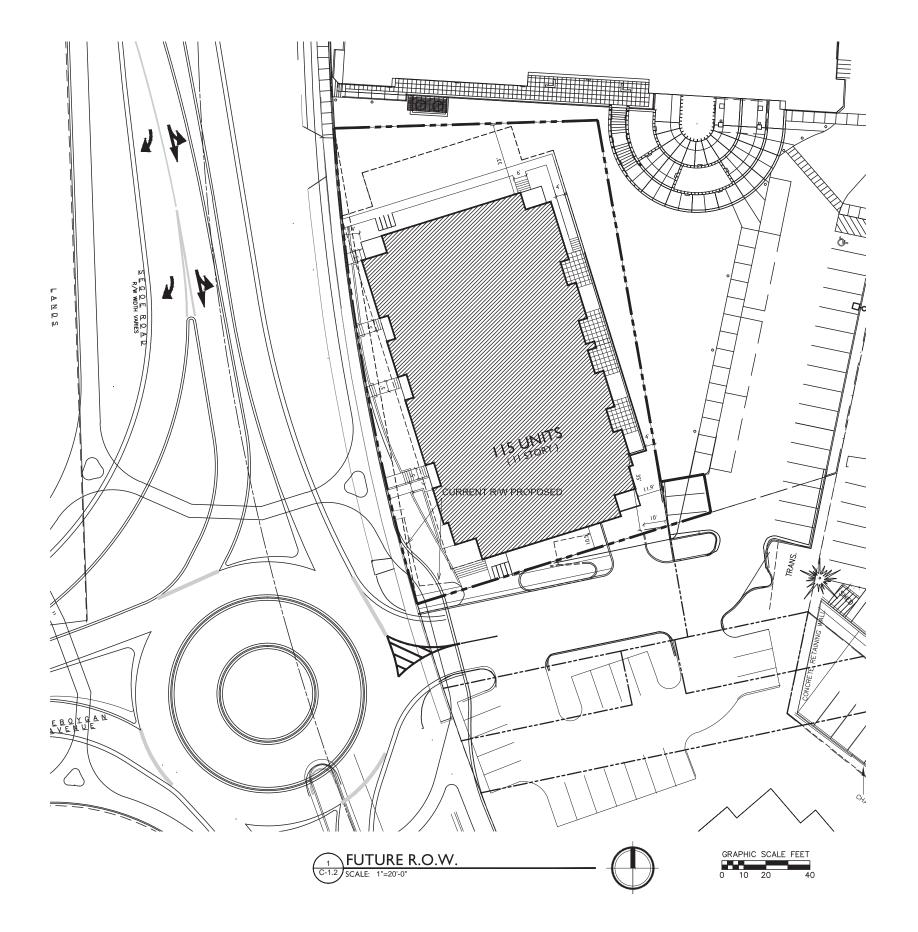



REVISIONS

REZONING APPLICATION -FEBRUARY 19 2014 REVISED REZONING APPLICATION -APRIL 11, 2014

PROJECT TITLE 617 SEGOE RD


Madison, WI

Site Plan with Future R.O.W.

SHEET NUMBER

C-1.2

PROJECT NO.

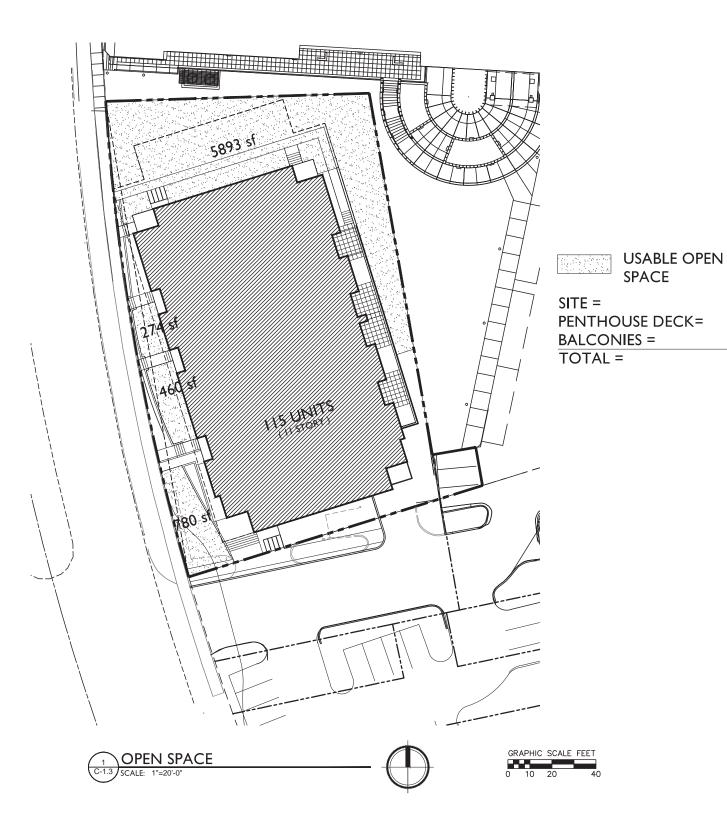



REVISIONS

7,407 SF

2,451 SF 7,572 SF

17,430 SF

REZONING APPLICATION -FEBRUARY 19 2014 REVISED REZONING APPLICATION -APRIL 11, 2014

PROJECT TITLE


617 SEGOE RD

Madison, WI

OPEN SPACE

SHEET NUMBER

PROJECT NO.

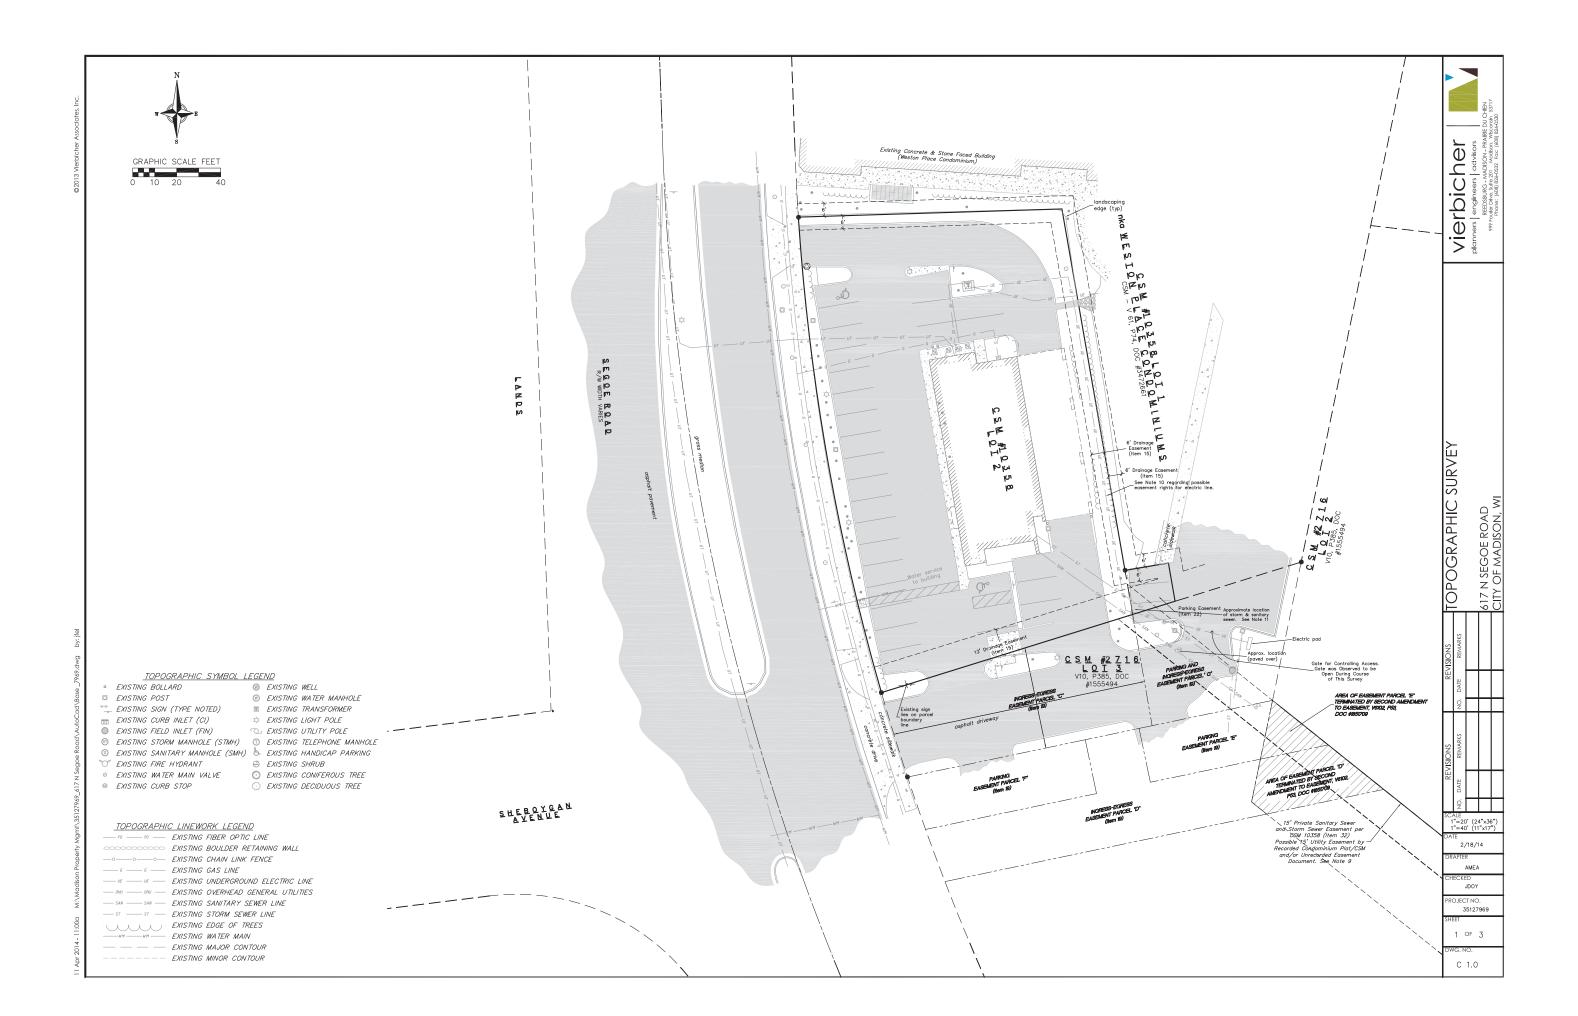

- TOP OF CURB
- FINISHED FLOOR
- TOP OF WALK
- EDGE OF PAVEMENT
RISERS

- 1. CONTOURS ARE SHOWN FOR PURPOSES OF INDICATING ROUGH GRADING. FINAL GRADE SHALL BE ESTABLISHED ON PAVED SURFACES BY USING SPOT GRADES ONLY.
- 2. ALL ABANDONED DRIVEWAYS ADJACENT TO THE SITE SHALL BE REPLACED WITH CURB AND THE TERRACE SHALL BE RESTORED WITH GRASS.
- 3. CONTRACTOR SHALL OBTAIN ANY NECESSARY DRIVEWAY CONNECTION, WORK IN RIGHT-OF-WAY AND EXCAVATION
- 4. ANY SIDEWALK AND CURB & GUTTER ABUTTING THE PROPERTY SHALL BE REPLACED IF IT IS DAMAGED DURING CONSTRUCTION OR IF THE CITY ENGINEERING DEPARTMENT DETERMINES THAT IT IS NOT AT A DESIRABLE GRADE, REGARDLESS OF WHETHER THE CONDITION EXISTED PRIOR TO BEGINNING CONSTRUCTION.

USE ANNUAL OATS AT 3.0 LB./1,000 S.F. FOR SPRING AND

2. USE WINTER WHEAT OR RYE AT 3.0 LB./1,000 SF FOR FALL

1. USE WISCONSIN D.O.T. SEED MIX #40 AT 2 LB./1,000 S.F.

TEMPORARY AND PERMANENT:

USE WISCONSIN D.O.T. TYPE A OR B AT 7 LB./1,000 S.F.

TEMPORARY AND PERMANENT:

USE ½" TO 1-½" STRAW OR HAY MULCH, CRIMPED PER SECTION 607.3.2.3, OR OTHER RATE AND METHOD PER SECTION 627, WISCONSIN D.O.T. STANDARD SPECIFICATIONS FOR HIGHWAY AND STRUCTURE CONSTRUCTION

EROSION CONTROL MEASURES

- EROSION CONTROL SHALL BE IN ACCORDANCE WITH THE CITY OF MADISON EROSION CONTROL ORDINANCE AND CHAPTER NR 216 OF WISCONSIN ADMINISTRATIVE CODE.
- CONSTRUCT AND MAINTAIN ALL EROSION AND SEDIMENT CONTROL MEASURES IN ACCORDANCE WITH WISCONSIN DNR TECHNICAL STANDARDS (http://dnr.wi.gov/runoff/stormwater/techstds.htm) AND WISCONSIN CONSTRUCTION SITE BEST MANAGEMENT PRACTICE
- INSTALL SEDIMENT CONTROL PRACTICES (TRACKING PAD, PERIMETER SILT FENCE, ETC.) PRIOR TO INITIATING OTHER LAND DISTURBING CONSTRUCTION ACTIVITIES.
- THE CONTRACTOR IS REQUIRED TO MAKE EROSION CONTROL INSPECTIONS AT THE END OF EACH WEEK AND WHEN 0.5 INCHES OF RAIN FALLS WITHIN 24 HOURS. INSPECTION REPORTS SHALL BE PREPARED AND FILED AS REQUIRED BY THE DNR AND/OR CITY. ALL MAINTENANCE WILL FOLLOW AN INSPECTION WITHIN 24 HOURS.
- EROSION CONTROL IS THE RESPONSIBILITY OF THE CONTRACTOR UNTIL ACCEPTANCE OF THIS PROJECT. EROSION CONTROL MEASURES AS SHOWN SHALL BE THE MINIMUM PRECAUTIONS THAT WILL BE ALLOWED. ADDITIONAL EROSION CONTROL MEASURES, AS REQUESTED IN WRITING BY THE STATE OR LOCAL INSPECTORS, OR THE DEVELOPER'S ENGINEER, SHALL BE INSTALLED WITHIN 24 HOURS.
- A 3" CLEAR STONE TRACKING PAD SHALL BE INSTALLED TO PREVENT SEDIMENT FROM BEING TRACKED ONTO THE ADJACENT PAVED PUBLIC ROADWAY. SEDIMENT TRACKING PAD SHALL CONFORM TO WISDNR TECHNICAL STANDARD 1057. SEDIMENT REACHING THE PUBLIC ROAD SHALL BE REMOVED BY STREET CLEANING (NOT HYDRAULIC FLUSHING) BEFORE THE END OF EACH WORK DAY.
- SITE DE—WATERING. WATER PUMPED FROM THE SITE SHALL BE
 TREATED BY TEMPORARY SEDIMENTATION BASINS OR OTHER
 APPROPRIATE CONTROL MEASURES. SEDIMENTATION BASINS OR OTHER
 APPROPRIATE CONTROL MEASURES. SEDIMENTATION BASINS OR OTHER
 APPROPRIATE CONTROL MEASURES. SEDIMENTATION BASINS SHALL
 HAVE A DEPTH OF AT LEAST 3 FEET, BE SURROUNDED BY
 SNOWEENCE OR EQUIVALENT BARRIER AND HAVE SUFFICIENT
 SURFACE AREA TO PROVIDE A SURFACE SETTLING RATE OF NO MORE
 THAN 750 GALLONS PER SQUARE FOOT PER DAY AT THE HIGHEST
 DEWATERING PUMPING RATE. WATER MAY NOT BE DISCHARGED IN A
 MANNER THAT CAUSES EROSION OF THE SITE, A NEIGHBORING SITE,
 OR THE BED OR BANKS OF THE RECEIVING WATER. POLYMERS MAY
 ELUPE TO BE USED ACROSS AREAS WILL NOT BE RESTORED IMMEDIATELY AFTE
 ROUGH GRADING, TEMPORARY SEED SHALL BE PLACED.

 15. FOR THE FIRST SIX WEEKS AFTER RESTORATION (E.G. SEED &
 MALLEN SON OF ALL NEWLY SEEDED AND MULCHED
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 15. SEDIMENT SHALL BE ELECANED FROM CURB AND GUTTER AFTE
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 16. THE CITY OF MADISON, OWNER AND OR PALL BY A THE STORY OF THE STORY OF THE STORY OF THE SET OF THE STORY O PER MINUTE. SUMP PUMP SHALL BE PLACED ON A CLEAR STONE BEDDING AND A CLOTH/MESH SOCK SHALL BE PLACED ON THE OUTLET END OF THE PIPE TO CONTROL SEDIMENT LOSS.



GRAPHIC SCALE FEET

EXISTING PAVEMENT


EXISTING PAVEMENT


PROPOSED PAVEMENT

PROPOSED PAVEMENT

- INLET FILTERS ARE TO BE PLACED IN STORMWATER INLET STRUCTURES AS SOON AS THEY ARE INSTALLED. ALL PROJECT AREA STORM INLETS NEED WISCONSIN D.O.T. TYPE D INLET PROTECTION. THE FILTERS SHALL BE MAINTAINED UNTIL THE CITY HAS ACCEPTED THE BINDER COURSE OF ASPHALT.
- 10. RESTORATION (SEED, FERTILIZE AND MULCH) SHALL BE PER SPECIFICATIONS ON THIS SHEET UNLESS SPECIAL RESTORATION IS CALLED FOR ON THE LANDSCAPE PLAN.
- 11. ALL AREAS WHICH ARE NOT PAVED SHALL RECEIVE A MINIMUM OF 4" TOPSOIL PRIOR TO SEEDING.
- 12. SEED, FERTILIZER AND MULCH SHALL BE APPLIED WITHIN 7
 DAYS AFTER FINAL GRADE HAS BEEN ESTABLISHED. IF
 DISTURBED AREAS WILL NOT BE RESTORED IMMEDIATELY AFTER LE
- 13. FOR THE FIRST SIX WEEKS AFTER RESTORATION (E.G. SEED & MULCH, SOD) OF A DISTURBED AREA, INCLUDE SUMMER WATERING PROVISIONS OF ALL NEWLY SEEDED AND MULCHED
- 15. SEDIMENT SHALL BE CLEANED FROM CURB AND GUTTER AFTER EACH RAINFALL AND PRIOR TO PROJECT ACCEPTANCE.
- 16. THE CITY OF MADISON, OWNER AND/OR ENGINEER MAY REQUIR THE CITY OF MADISON, OWNER AND/OR ENGINEER MAY REQUIR ADDITIONAL EROSION CONTROL MEASURES AT ANY TIME DURING CONSTRUCTION.



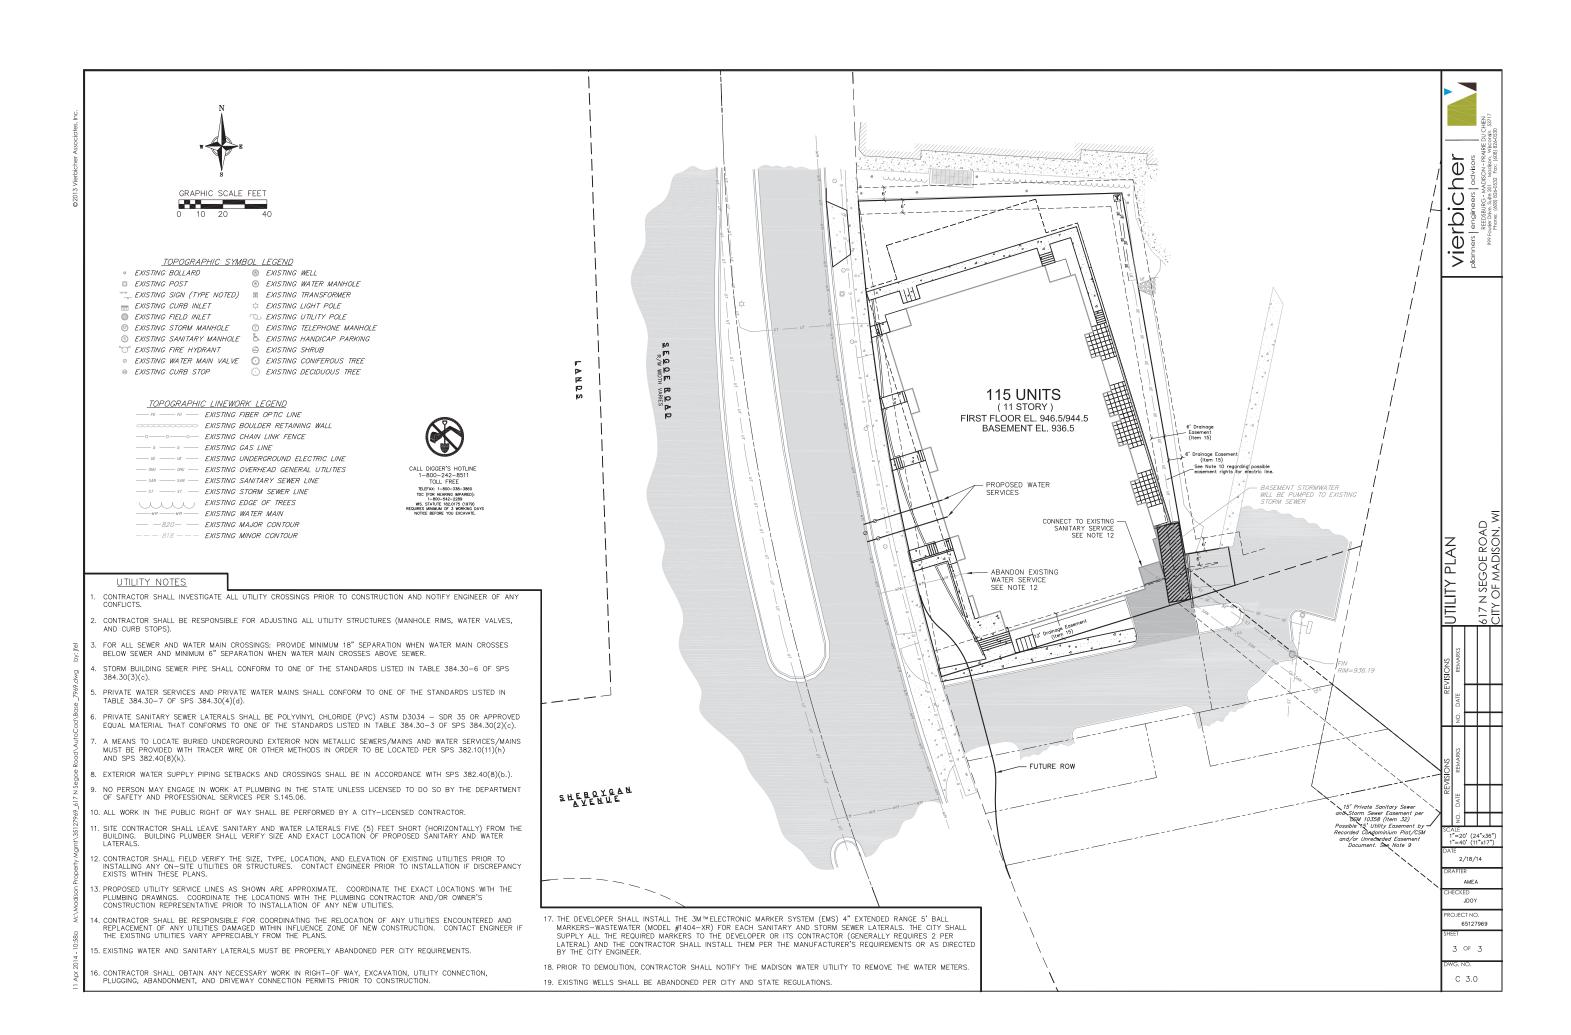

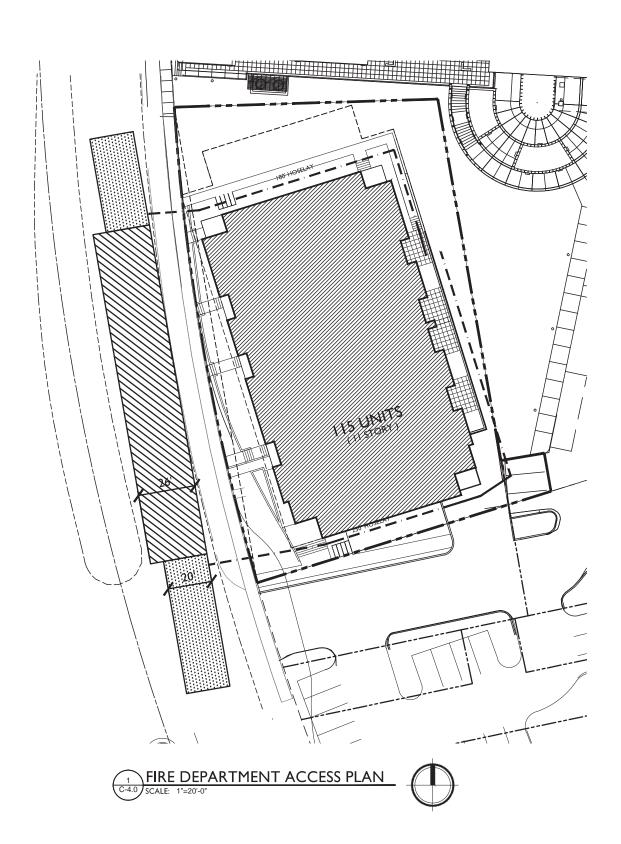



REVISIONS

REZONING APPLICATION -FEBRUARY 19 2014 REVISED REZONING APPLICATION -APRIL 11, 2014

PROJECT TITLE 617 SEGOE RD


MADISON, WI

FIRE DEPARTMENT ACCESS PLAN

SHEET NUMBER

C-4.0

PROJECT NO. 1012 © 2013 Knothe & Bruce Architects

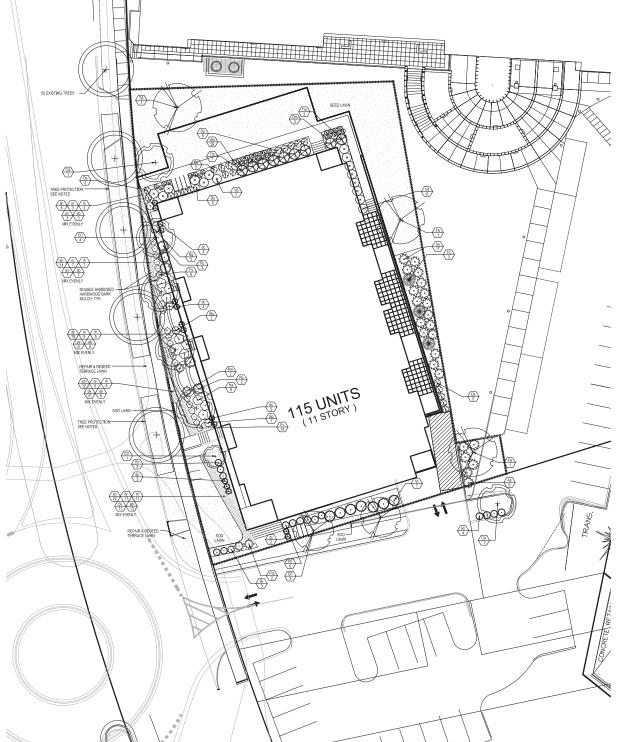

GRAPHIC SCALE										
20	٥	10	20	40						
		N FEET)								

TA	Tiliaamericana 'Sentry'	Sentry American Linden	3	2" Cal.	88	7
	Deciduous Trees					
CA	Cardinus caroliniana	American Hornbeam	2	2.5° Cal.	88	tree form, space per plan, trunk free of branches to 6.5
CC	Cerc's canadensis	Eastern Radbud	4	1.75° Cal.	BB	Columbus, Wi strain
CV	Chionanthus virginicus	White Fringetree	1	1.5° Cal.	88	Water County FFF State Sept.
	Evergreen Trees					
TC	Tsuga canadensis 'Geneva'	Eastern Hernlock	3	4' ht.	88	
	Deciduous Shrubs					
As:	Ame anchier stonionifera	Running Serviceberry	23	5 gal.		space 5' on center
Ds.	Diervilla sessilifolia 'Butterfly'	Butterfly Bush Honeysuckle	22	5 gal.		space 3.5' on center
Fv	Forsythia viridissima 'Broxensis'	Bronx Forsythia	20	5 gal.		space 3'on center
Ha	Hydrangea arborescens 'Annabelle'	Annabelle Hydrangea	9	5 gal.		space 4'on center
Rc	Rhus copallina var. latifolia 'Morton'	Prairie Flame Shining Sumac	5	5 gal.	CG	space 5' on center
Rr	Rosi rugosa 'Dwarf Pavement'	Dwarf Pavement Rose	16	2 gal.	CG	space 3'on center
Vd	Viburium dentatum 'Christom'	Blue Muffin Viburnum	15	5 gal.	CG	space 4'on center
Vt	Vibunum trilobum 'Balley's Compact'	American Cranberrybush Vburnum	7	5 gal.	CG	space 6'on center
	Evergreen Shrubs					
Bg	Buxus x "Green Velvet"	Green Velvet Boxwood	5	18"-24" spr.	CG	
Pm	Pinut mugo var. Pumilo	Dwarf Mugo Pine	- 4	18"-24" spr.		
Tm	Taxus x media 'Tauritonii'	Taunton Yew	9	24"-36" spr.	CG	space 5'on center
90	Perennials/Grasses/Groundcovers	Manager 1 1 1 1 1 1 1 1 1 1 1 1 1 1 1 1 1 1 1	2.00	Down to 1	14020	
dc	Deschampsia caespitosa 'Goldtau'	Gold Dew Tuffed Hair Grass	13	1 gal.		space 2 on center
dm	Drycoteris marginalis	Leatherlesf Fern	14	1 gal.	CG	space 2 on center
nr	Nepita racemosa "Walker's Low"	Walker's Low Catmint	37	1 gal.	CG	space 18" on center
pv ·	Physolegia virginiana 'Miss Manners'	White Gayfeather	37	1 gal.	CG	space 18" on center
rh	Rudbeckia hirta	Black Eyed Susan	37	1 gal.	CG	space 16" on center
ab	Amsonia x 'Blue Ice'	Blue Ice Star Flower	37	1 gal.	CG	space 18* on center
sh	Sporobolus hetrolepsis 'Tara'	Tara Praire Dropseed	74	1 gal.	CG	space 18" on center

City of Madison, WI La 10-Apr-14				
Developed Lot	SF	Landscape Units Req.	Landscape Points Req.	
Total Developed Area	25,351	85	42	
Element	Point Value	Quantity	Total Points	
Overstory Deciduous Tree	35	11	385	
Ornamental Tree	15	7	105	
Evergreen Tree	15	3	45	
Shrub, deciduous	2	117	234	
Shrub, evergreen	3	18	54	
Ornamental Grass	2	110	220	
Ornamental/Decorative Fence or Wall (4 pts/10 LF)	4	0	0	
			1043	
			A155 A255	
Development Frontage	LF	Overstory Tree Req (or x2 for Orn./Evergreen Tree Sub.)	Shrubs Req.	
Total LF of Street Frontage Between Bldg / Parking & street	219	7	3	
between bug raining a weet	219		3	
Element	Point Value	Quantity		
Overstory Deciduous Tree	35	4	140	
Ornamental Tree	15	6	90	
Evergreen Tree	15	.0	0	
Shrub, deciduous	2	49	98	
Shrub, evergreen	3	9	27	



KEN SAIKI
DESIGN IN C
LANDSCAPE
ARCHITECTS
20.3 F, PATERION
ANALOSON, WI STOOS
Phone 608 851-14300
Frac. 608 851-14300

REVISIONS

Revised - February 19, 2014 Revised - April 3, 2014 Revised - April 10, 2014

GENERAL NOTES

1. SEE SHEET L-2.0 FOR PLANTING DETAILS.

PLANT LIST

2. SEE CIVIL DOCUMENTS FOR TREE PROTECTION DETAILS.

GT Gredsia triccanthos var. inermis 'Skyline' Thorniess Honeylocust
TA Till page areas Senter.

3. TREE PROTECTION FENCING SHALL BE PROVIDED FOR THE EXISTING STREET TREES FOR THE DURATION OF CONSTRUCTION. FENCING SHALL COVER THE WIDTH OF THE TERRACE AND EXTEND AS SHOWN ON THE PLANS.

4. IF EXCAVATION IS NECESSARY WITHIN 5 FT OF ANY EXISTING TREE, CITY FORESTRY (DEAN KAHL, 608-266-4816, DKAHL@CITYOFMADISON,COM) SHALL BE CONTACTED SO THAT THEY MAY INSPECT AND PROVIDE RECOMMENDATIONS TO PROTECT THE ROOT SYSTEMS OF THE TREES.

5. CITY FORESTRY SHALL BE CONTACTED AT LEAST TWO WEEKS PRIOR TO DEMOLITION TO REVIEW ANY PRUNING NEEDS.

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PROJECT TITLE
SEGOE ROAD

MADISON, WI

PLANTING PLAN


SHEET NUMBER


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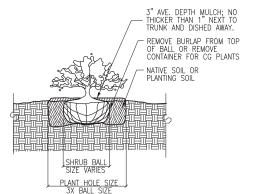
PROJECT NO. 1012

PLANTING PLAN


SCALE: 1"=20'-0"



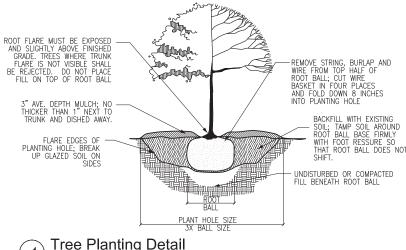

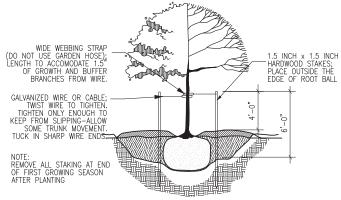

Shrub Planting Detail

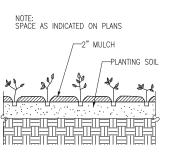

Perennial Planting Detail





Phone: 608 251-3600 Fax: 608 251-2330


PROJECT TITLE **SEGOE ROAD**

REVISIONS

PLANTING

SHEET NUMBER

PROJECT NO.

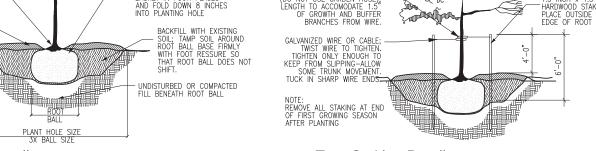

Tree Staking Detail

- 1. Contractor shall provide a suitable amended topsoil blend for all planters and areas where existing soil conditions are unsuitable for planting, seeding, or sodding. Topsoil shall be clean salvaged or imported material capable of passing the 1" sieve and meeting the requirements of Section 625.2(1) of the inches into planting hole. Standard Specifications for Highway Construction. The material shall be free of 16. No soil is to cover the top of the root flare. All plants shall be mulched rocks, gravel, wood, debris, and of noxious weeds and their seeds.
- 2. Remove all rocks, debris, and litter from the site and all planting/seeding/sodding areas. Till or disc the subsoil to a depth of 2"-4" to allow aeration. Provide a minimum of 6" of topsoil in areas where existing soil 18. Remove all twine and labels and prune any dead or broken branches after allow aeration. Provide a minimum of 6" of topsoil in areas where existing soil conditions are unsuitable for sodding and seeding. Provide a minimum of 12" planting.

 19. Maintenance for plant material shall be 30 days. Plants shall be watered,
- 3. Soil depths will vary by planter. See Architectural for details.
- 4. Do not apply topsoil to saturated or frozen subgrades.
- 5. Provide organic soil amendments as recommended by soil analysis. If topsof 0. If any street trees are damaged or need to be removed to accommodate has been determined acceptable by a soil test, no ammendments are needed. Construction, the appraised value of the tree(s) will need to be paid. The Uniformly apply any organic soil ammendments and incorporate into the top 4"-6" of soil by tilling or discing.

PLANTS

- 2. All plant material shall be true to the species and variety/hybrid/cultivar specified, and nursery-grown in accordance with good horticultural practices, and under climatic conditions similar to those of the site location. Nursery-dug material shall be freshly dug and properly prepared for planting. Contact Landscape Architect, in writing, to request any plant material substitutions due to availability issues.
- 3. Trees and shrubs shall have superior form, compactness, and symmetry. Damaged trees and shrubs, by weather, insects, fungus, knots, abrasions, or cla Seed shall be delivered to the site in its original, unopened container, limbs or leaders and trees with multiple leaders, unless specified otherwise, will be rejected.
- physical damage.
- 5. Plants shall conform to the measurements specified within the contract
- that damages trunks or breaks branches. Plants are not to be dragged, lifted, Specifications for Highway Construction. Unless otherwise specified, provide or pulled by the trunk, branches or foliage. Plants are not to be thrown off of a truck or loader.
- 7. Prior to installation, plants must be protected from sun and drying winds, kept in shaded areas, and kept well-watered. Install all plants within three days of delivery to site.
- 8. All plants shall be guaranteed to be in healthy and flourishing condition during the growing season. The guarantee does not cover damage from owner, all plants not in a healthy and flourishing condition as determined by the Landscape Architect.
- 9. All plant material shall be guaranteed for one (1) year from time of installation. Only one replacement per plant shall need to be made.
- detrimental to healthy plant growth. Shredded bark mulch shall be 1/8" nominarequirements in TPI's "Specifications for Turfgrass Sod Materials" and thickness, with at least 50% having an area of not less than 1 sq. inch, and no "Specifications for Turfgrass Sod and Transplanding and Installation" in its piece having an area of more than 4 sq. inches.
- 11. Stake all planting and notify Digger's Hotline (1-800-242-8511) to verity location of all underground utilities prior to excavation.
- at least 2.5 to 3 times the diameter of the soil ball. The soil beyond the edges is to be loosened. The soil at the base of the pit is to remain
- 13. The depth of the planting pit shall correspond to the distance from the bottom of the soil ball to the root flare, or slightly less. Plant material set too low will need to be re-set by the contractor pending the Landscape Architect's instructions. Pits shall be backfilled with excavated soil so long as it is not muddy or frozen.
- 14. The planters shall be prepared for planting by placing topsoil on top of filter fabric and crushed aggregate (to be provided by general contractor); tamp and/or water to ensure that large air pockets have been removed from planter; allow for settling and re-fill so that topsoil is 2" below cap of lower wall; mound planting beds slightly in the center for added height.

(PLANTS CONT'D)


- 15. Root balled plants shall have rope, string, burlap and/or other wrapping material cut away and removed from top half of the root ball after the plant has been set in the hole. Cut wire basket in four places and fold down 8
- with a 3" layer of specified mulch immediately after planting. Mulch is to be pulled back no less than 3" and no more than 6" from trunks.
- 17. Thoroughly water plants immediately after planting and before mulching.
- staked, pruned, dead-headed, and planting beds shall be weeded during this time period.
- planned removal of the two street trees includes all brush and stump removal. 21. Tree protection fencing shall be provided for each of the existing street trees for the duration of the construction. The fencing shall cover the width of the terrace and extend as shown on the plans. If excavation is necessary 1. All plant material shall conform to the American Standards of Nursery Stock within 5 ft of any existing tree, City Forestry (Dean Kahl, 608-266-4816, dkahl@cityofmadison.com) shall be contacted so that they may inspect and provide recommendations to protect the root systems of the trees.
 - 22. City Forestry shall be contacted at least two weeks prior to demolition to review any pruning needs. City Forestry will prune the existing street trees, they will need building plans to determine how much they will need to prune off the building side of the trees.

LAWNS & GRASSES

- labeled as to weight, analysis, and manufacturer. Store any seed delivered prior to use in a manner safe from damage from heat, moisture, rodents, or 4. Trees and shrubs shall have healthy, well-developed root systems, free from the rauses. Any seed damaged after acceptance shall be replaced by the Contractor.
 - 2. The Contractor shall guarantee the germination of seed installed during the regular seeding season (May 1 - October 15).
- 6. During transportation, no plant shall be bound with rope or wire in a manner 3. Grass seed shall meet the requirements of Section 630.2.1 of Standards Kentucky Bluegrass seed blend.
 - 4. Place and anchor clean straw or hay mulch that is well-seasoned, and free of rot, mildew, and seeds of noxious weeds over the seeded area according to the methods outlined by Section 627.3 of Standards Specifications for Highway Construction
 - 5. Erosion control mat shall be used on slopes greater than 1:4.
- 6. Seeded areas are to be watered daily to maintain adequate surface soil vandalism, animals, freezing rain, or winds over 60 mph. During any time of the noisture for proper seed germination. Watering shall continue for not less than quarantee period, the Contractor shall remove or replace, without cost to the 60 days following seeding. Thereafter, apply 1/2" of water twice weekly until final acceptance
 - 7. All sod is to be turfgrass species Kenucky Bluegrass (Poa pratensis), a minimum of three cultivars, of uniform density, color, and texture, strongly rooted, and capable of vigorous growth and development when planted.
- 10. Organic Mulch is to be double shredded hardwood bark, free of material 8. All sod is to be harvested, delivered, stored, and handled according to "Guideline Specifications to Turfgrass Sodding"
 - 9. Lay sod within 24 hours of harvesting. Do not lay sod if dormant or if ground is frozen or muddy.
- 12. The planting pit for containerized and balled and burlapped plants shall be 10. Lay sod to form a solid mass with tightly fitted joints. Butt ends and sides of sod; do not stretch or overlap. Stagger strips or pads to offset joints in adjacent courses. Avoid damage to subgrade or sod during installation. Tamp and roll lightly to ensure contact with subgrade, eliminate air pockets, and form a smooth surface. Work sifted soil or fine sand into minor cracks between sod pieces; remove excess soil.
 - 11. Lay sod across angle of slopes exceeding 1.3. Anchor sod on slopes exceeding 1:6 with wood pegs space as recommended by sod manufacturer but not less than two (2) anchors per strip.
 - 12. Saturate sod with fine water spray within two hours of planting. During the first week, water daily or more frequently as necessary to maintain moist soil to a min. depth of 1-1/2" below sod.
 - 13. Maintenance of sodded lawn is to begin immediately after each area is planted and continue until acceptable lawn is established, but not less than 60 days from date of substantial completion.

(LAWNS & GRASSES CONT'D)


- 13. Provide and maintain temporary piping, hoses, and watering equipment to convey water from sources and keep sodded lawn uniformily moist to a depth of 4". After first week, water sodded lawn at a minimum rate of 1" per week. 14. All lawn areas of seed or sod are to be mowed to a height of 2"-3" by scheduled mowings. Repeat mowing to maintain specified height without cutting more than 40% of grass height. Remove no more than 40% of grass-leaf growth in initial or subsequent mowings. Do not delay mowing until grass blades bend over and become matted. Do not mow when grass is wet Mow to maintain during entire 60-day maintenance period
- 15. Maintain and establish seeded and sodded lawn areas by watering, fertilizing, weeding, mowing, trimming, replanting, and other operations. Roll, regrade, and replant bare or eroded areas and remulch to produce a uniformly smooth lawn.
- 16. At the end of the maintenance period, a healthy, well-rooted, even-colored, viable lawn will have been established, free of weeds, open ioints, bare areas, and surface irregularities.

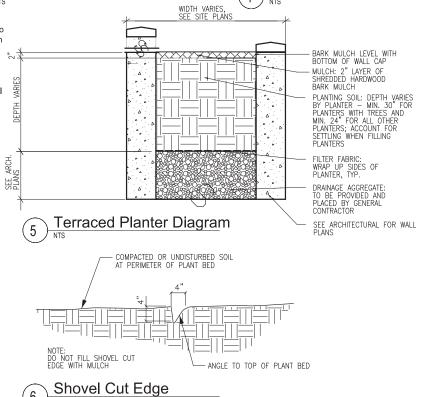

MADISON, WI

DETAILS AND NOTES

1012

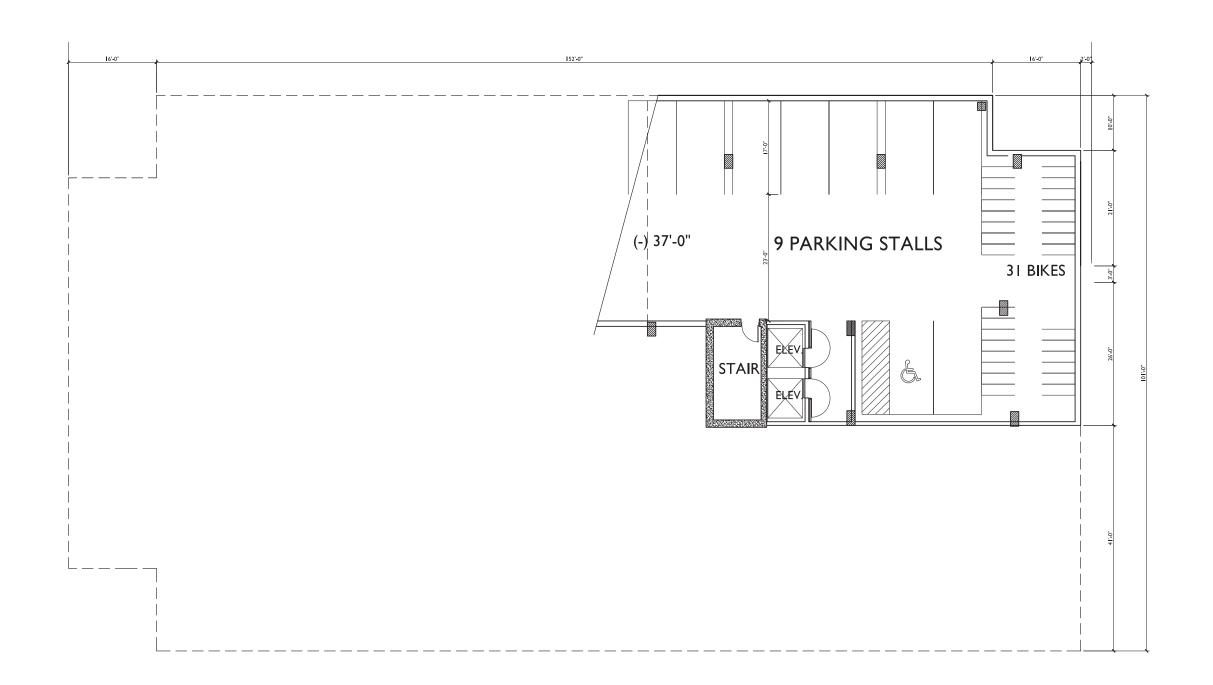





PROJECT TITLE
617 SEGOE RD


Madison, WI
SHEET TITLE
PARKING LEVEL 4

SHEET NUMBER



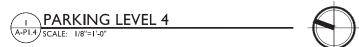

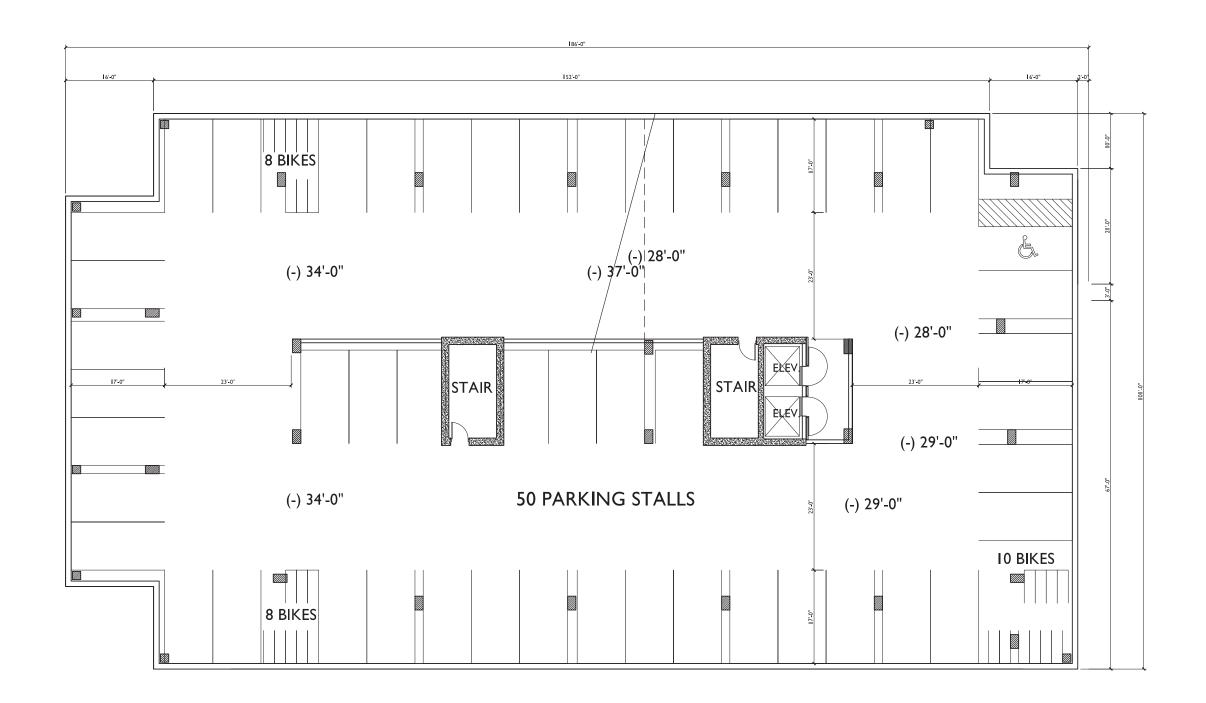

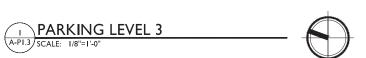




PROJECT TITLE
617 SEGOE RD

Madison, WI
SHEET TITLE
PARKING
LEVEL 3

SHEET NUMBER

A-PI.3

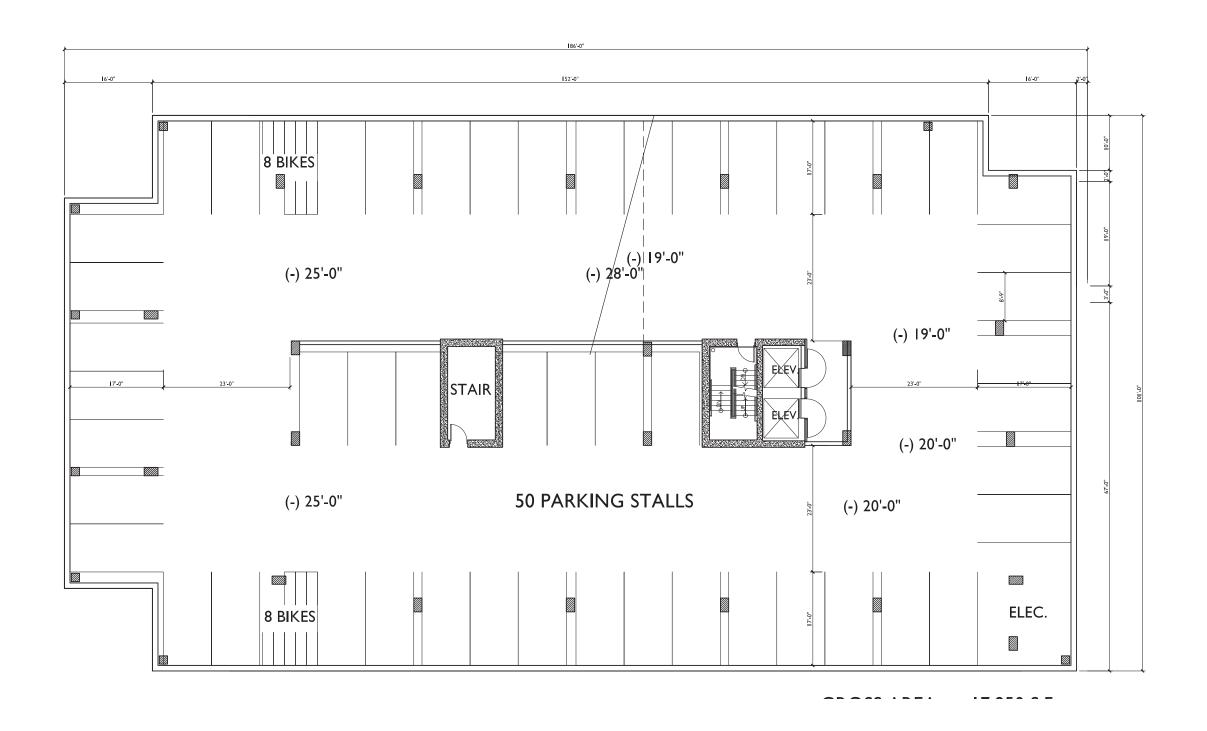

PARKING LEVEL 2

SCALE: 1/8"=1'-0"




ISSUED
Issued For Rezoning - February 19, 2014
Revised Rezoning - April 11, 2014

PROJECT TITLE
617 SEGOE RD

Madison, WI
SHEET TITLE
PARKING LEVEL 2

SHEET NUMBER

A-PI.2

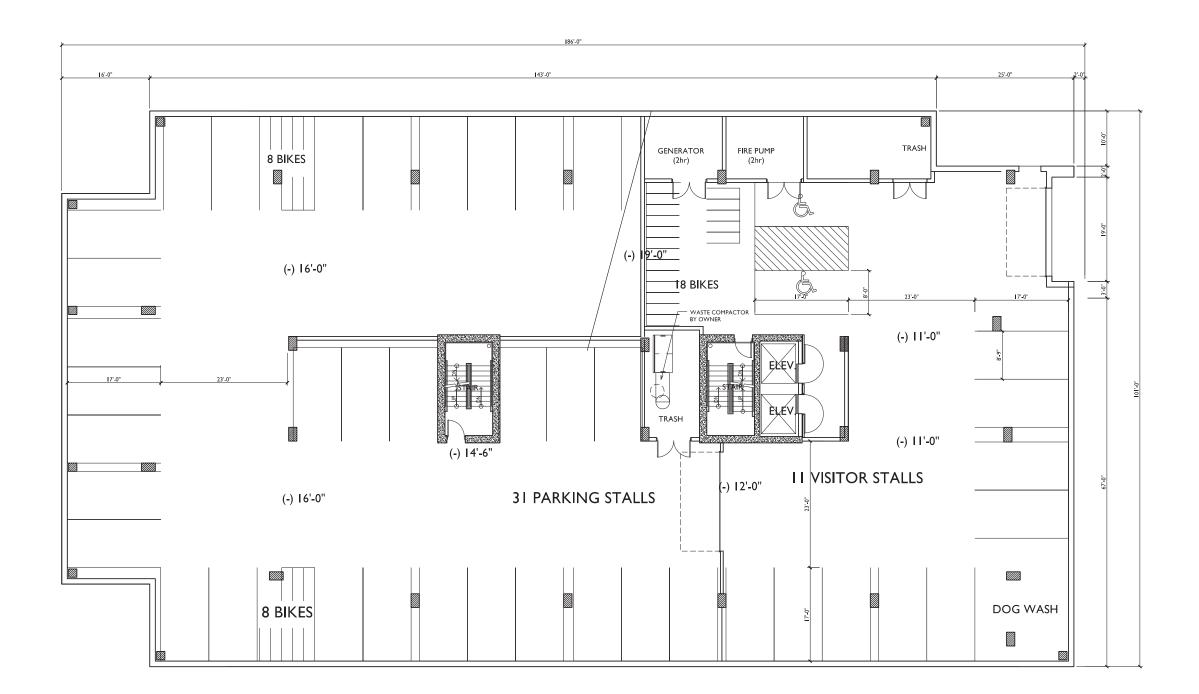



PROJECT TITLE
617 SEGOE RD

Madison, WI
SHEET TITLE
PARKING LEVEL I


SHEET NUMBER



PARKING LEVEL I

A-P1.1 SCALE: 1/8"=1'-0"



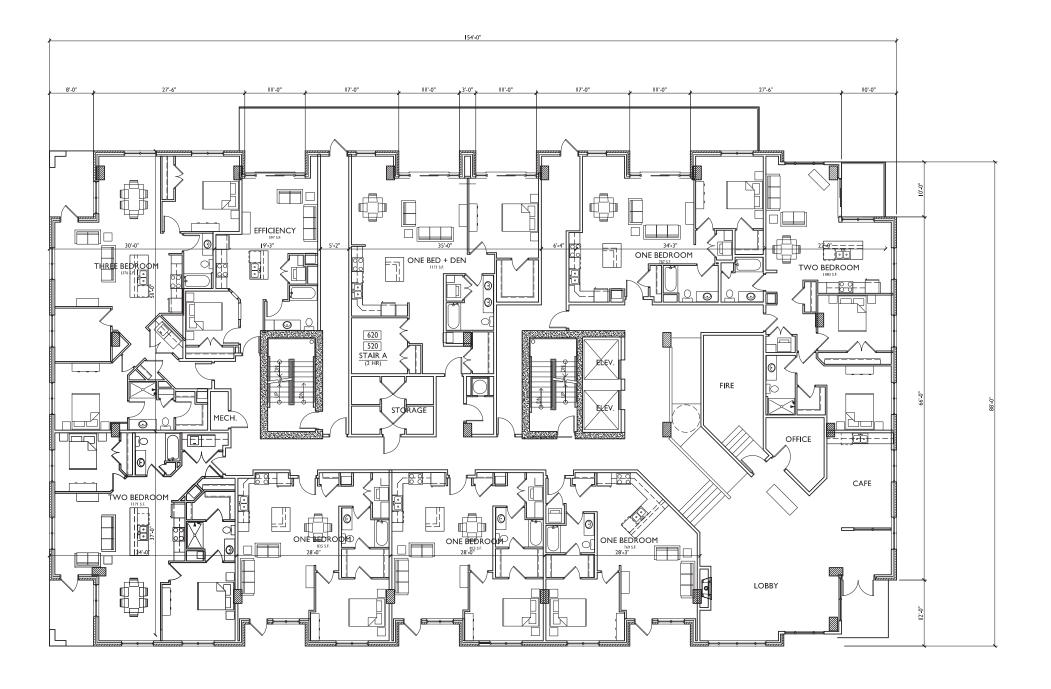

FIRST FLOOR PLAN

A-1.1 SCALE: 1/8"=1"-0"


ISSUED Issued For Rezoning - February 19, 2014 Revised Rezoning - April 11, 2014

PROJECT TITLE
617 SEGOE RD

Madison, WI
SHEET TITLE
FIRST FLOOR PLAN

SHEET NUMBER



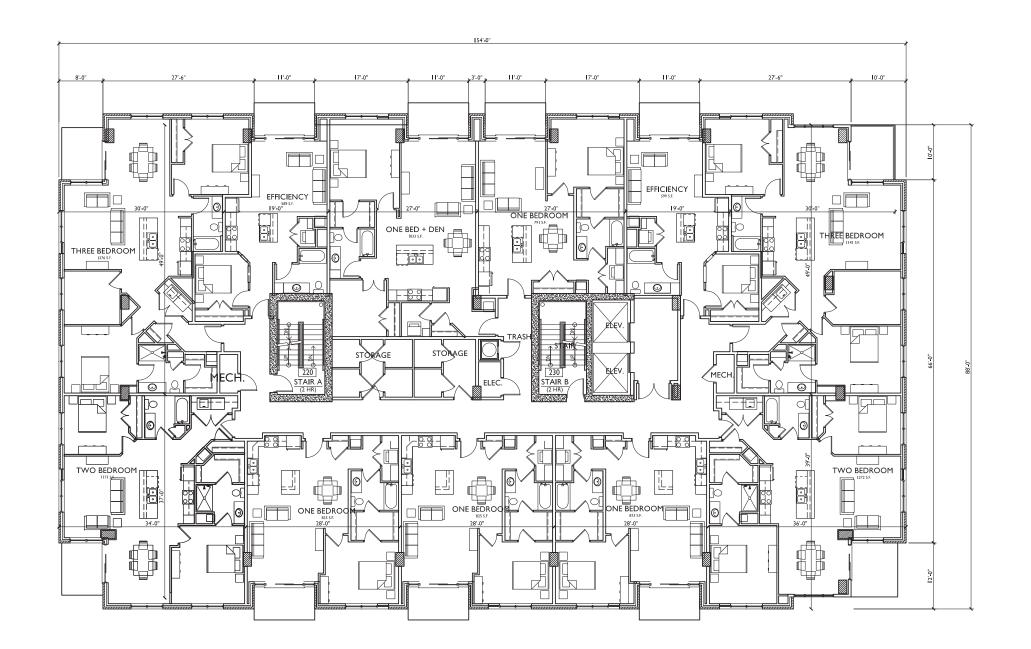






PROJECT TITLE
617 SEGOE RD

Madison, WI
SHEET TITLE
SECOND-EIGHTH FLOOR PLAN

SHEET NUMBER

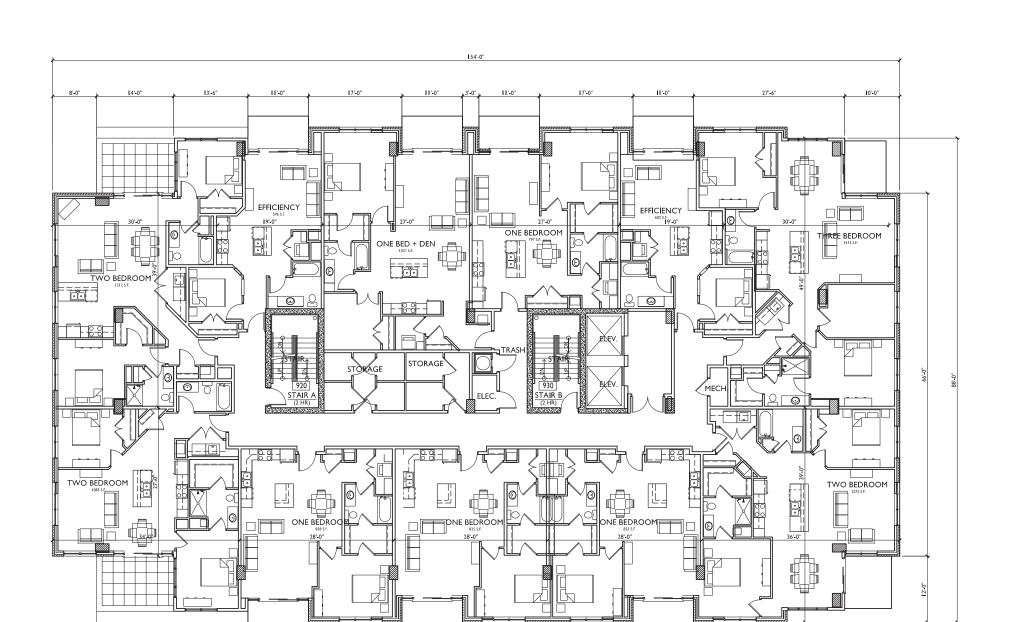



PROJECT TITLE
617 SEGOE RD

Madison, WI
SHEET TITLE
NINTH FLOOR PLAN


SHEET NUMBER

PROJECT NO. 1012

NINTH FLOOR PLAN

A-1.3 SCALE: 1/8"=1'-0"



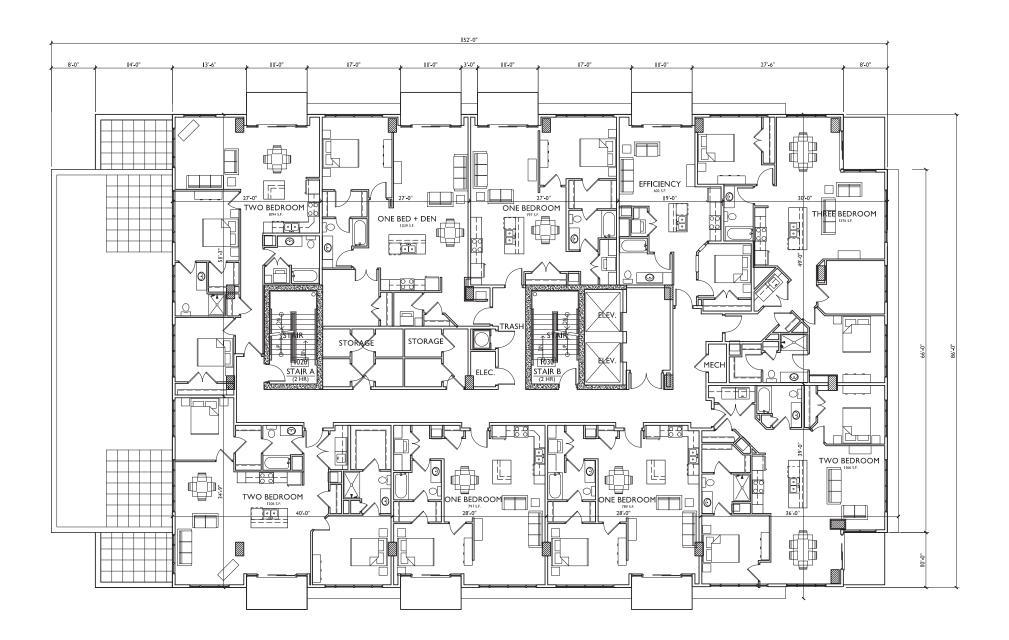







ISSUED

Issued For Rezoning - February 19, 2014 Revised Rezoning - April 11, 2014


PROJECT TITLE
617 SEGOE RD

Madison, WI
SHEET TITLE
TENTH &
ELEVENTH
FLOOR PLAN

SHEET NUMBER





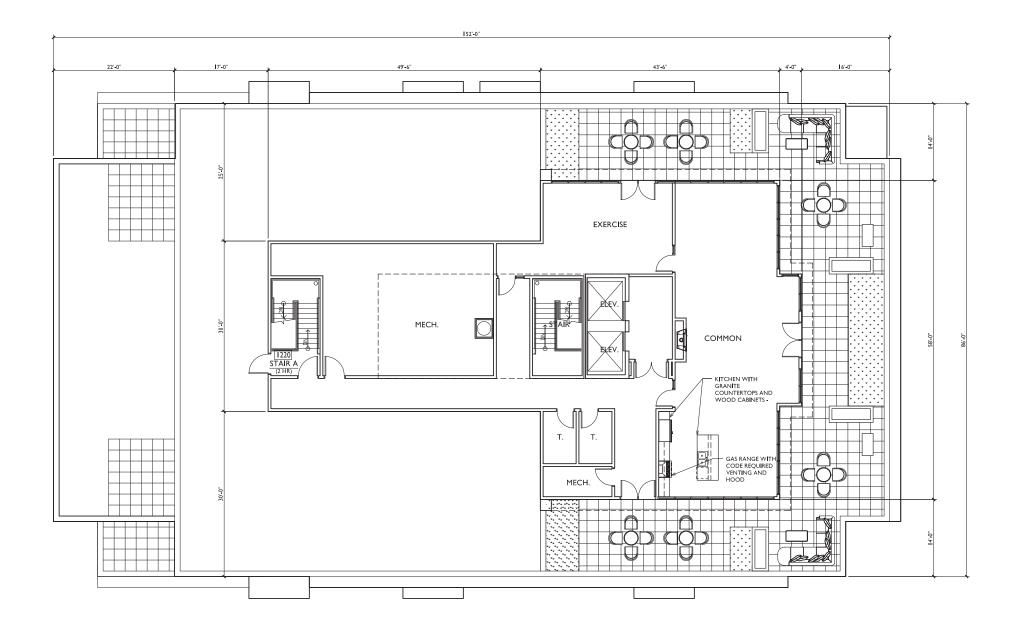

PROJECT TITLE
617 SEGOE RD

Madison, WI
SHEET TITLE
PENTHOUSE PLAN

SHEET NUMBER

A-1.5








SEGOE ROAD ELEVATION

A-2.1 SCALE: 1/8"=1'-0"

SHEET NUMBER

A-2.

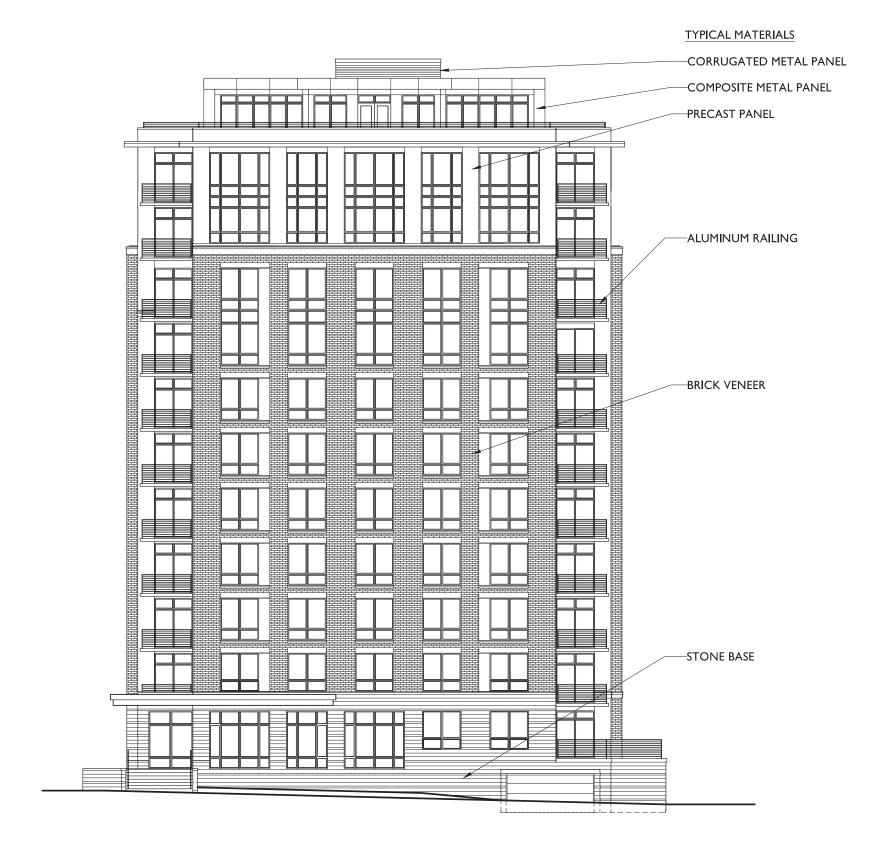



ISSUED

Issued For Rezoning - February 19, 2014 Revised Rezoning - April 11, 2014

PROJECT TITLE
617 SEGOE RD

Madison, WI
SHEET TITLE
SOUTH
ELEVATION

SHEET NUMBER

A-2.2





ISSUED

Issued For Rezoning - February 19, 2014 Revised Rezoning - April 11, 2014

PROJECT TITLE
617 SEGOE RD

Madison, WI

SHEET TITLE

EAST ELEVATION

SHEET NUMBER

A-2.3







PROJECT TITLE
617 SEGOE RD

Madison, WI
SHEET TITLE
NORTH **ELEVATION**

SHEET NUMBER

